

1. TC = TRASH CAN
2. RC = RECYCLING CAN
3. AC = HVAC UNIT
4. WALKS TO PORCHES TO BE CONCRETE

HEIGHT REQUIREMENTS:

MAIN BUILDING	35 FT.
ACCESSORY BUILDING	20 FT.
FENCE OR WALL	6.5 FT. (SIDE & REAR YARD)
FENCE OR WALL	4.0 FT. (FRONT YARD)

LANDSCAPING:

A	ARBORVITAE TREE OR EQUAL MAX. HEIGHT 3 FEET
B	CRAPE MYRTLE TREE MAX. HEIGHT 15 FEET
C	BOX SHRUBS IN MULCH BED

NOTE:
DRIVE WAY COVERED UNDER
INGRESS/EGRESS EASEMENT
SHARED EQUALLY BY ALL
PROPERTY OWNERS




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PENN & CO.
10921 PARKSHIRE LANE
HENRICO, VA 23233
(703) 728-5779 PHONE

STRUCTURAL ENGINEER INFO

 Maggie Walker
Community Land Trust

1111 N 25TH STREET
RICHMOND, VA 23223
JULIA MacNELLY
804-251-1525


OWNER

APPROVED		
ACTIVITY		
SATISFACTORY TO DATE —		
DES ---	DRW <i>JRP3</i>	CHK <i>JRP3</i>

ATTACHED FOUR SQUARE HOMES

1624 FOLLOCK STREET
RICHMOND, VA 23223
PROPOSED SITE PLAN

SCALE:	
PROJECT NO.: 2018-02	
CONSTR. CONTR. NO.	
DRAWING NO.	
SHEET	OF
A-100	

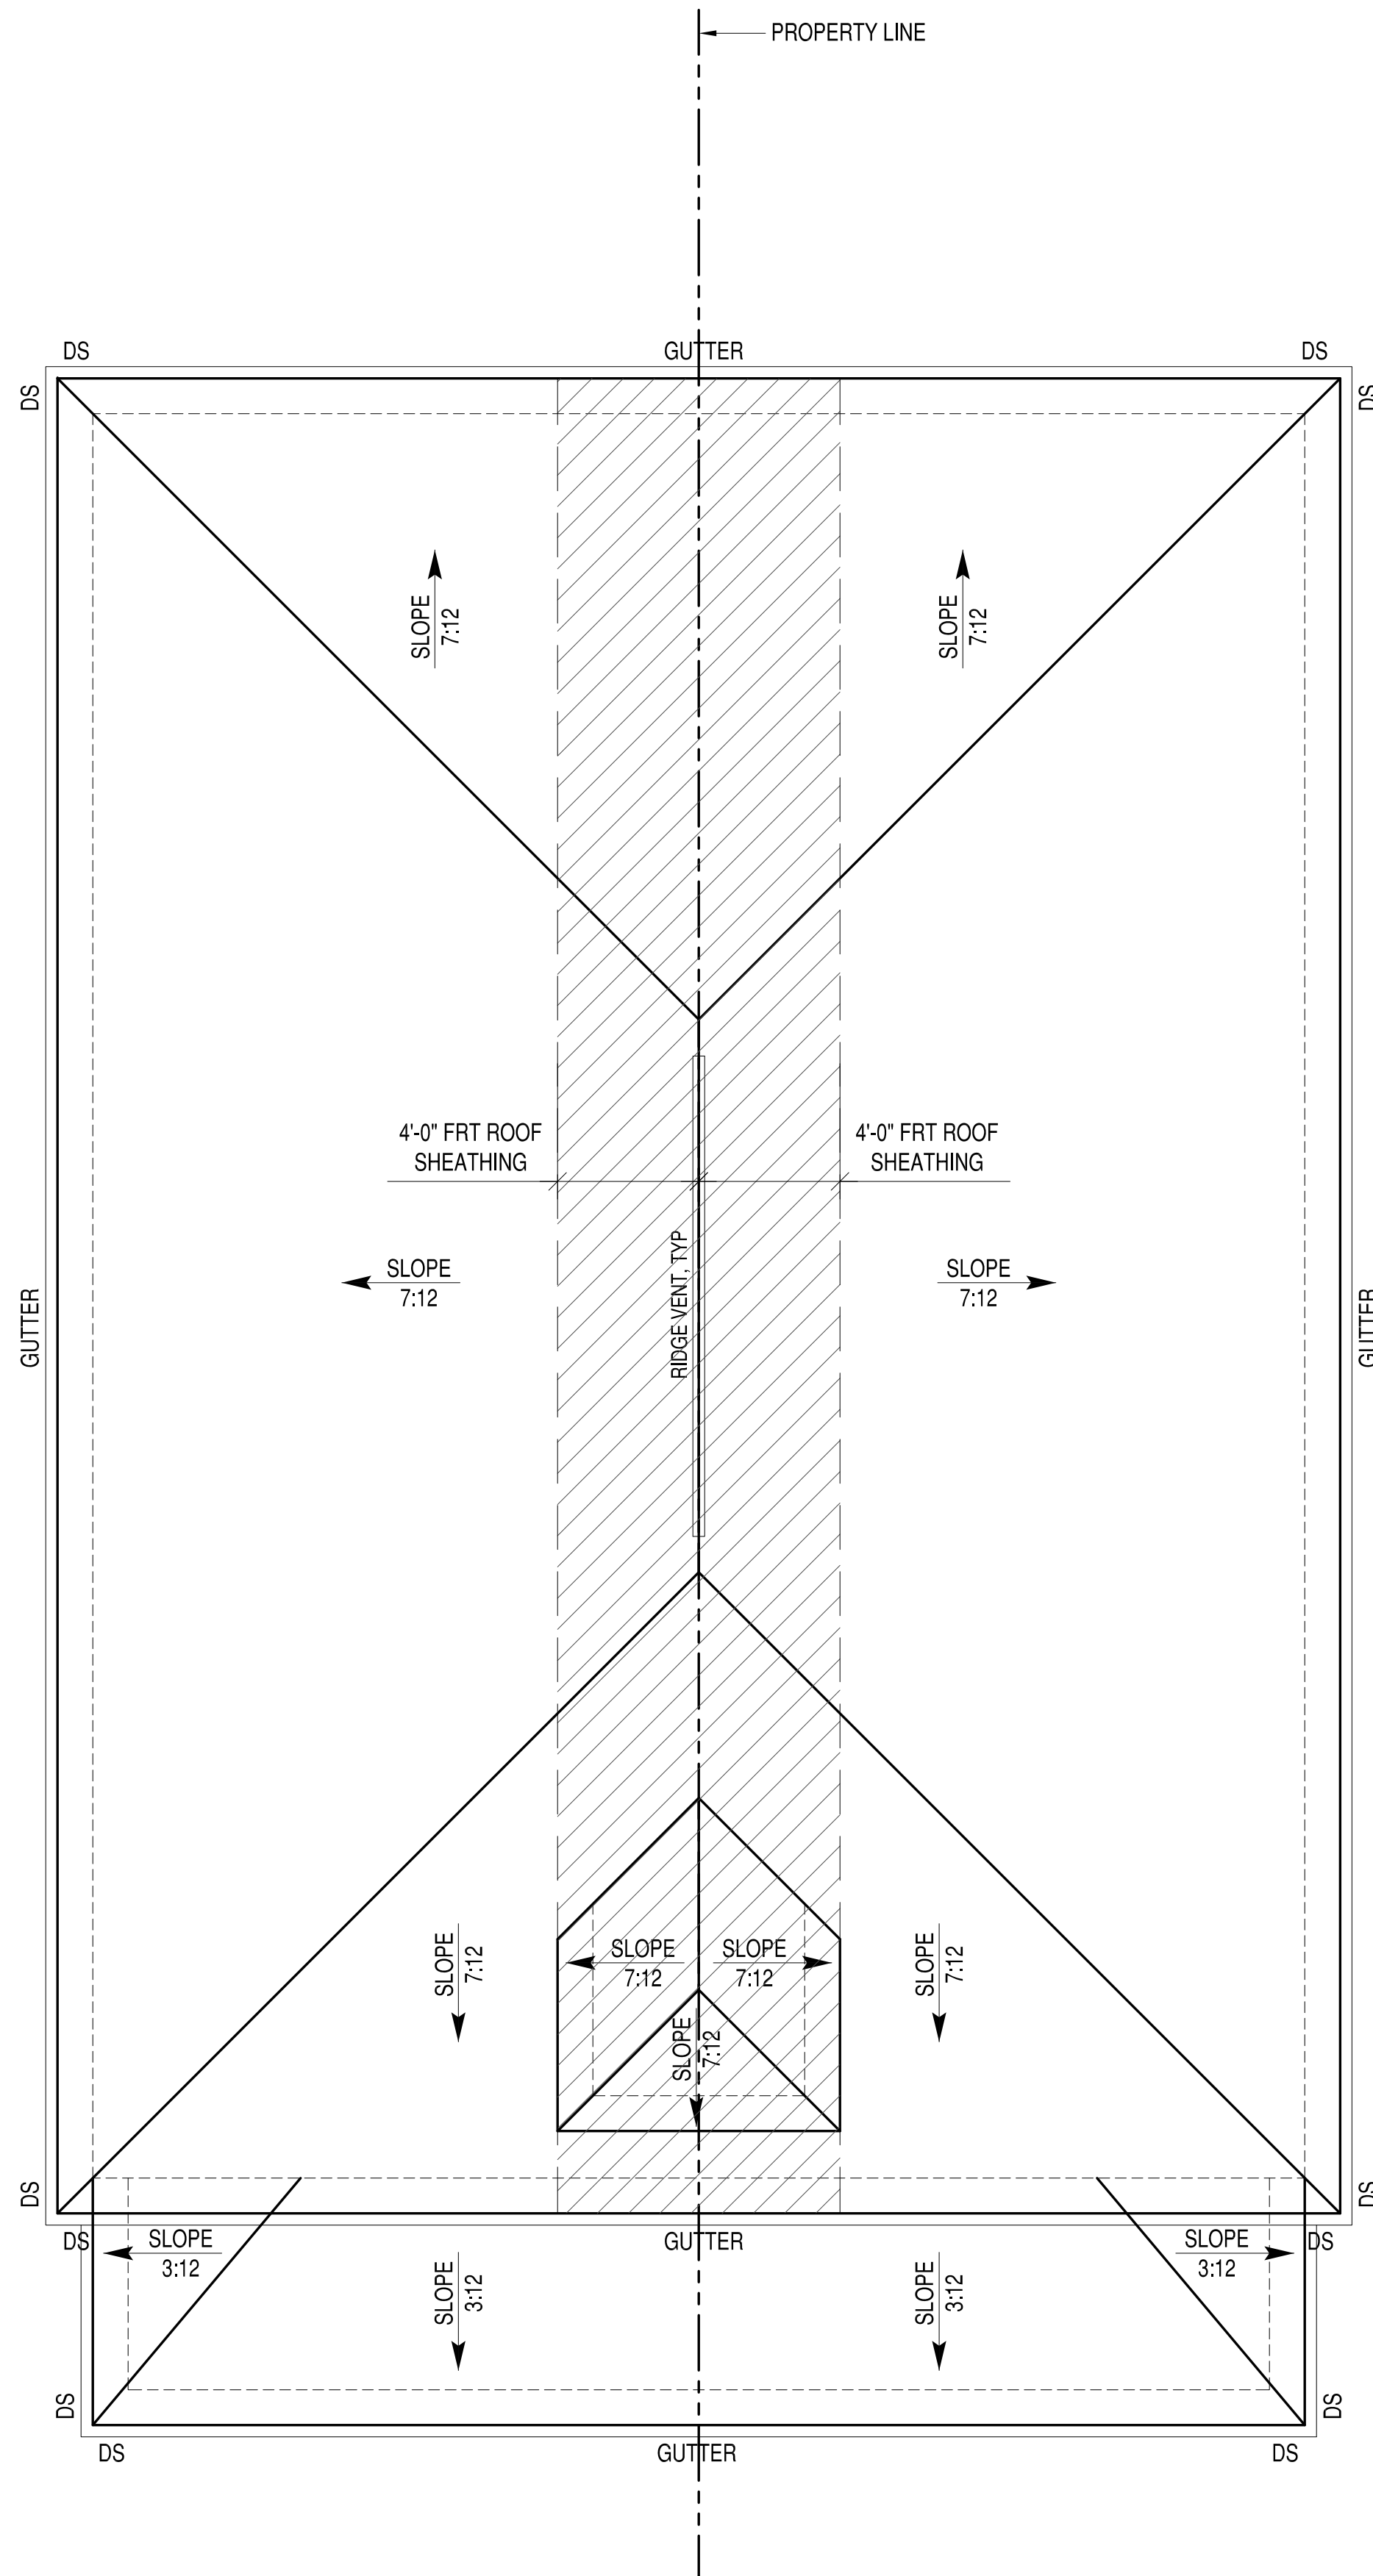

ATTIC AREA VENTILATION CALCULATIONS PER UNIT	
ATTIC AREA:	
1565 SQ.FT. / 300*144 =	
757 SQ. IN. NET FREE AREA REQUIRED	
(50% MIN AT RIDGE)	
RIDGE VENT:	
20 L.F. X 18 SQ. IN. PER LINEAR FOOT =	
360 SQ. IN. PROVIDED	
SOFFIT VENT:	
146 L.F. X 5.867 SQ. IN. PER LINEAR FOOT =	
856 SQ. IN. PROVIDED	
TOTAL NET FREE ARE PROVIDED = 1,216 SQ. IN.	
POWER VENT = (1) 12" AIRVENT, INC POWERCOOL PLUS 12	
AUTOMATIC THERMOSTAT W/ HUMIDSTAT VENT FOR UP TO	
1,650 SF OF ATTIC SPACE, INSTALL MULTIPLE VENTS FOR	
ADDITIONAL AREA.	
IF INSTALLING POWER VENT, DO NOT INSTALL	
RIDGE VENT	

PRE-ENGINEERED, PRE-FABRICATED WOOD TRUSSES

- THE DESIGN, FABRICATION AND INSTALLATION OF ALL PRE-ENGINEERED, PRE-FABRICATED WOOD TRUSSES SHALL CONFORM TO THE LATEST, ADOPTED EDITIONS OF THE STANDARDS AND MATERIAL SPECIFICATIONS REFERENCED HEREIN.
- REFERENCE STANDARDS
 - NDS "NATIONAL DESIGN SPECIFICATIONS FOR WOOD CONSTRUCTION" BY THE AMERICAN FOREST & PAPER ASSOCIATION (AF&PA).
 - TP1-1, "DESIGN STANDARDS FOR METAL PLATE CONNECTED WOOD TRUSS CONSTRUCTION" BY THE TRUSS PLATE INSTITUTE.
- MATERIALS
 - THE TERM "TRUSS" USED IN THIS SECTION APPLIES TO TRUSSES THAT ARE DESIGNED AND FABRICATED AS SEPERATE ENGINEERED PRODUCTS, AND DELIVERED TO THE PROJECT SITE FOR INSTALLATION.
 - LUMBER: SPECIES PER DESIGN BY THE TRUSS MANUFACTURER, NO.2 GRADE OR BETTER, 15% MAXIMUM M.C., EXCEPT THE TRUSS MANUFACTURER MAY USE STUD-GRADE FOR WEB MEMBERS.
- DESIGN
 - THE TRUSS MANUFACTURER SHALL DESIGN, DETAIL, PROVIDE AND INSTALL ALL INTERNAL TRUSS COMPONENT CONNECTIONS.
 - THE TRUSS MANUFACTURER SHALL DESIGN AND DESIGNATE ALL TRUSS-TO-TRUSS HANGERS. THE CONTRACTOR SHALL FURNISH AND INSTALL ALL TRUSS-TO TRUSS HANGERS IN ACCORDANCE WITH THE HANGER MANUFACTURER'S SPECIFICATIONS.
 - METAL CONNECTOR PLATES: USE GALVANIZED SHEET STEEL CONFORMING WITH ASTM A653, COATING CLASS G60. MANUFACTURE WITH HOLES, PLUGS, TEETH, OR PRONGS UNIFORMLY SPACED AND FORMED.
 - IN ADDITION TO THE UNIFORM LOADS INDICATED BELOW, DESIGN TRUSSES FOR ALL SUPERIMPOSED DEAD LOADS INCLUDING BUT NOT LIMITED TO OVERLAY FRAMING, CHIMNEYS, MECHANICAL EQUIPMENT, ETC. DESIGN TRUSSES AND REQUIRED BRACING TO RESIST THE NET WIND UPLIFT INDICATED ON THE DRAWINGS.
 - DESIGN OF MEMBERS AND CONNECTIONS SHALL BE PERFORMED BY A PROFESSIONAL ENGINEER, REGISTERED IN THE DISTRICT OF COLUMBIA, EXPERIENCED IN SIMILAR DESIGN, RETAINED BY THE MANUFACTURER.
 - DESIGN BOTTOM CHORDS OF GIRDER TRUSSES FOR THE END REACTIONS OF SUPPORTED TRUSSES.
 - DESIGN ALL TRUSSES FOR ADDITIONAL SERVICE LOADS INDICATED ON PLAN.
- DESIGN LOADS
 - ROOF
 - TOP CHORD DEAD LOAD = 10 PSF
 - TOP CHORD LIVE LOAD = 20 PSF
 - BOTTOM CHORD DEAD LOAD = 10 PSF
 - BOTTOM CHORD LIVE LOAD = 0 PSF
 - WIND LOADING: SEE DESIGN LOADS SECTION ON SHEET S 001
 - NET WIND UPLIFT = 8 PSF
 - DEFLECTIONS
 - ROOF
 - MAXIMUM LIVE LOAD DEFLECTION = L/360, OR .625" MAXIMUM
 - MAXIMUM TOTAL LOAD DEFLECTION = L/240, OR 1.0" MAXIMUM
 - DESIGN ALL BRACING AND BRACING CONNECTIONS FOR ALL TRUSS TO CHORDS, BOTTOM CHORDS AND WEB MEMBERS. PARTICULAR ATTENTION SHALL BE GIVEN TO AREAS IN THE FINISHED STRUCTURE WHICH CONTAIN TRUSSES WITH UN-SHEATHED TOP AND/OR BOTTOM CHORD MEMBERS.
- SUBMITALS
 - SUBMIT TRUSS SHOP DRAWINGS WHICH EXHIBIT THE SEAL OF THE ENGINEER RESPONSIBLE FOR TRUSS DESIGN.
 - SUBMIT LAYOUT DRAWING WHICH INDICATES THE LOCATION OF EACH TRUSS.
 - SUBMIT HANGER CONNECTOR TYPES AND LOCATIONS.
 - INDICATE ALL TEMPORARY AND PERMANENT BRACING REQUIREMENTS OF TRUSS MEMBERS. IN AREAS WHERE TRUSS TOP CHORDS AND/OR BOTTOM CHORDS DO NOT RECEIVE SHEATHING, INDICATE THE REQUIRED CHORD BRACING AND BRACE SPACINGS FOR ALL APPLICABLE LOAD CASES. INDICATE ANCHORAGE OF "CAP" TRUSSES AND/OR "OVERLAY" TRUSSES.

PROPOSED TYPICAL ROOF PLAN

SCALE: 1/4"=1'-0"



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HENRICO, VA 23233
(703) 728-5779 PHONE

STRUCTURAL ENGINEER INFO



1111 N 25TH STREET
RICHMOND, VA 23223
JULIA MacNELLY
804-251-1525

OWNER

APPROVED

ACTIVITY

SATISFACTORY TO: DATE: --
DES: --- | DRW: JRP3 | CHK: JRP3

ATTACHED FOUR SQUARE HOMES

1624 POLLOCK STREET
RICHMOND, VA 23223

PROPOSED TYPICAL ROOF PLAN AND NOTES

SCALE:
PROJECT NO.: 2018-02
CONSTR. CONTR. NO.
DRAWING NO.
SHEET OF
A-103




SYN	DESCRIPTION	DATE	APPR
3	SUP SUBMIT FINAL	10-14-2020	
2	CLIENT REVIEW	10-13-2020	
1	CLIENT REVIEW	10-7-2020	




SCALE: 1/4"=1'-0"

[illegible]

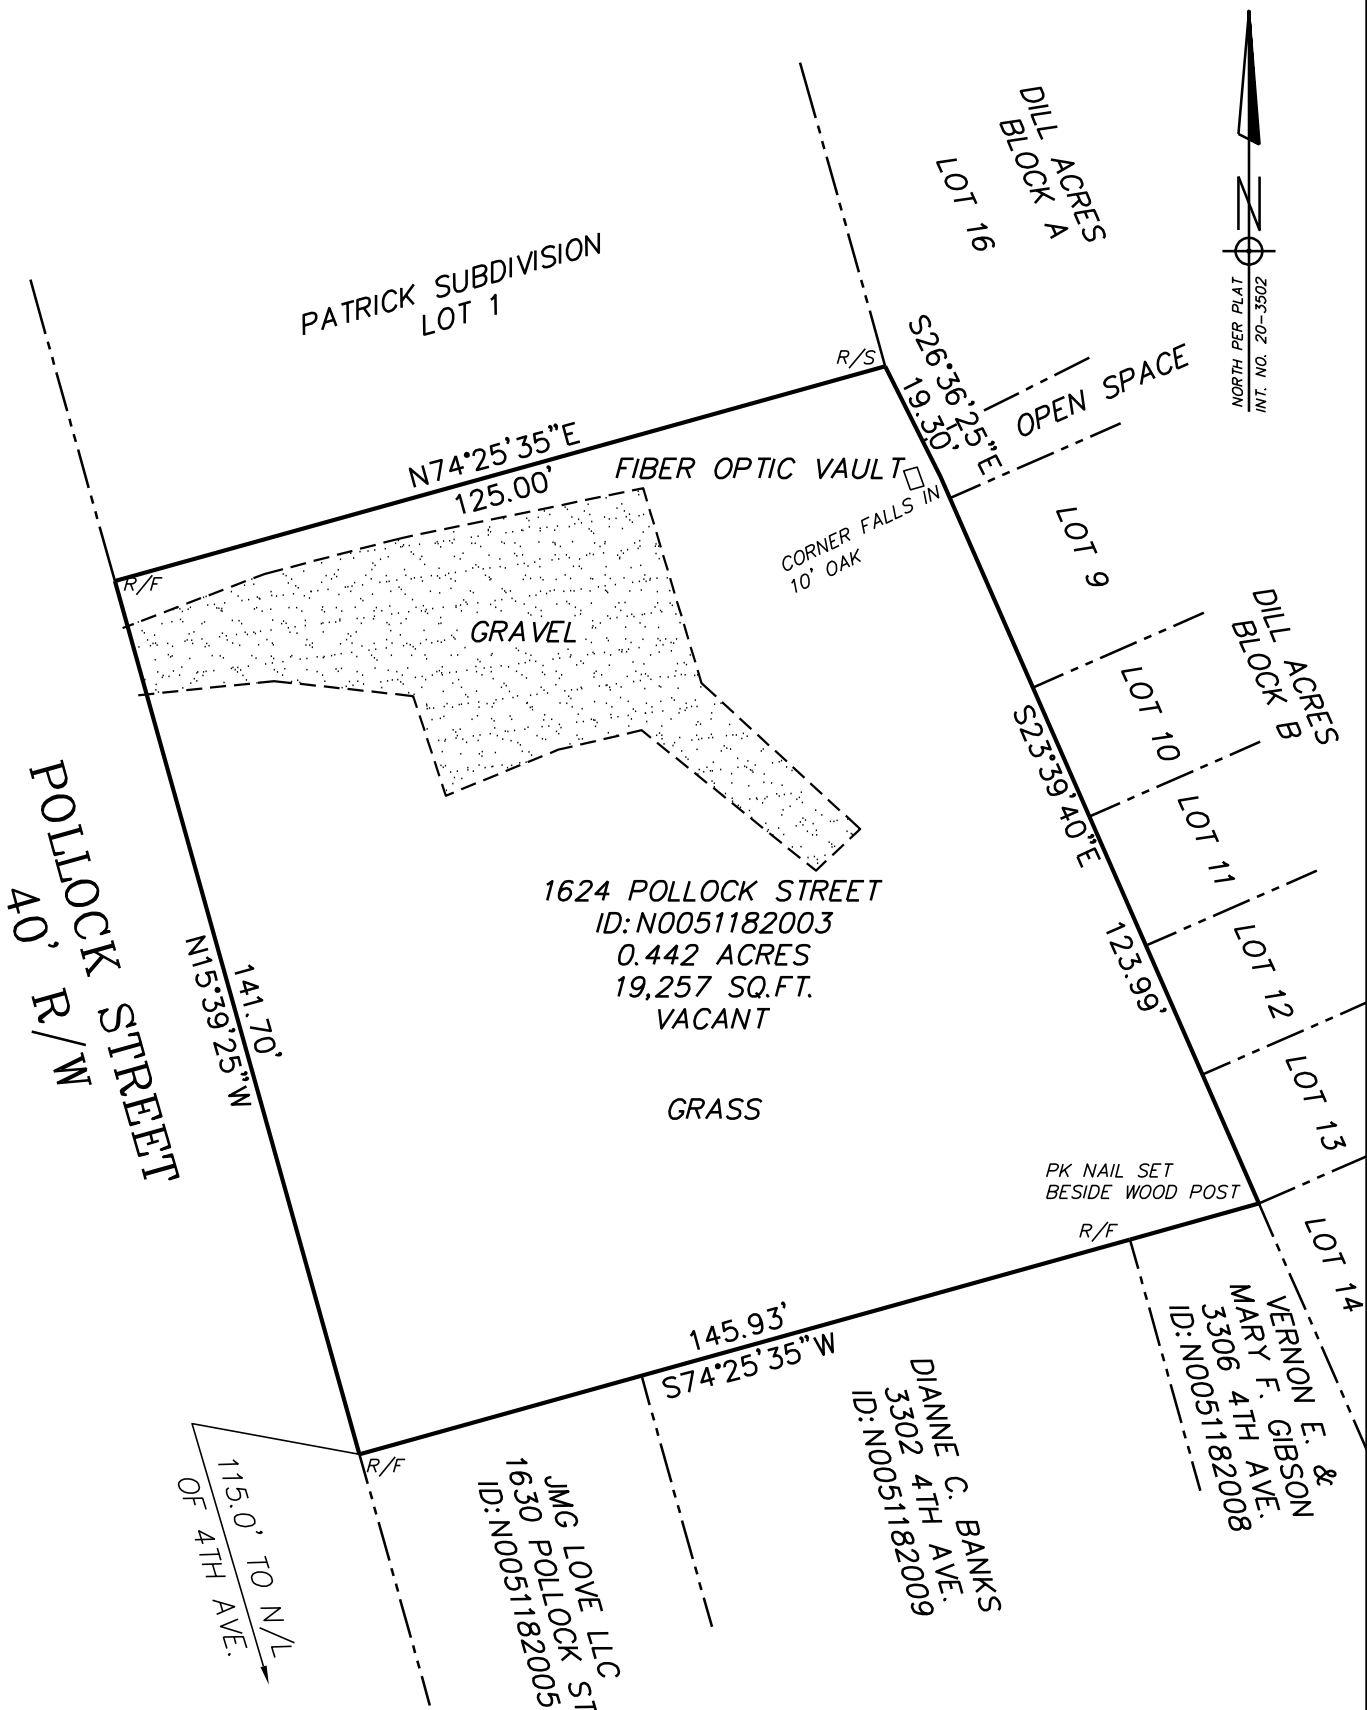

PLAT SHOWING IMPROVEMENTS ON
#1624 POLLOCK STREET
CITY OF RICHMOND, VIRGINIA

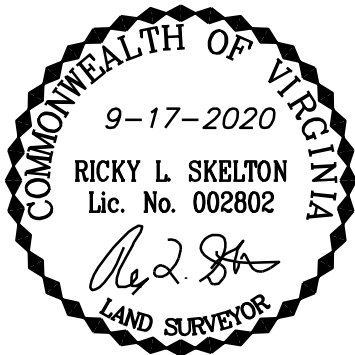

I HEREBY CERTIFY THAT THE POSITIONS OF EXISTING IMPROVEMENTS WERE CAREFULLY ESTABLISHED BY A CURRENT FIELD SURVEY AND UNLESS OTHERWISE SHOWN, THERE ARE NO VISIBLE ENCROACHMENTS.

TITLE REPORT NOT FURNISHED
PLAT SUBJECT TO RESTRICTION OF RECORD
THIS PROPERTY IS LOCATED IN H.U.D. FLOOD ZONE X

HULCHER & ASSOCIATES, INC.
CONSULTING ENGINEERS
5901 LAKESIDE AVENUE
RICHMOND, VIRGINIA 23228
(804)262-7622 * FAX: 262-8215

DATE: SEPT. 16, 2020
DRAWN BY: ESTILL SCALE: 1"=30'
CHECKED BY: RS
JOB NO: 20020MS

OWNER: THE MAGGIE WALKER COMMUNITY LAND TRUST