

COMMISSION OF ARCHITECTURAL REVIEW

APPLICATION FOR CERTIFICATE OF APPROPRIATENESS

PROPERTY (loc	cation of work)		Date/time rec'd:
Address 420	1 Hermitage Ro		
Address 1 20	Hermiasc 10	au	Rec'd by:
Historic district	Hermitage K	000	Hearing date:
	THE THE STATE OF T	,000	ricaring date.
APPLICANT IN	FORMATION		804.266.2494 x 2211 0
Name 10	oy Buzzard		Phone 804.350.3573 C
	e New Commanite	54.1	Email i buzzard @ thes.ord
		1	Email July Zara C 11763.00
Mailing Address	4211 Hermitage	e hoad	Applicant Type: ☑Owner ☐ Agent
-	Richmond VA	23227	☐ Lessee ☐ Architect ☐ Contractor
	Trioring VII	2 722	☐ Other (please specify):
OWNER INFO	RMATION (if different from a	above)	
Name			Company
Mailing Address			Phone
			Email
PROJECT INFO	RMATION		
Review Type:	☐ Conceptual Review	Ճ Final Review	,
Project Type:	☐ Alteration	☐ Demolition	□ Now Construction
	A Alteration	Li Demontion	 ☐ New Construction (Conceptual Review Required)
Project Descripti	ion: (attach additional sheets if	f needed)	(conceptual keview kequired)
Convert .	single Family h	ome to be	4 dassrooms.
+ Add	ATTA rama to a	opease	3. 3. 3.
+ Add	rear deck to a	ccommodat	Le additional egress stairs.
^			
+ Repla	ice garage door	with bar	y window + door entrance.
	GEMENT OF RESPONSIBIL		-
Compliance: If are	nted you agree to comply with a	Il conditions of the CO	A Povisions to approved week ways to the first term to
			A. Revisions to approved work require staff review with the COA may result in project delays or legal
,	approve	and to comply w	and don't may result in project delays of legal

action. The COA is valid for one (1) year and may be extended for an additional year, upon written request.

Requirements: A complete application includes all applicable information requested on checklists to provide a complete and accurate description of existing and proposed conditions. Applicants proposing major new construction, including additions, should meet with Staff to review the application and requirements prior to submitting an application. Owner contact information and signature is required. Late or incomplete applications will not be considered.

Zoning Requirements: Prior to Commission review, it is the responsibility of the applicant to determine if zoning approval is required and application materials should be prepared in compliance with zoning.

12/22/2020

December 22, 2020

Ms. Carey Jones Commission on Architectural Review 900 E. Broad St., Room 510 Richmond, VA 23219

Dear Carey,

Thank you for your help talking through the remodel of the house at 4201 Hermitage Road. We are finally ready to submit plans to the City of Richmond and the Commission on Architectural Review to complete the remodel of this single-family house. Once complete, this little home will contain four (4) classrooms with additional spaces for collaboration or independent study.

Included with this letter is the Application for Certificate of Appropriateness. We are seeking the Commission's approval to add:

- A concrete ramp for needed ADA access to the front of the house. There are metal railings as required by code.
- In the rear of the house, we are adding a wood deck area at the primary home level. This will allow us to add the code-required second mode of egress from the primary home level. The deck will be approximately 333 square feet. Primary material will be pressure treated wood with metal handrails, wood posts and pickets. This addition will be visible from the rear, from Princeton road and from Hermitage Road.
- Also in the rear, we are replacing the garage door with a bay window and door that will allow interior space for a handicapped accessible hallway. The exterior materials will be cement board with commercial grade windows and door. This area will only be visible to those on Princeton road looking towards Hermitage Road.

We have provided the architect's drawings and plans for these changes. In keeping with the other changes the School has made to our historic district properties, we are working to make everything as cohesive as possible with an eye towards maintaining or improving the aesthetics of our properties. I hope you will agree.

We are currently seeking bids from local contractors to perform this work and we do not at this time have a comprehensive estimate available. There are extensive interior changes that will impact the final cost.


Please review this request and let me know if you have any questions. I look forward to hearing from you regarding next steps.

Best,

Joy F. Buzzard

Director of Finance & Operations

Enclosures

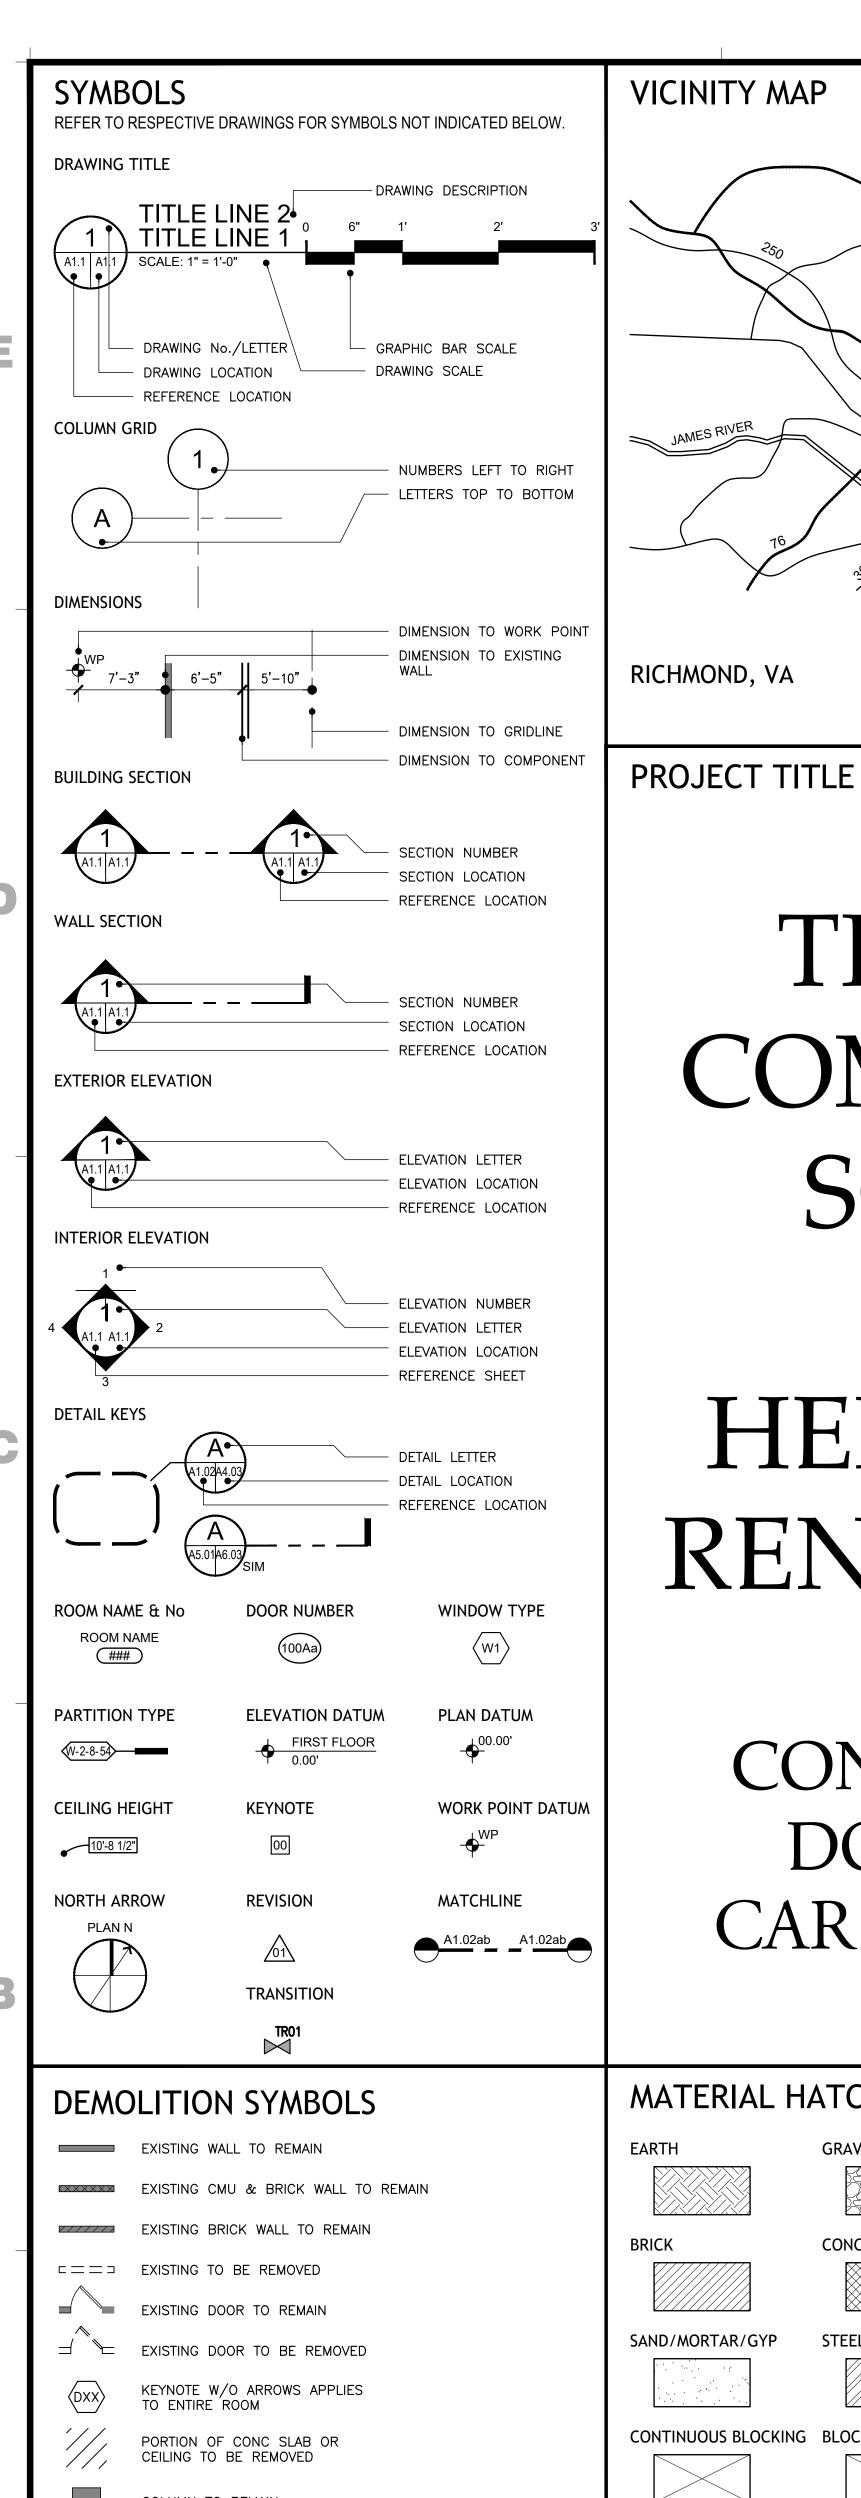

VICINITY MAP

PROJECT NARRATIVE

THE NEW COMMUNITY SCHOOL MASTER PLAN HAS AS ONE OF ITS PRIMARY GOALS THE ADDITION OF CLASSROOM SPACE FOR ITS GROWING STUDENT BODY. RECENT HEALTH CONCERNS RELATED TO COVID-19 HAVE MADE ADDING CLASSROOM SPACE A NECESSITY TO MEET THE NEEDS OF THE STAFF AND STUDENTS WITH SMALLER CLASS SIZES AND GREATER SOCIAL DISTANCES. THE SCHOOL HAS RECENTLY PURCHASED A HOUSE ON AN ADJACENT SITE IN ORDER TO HELP MEET THESE REQUIREMENTS. THE PROJECT CONSISTS OF THE CONVERSION OF THE HOUSE AT 4201 HERMITAGE ROAD FROM RESIDENTIAL USE TO EDUCATIONAL USE. THIS RESIDENTIAL PROPERTY, AN EXISTING 4,000 SF RANCH-STYLE HOUSE WITH A WALK-OUT BASEMENT AND A TWO-STORY ADDITION, IS ENVISIONED AS A SPECIALIZED, SMALL ACADEMIC BUILDING WITH CLASSROOMS, FACULTY OFFICES, AND COLLABORATION SPACES, AS WELL AS AN OUTDOOR CLASSROOM SPACE AND FOUR PARKING SPACES. THE PROJECT WILL BE UNDERTAKEN IN TWO PHASES IN ORDER TO SERVE THE STUDENT AND STAFF HEALTH AND WELLNESS MORE IMMEDIATELY. PHASE 1 INVOLVES THE RENOVATION OF THE LOWER LEVEL AND ANY MODIFICATIONS ON THE UPPER LEVEL NECESSARY TO MAKE THE LOWER LEVEL FUNCTIONAL AS SPACE FOR TWO CLASSROOMS. IT ALSO INCLUDES THE ADDITION OF TWO ACCESSIBLE PARKING SPACES. PHASE 2 WILL RENOVATE PORTIONS OF THE UPPER LEVEL, ADD A PORCH TO THE REAR OF THE BUILDING ON BOTH LEVELS, ADD A RAMP TO THE UPPER LEVEL ENTRANCE, AND ADD TWO MORE PARKING SPACES.

LOCATION MAP

4201 HERMITAGE RD

RICHMOND, VIRGINIA 23227

DRAWING INDEX

T1.1 PROJECT INFORMATION AS1.1 ARCHITECTURAL SITE PLAN AA1.1 FLOOR PLANS

A2.1 EXTERIOR ELEVATIONS

A2.0 EXISTING EXTERIOR ELEVATIONS

"GLAVÉ O" || HOLMES |

ARCHITECTURE

2101 East Main Street Richmond, Virginia 23223

PROJECT TITLE 4201 Hermitage

W www.glaveandholmes.com

T 804 649 9303 F 804 343 3378

The New Community School Richmond, VA

CONSULTANTS

Renovation

STRUCTURAL ENGINEER Dunbar Milby Williams Pittman Vaughn 1025 Boulders Parkway, Suite 310 Richmond, VA 23225 T (804) 323-0656 F (804) 272-3916

MEP ENGINEER Inversity Consulting Engineers 250 Wylderose Commons, Suite 102 Midlothian, VA 23113 T (804) 977-0403 F ...

Richmond Commission of Architectural Review (CAR) Drawings

PROJECT NUMBERS G&HA #: 20082

December 21, 2020

DRAWN BY: GHA CHECKED BY: GHA

REVISIONS

SHEET TITLE

NO. DATE DESCRIPTION

PROJECT

INFÓRMATION

SHEET NUMBER

These drawings may not be used in any manner nor reproduced in any form without prior consent from Glavé & Holmes Architecture.

THE NEW COMMUNITY SCHOOL 4201 HERMITAGE RENOVATION PHASE 2 CONSTRUCTION

EXISTING SITE PLAN

FP FIRE PROTECTION

FR FIRE RESISTANT

CARPET TILE

CT CERAMIC TILE

MATERIAL HATCHES

DOCUMENTS

CAR REVIEW SET

GRAVEL	CONCRETE/PREC
CONCRETE MASONRY	STONE
STEEL	ALUMINUM
BLOCKING	PLYWOOD
RIGID INSULATION	BATT INSULATIO
CERAMIC TILE	ACOUSTICAL TIL
	CONCRETE MASONRY STEEL BLOCKING RIGID INSULATION

	4000	EVALUATION LIGHT														
	ABBR	EVIATION LIST	CU FT	CUBIC FEET		FRT	FIRE RETARDENT TREATED		LT	LIGHT		PLAM	PLASTIC LAMINATE		STD	STANDARD
						FT	FOOT, FEET		LVT	LUXURY VINYL TILE		PLAS	PLASTER		STL	STEEL
- 1	A A/C	AIR CONDITIONING D	DD	DECK DRAIN		FTG	FOOTING					PLYWD	PLYWOOD		STN	STAIN(ED)
	ADJ	ADJACENT, ADJUSTABLE	DIA	DIAMETER				M	MAS	MASONRY		PNL	PANEL		STR	STRUCTURAL
	AFF	ABOVE FINISH FLOOR	DIAG	DIAGONAL	G	GA	GUAGE		MATL	MATERIAL		PNT(D)	PAINT(ED)		SUSP	SUSPEND(ED)
	ALT	ALTERNATE	DIM	DIMENSION		GALV	GALVANIZED		MAX	MAXIMUM		PSF	POUNDS PER SQUARE FOOT			
	ALUM	ALUMINUM	DIST	DISTANCE		GC	GENERAL CONTRACTOR		MECH	MECHANICAL		PSI	POUNDS PER SQUARE INCH	Τ	Т	TIL(E), (ING)
	APC	ACOUSTICAL PANEL CEILING	DN	DOWN		GWB	GYPSUM WALL BOARD		MED	MEDIUM		PT	POINT		T&G	TONGUE & GROOVE
	APPROX	(APPROXIMATE	DS	DOWN SPOUT		GYP	GYPSUM		MEP	MECHANICAL, ELECTRICAL,		PTN	PARTITION		TBD	TO BE DECIDED
	AR	AREA OF REFUGE	DWG(S)	DRAWING(S)						PLUMBING		PVC	POLYVINYL CHLORIDE		TE	TILE EDGING
	ARCH	ARCHITECT(URAL)			Н	HC	HOLLOW CORE		MFR	MANUFACTURER					TEL	TELEPHONE
	ATC	ACOUSTICAL TILE CEILING E	Е	EAST		HDW	HARDWARE		MIN	MINIMUM, MINUTE(S)	R	RAD	RADIUS		TERR	TERRAZZO
	AWC	ACOUSTICAL WALL COVERING	EA	EACH		HDWD	HARDWOOD		MIR	MIRROR		RB	RUBBER BASE		THK	THICK(NESS)
	AWP	ACOUSTICAL WALL PANEL	EJ	EXPANSION JOINT		HEJ	HORIZONTAL EXPANSION JOINT	Γ	MISC	MISCELLANEOUS		RD	ROOF DRAIN		TOC	TOP OF CONCRETE
			EL	ELEVATION		HM	HOLLOW METAL		MLDG	MOLDING		RE:	REFER TO		TOM	TOP OF MASONRY
	В ввт	BIOBASED TILE	ELEC	ELECTRIC(AL)		HOR	HORIZONTAL		MNT	MOUNT		REF	REFRIGERA(NT), (TOR)		TOS	TOP OF STEEL
	BD	BOARD	EMER	EMERGENCY		HP	HIGH POINT		MO	MASONRY OPENING		REINF	REINFORC(E), (ED), (ING)		TOW	TOP OF WALL
	BEJ	BUILDING EXPANSION JOINT	EPDM	ETHYLENE PROPYLENE		HT	HEIGHT		MTL	METAL		REQD	REQUIRED		TR	TRANSITION
	BLDG	BUILDING		DIENE MONOMER		HTG	HEATING					RES	RESILIENT		TV	TELEVISION
	BLKG	BLOCKING	EPX	RESINOUS POURED EPOXY		HVAC	HEATING, VENTILATING,	Ν		NORTH		REV	REVISION		TYP	TYPICAL
	BOT	BOTTOM		FLOORING			AIR CONDITIONING		NIC	NOT IN CONTRACT		RL	RAIN LEADER			
	BRK	BRICK	EQ	EQUAL					No, #	NUMBER		RM	ROOM	U	UNO	UNLESS NOTED OTHERWISE
			EQUIP	EQUIPMENT	ı	ID	INSIDE DIAMETER		NOM	NOMINAL		RO	ROUGH OPENING			
	C CAB	CABINET	EVTR	ELEVATOR		INCL	INCLUD(E), (ED), (ING)		NTS	NOT TO SCALE		RSN		٧	VCT	VINYL COMPOSITION TILE
	CEM	CEMENT	EXIST	EXISTING		INSUL	INSULAT(E), (ED), (ING), (ION)					RT	RUBBER TILE		VEJ	VERTICAL EXPANSION JOINT
	CIP	CAST IN PLACE	EXP	EXPOSED		INT	INTERIOR	0	OC	ON CENTER					VERT	VERTICAL
	CJ	CONTROL JOINT	EXT	EXTERIOR					OD	OUTSIDE DIAMETER	S		SOUTH		VIF	VERIFY IN FIELD
	CL	CENTERLINE			J	JAN	JANITOR		OFD	OVERFLOW DRAIN		SC	SEALED CONCRETE		VIN	VINYL
	CLG		FA	FIRE ALARM		JT	JOINT		OFCI	OWNER FURNISHED		SCF	STRUCTURAL CONCRETE FLOOR			
	CLO	CLOSET	FAB	FABRIC						CONTRACTOR INSTALLED		SCHED	(), ()	W	W	WEST, WIDE, WIDTH
	CMU	CONCRETE MASONRY UNIT	FD	FLOOR DRAIN, FIRE DAMPER	K	KIT	KITCHEN		OFOI	OWNER FURNISHED OWNER		SD	STORM DRAIN		W/	WITH
	CO	CASED OPENING	FE	FIRE EXTINGUISHER		KO	KNOCK OUT			INSTALLED		SFRM	SPRAY-APPLIED CEMENTITIOUS		W/O	WITHOUT
	COL	COLUMN	FEC	FIRE EXTINGUISHER CABINET					OPNG	OPENING			FIRE RESISTIVE MATERIAL		WC	WALLCOVERING, WATER-
	CONC	CONCRETE	FHC	FIRE HOSE CABINET	L	L	LENGTH		OPP	OPPOSITE		SIM	SIMILAR			CLOSET
	CORR	CORRIDOR, CORRUGATED	FIN	FINISH		LAB	LABORATORY	_				SQ	SQUARE		WD	WOOD
	CPT	BROADLOOM CARPET/	FLR	FLOOR		LAM	LAMINAT(E), (ED), (ION)	Ч	PERF	PERFORAT(E), (ED), (ION)		SS	STAINLESS STEEL		WP	WORKING POINT

PERP PERPENDICULAR


PL PLATE


LAV LAVATORY


LINO LINOLEUM

SSM SOLID SURFACE MATERIAL ST STONE


WWF WELDED WIRE FABRIC

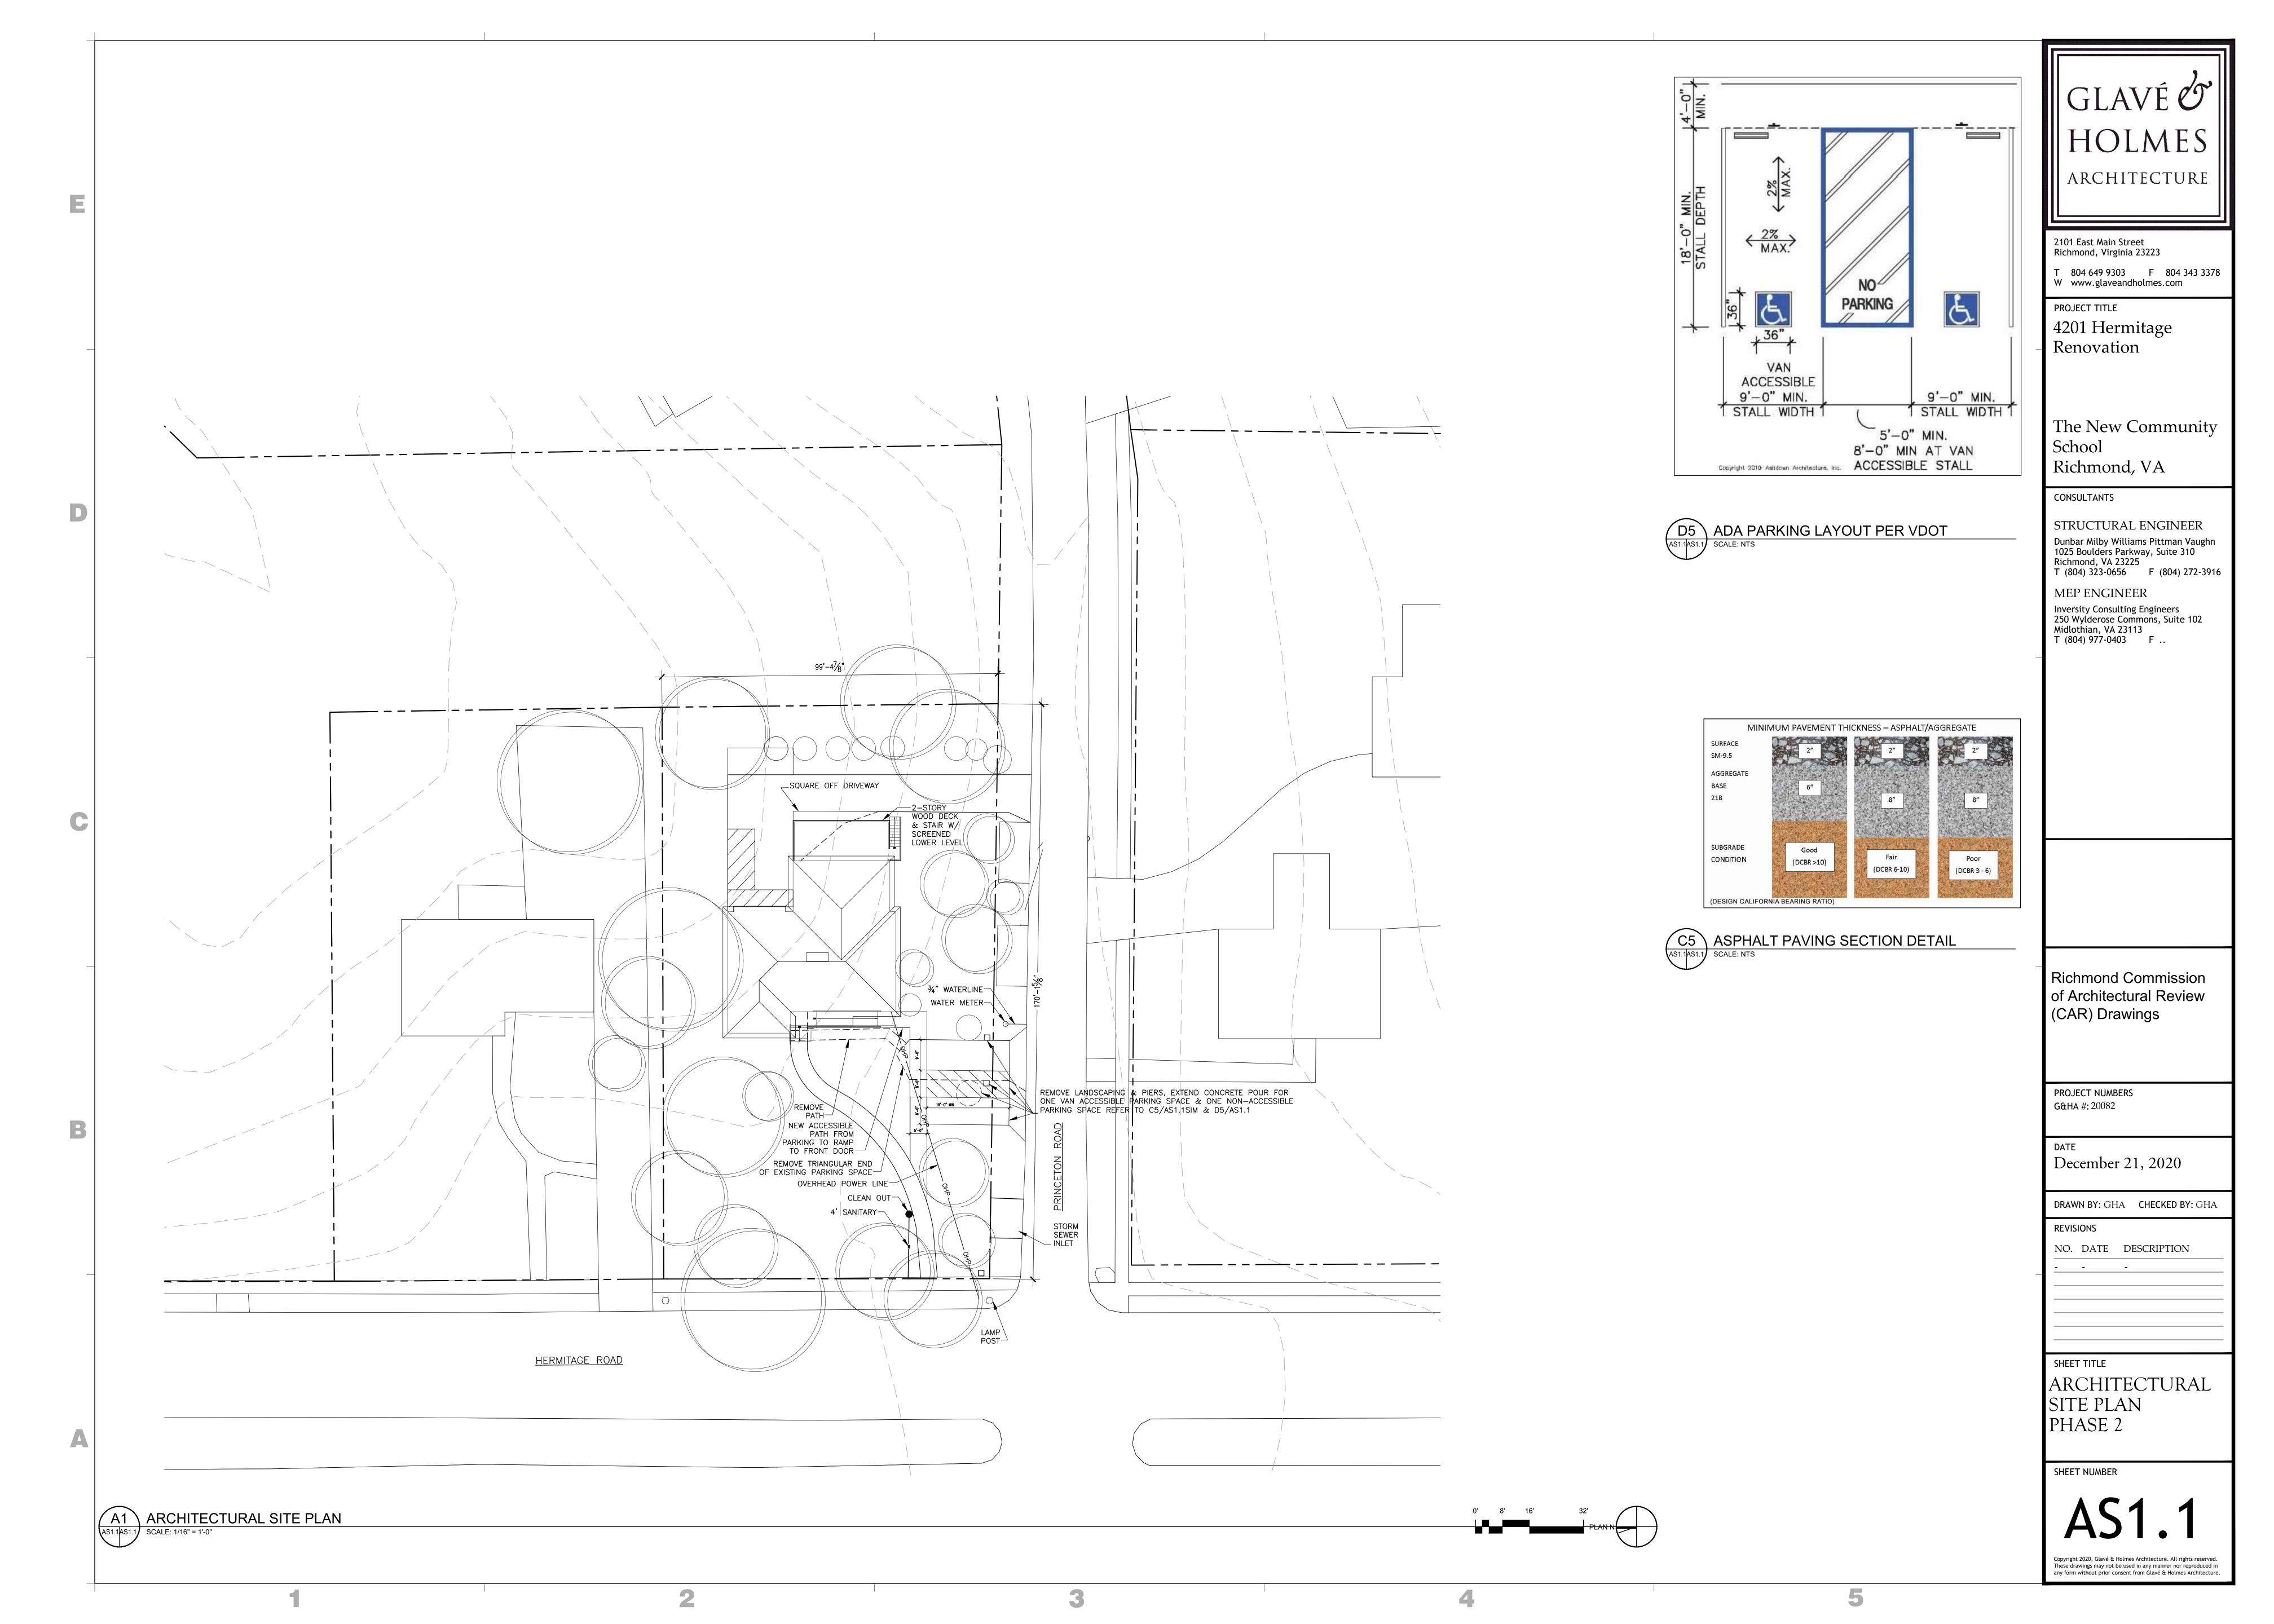

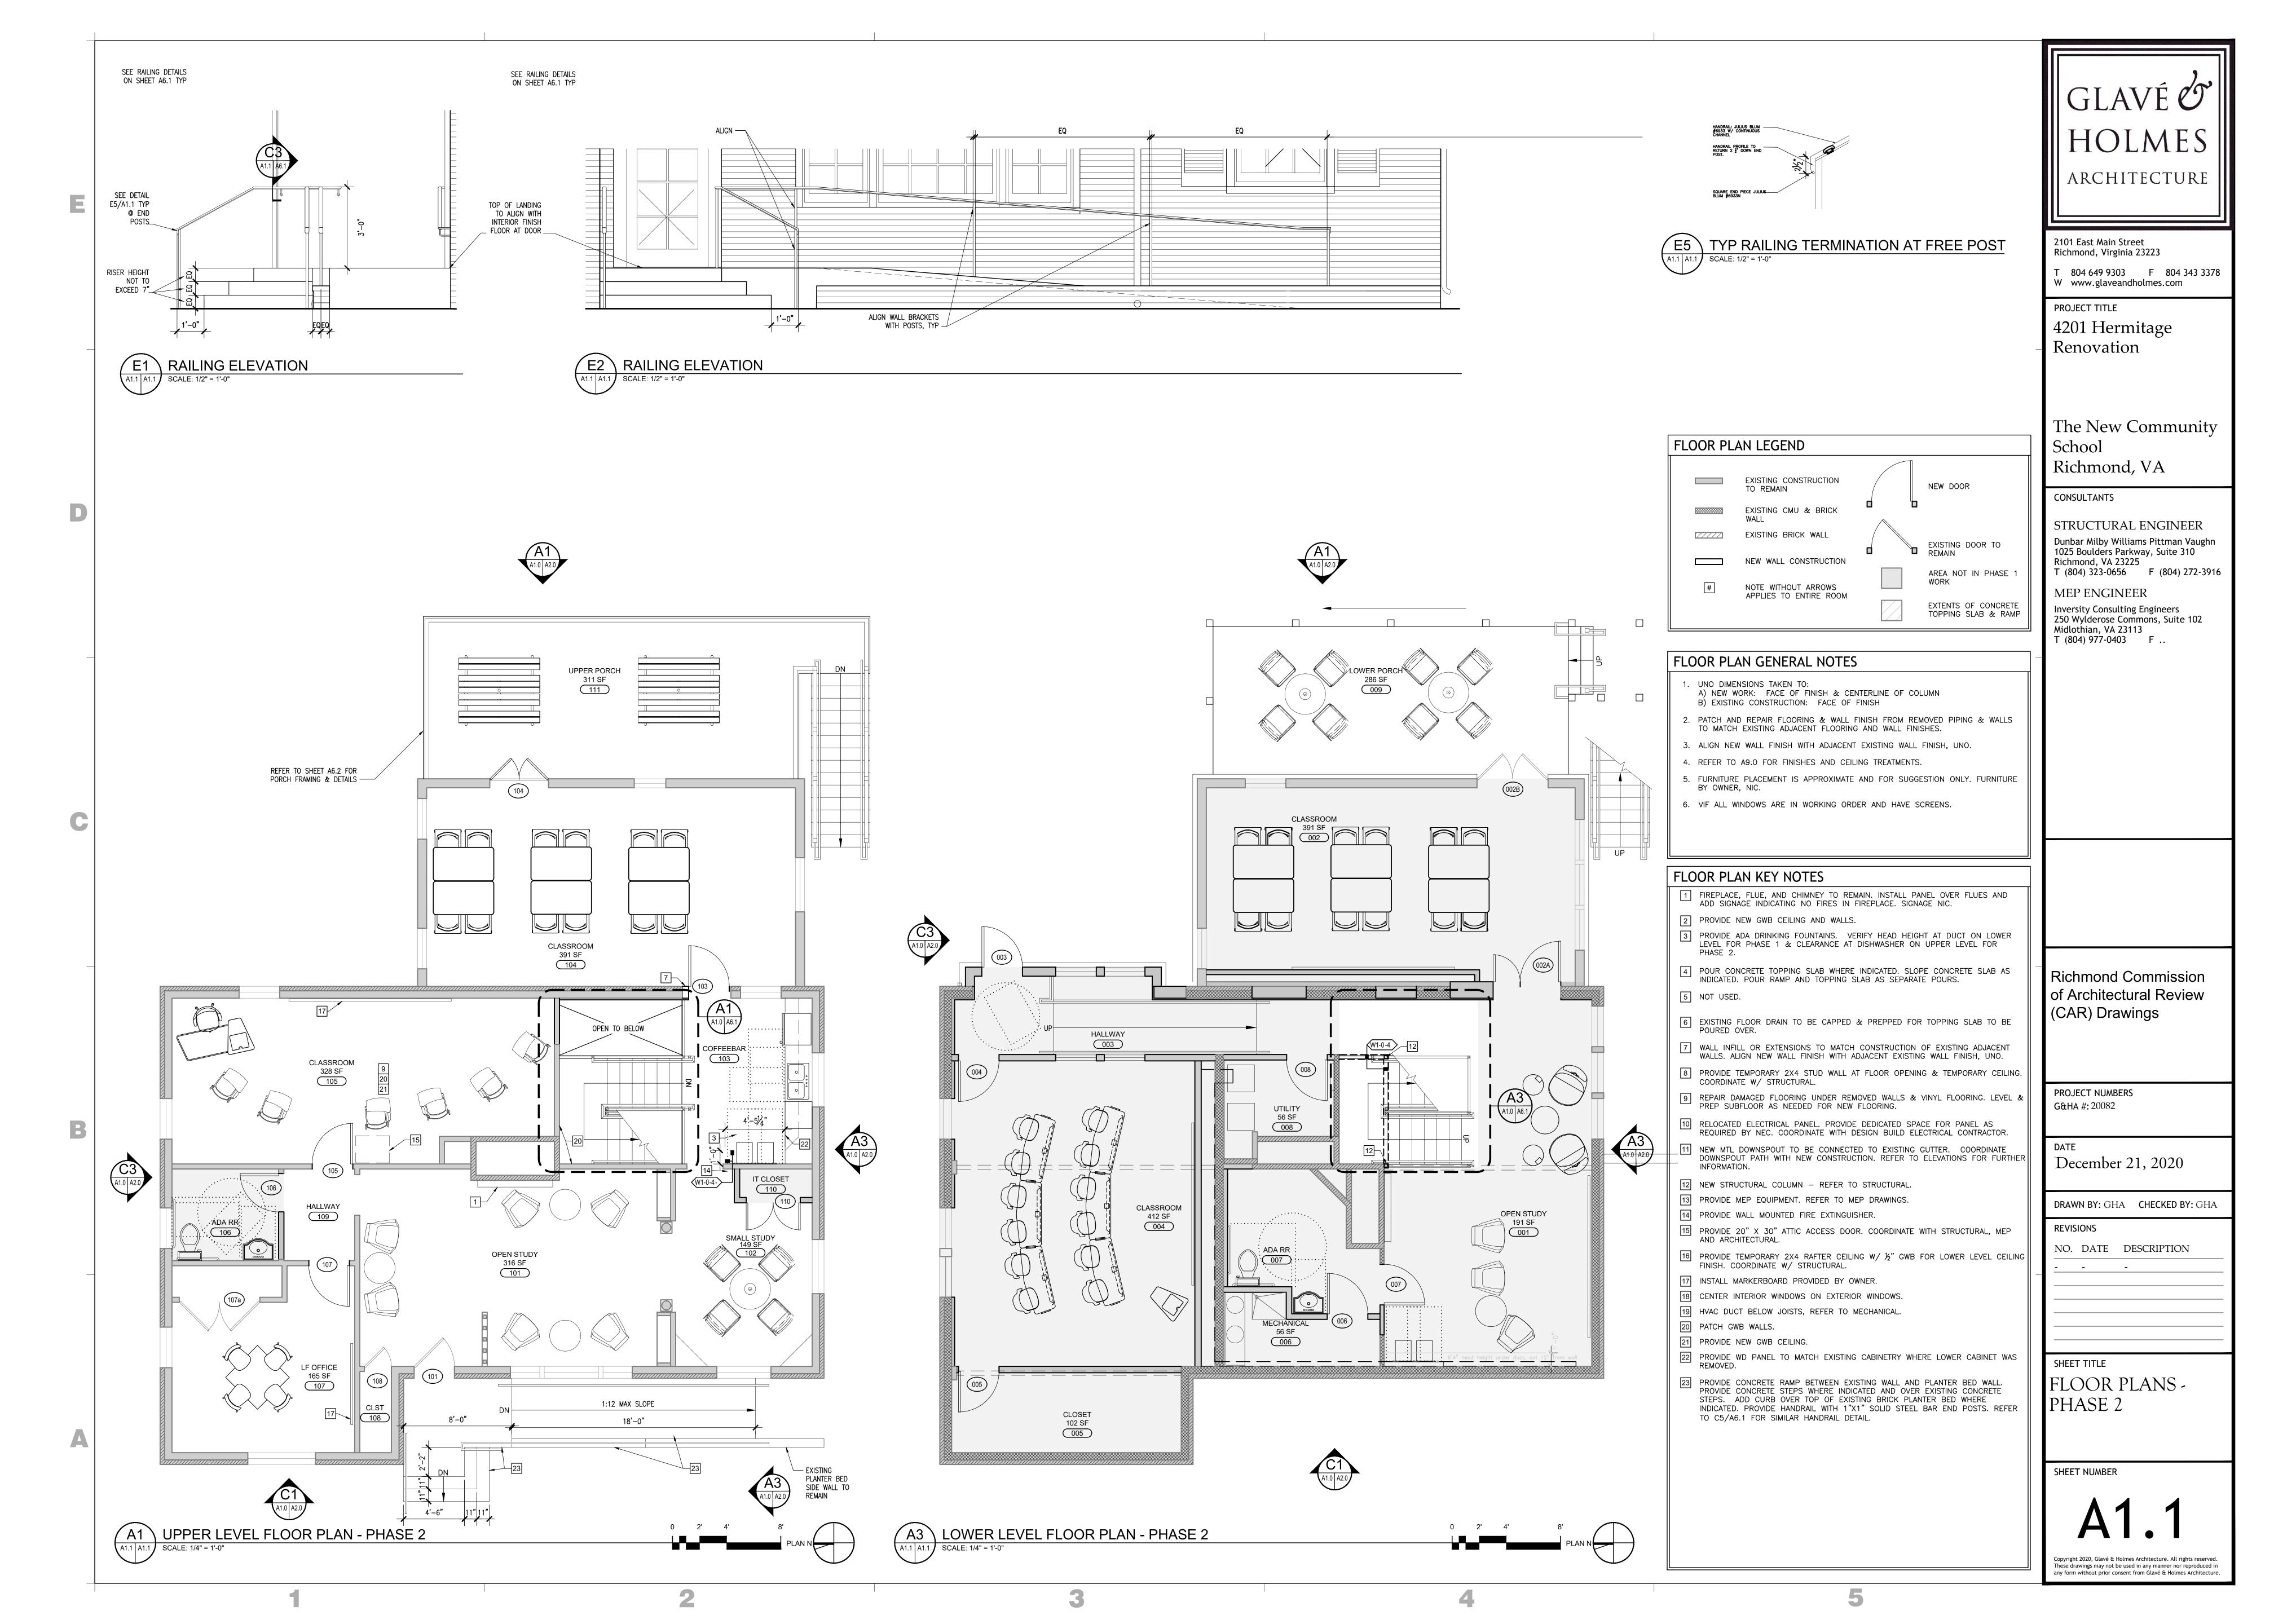

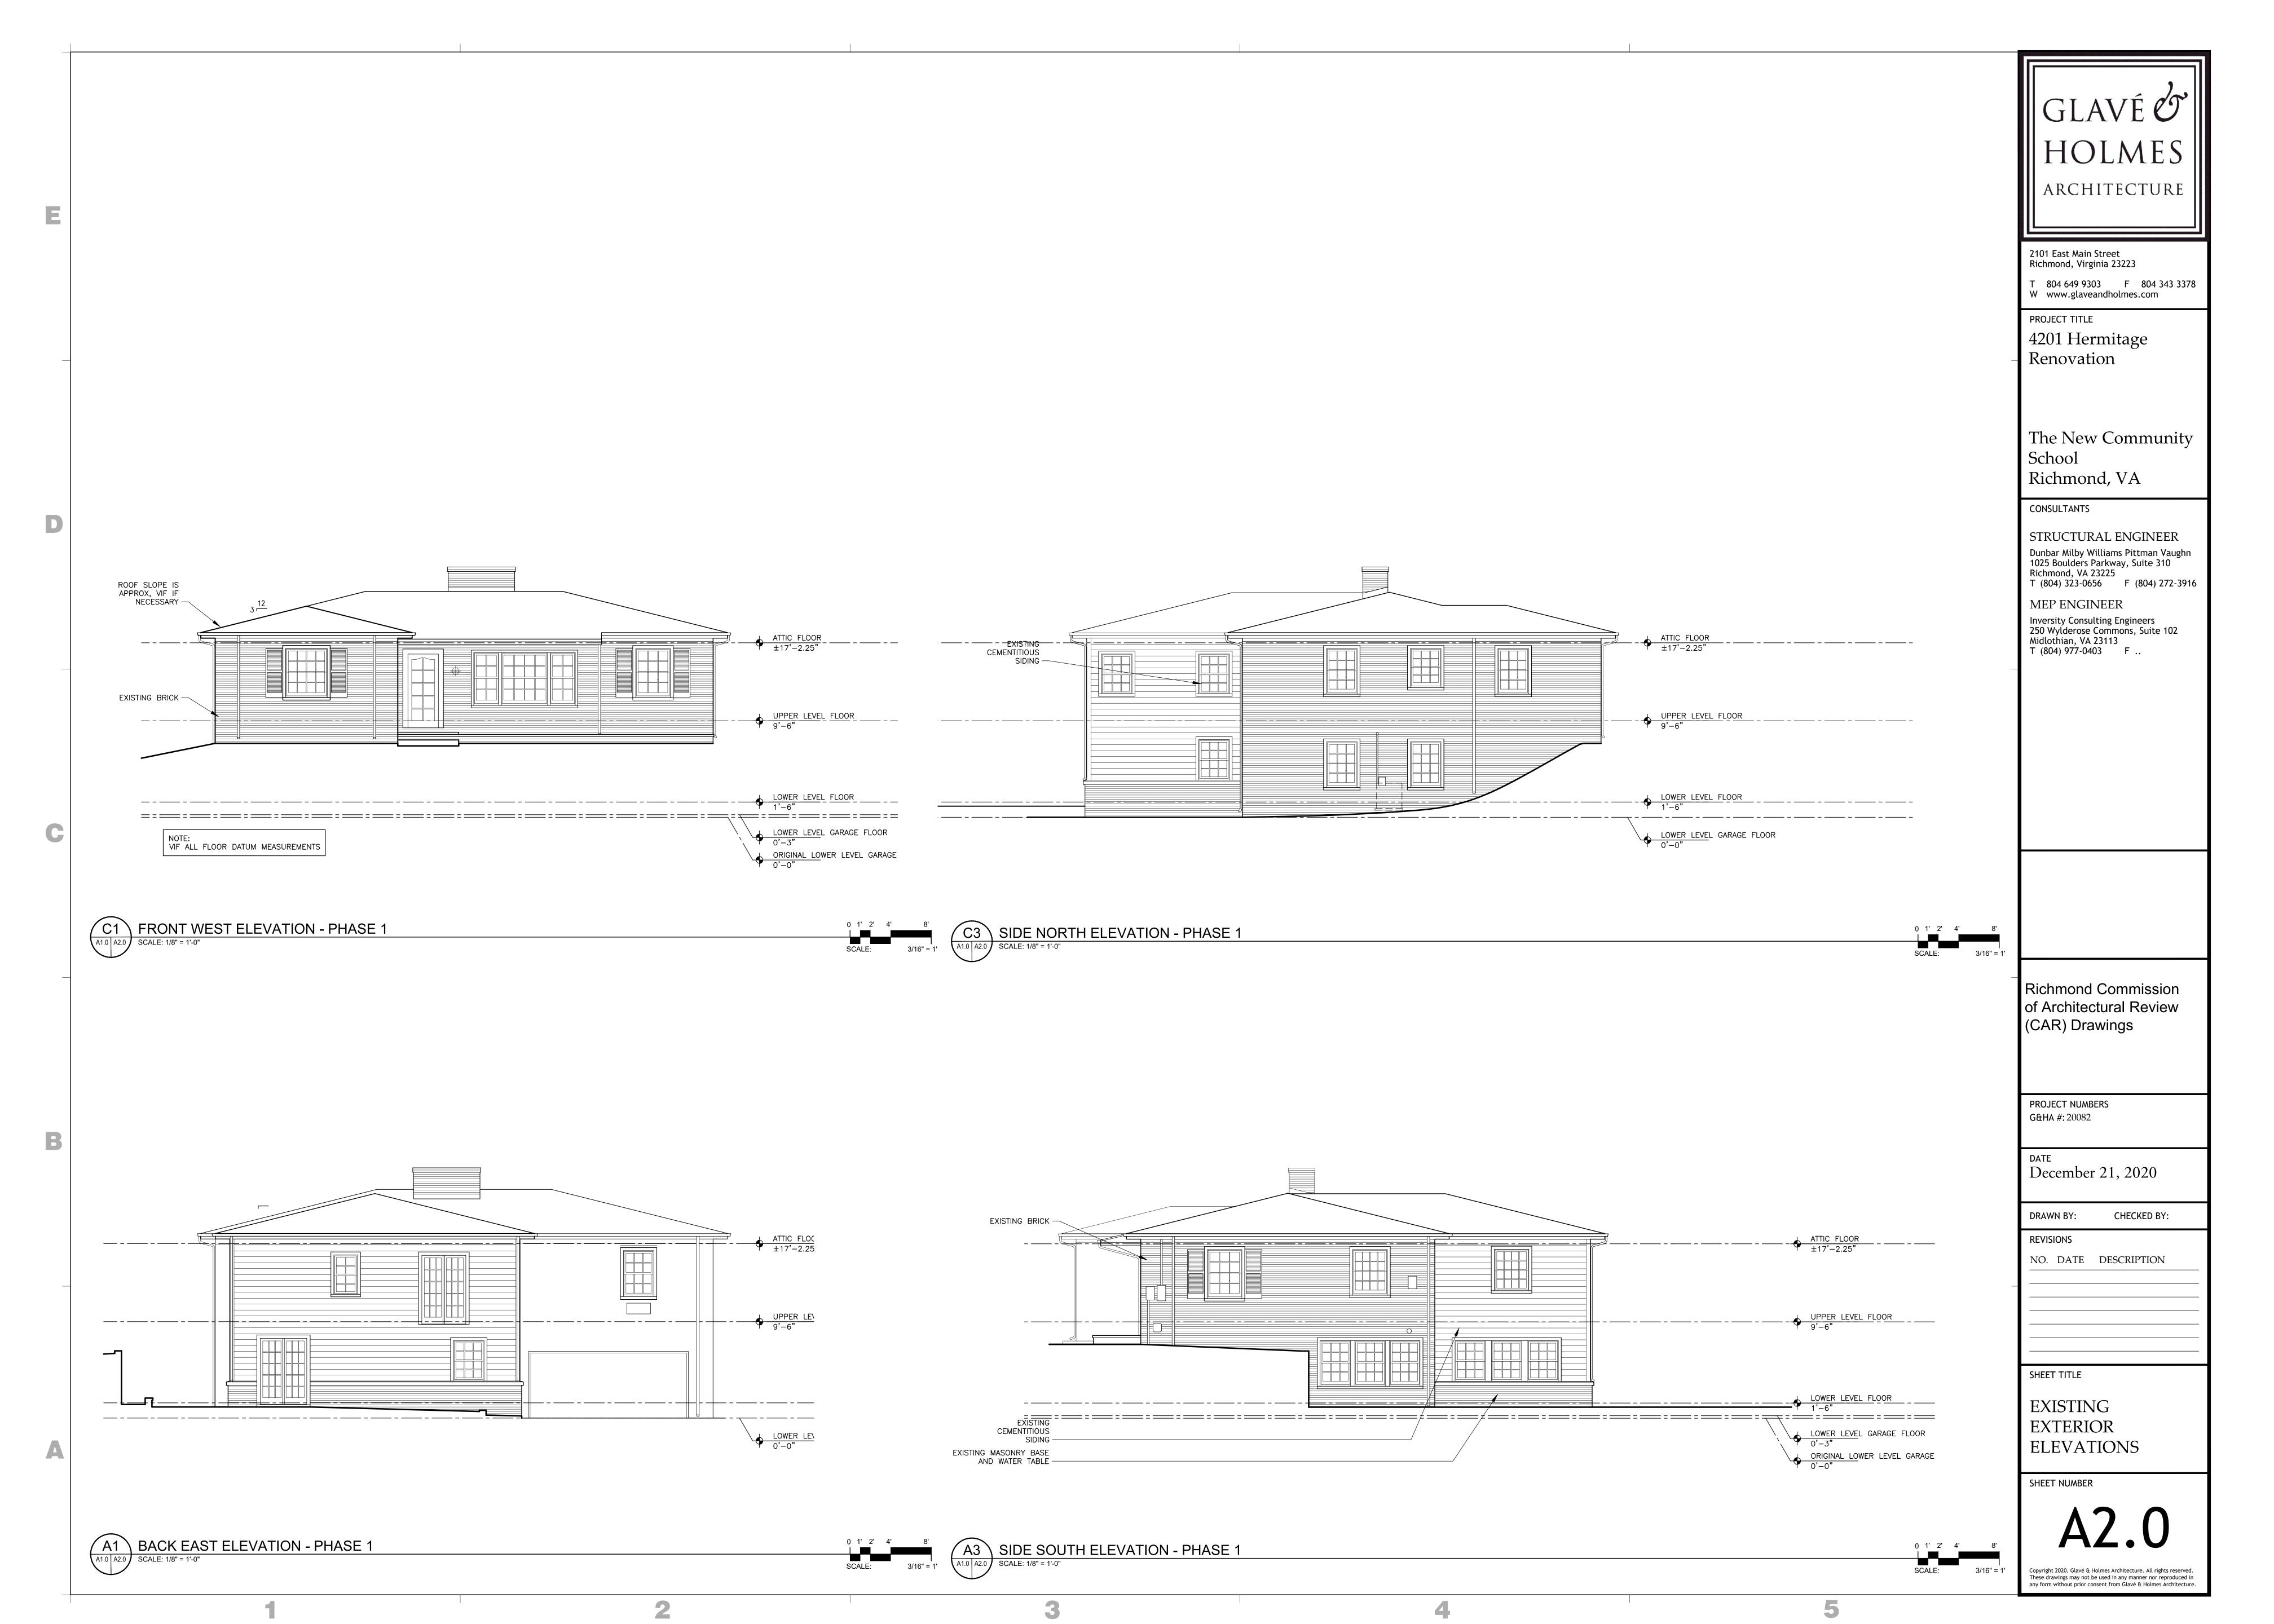



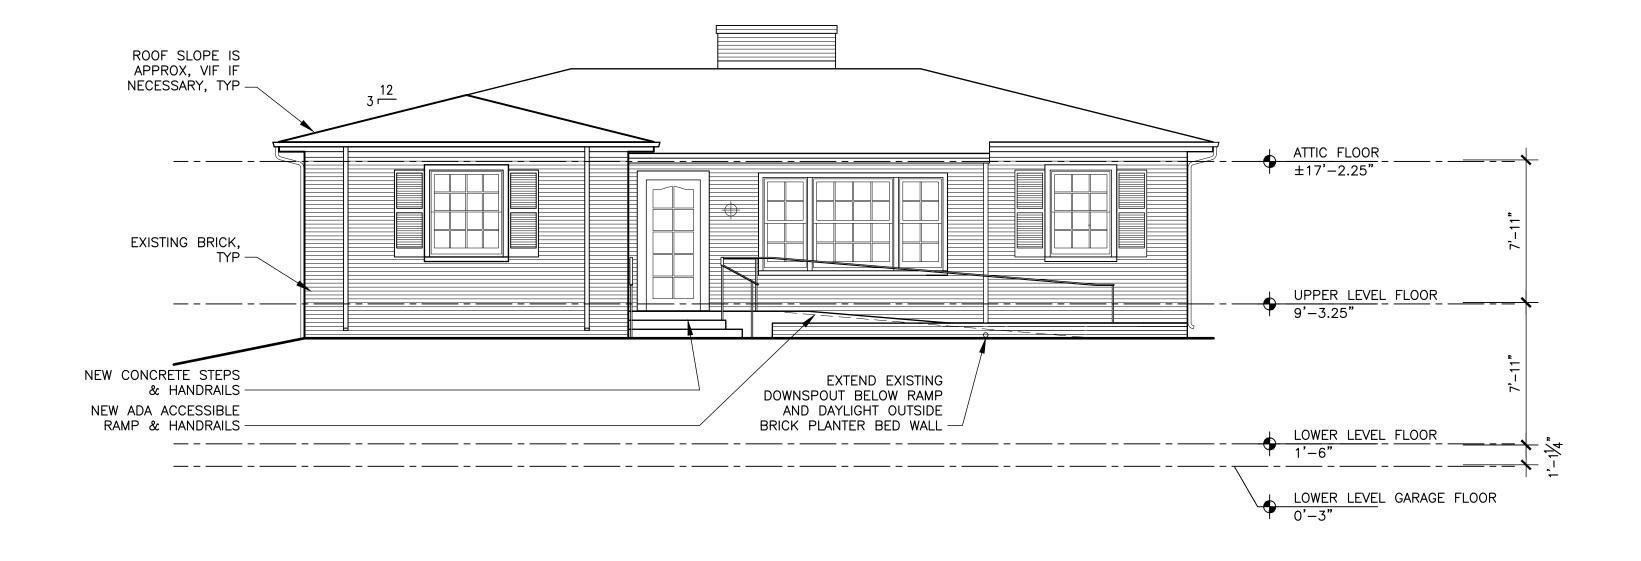


C1

FRONT WEST ELEVATION - PHASE 2

SCALE: 3/16" = 1'


SCALE: 1/8" = 1'-0"

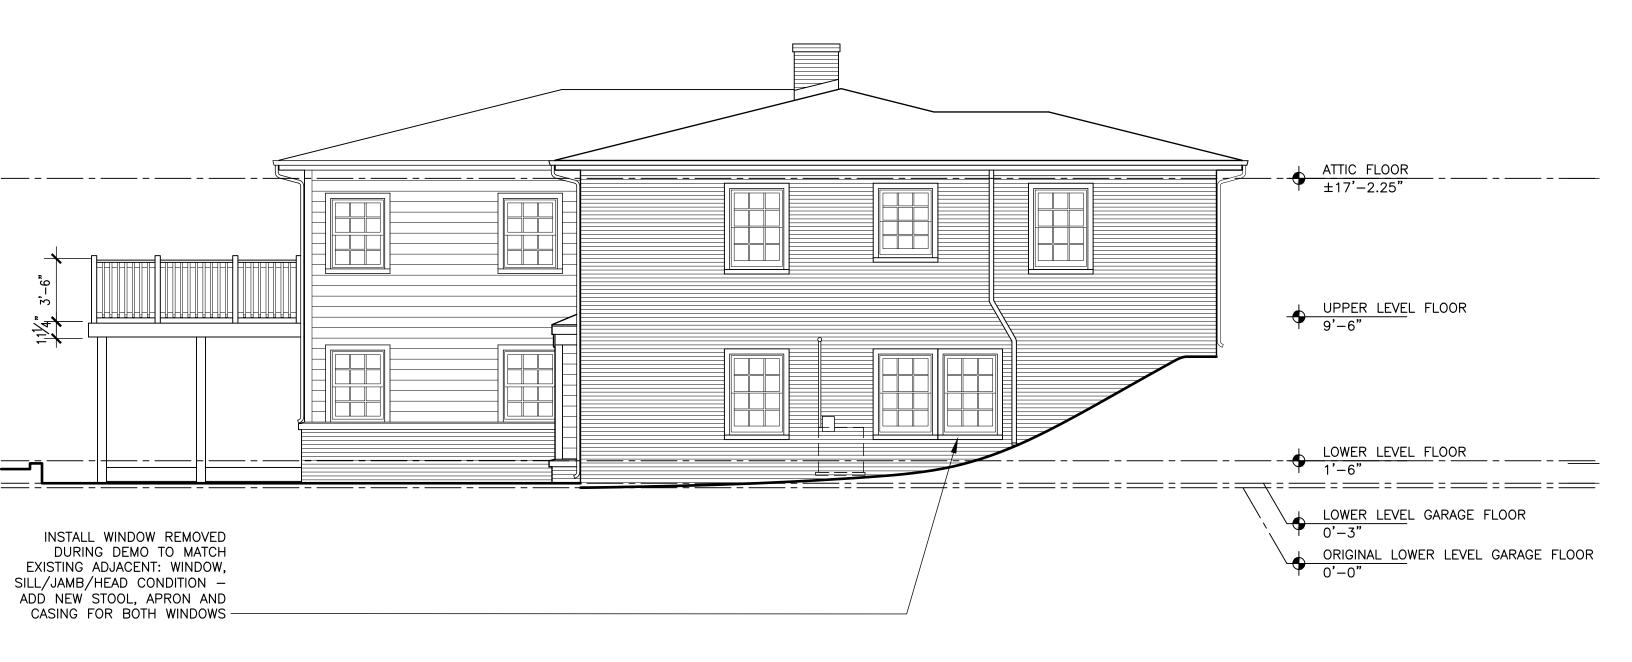



0 1' 2' 4' SCALE: 3/16" = 1'

SCALE: 1/8" = 1'-0"

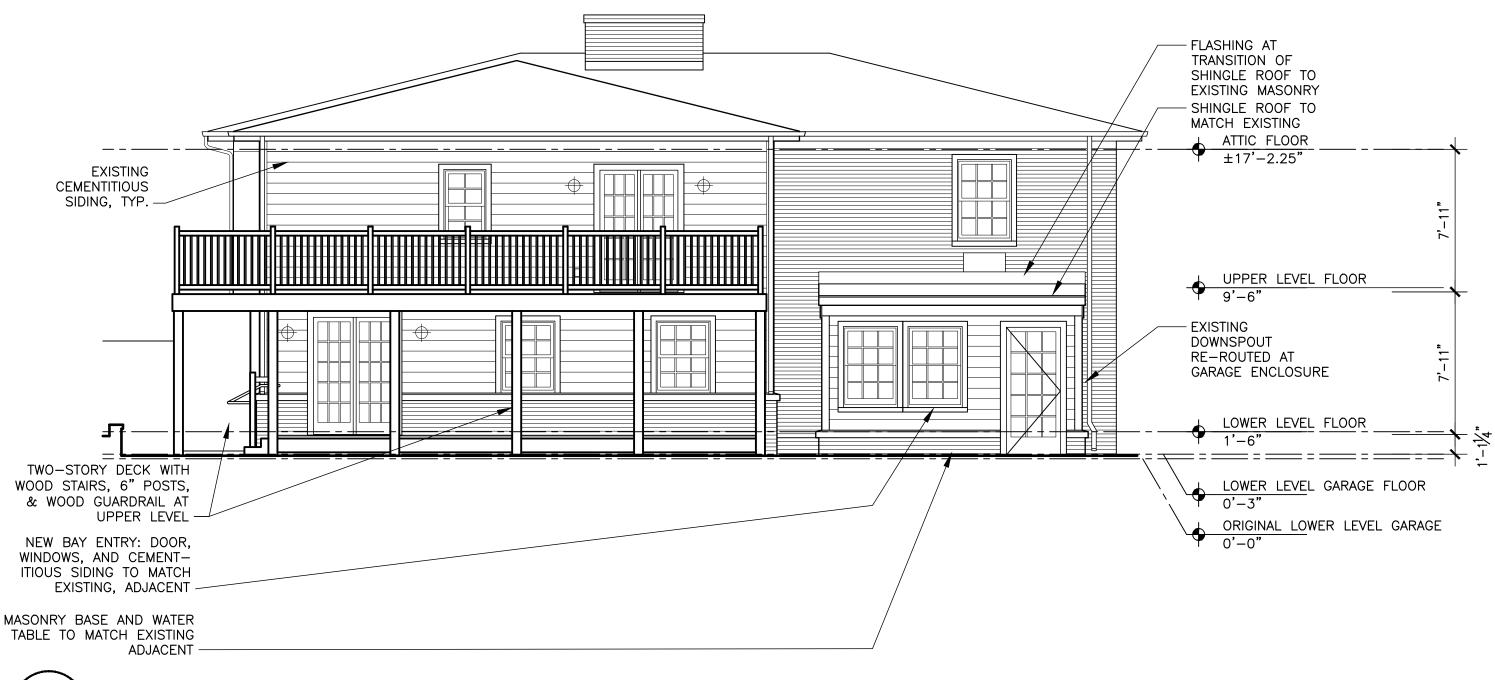

A1.0 A2.0

BACK EAST ELEVATION - PHASE 2

0 1' 2' 4' 8' SCALE: 1/8" = 1'-0" 3/16" = 1' SCALE:

