

#### **COMMISSION OF ARCHITECTURAL REVIEW**

#### APPLICATION FOR CERTIFICATE OF APPROPRIATENESS

	tion of work) Duval Street, Richmond VA ackson Ward District	Date/time rec'd:  Rec'd by:  Application #:  Hearing date:			
APPLICANT INF	ORMATION				
Name Roy	L. Delph		Phone	804-347-7330	
Company DePas	quale Delph Gentilhomme Group		<u>Email</u>	rdelph@dggrouparchitects.com	
Mailing Address	0 East 4th Street Studio 39, Richmo	ond VA 23224	Applicant Type: ☐ Owner ☐ Agent ☐ Lessee ☐ Architect ☐ Contractor ☐ Other (please specify):		
	MATION (if different from abo	ve)	Compar	Sixth Mount Zion Baptist  Church	
Mailing Address	14 W Duval Street		Phone 804-648-7511		
	Richmond, VA 23220		Email webmaster@smzbc.org		
PROJECT INFOR	RMATION				
Review Type:	☐ Conceptual Review	☑ Final Review	,		
Project Type:	☐ Alteration	☐ Demolition		☐ New Construction (Conceptual Review Required)	
<b>Project Descriptio</b>	<b>n:</b> (attach additional sheets if ne	eeded)		,	
See Attached Plan	ns				

#### **ACKNOWLEDGEMENT OF RESPONSIBILITY**

**Compliance:** If granted, you agree to comply with all conditions of the COA. Revisions to approved work require staff review and may require a new application and CAR approval. Failure to comply with the COA may result in project delays or legal action. The COA is valid for one (1) year and may be extended for an additional year, upon written request.

**Requirements:** A complete application includes all applicable information requested on checklists to provide a complete and accurate description of existing and proposed conditions. <u>Applicants proposing major new construction</u>, including <u>additions</u>, should meet with Staff to review the application and requirements prior to submitting an application. Owner contact information and signature is required. Late or incomplete applications will not be considered.

**Zoning Requirements:** Prior to Commission review, it is the responsibility of the applicant to determine if zoning approval is required and application materials should be prepared in compliance with zoning.

Signature of Owner (Kolof W. Bind), Date August 27, 2019

# SIXTH MOUNT ZION BAPTIST CHURCH

# 14 WEST DUVAL STREET RICHMOND, VA 23220

# **OWNER:** SIXTH MOUNT ZION BAPTIST CHURCH 18 WEST DUVAL STREET RICHMOND, VA 23220 PHONE 804.648.7511 CONTACT: ROBERT BROWN EMAIL: advisorrob@comcast.net ARCHITECT: DEPASQUALE DELPH GENTILHOMME GROUP 18 WEST FRANKLIN STREET RICHMOND, VA 23220 PHONE 1.804.649.2192 CONTACT: ROY L. DELPH III EMAIL: RDELPH@DGGROUPARCHITECTS.COM STRUCTURAL ENG.: LYNCH MYKINS 4198 COX ROAD GLEN ALLEN, VA 23060 PHONE 1.804.346.3935 CONTACT: JOHN HANCOCK EMAIL: JHANCOCK@STROUDPENCE.COM HISTORIC TAX CREDIT CONSULTANT COMMONWEALTH PRESERVATION GROUP P.O. BOX 11083 NORFOLK, VA 11083 Phone 1.757.923.1900 Email: PAGE@COMMONWEALTHPRESERVATIONGROUP.COM GENERAL CONTRACTOR **CENTURY CONSTRUCTION INC** 7416 FOREST HILL AVENUE RICHMOND, VA 23225 Phone 1.804.330.4400 Contact: NEIL PALMER Email:NPALMER@CENTURYCONSTRUCTIONINC.COM CODE ANALYSIS CODE ANALYSIS APPLICABLE CODE: INTERNATIONAL BUILDING CODE 2015 VIRGINIA UNIFORM STATEWIDE BUILDING CODE, 2015, 1.USE GROUP: A - 3 2.CONSTRUCTION CLASSIFICATION: 3B 3.BUILDING AREA (SECTION 503): EQUATION 5-1 AREA MODIFICATIONS (506.1) $A(A) = \{AT + [ATXIF] + [ATXIS]\}$ WHERE: A(T) = 9,500 (TABLE 503 VALUE FOR 3B CONSTRUCTION) I(S) = 0A(A) = 9,500 + [9,500\*0 + [0]]A(A) = 9,500 + 0A(A) = 9,500 SF/FLOOREXISTING BUILDING AREA: 8,904 S.F. < A(A) 4. EXIT REQUIREMENTS PER TABLE 1019.1 REFER TO SHEET LS1.1 & 5. PLUMBING FIXTURE CALCULATIONS REFER TO SHEET LS1.1 & LS1.2

PROJECT TEAM

# PROJECT SCOPE

#### SCOPE OF THE PROJECT

INDEX OF DRAWINGS

: COVER SHEET

: FIRST AND SECOND FLOOR LIFE SAFETY PLAN

: FIRST AND SECOND FLOOR DEMOLITION PLAN

: ENLARGED RESTROOM PLAN / FIRST FLOOR FINISH

: ENLARGED STAIR PLAN / SECTION / SECOND FLOOR

: EXTERIOR SOUTH AND EAST BUILDING ELEVATIONS

EXTERIOR NORTH AND WEST BUILDING ELEVATIONS

: BALCONY LIFE SAFETY PLAN

: ARCHITECTURAL SITE PLAN

: BALCONY DEMOLITION PLAN

: BALCONY FLOOR PLAN

: STAIR FRAMING PLAN

: TRUSS CONNECTION DETAIL

: FIRST AND SECOND FLOOR PLANS

FINISH SCHEDULE / DOOR SCHEDULE

**EXISTING WALL** 

**DEMO WALL** 

**NEW WALL** 

EXISTING DOOR

**DEMO DOOR** 

**NEW DOOR** 

SCHEDULE / DOOR SCHEDULE

COVER

D1.2

A1.2

**STRUCTURAL** 

**LEGEND** 

**ARCHITECTURAL** 

- 1. RENOVATION OF THE EXISTING FIRST AND SECOND FLOOR RESTROOMS TO COMPLY WITH ADA RESTROOMS REQUIREMENTS, SHEET A1.3. PLUMBING FIXTURE QUANTITIES WILL REMAIN THE SAME.
- 2. DEMO EXISTING NON EGRESS SHIPS LADDERS (TWO) FROM THE SECOND FLOOR TO THE CHOIR LOFT AND CONSTRUCT TWO NEW CONVENIENCE STAIRS. SHEET A1.4.
- 3. MAINTENANCE RESTORATION
- 4. THE SCOPE OF THE PROJECT SHALL NOT INCREASE THE EXISTING OCCUPANT LOAD OF THE BUILDING. NO NEW SQUARE FOOTAGE WILL BE ADDED TO THE EXISTING SQUARE FOOTAGE OF THE BUILDING.
- 5. THE SCOPE OF THE PROJECT SHALL NOT CHANGE THE PRIMARY USE OF THE BUILDING.
- 6. SIXTH MOUNT ZION BAPTIST CHURCH REHAB IS A HISTORIC TAX CREDIT PROJECT. THE INTENT IS NOT TO REMOVE AND REPLACE ELEMENTS OF THE BUILDING, BUT TO RESTORE AND RENOVATE USING THE EXISTING ELEMENTS OF THE FACILITY. RENOVATION SHALL BE IN ACCORDANCE WITH APPLICABLE SECTION OF PRESERVATION BRIEFS, PROVIDED BY THE U.S. DEPARTMENT OF INTERIOR (FOLLOW THE LINK TO THE DETAILED DESCRIPTION OF MEANS AND METHODS OF WORK). IN ADDITION, MEANS AND METHODS FOR REHABILITATION SHALL BE APPROVED BY THE OWNER'S HISTORIC TAX CREDIT CONSULTANT. NO HISTORIC REHABILITATION SHALL BE DONE WITHOUT PRIOR APPROVAL OF MEANS AND METHODS FROM THE OWNER'S TAX CREDIT CONSULTANT

#### Secretary of the Interior's Standards for Rehabilitation

- 1. A property will be used as it was historically or be given a new use that requires minimal change to its distinctive materials, features, spaces, and spatial relationships.
- 2. The historic character of a property will be retained and preserved. The removal of distinctive materials or alteration of features, spaces, and spatial relationships that characterize a property will be avoided.
- 3. Each property will be recognized as a physical record of its time, place, and use. Changes that create a false sense of historical development, such as adding conjectural features or elements from other historic properties, will not be undertaken.
- 4. Changes to a property that have acquired historic significance in their own right will be
- 5. Distinctive materials, features, finishes, and construction techniques or examples of craftsmanship that characterize a property will be preserved.
- 6. Deteriorated historic features will be repaired rather than replaced. Where the severity of deterioration requires replacement of a distinctive feature, the new feature will match the old in design, color, texture, and, where possible, materials. Replacement of missing features will be substantiated by documentary and physical evidence.
- 7. Chemical or physical treatments, if appropriate, will be undertaken using the gentlest means possible. Treatments that cause damage to historic materials will not be used.
- 8. Archeological resources will be protected and preserved in place. If such resources must be disturbed, mitigation measures will be undertaken.
- 9. New additions, exterior alterations, or related new construction will not destroy historic materials, features, and spatial relationships that characterize the property. The new work shall be differentiated from the old and will be compatible with the historic materials, features, size, scale and proportion, and massing to protect the integrity of the property and its environment.
- 10. New additions and adjacent or related new construction will be undertaken in a such a manner that, if removed in the future, the essential form and integrity of the historic property and its environment would be unimpaired.

#### **Preservation Briefs**

#### https://www.okhistory.org/shpo/presbriefs.htm

The following Preservation Briefs are made available by the National Park Service. The HTML links will take you to the National Park Service's website (http://www.nps.gov/tps/how-to-preserve/briefs.htm ) and will open in a new window so you can easily return to the SHPO website. The PDFs are available on the SHPO website.

- 1. Assessing Cleaning and Water-Repellent Treatments for Historic Masonry Buildings
- 2. Repointing Mortar Joints in Historic Masonry Buildings 3. Improving Energy Efficiency in Historic Buildings
- 4. Roofing for Historic Buildings
- 5. Preservation of Historic Adobe Buildings
- 6. Dangers of Abrasive Cleaning to Historic Buildings
- 7. The Preservation of Historic Glazed Architectural Terra-Cotta
- 8. Aluminum and Vinyl Sidings on Historic Buildings: The Appropriateness of Substitute
- Materials for Resurfacing Historic Wood Frame Buildings 9. The Repair of Historic Wooden Windows
- 10. Exterior Paint Problems on Historic Woodwork
- 11. Rehabilitating Historic Storefronts
- 12. The Preservation of Historic Pigmented Structural Glass (Vitrolite and Carrara Glass)
- 13. The Repair and Thermal Upgrading of Historic Steel Windows
- 14. New Exterior Additions to Historic Buildings: Preservation Concerns
- 15. Preservation of Historic Concrete
- 16. The Use of Substitute Materials on Historic Buildings Exteriors
- 17. Architectural Character: Identifying the Visual Aspects of Historic Buildings as an Aid to Preserving Their Character
- 18. Rehabilitating Interiors in Historic Buildings: Identifying and Preserving Character-Defining
- 19. The Repair and Replacement of Historic Wooden Shingle Roofs
- 20. The Preservation of Historic Barns
- 21. Repairing Historic Flat Plaster Walls and Ceilings
- 22. The Preservation and Repair of Historic Stucco 23. Preserving Historic Ornamental Plaster
- 24. Heating, Ventilating, and Cooling Historic Buildings: Problems and Recommended Approaches
- 25. The Preservation of Historic Signs
- 26. The Preservation and Repair of Historic Log Buildings
- 27. The Maintenance and Repair of Architectural Cast Iron
- 28. Painting Historic Interiors
- 29. The Repair, Replacement & Maintenance of Historic Slate Roofs
- 30. The Preservation and Repair of Historic Clay Tile Roofs
- 31. Mothballing Historic Buildings 32. Making Historic Properties Accessible
- 33. The Preservation and Repair of Historic Stained and Leaded Glass
- 34. Applied Decoration for Historic Interiors: Preserving Composition Ornament
- 35. Understanding Old Buildings: The Process of Architectural Investigation 36. Protecting Cultural Landscapes: Planning, Treatment and Management of Historic Landscapes
- 37. Appropriate Methods for Reducing Lead-Paint Hazards in Historic Housing
- 38. Removing Graffiti from Historic Masonry
- 39. Holding the Line: Controlling Unwanted Moisture in Historic Buildings
- 40. Preserving Historic Ceramic Tile Floors
- 41. The Seismic Retrofit of Historic Buildings: Keeping Preservation in the Forefront
- 42. The Maintenance, Repair and Replacement of Historic Cast Stone 43. The Preparation and Use of Historic Structure Reports
- 44. The Use of Awnings on Historic Buildings: Repair, Replacement and New Design
- 45. Preserving Historic Wood Porches
- 46. The Preservation and Reuse of Historic Gas Stations
- 47. Maintaining the Exterior of Small and Medium Size Historic Buildings
- 48. Preserving Grave Markers in Historic Cemeteries
- 49. Historic Decorative Metal Ceilings and Walls: Use, Repair and Replacement
- 50. Lightning Protection for Historic Structures



SIXTH MOUNT BAPTIST CHU

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A PROFESSIONAL CORPORATION

ARCHITECTS

18 WEST FRANKLIN STREET RICHMOND, VIRGINIA 23220 804 649-2192

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**COVER TITLE SHEET** 

#### **GENERAL NOTE:**

- 1. PRIOR TO EXECUTION OF CONTRACT, GENERAL CONTRACTOR SHALL QUANTIFY AMOUNT OF EACH REPAIR, OR PROVIDE ALLOWANCES WHERE QUANTIFYING IS NOT APPLICABLE. UNIT COST SHALL BE INCLUDED IN OWNER / G.C. CONTRACT FOR NON QUANTIFIABLE AMOUNTS.
- 2. SIXTH MOUNT ZION BAPTIST CHURCH REHAB IS A HISTORIC TAX CREDIT PROJECT. THE INTENT IS NOT TO REMOVE AND REPLACE ELEMENTS OF THE BUILDING, BUT TO RESTORE AND RENOVATE USING THE EXISTING ELEMENTS OF THE FACILITY. RENOVATION SHALL BE IN ACCORDANCE WITHE APPLICABLE SECTION OF "STANDARDS FOR REHABILITATION AND GUIDELINES FOR REHABILITATING HISTORIC BUILDINGS", PROVIDED BY THE U.S. DEPARTMENT OF INTERIOR AND INCLUDED IN THE APPENDIX A OF THE PROJECT MANUAL. IN ADDITION, MEANS AND METHODS FOR REHABILITATION SHALL BE APPROVED BY THE OWNER'S HISTORIC TAX CREDIT CONSULTANT. NO HISTORIC REHABILITATION SHALL BE DONE WITHOUT PRIOR APPROVAL OF MEANS AND METHODS FROM THE OWNER'S TAX CREDIT CONSULTANT.

S1 NOT USE  S2 REPAIR		4
		4
S2 REPAIR		<del> </del>
	BRICK SIDEWALK	2
NOT USE	ED .	5
REPAIR A	ASPHALT PAVEMENT TO STORM DRAIN	6
S5 REPAIR	BRICK AT BASE OF HANDRAILS	3
S6 REPAIR	CRACKS IN CONCRETE STEPS	17,20,21
S7 INSTALL	STORM DRAIN AT ADIM. ENTRANCE, TIE TO EXISTING STORM DRAIN	
S8 DEMO EX	XISTING SIDEWALK AND INSTALL NEW LEVEL SIDEWALK , SLOPE 2% AWAY FROM BUILDING	33
S9 CLEAN A	ALL DOWNSPOUTS AND, STORM DRAINS AND CLEANOUTS TO PROVIDE POSITIVE FLOW AWAY UILDING	36

SITE RESTORATION SCHEDULE



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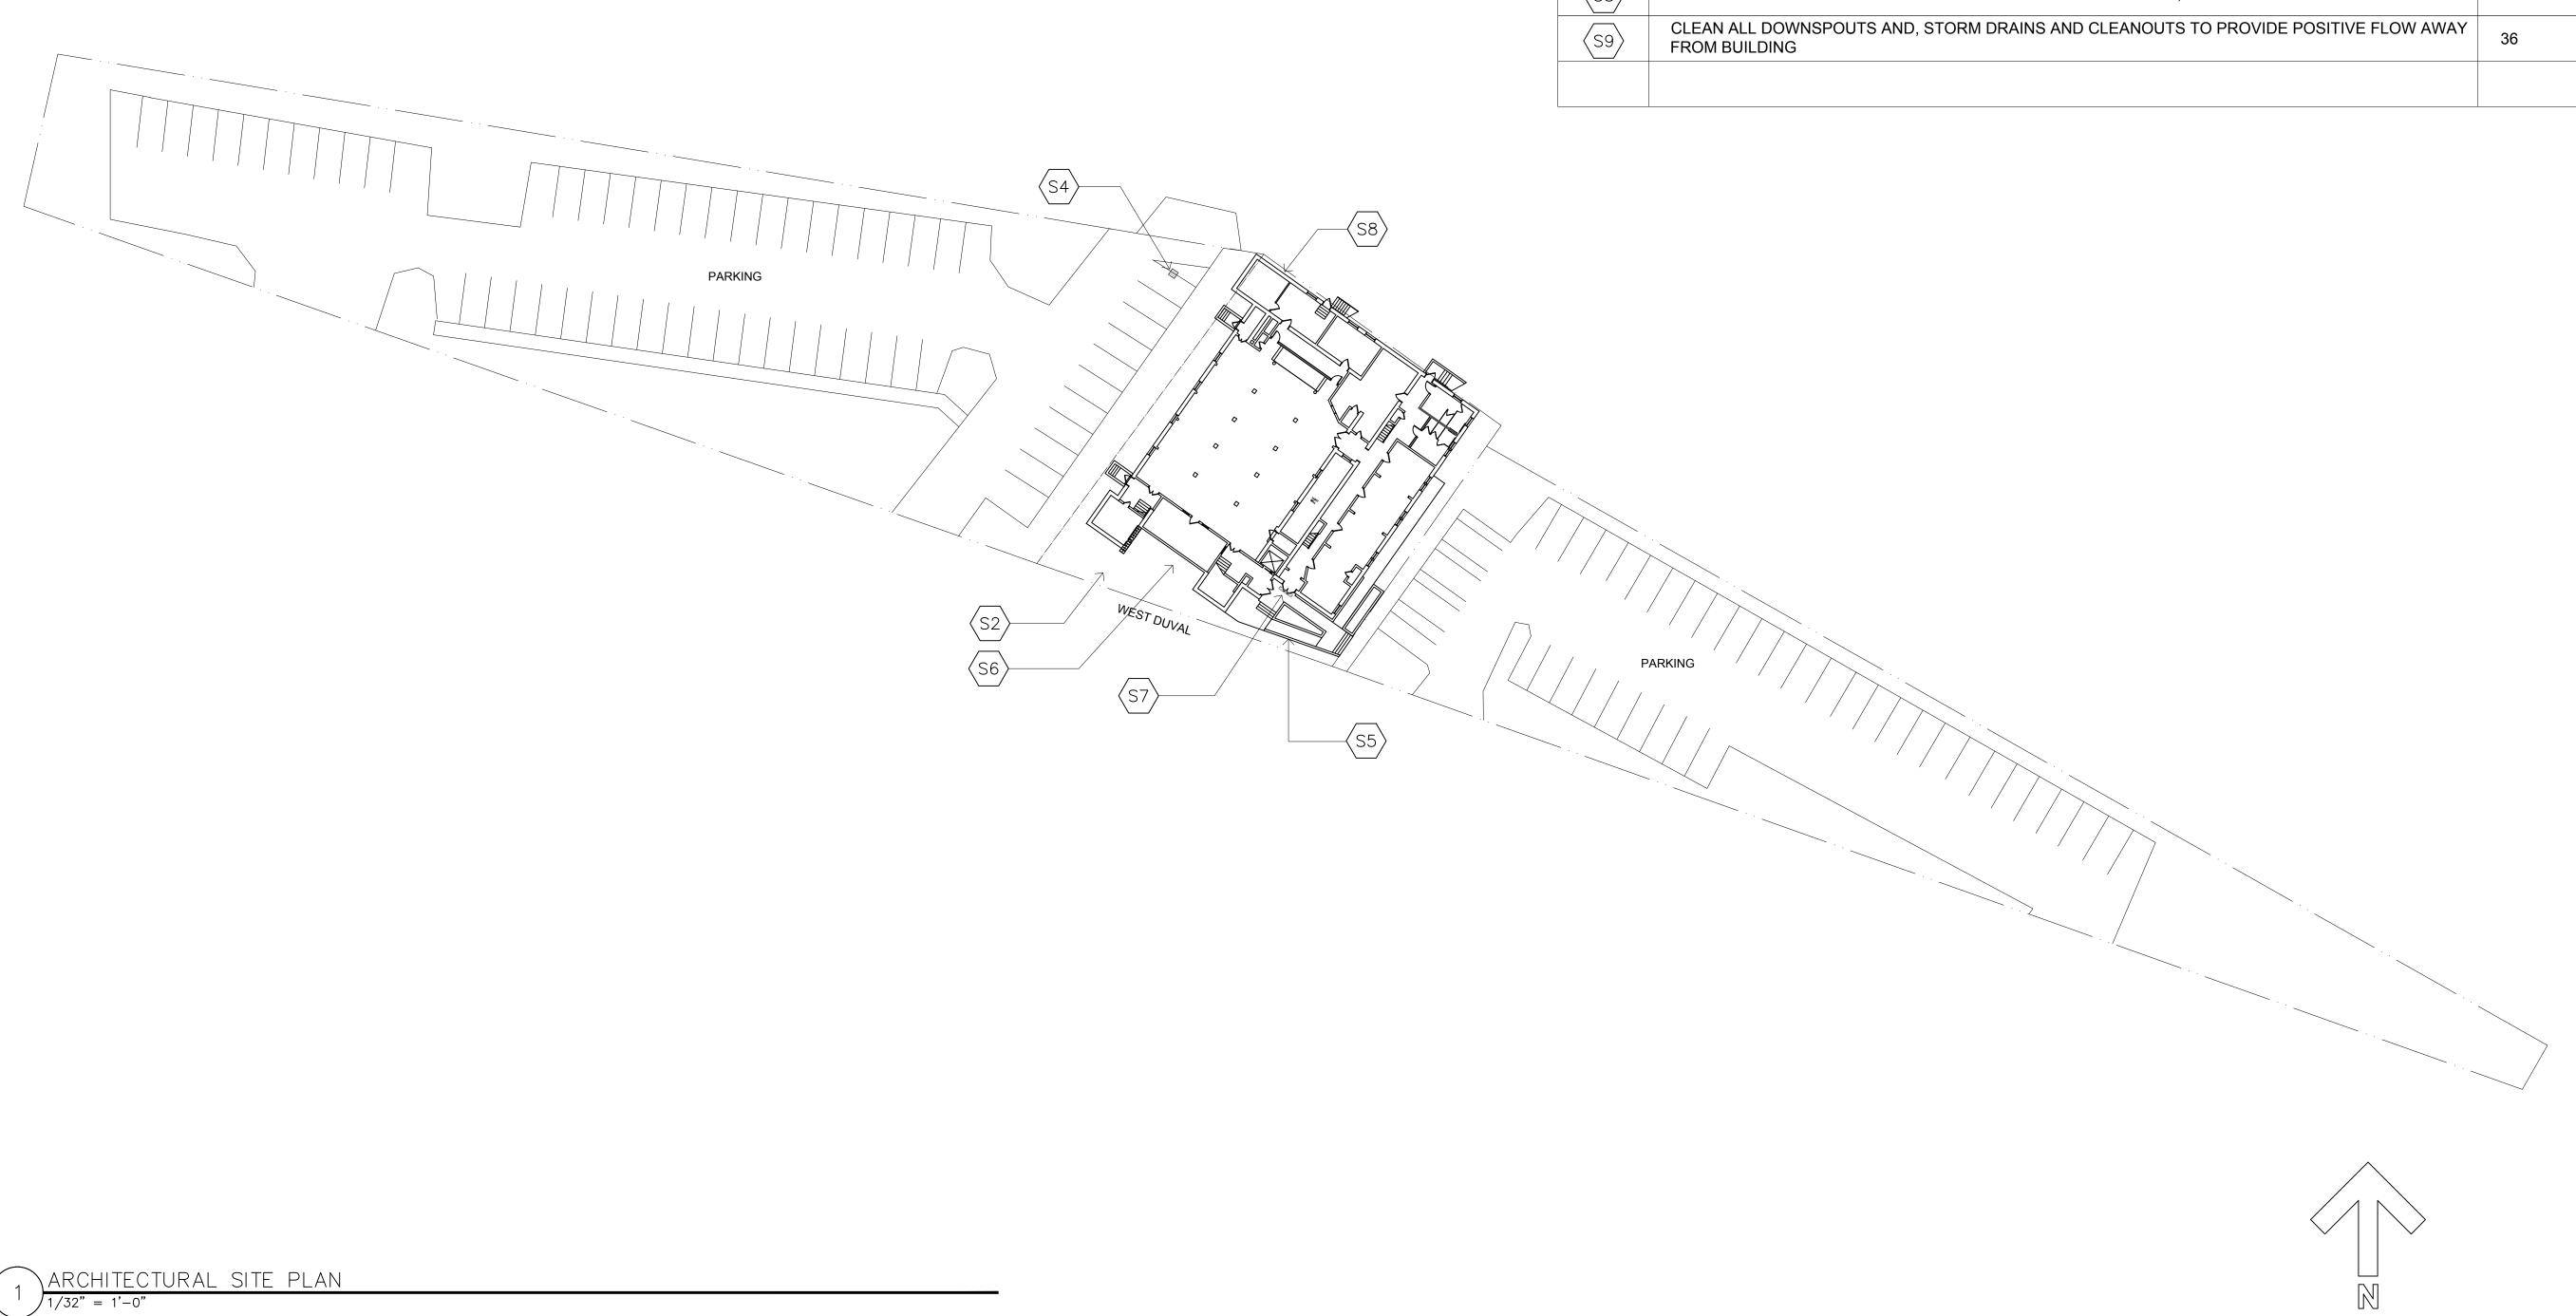
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ARCHITECTURAL SITE PLAN






#### BUILDING PLUMBING CALCULATIONS

А3	М	W
WC	$\frac{1}{150}(716) \approx 5$	$\frac{1}{75}(716) \approx 10$
LAV	$\frac{1}{200}(716) \approx 4$	$\frac{1}{200}(716) \approx 4$
DF	$\frac{1}{1000}(1431) \approx 2$	

#### EGRESS NOTE:

- E 🙀 1. EXISTING EXIT LIGHT
- 2. TABLE 1006.3.1 # OF REQUIRED EXITS PER STORY = 3 EXISTING EXITS = 4
- 3. TABLE 1017.2 REQUIRED EXIT ACCESS TRAVEL DISTANCE USE GROUP A W/O SPRINKLER = 200 LF. REFER TO FLOOR PLAN FOR TRAVEL DISTANCES

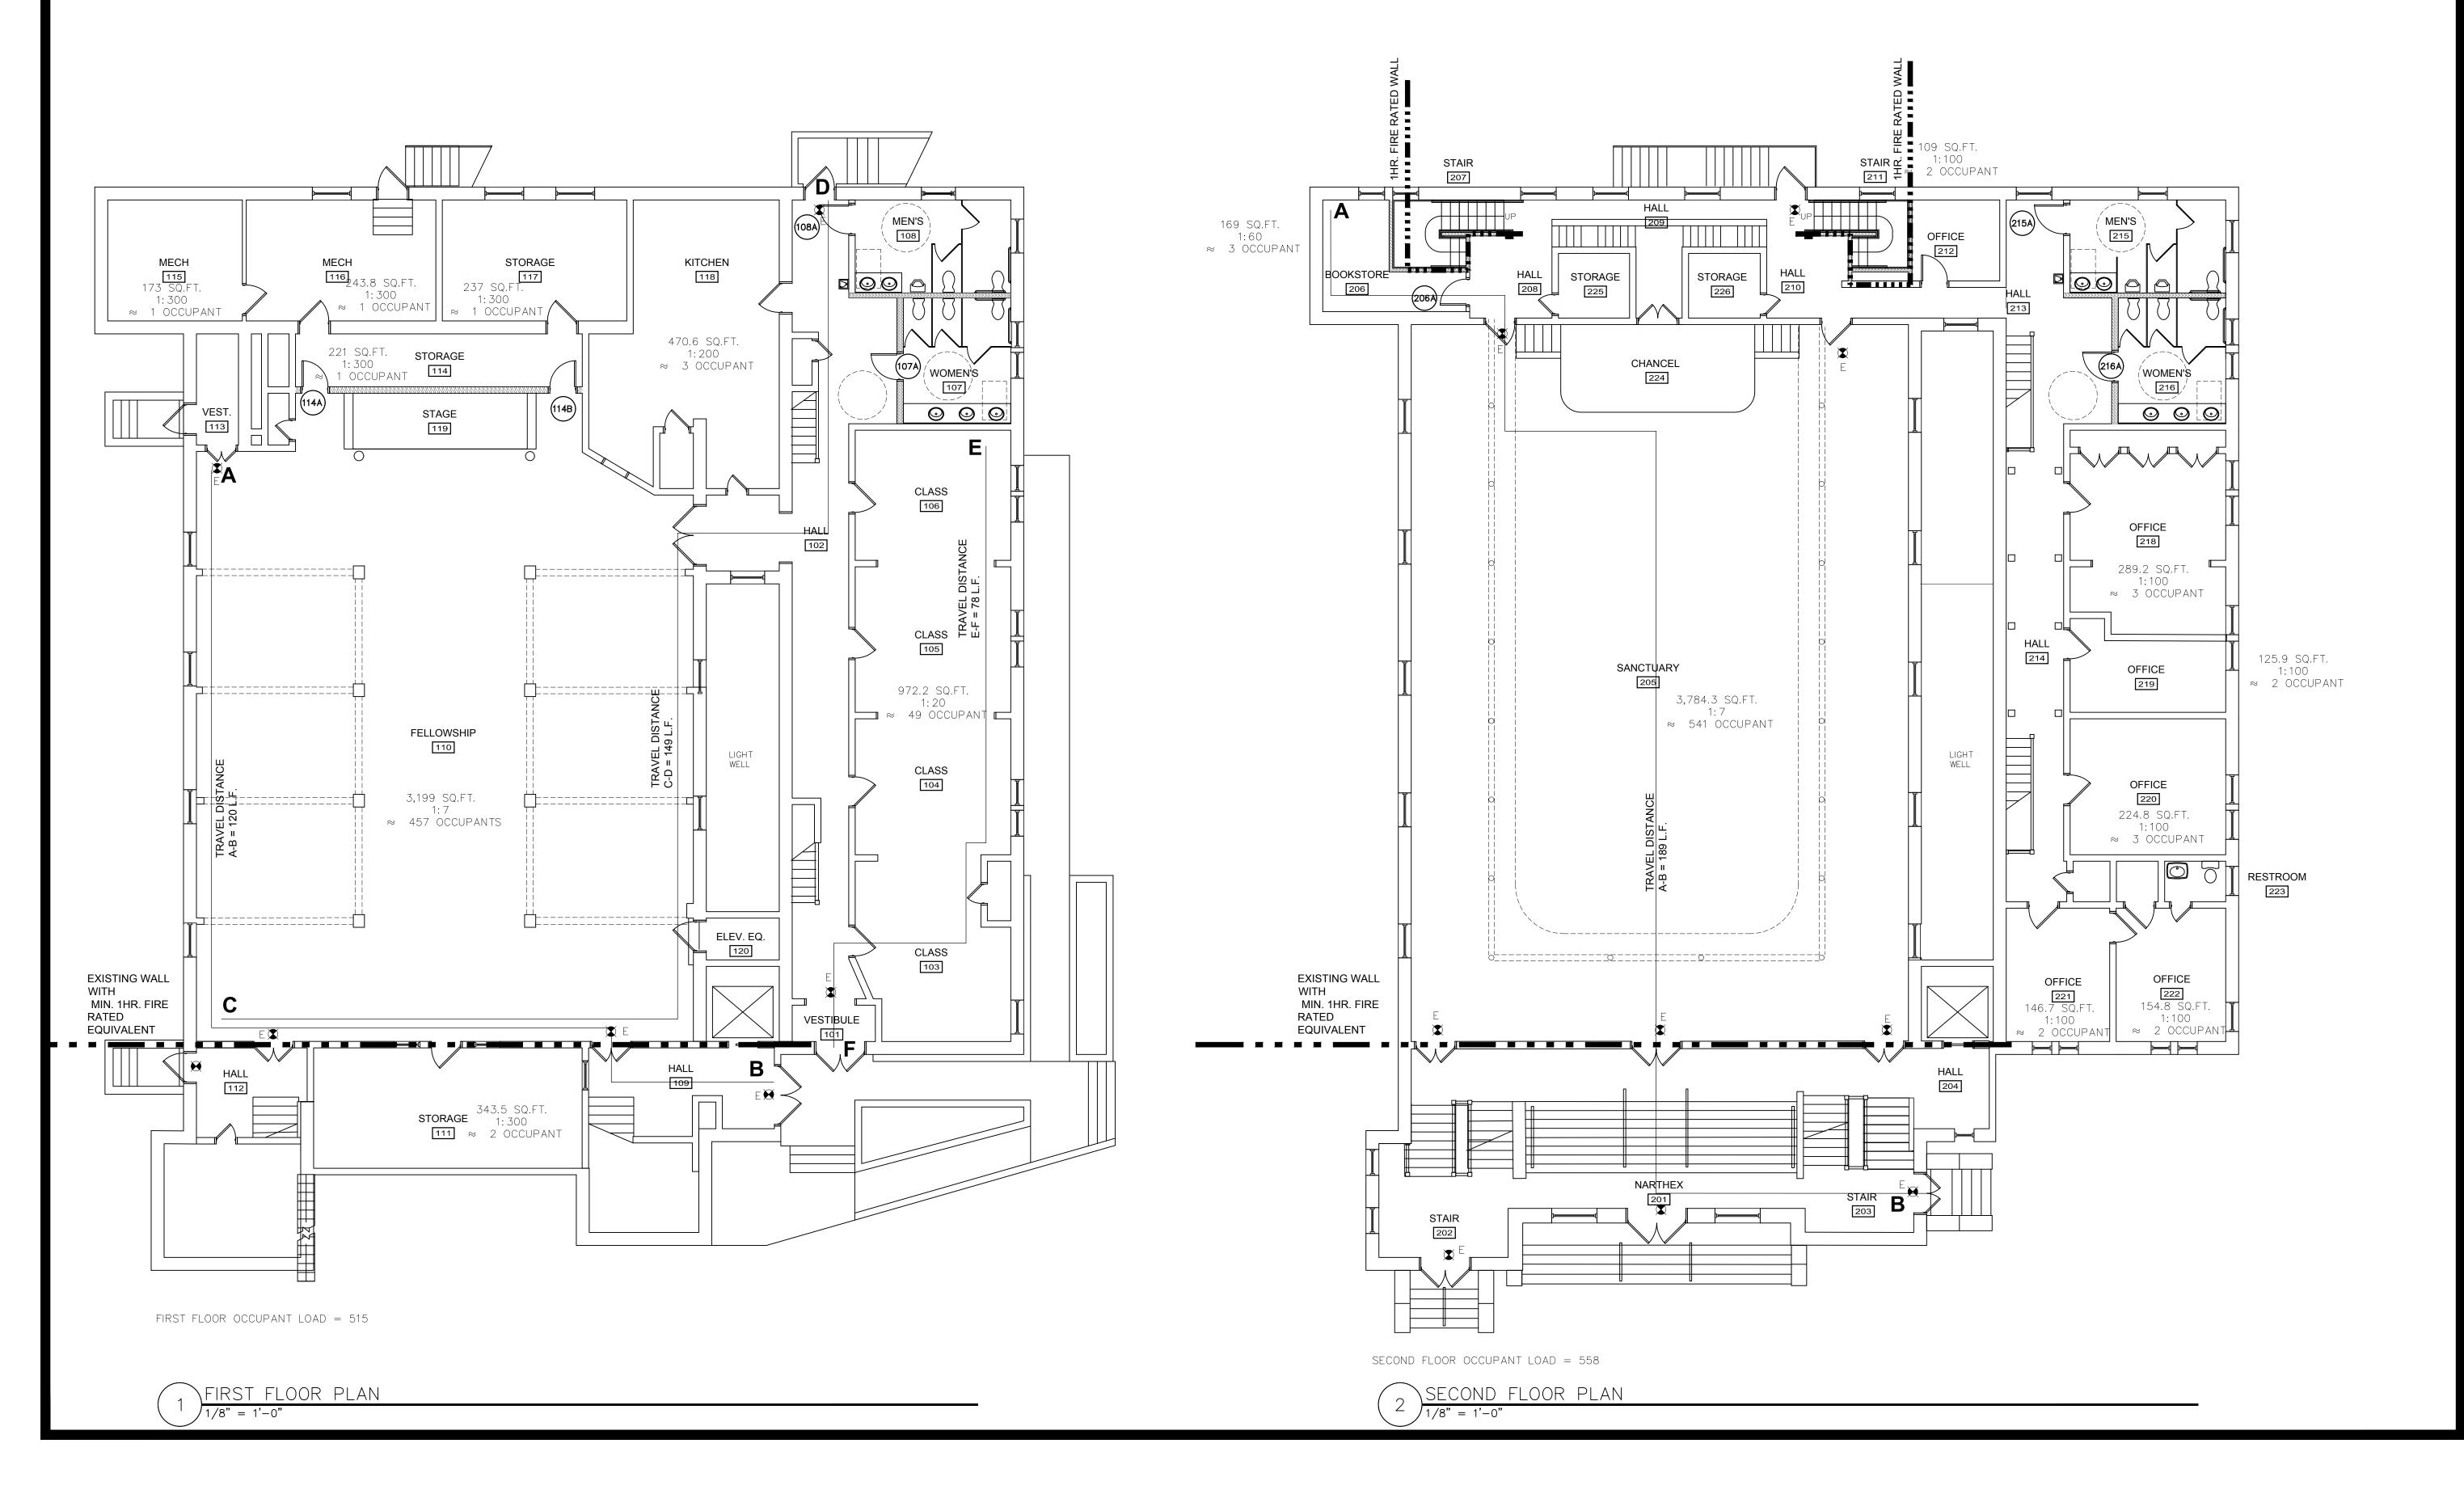



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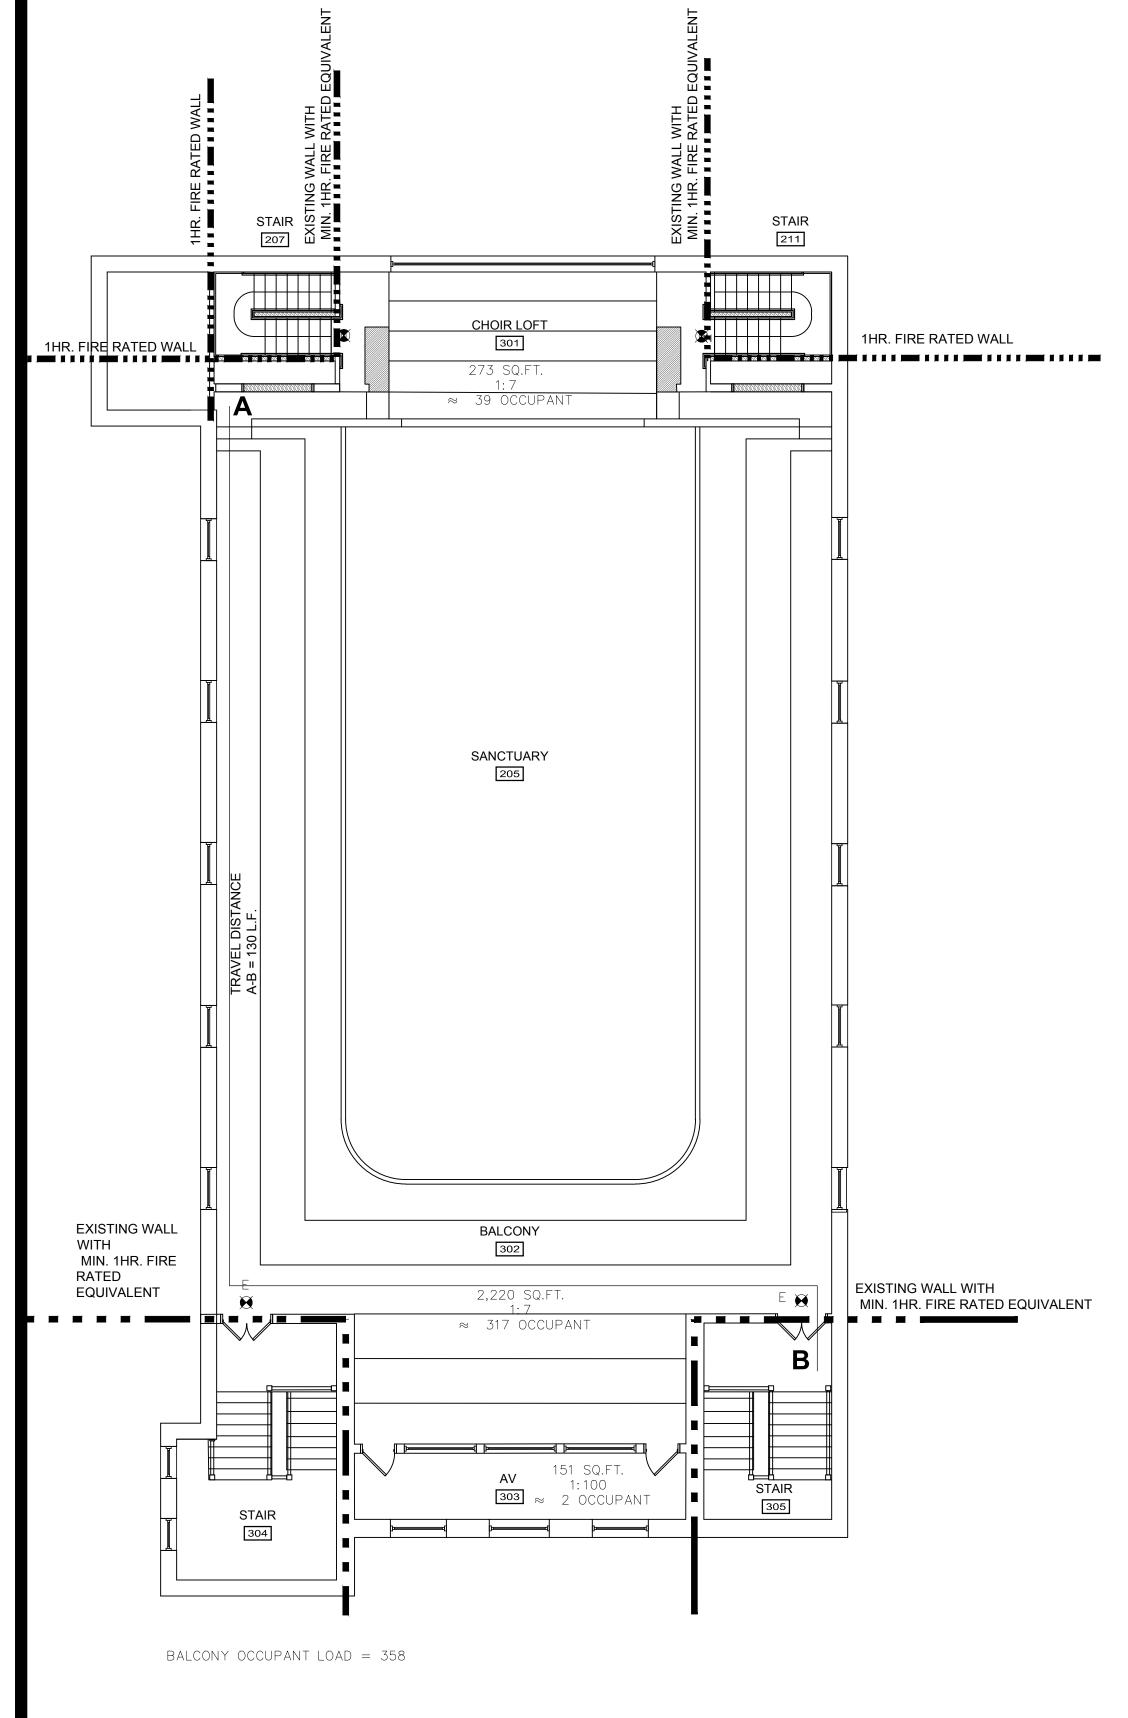
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FIRST AND SECOND FLOOR LIFE SAFETY PLAN



# EGRESS NOTE: E € 1. EXISTING EXIT LIGHT AN THR. FIRE RATED E

- 2. REFER TO SHEET LS1.1 FOR EGRESS NOTES
- 3. REFER TO SHEET LS1.1 FOR PLUMBING CALCULATIONS



BALCONY FLOOR PLAN

CERTIFICATE No.

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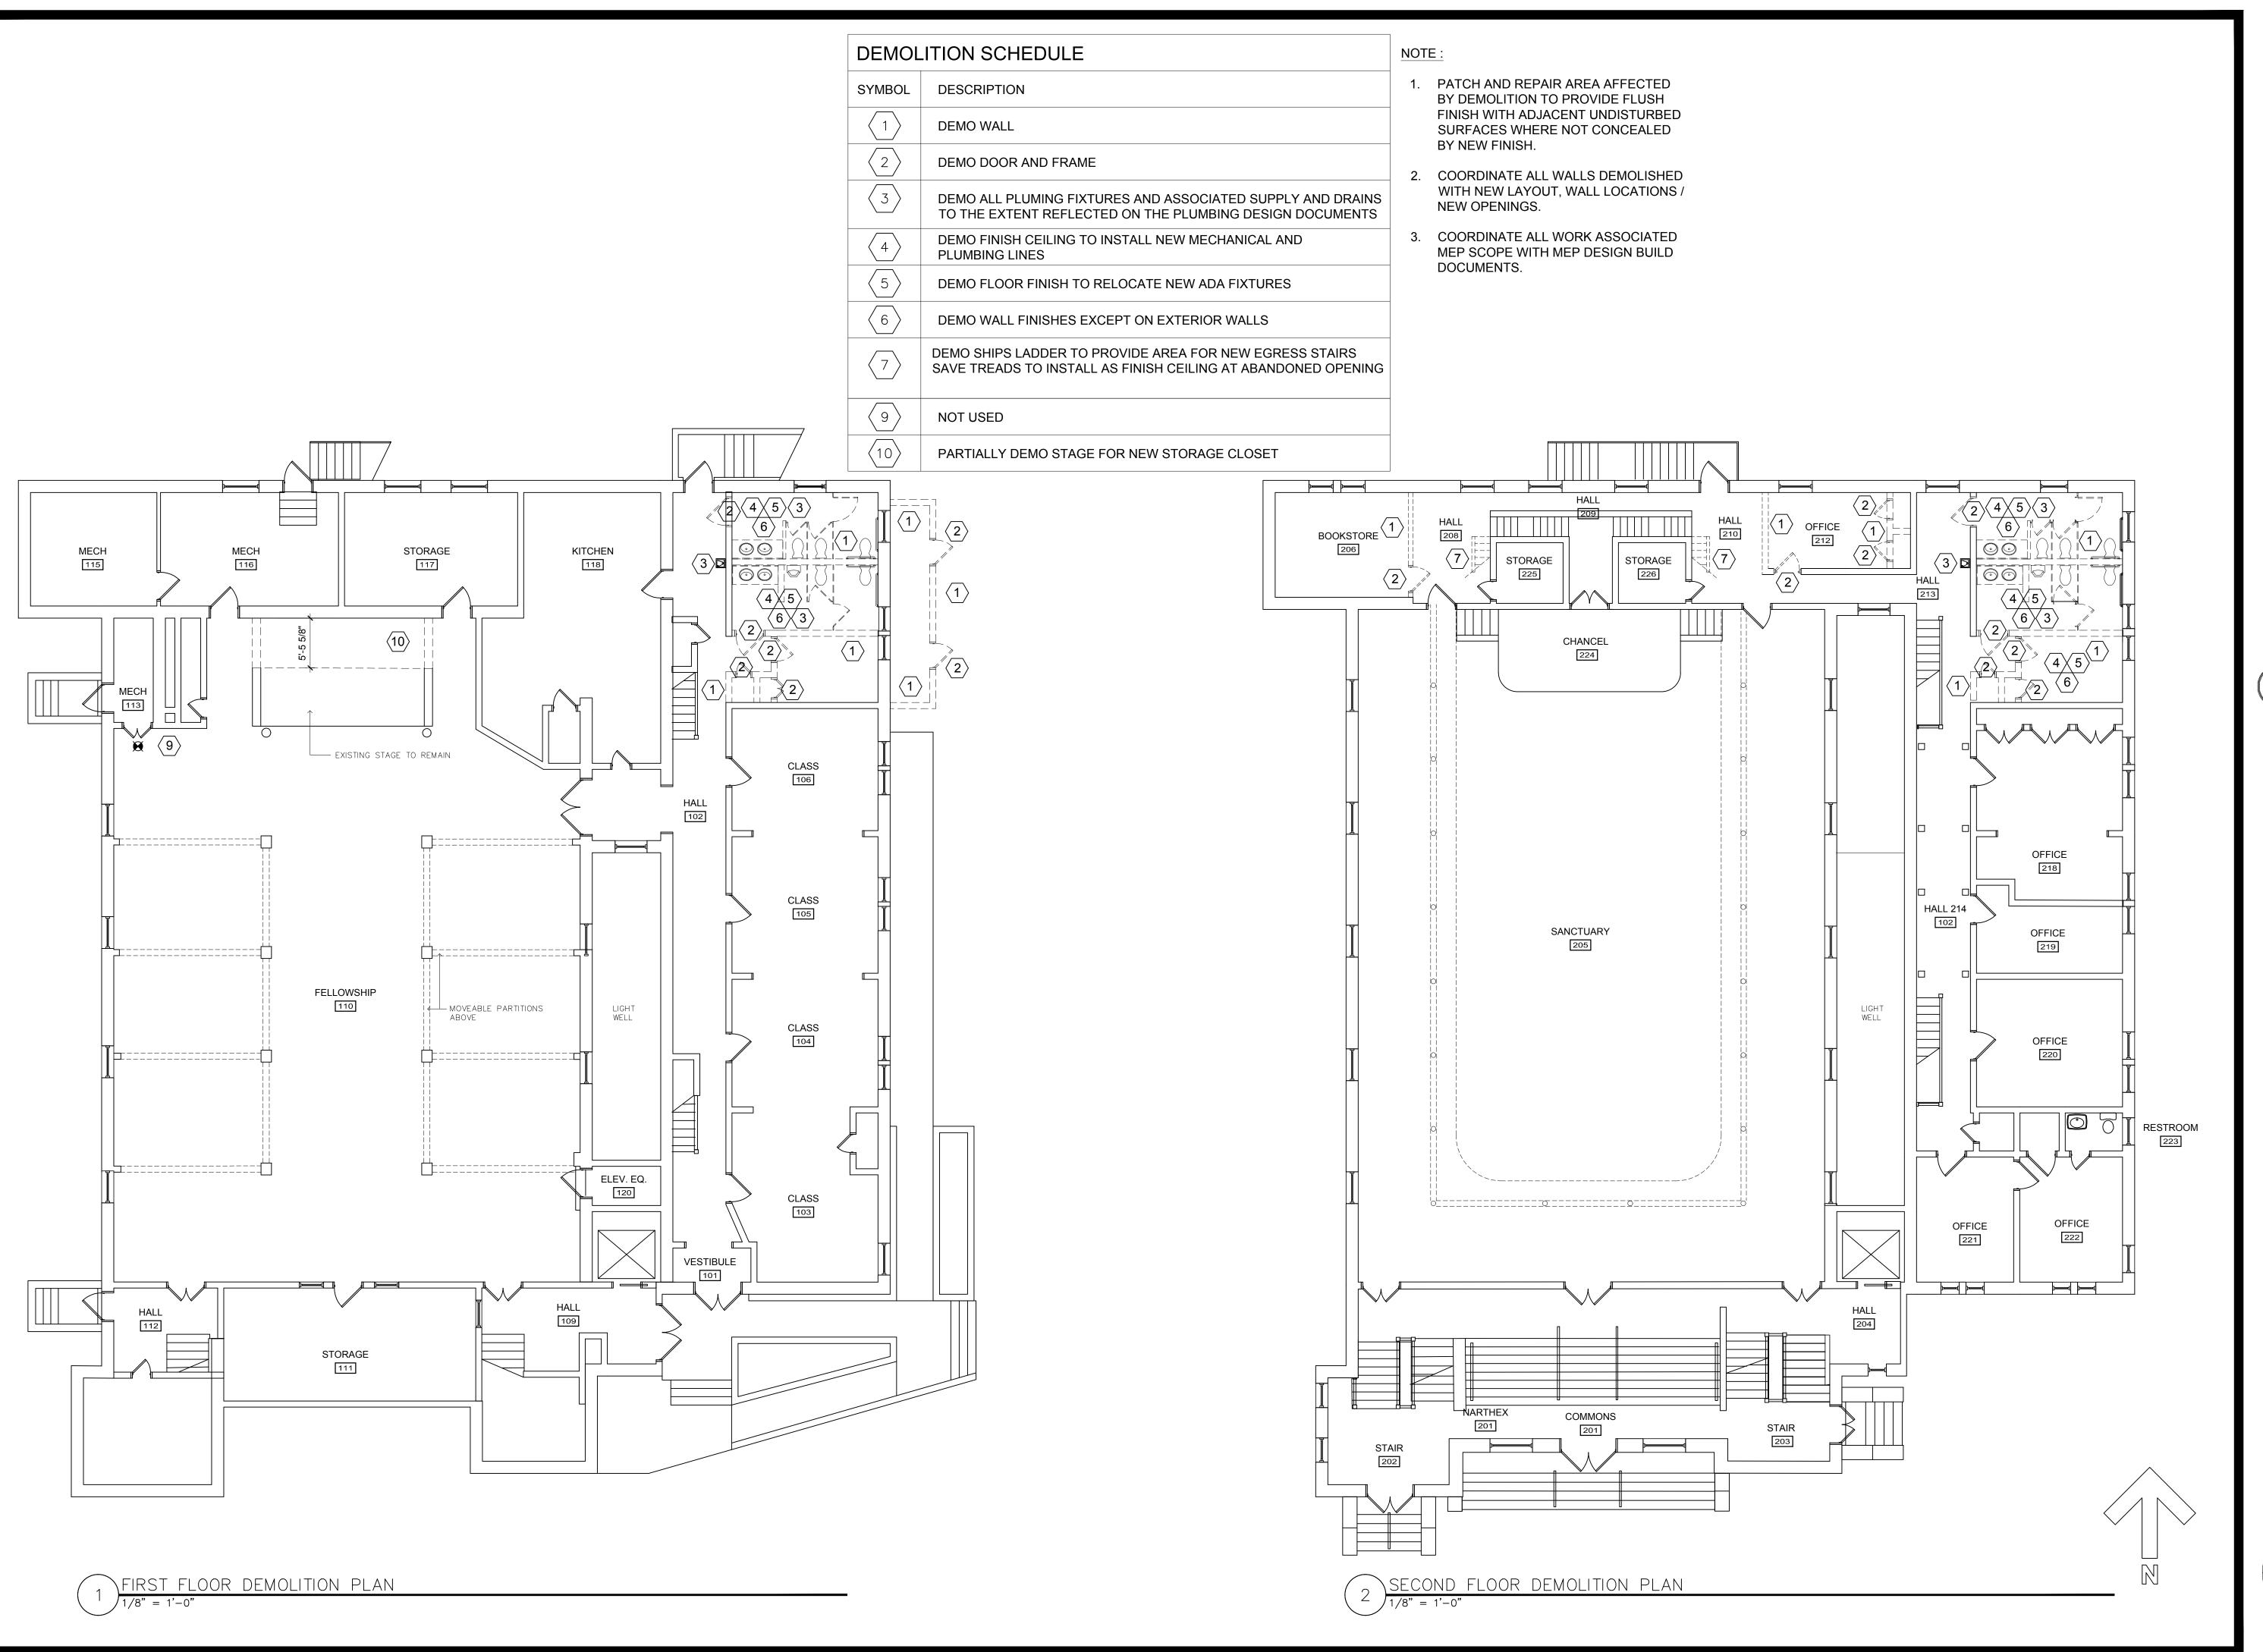
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BALCONY LIFE SAFETY PLAN





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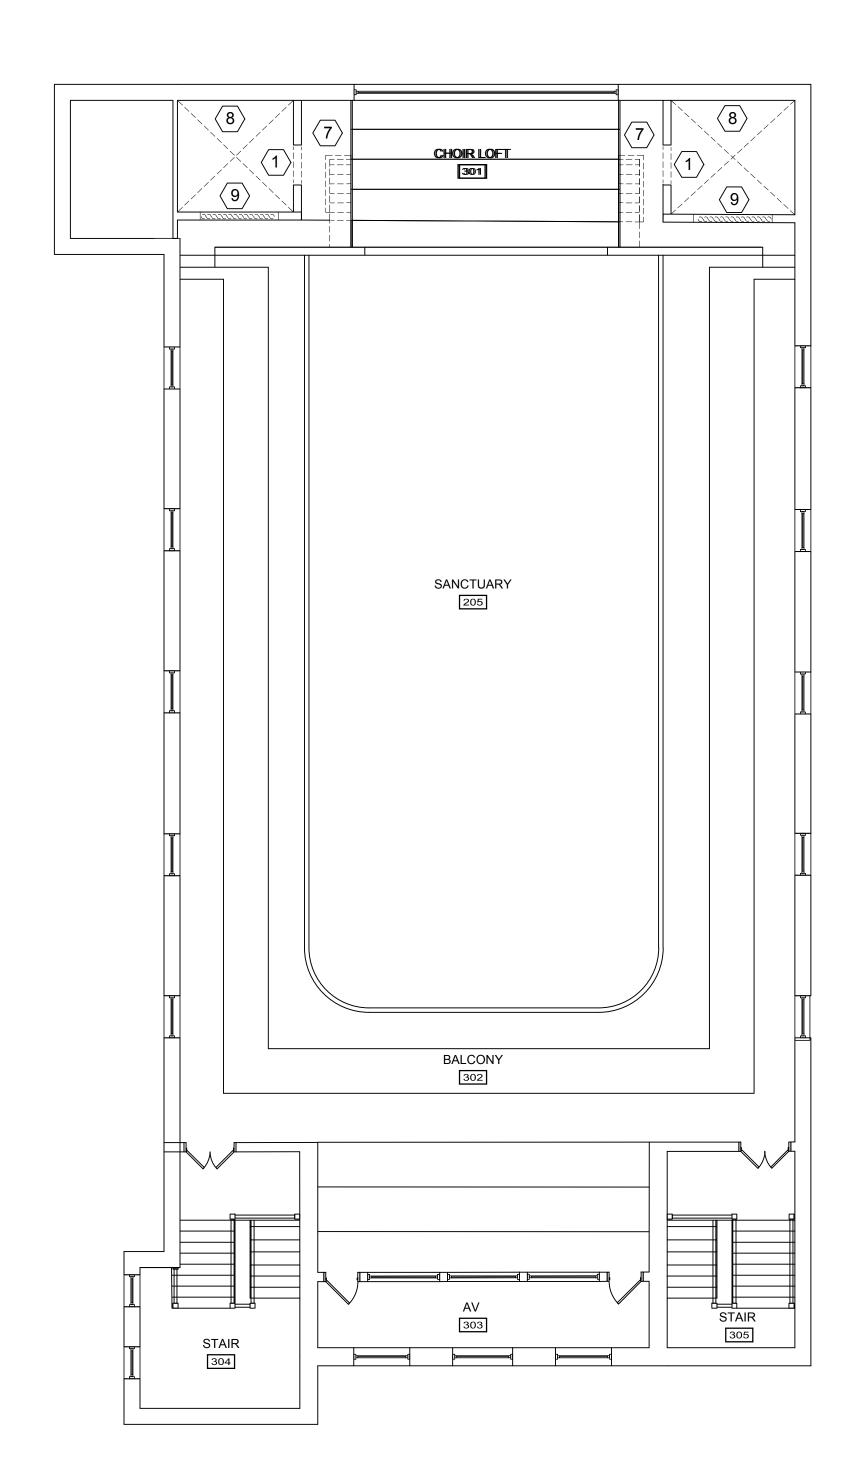
FIRST AND SECOND FLOOR DEMOLITION PLAN



DEMOLITION SCHEDULE						
SYMBOL	DESCRIPTION					
1	DEMO WALL					
7	DEMO SHIPS LADDER TO PROVIDE AREA FOR NEW EGRESS STAIRS SAVE TREADS TO INSTALL AS FINISH CEILING AT ABANDONED OPENING					
8	DEMO FLOOR / CEILING FOR NEW EGRESS STAIR					
9	DEMO FALSE ORNAMENTAL PIPE ORGAN PIPES E.S. / INFILL OPENING					

## NOTE:

- 1. PATCH AND REPAIR AREA AFFECTED BY DEMOLITION TO PROVIDE FLUSH FINISH WITH ADJACENT UNDISTURBED SURFACES WHERE NOT CONCEALED BY NEW FINISH.
- COORDINATE ALL WALLS DEMOLISHED WITH NEW LAYOUT, WALL LOCATIONS / NEW OPENINGS.





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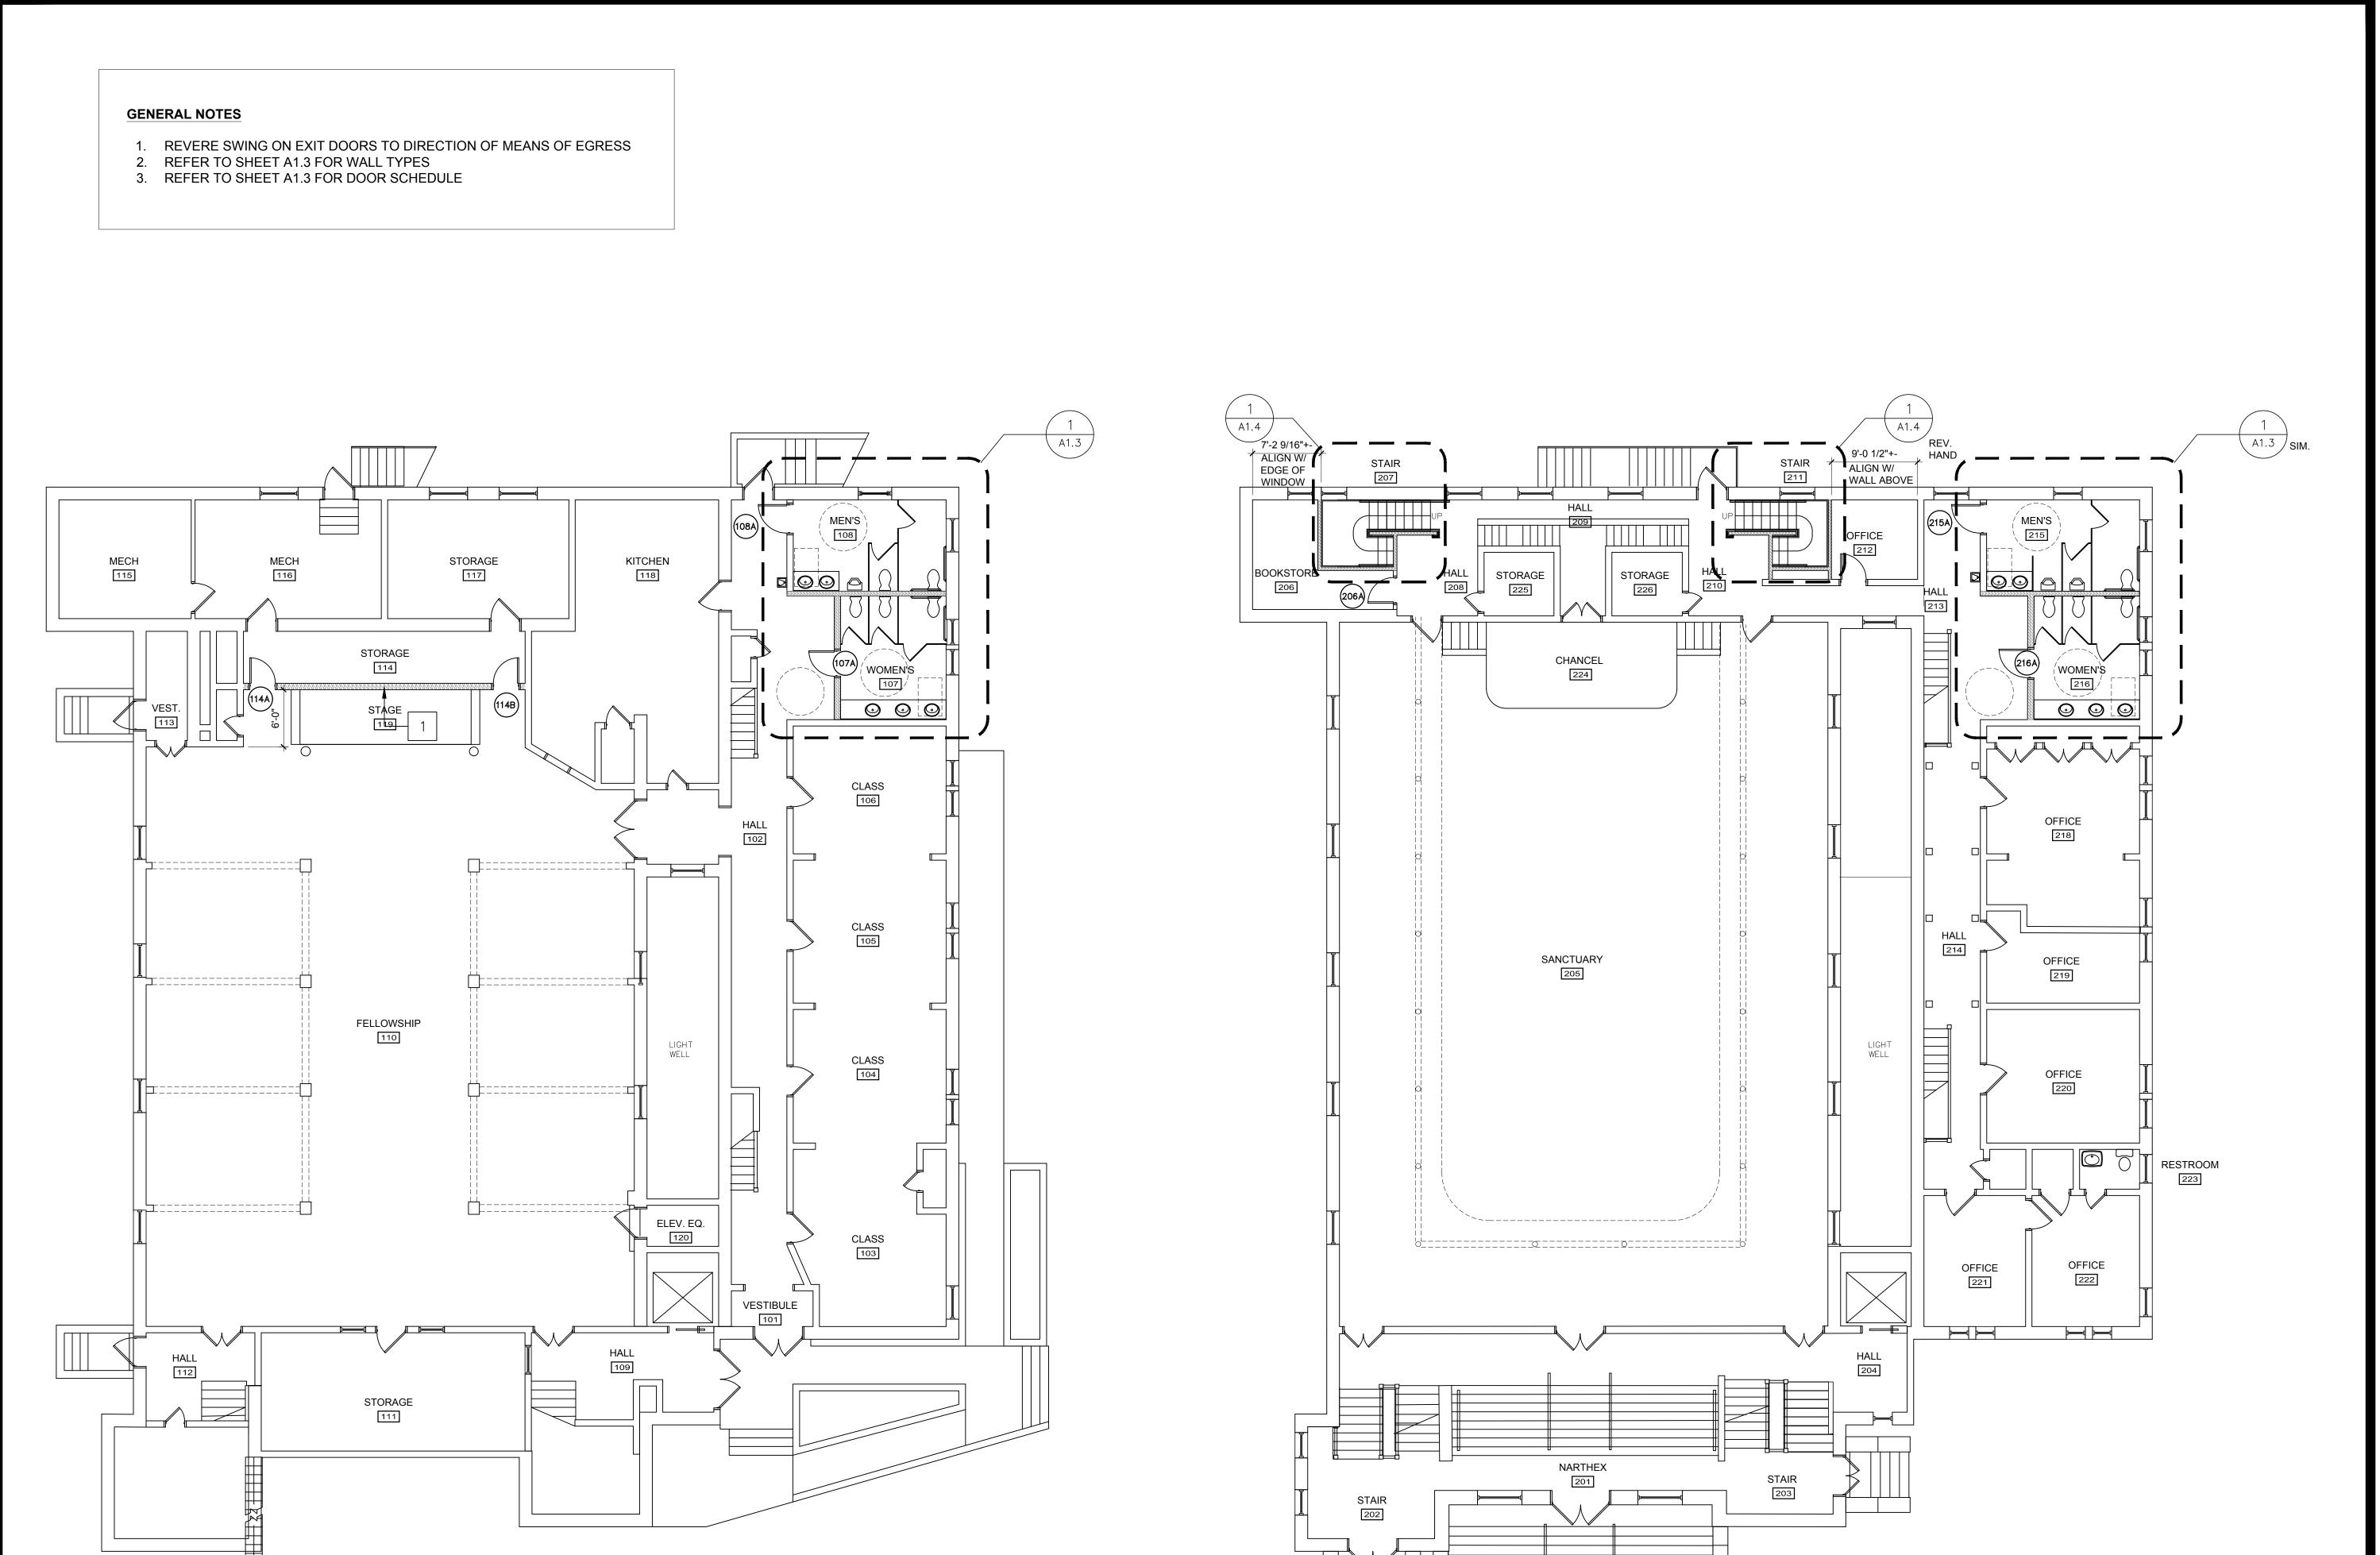
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BALCONY DEMOLITION PLAN









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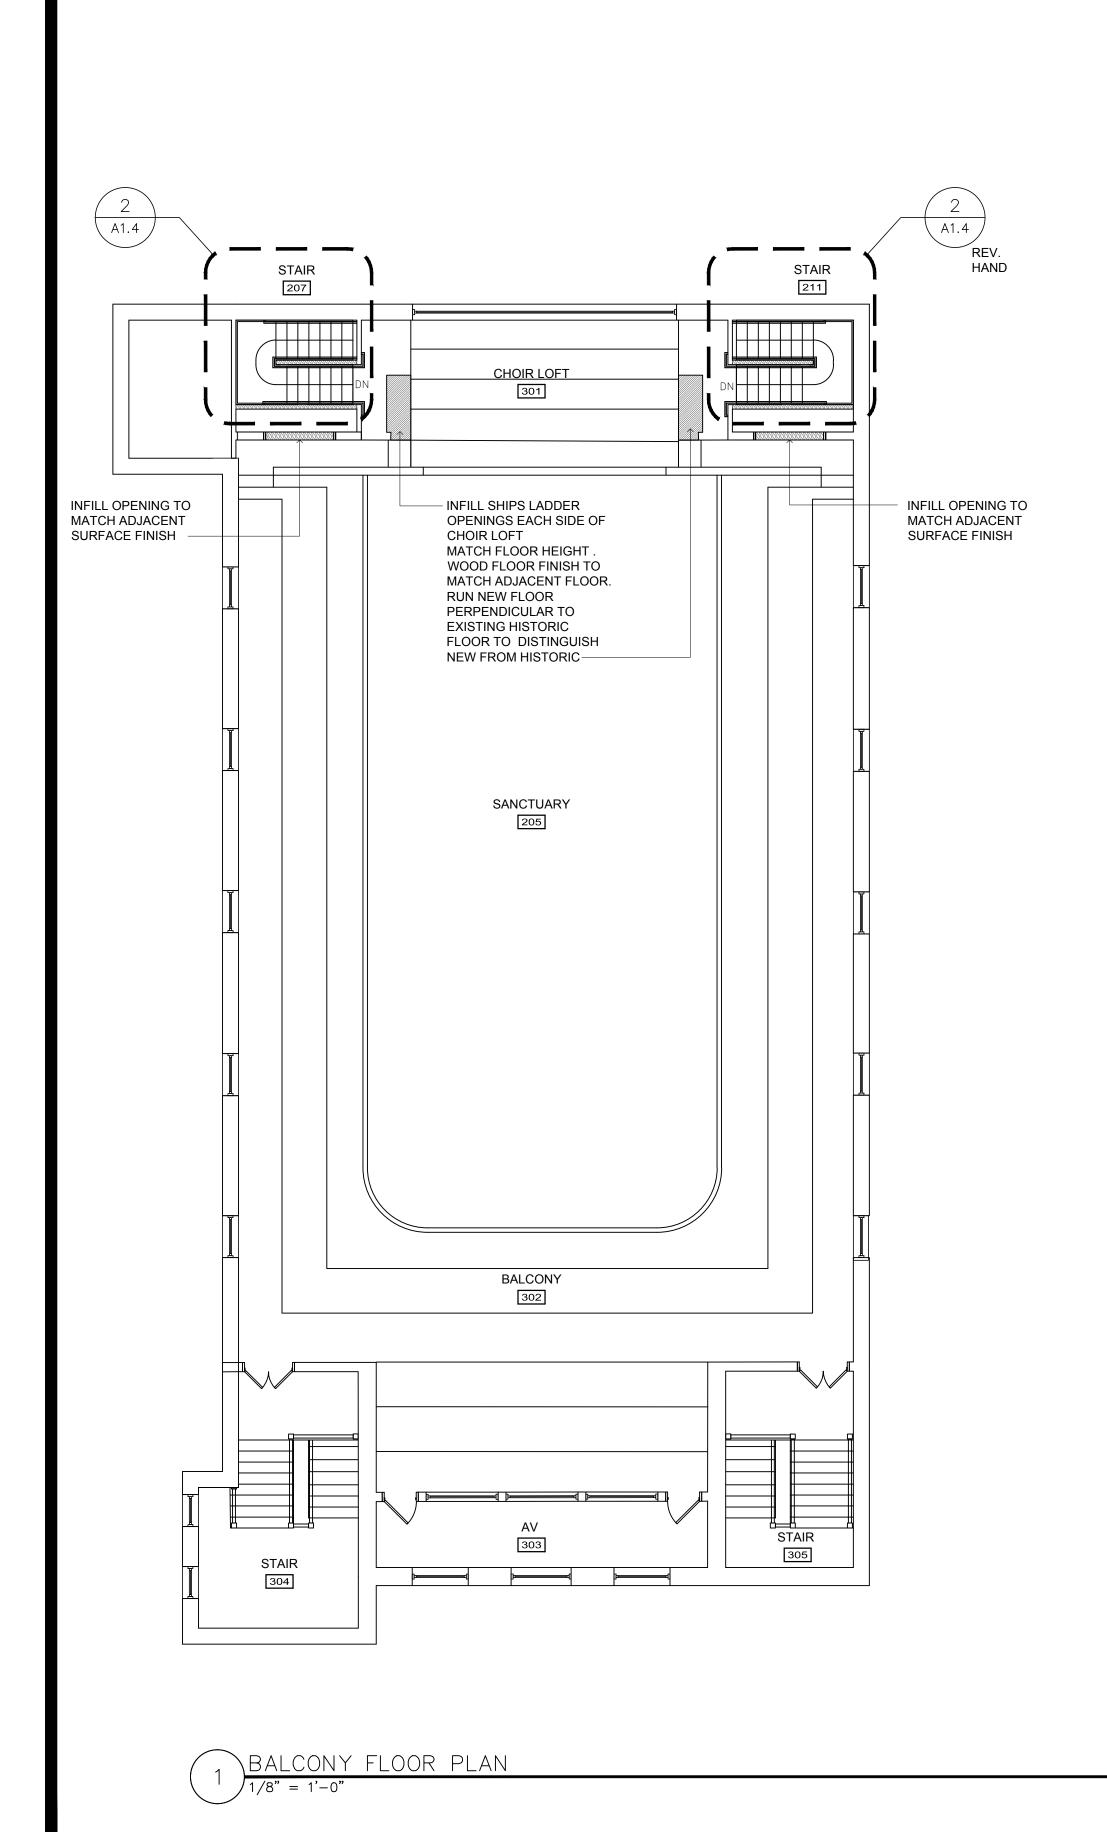
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FIRST FLOOR PLAN SECOND FLOOR PLAN

PROJ. NO.**1403** 

(A1.1)





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BALCONY FLOOR PLAN


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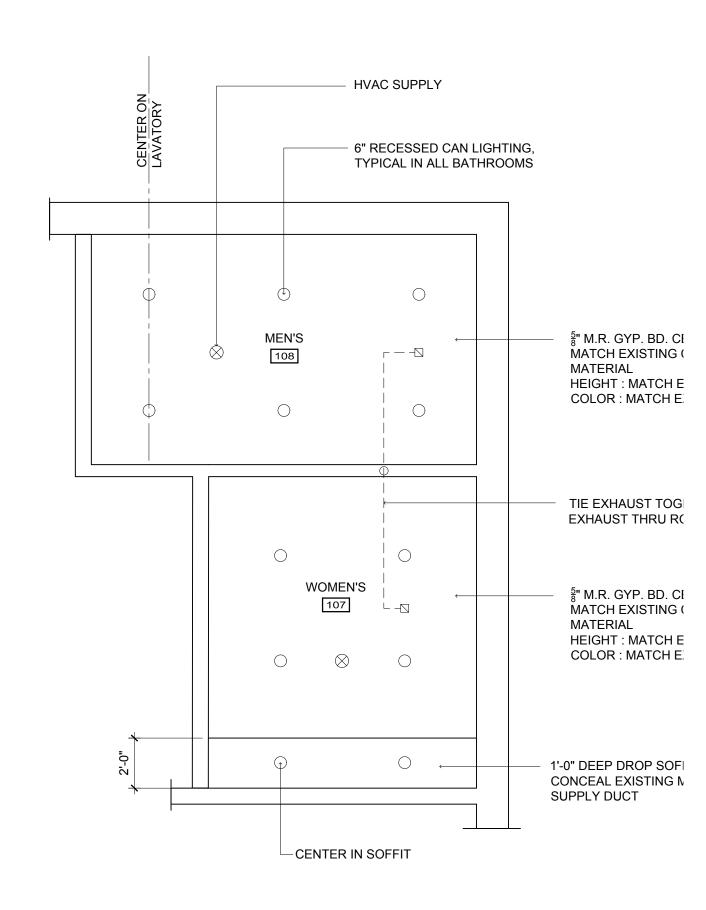
A1.2

	PLUMBING ACCESSORIES SCHEDULE									
ID	DESCRIPTION	MOUNTING HEIGHT	NOTES							
GB	GRAB BARS	39" TO 41" TO BOTTOM VERTICAL GRAB BAR 33" TO 36" CL FOR SIDE AND READ WALL	B-6806x18 VERTICAL SIDE WALL B-6806x42 SIDE WALL / x36 REAR WALL							
TD	DOUBLE ROLL TOILET TISSUE DISPENSER	27.5" TO TOP UNIT								
PT	PAPER TOWEL/ WASTER DISP.	61 <sup>1</sup> / <sub>4</sub> " TOP OF UNIT								
RH	ROBE HOOKS	38" TO 40" A.F.F.	B-7682 B (LOCATED ON ALL STALL DOORS)							
M	ADD MIRROR	40" MAX. BOTTOM MIRROR TO FLOOR	FULL WIDTH OF SINK x 3'-4" HIGH							
WC	ADA WALL MTD WATER CLOSET	RIM HEIGHT 17"	DESIGN BUILD							
L-1	ADA LAVATORY	2'-10" A.F.F. MAX.	DESIGN BUILD - COMPLY W/ ANSI A117.1 -BRADLEY MODEL LD3010-SL-TR1							
DF	ADA HI/LOW DRINKING FOUNTAIN	2'-10" A.F.F. MAX.	ELKAY VRCHD8S							
FD	FLOOR DRAIN									

#### NOTE:

- ALL FIXTURES AND ACCESSORIES SHALL COMPLY WITH ADA / ICC/ANSI A117.1
- TOILET ACCESSORIES SHALL BE CONTURA SERIES BY BOBRICK
- 3. ALL TOILET PARTITIONS SHALL BE SOLID PHENOLIC. COLOR TO BE SELECTED BY ARCHITECT FROM MANUFACTURERS STANDARD COLORS
- 4. G.C. TO PROVIDE LAVATORY DRAIN AND SUPPLY WHEELCHAIR PROTECTION JACKETS.



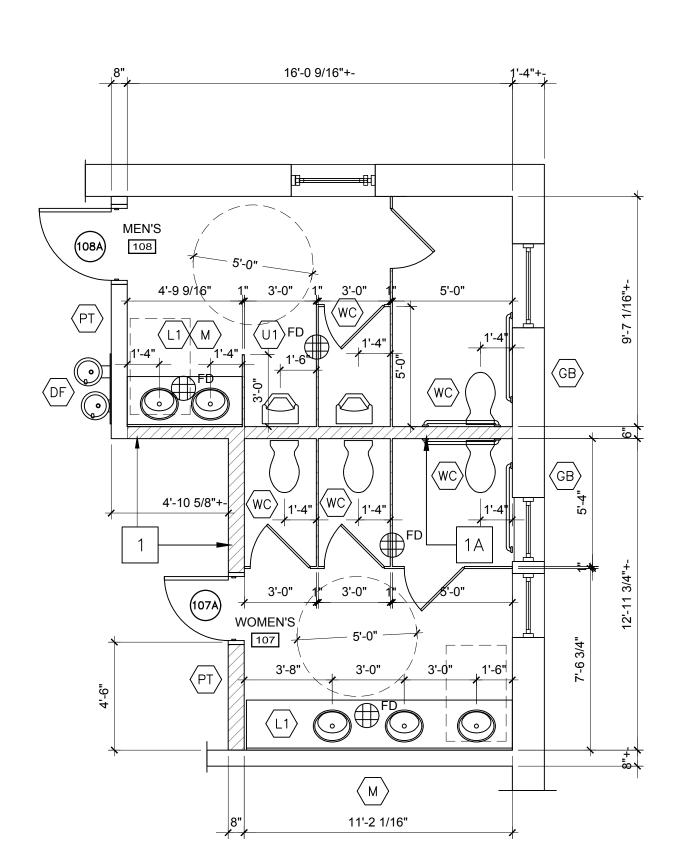



GENERAL NOTES:

1. RESTROOM 215 AND 216 ABOVE TO MATCH RESTROOM 107 AND 108



GENERAL NOTES:

1. RESTROOM 215 AND 216 ABOVE TO MATCH RESTROOM 107 AND 108

FINISH SCHEDULE									
		FLO	OR	WALLS		CEILING			
SPACE NUMBER	SPACE NAME	MAT'L.	BASE	MAT'L.	FINISH	MAT'L.	FINISH	*REMARKS	
	FIRST FLOOR								
107	MEN'S	C.T.	C.T.	GYP.BD.*	PAINT	GYP.BD.	PAINT	*4'-0" HIGH C.T. WAINSCOT.	
108	WOMEN'S	C.T.	C.T.	GYP.BD.*	PAINT	GYP.BD.	PAINT	*4'-0" HIGH C.T. WAINSCOT.	
	SECOND FLOOR								
215	MEN'S	C.T.	C.T.	GYP.BD.*	PAINT	GYP.BD.	PAINT	*4'-0" HIGH C.T. WAINSCOT.	
216	WOMEN'S	C.T.	C.T.	GYP.BD.*	PAINT	GYP.BD.	PAINT	*4'-0" HIGH C.T. WAINSCOT.	


#### **GENERAL NOTES:**

1. C.T. TO BE DALE TILE AMBASSADOR SERIES: 12x24 WANDERLUST WHT STD. AM36 - NON-POLISHED

	DOOR SCHEDULE										
ROOM NUMBER	DOOR NUMBER	SIZE (W X H)	DOOR  MATERIAL TYPE		FRAME	LABEL	ANSI # FUNCTION	ADA THRESHOLD	CLOSER	REMARKS	
107	107A	3'-0"x7'-0"	WD	1 PANEL	MTL	-	-	-	YES		
108	108A	3'-0"x7'-0"	WD	1 PANEL	MTL	-	-	-	YES		
114	114A	3'-0"x7'-0"	WD	1 PANEL	MTL	-	-	-	YES		
	114B	3'-0"x7'-0"	WD	1 PANEL	MTL	-	-	-	YES		
215	215A	3'-0"x7'-0"	WD	1 PANEL	MTL	-	-	-	YES		
216	216A	3'-0"x7'-0"	WD	1 PANEL	MTL	-	-	-	YES		

#### **GENERAL NOTES:**

- 1. ANSI LOCK SET # ARE BASED ON CORBIN RUSSWIN CL3400 SERIES HEAVY DUTY CYLINDRICAL LEVER LOCK SET OR EQUAL.
- 2. DOOR TRIM DESIGN SHALL BE ADA LEVER, FINISH TO MATCH EXISTING FACILITIES HARDWARE FINISH
- 3. ALL DOOR HARDWARE SHALL COMPLY WITH IBC SECTION 1008.1.9
- 4. NEW DOORS TO BE KEYED TO MATCH EXISTING FACILITY. G.C. TO SUBMIT KEYING SCHEDULE TO OWNER FOR REVIEW AND APPROVAL.
- 5. DOOR TO BE BY SIMPSON DOOR COMPANY OR EQUAL. ENGINEERED ALL WOOD STILES AND RAILS WITH DOWEL PINNED STILE/RAIL JOINERY. 3" VG FLAT PANEL, OVOLO STICKING. EASTERN WHITE PINE PAINT GRADE. FINISH TO MATCH EXISTING DOORS.

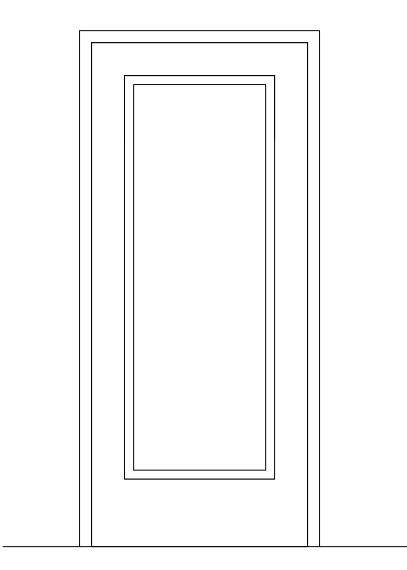

#### **GENERAL NOTES:**

 SINGLE RAISED PANEL : REFER TO DOOR GENERAL NOTE 5.



# WALL TYPE SCHEDULE

ID NUMBER	WALL TYPE
1	SONOBATT  6" METAL STUDS  @ 16" O.C. W/ 5/8" GWB  EACH SIDE - DEFLECTION  TRACK @ TOP - BRACES REQ.  BASE AS SCHEDULED  EACH SIDE  FINISH FLOOR  1 HR RATED PER IBC 2015 TABLE
	721.1(2) 13-1.1
1A	SAME AS TYPE 1 EXCEPT NOT RATED
2	SONOBATT  3-1/2" METAL STUDS @ 16" O.C. W/ 1/2" GWB EACH SIDE - DEFLECTION TRACK @ TOP - BRACES REQ.  BASE AS SCHEDULED EACH SIDE FINISH FLOOR  1 HR RATED PER IBC 2015 TABLE 721.1(2) 13-1.1



SIXTH MOUNT ZION
BAPTIST CHURCH
14 WEST DUVAL STREET
RICHMOND VA 23220

EPASQUALE
ELPH 

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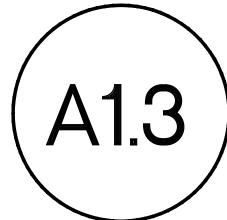
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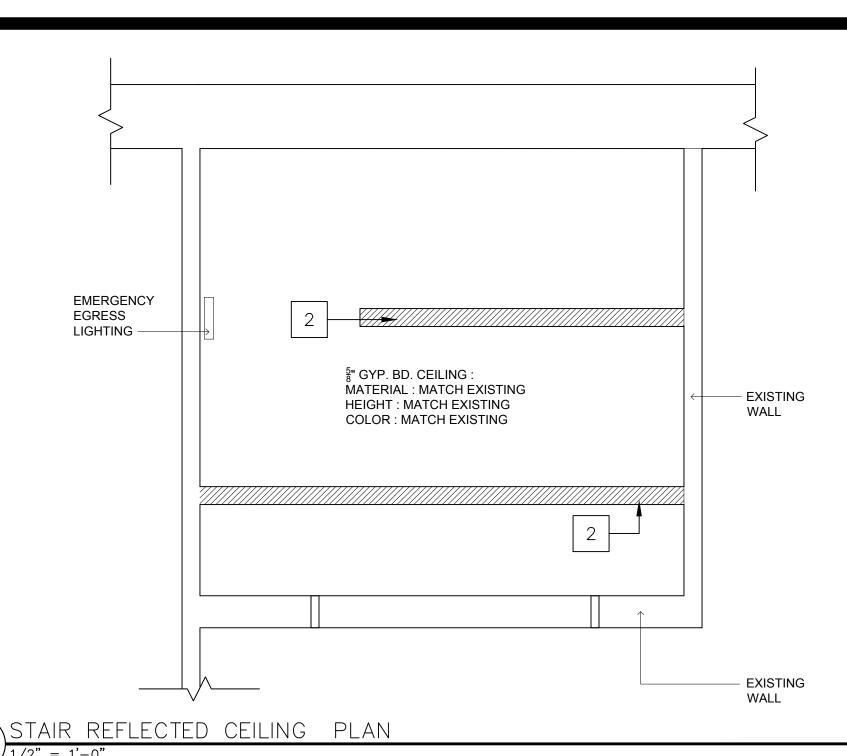
ENLARGED
RESTROOM
FLOOR PLAN


R/R REFLECTED
CEILING PLAN


FINISH SCHEDULE

DOOR SCHEDULE WALL TYPES





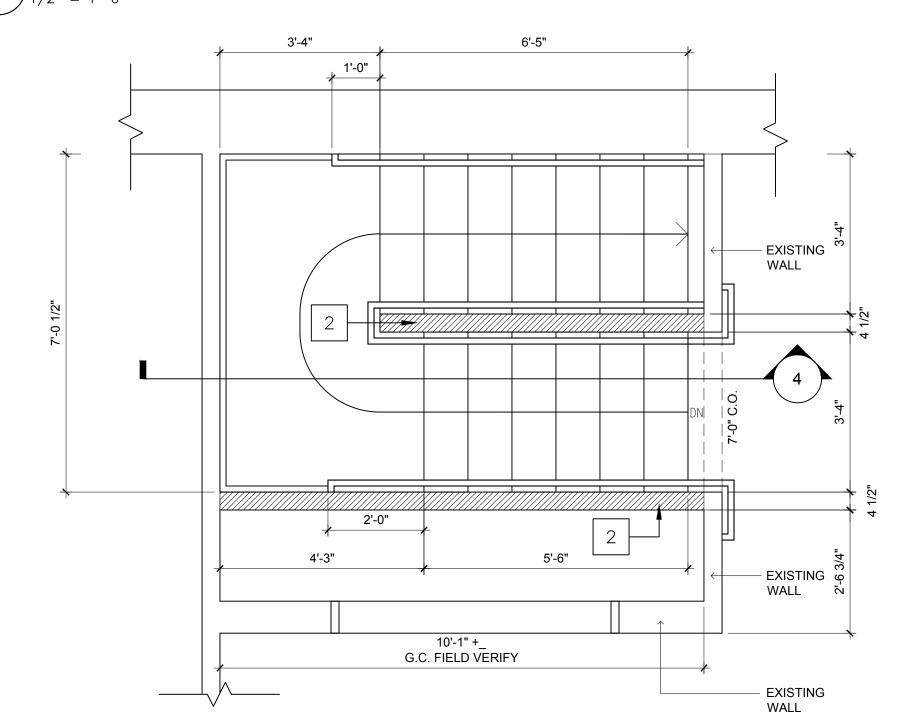

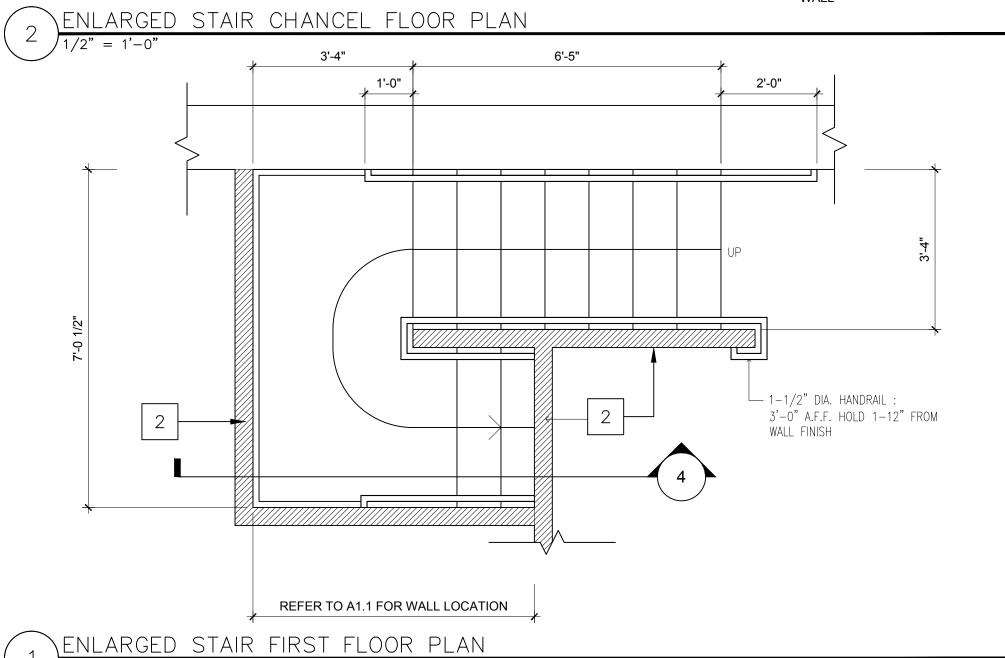

	FINISH SCHEDULE									
		FLO	OR	WALLS		CEILING				
SPACE NUMBER	SPACE NAME	MAT'L.	BASE	MAT'L.	FINISH	MAT'L.	FINISH	*REMARKS		
206	BOOKSTORE	CPT	WD	GYP.BD.	PAINT	GYP.BD.	PAINT			
207	STAIR	CPT	WD	GYP.BD.	PAINT	GYP.BD.	PAINT			
211	STAIR	CPT	WD	GYP.BD.	PAINT	GYP.BD.	PAINT			


#### **GENERAL NOTES:**

- 1. FINISHES TO MATCH EXISTING ADJACENT FINISHES
- 2. C.T. TO BE DALE TILE AMBASSADOR SERIES: 12x24 WANDERLUST WHT STD. AM36 NON-POLISHED

DOOR SCHEDULE										
ROOM NUMBER	DOOR NUMBER	SIZE (W X H)	DOOI MATERIAL	TYPE	FRAME	LABEL	ANSI # FUNCTION	ADA THRESHOLD	CLOSER	REMARKS
206	206A	3'-0"x7'-0"	WD	1 PANEL	MTL	1 HR	-	-	YES	
200	200A	3-0 X1 -0	VVD	TIANLL	IVIIL	1 1 111	-	-	160	

#### **GENERAL NOTES:**

- 1. ANSI LOCK SET # ARE BASED ON CORBIN RUSSWIN CL3400 SERIES HEAVY DUTY CYLINDRICAL LEVER LOCK SET OR EQUAL.
- 2. DOOR TRIM DESIGN SHALL BE ADA LEVER, FINISH TO MATCH EXISTING FACILITY HARDWARE
- 3. ALL DOOR HARDWARE SHALL COMPLY WITH IBC SECTION 1008.1.9
- 4. NEW DOOR TO BE KEYED TO MATCH FACILITY. G.C. TO SUBMIT KEYING SCHEDULE TO OWNER FOR REVIEW AND APPROVAL.
- 5. DOOR TO BE BY SIMPSON DOOR COMPANY OR EQUAL . ENGINEERED ALL WOOD STILES AND RAILS WITH DOWEL PINNED STILE/RAIL JOINERY.  $\frac{3}{8}$ " VG FLAT PANEL , OVOLO STICKING . EASTERN WHITE PINE PAINT GRADE . FINISH TO MATCH EXISTING DOORS.

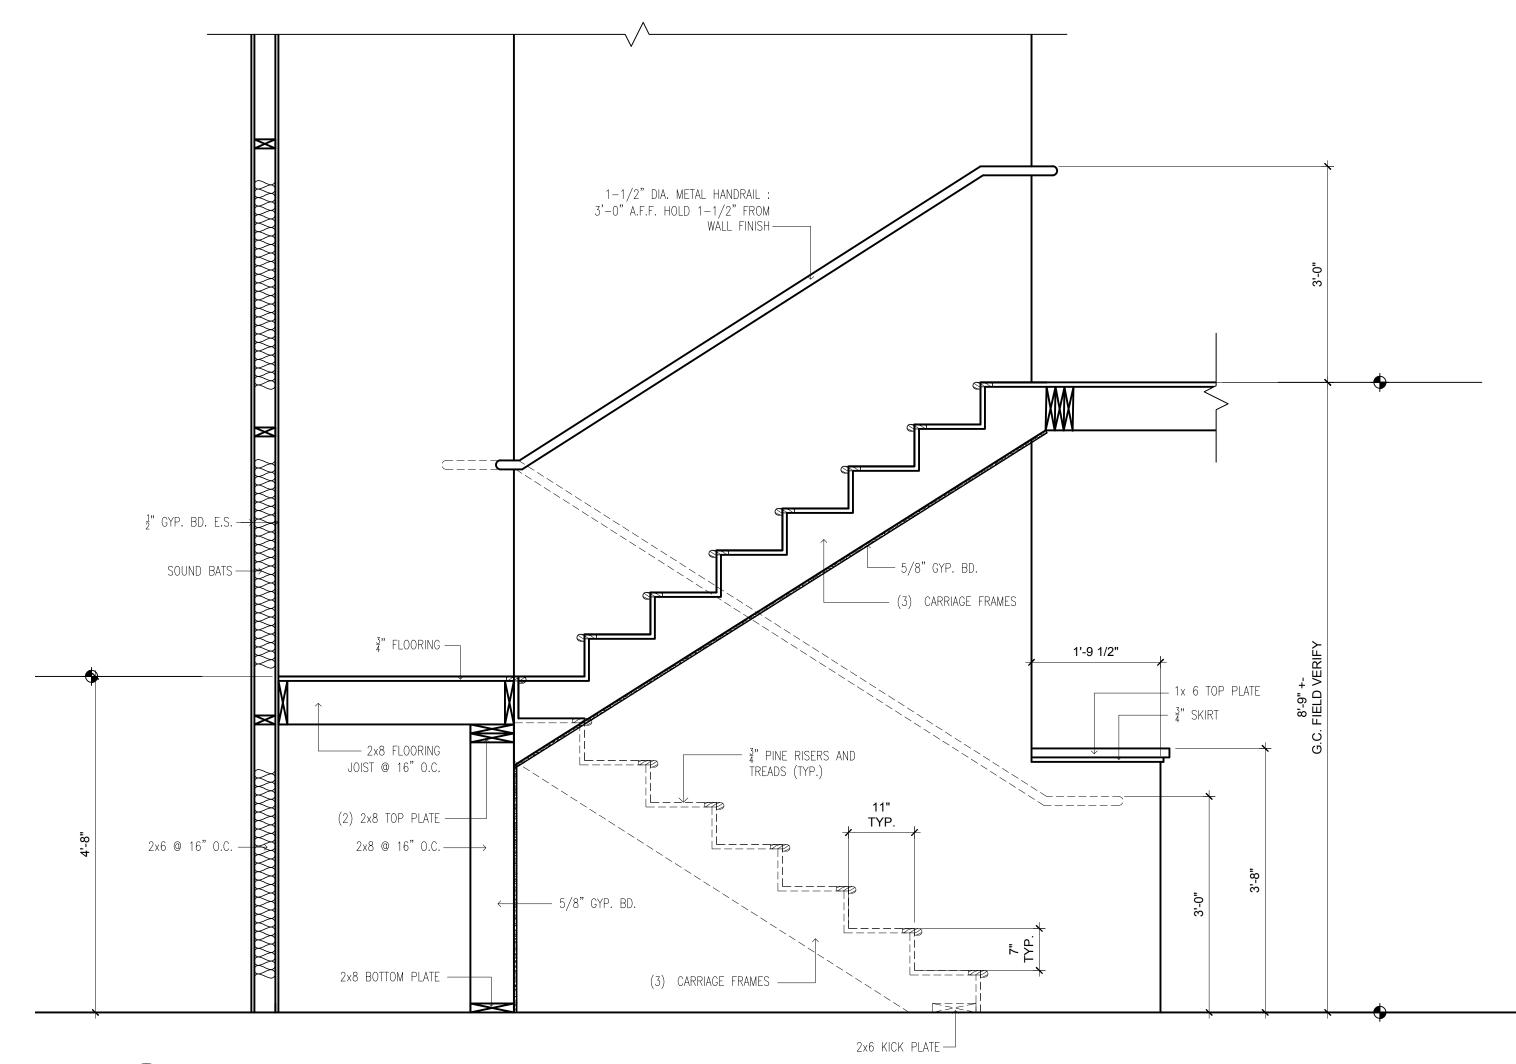


 $4 \frac{\text{STAIR SECTIO}}{3/4" = 1'-0"}$ 


#### **GENERAL NOTES:**

1. GENERAL CONTRACTOR TO FIELD VERIFY ALL EXISTING AND NEW DIMENSIONS PRIOR TO CONSTRUCTION




SIXTH MOUNT ZION BAPTIST CHURCH 14 WEST DUVAL STREET RICHMOND, VA 23220

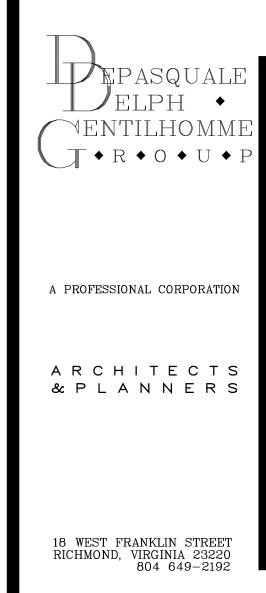

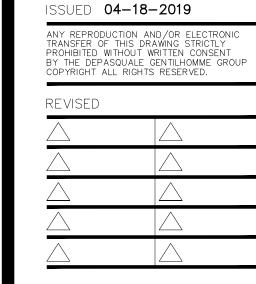


ENLARGED
STAIR FLOOR PLAN
AND DETAILS
REFLECTED CEILING
PLAN
STAIR SECTION
DOOR SCHEDULE
FINISH SCHEDULE



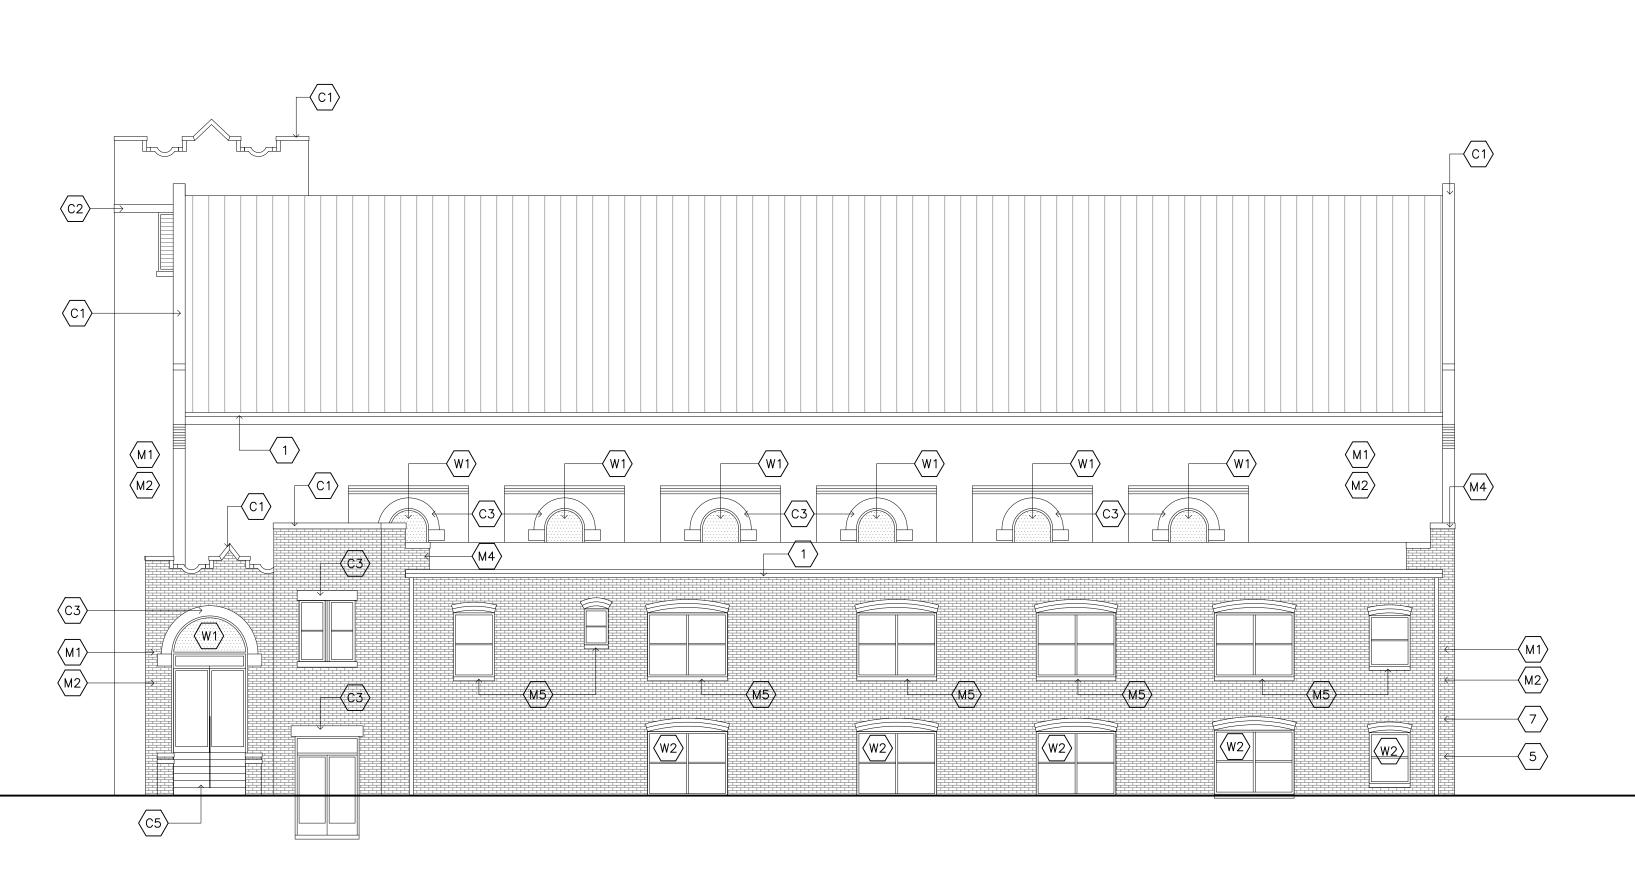

 $(2) \frac{\text{EXTERIOR EAST ELEVATION}}{1/8" = 1'-0"}$ 

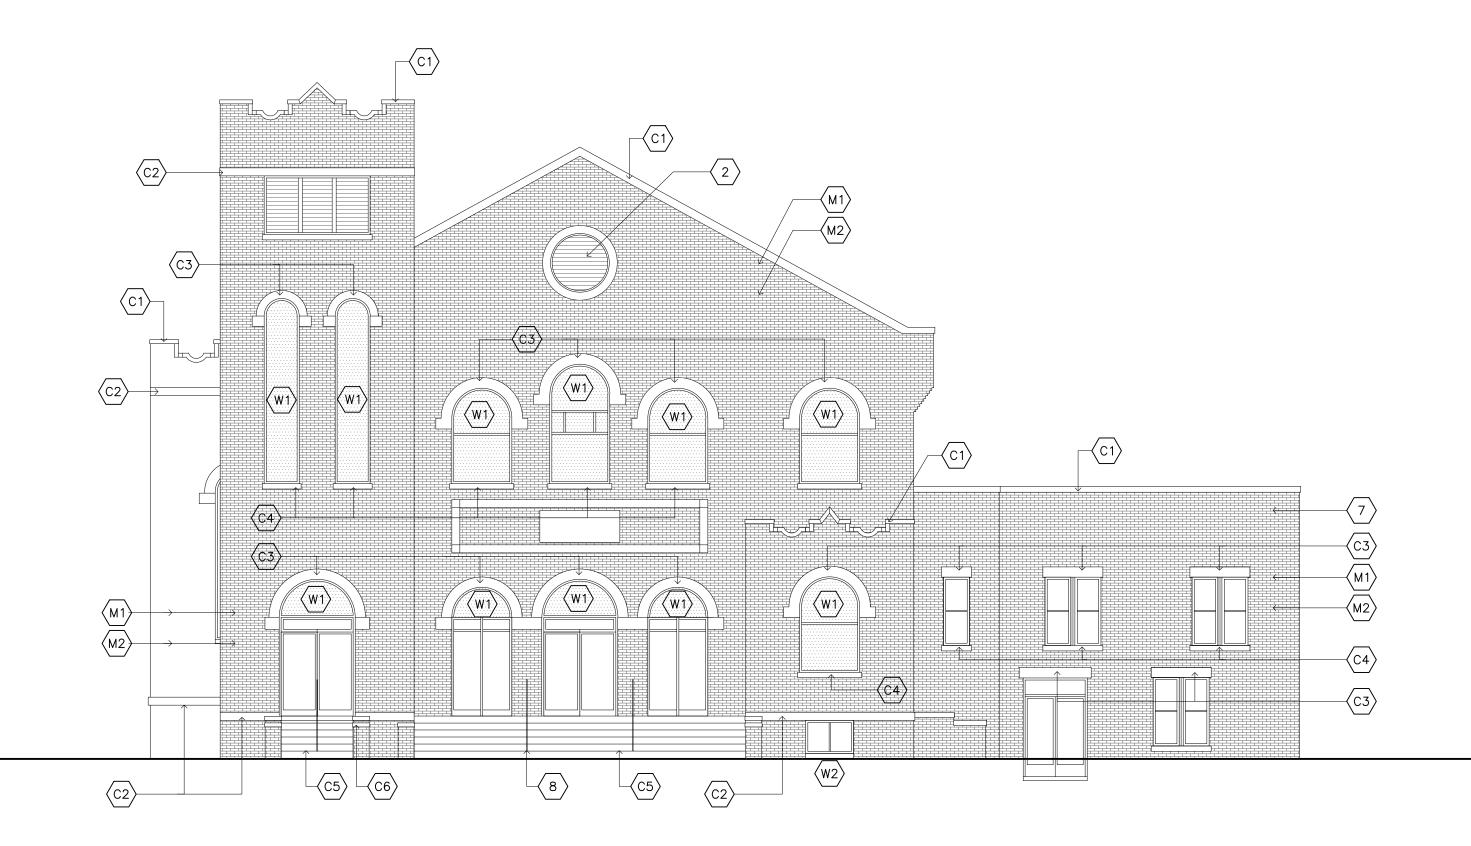

 $\underbrace{1}_{1/8"} = 1'-0"$ EXTERIOR SOUTH ELEVATION

SYMBOL	DESCRIPTION	PROJECT MANUA APPENDIX A PAGE #
	MASONRY	
$\langle M1 \rangle$	SELECTIVE TUCK POINT MORTAR JOINT	7
M2	INFILL BRICK VOIDS	43,25,39
(M3)	REMOVE AND REPLACE BRICK INFILL	29
M4	REPAIR BRICK PARAPET	37
(M5)	REPAIR BRICK SILL	38
⟨W1⟩	WINDOWS  RESTORE STAIN GLASS WINDOW: PROVIDE <sup>1</sup> / <sub>4</sub> " CLEAR TEMPERED GLASS STORM WINDOW PROTECTION,	9-15
	ALIGN STORM WINDOW PROTECTION, ALIGN STORM WINDOW HORIZ. JOINTS WITH WINDOW MULLIONS	
W2	RESTORE DOUBLE HUNG WINDOW	40-41
	CONCRETE / LIMESTONE	
(C1)	REPAIR CONCRETE COPING	8,22,26
C2	REPAIR CONCRETE BANDING	28
(C3)	REPAIR CONCRETE LINTEL /ARCH	23,24
C4	REPAIR CONCRETE SILL	27
(C5)	REPAIR CONCRETE STEP	17,20,21,31
(C6)	REPAIR LIMESTONE CAP	18
$\langle 1 \rangle$	GENERAL  CLEAN OUT GUTTERS, DOWNSPOUT AND REPAIR DRAINS	36
$\overline{\left\langle 2\right\rangle }$	RESTORE WOOD VENTS	16,19
$\overline{\left\langle 3\right\rangle }$	REPAIR METAL HANDRAIL	33
$\overline{\langle} 4\rangle$	REPAIR DOWNSPOUT	44
5	DEMO ABANDONED UTILITY LINES AND FILL BRICK VOIDS FROM SUPPORT	32,42
6	RESTORE DOOR WOOD JAMB SURROUND	30
7	NOT USED	
8	SAND AND REPAINT ALL EXTERIOR RAILINGS	
(10)	PROVIDE 300 PSI TEST PATCH WALL WASH FOR REVIEW WITH HISTORIC TAX CONSULTANT. IF htc APPROVES, PROCEED WITH SELECTIVE ELEVATION WAS PER THE HTC RECOMMENDED AREAS	

### GENERAL NOTE:

- 1. PRIOR TO EXECUTION OF CONTRACT, GENERAL CONTRACTOR SHALL QUANTIFY O THE WORK ASSOCIATED WITH OF EACH REPAIR, OR PROVIDE ALLOWANCES WHERE QUANTIFYING IS NOT APPLICABLE. UNIT COST SHALL BE INCLUDED IN OWNER / G.C. CONTRACT FOR NON QUANTIFIABLE AMOUNTS.
- 2. SIXTH MOUNT ZION BAPTIST CHURCH REHAB IS A HISTORIC TAX CREDIT PROJECT. THE INTENT IS NOT TO REMOVE AND PLACE ELEMENTS OF THE BUILDING, BUT TO RESTORE AND RENOVATE USING THE EXISTING ELEMENTS OF THE FACILITY. RENOVATION SHALL BE IN ACCORDANCE WITHE APPLICABLE SECTION OF "STANDARDS FOR REHABILITATION AND GUIDELINES FOR REHABILITATING HISTORIC BUILDINGS", PROVIDED BY THE U.S. DEPARTMENT OF INTERIOR AND INCLUDED IN THE APPENDIX OF THE SPECIFICATION MANUAL. IN ADDITION, MEANS AND METHODS, FOR REHABILITATION, SHALL BE APPROVED BY THE HISTORIC TAX CREDIT CONSULTANT. NO HISTORIC REHABILITATION SHALL BE DONE WITHOUT PRIOR APPROVAL OF MEANS AND METHODS FROM THE TAX CREDIT CONSULTANT.
- 3. FOR ADDITIONAL DETAILS ON SCOPE OF WORK, REFER TO PROJECT MANUAL APPENDIX A, FACILITY SCOPE OF WORK.



SIXTH MOUNT ZION BAPTIST CHURCH 14 WEST DUVAL STREET RICHMOND, VA 23220

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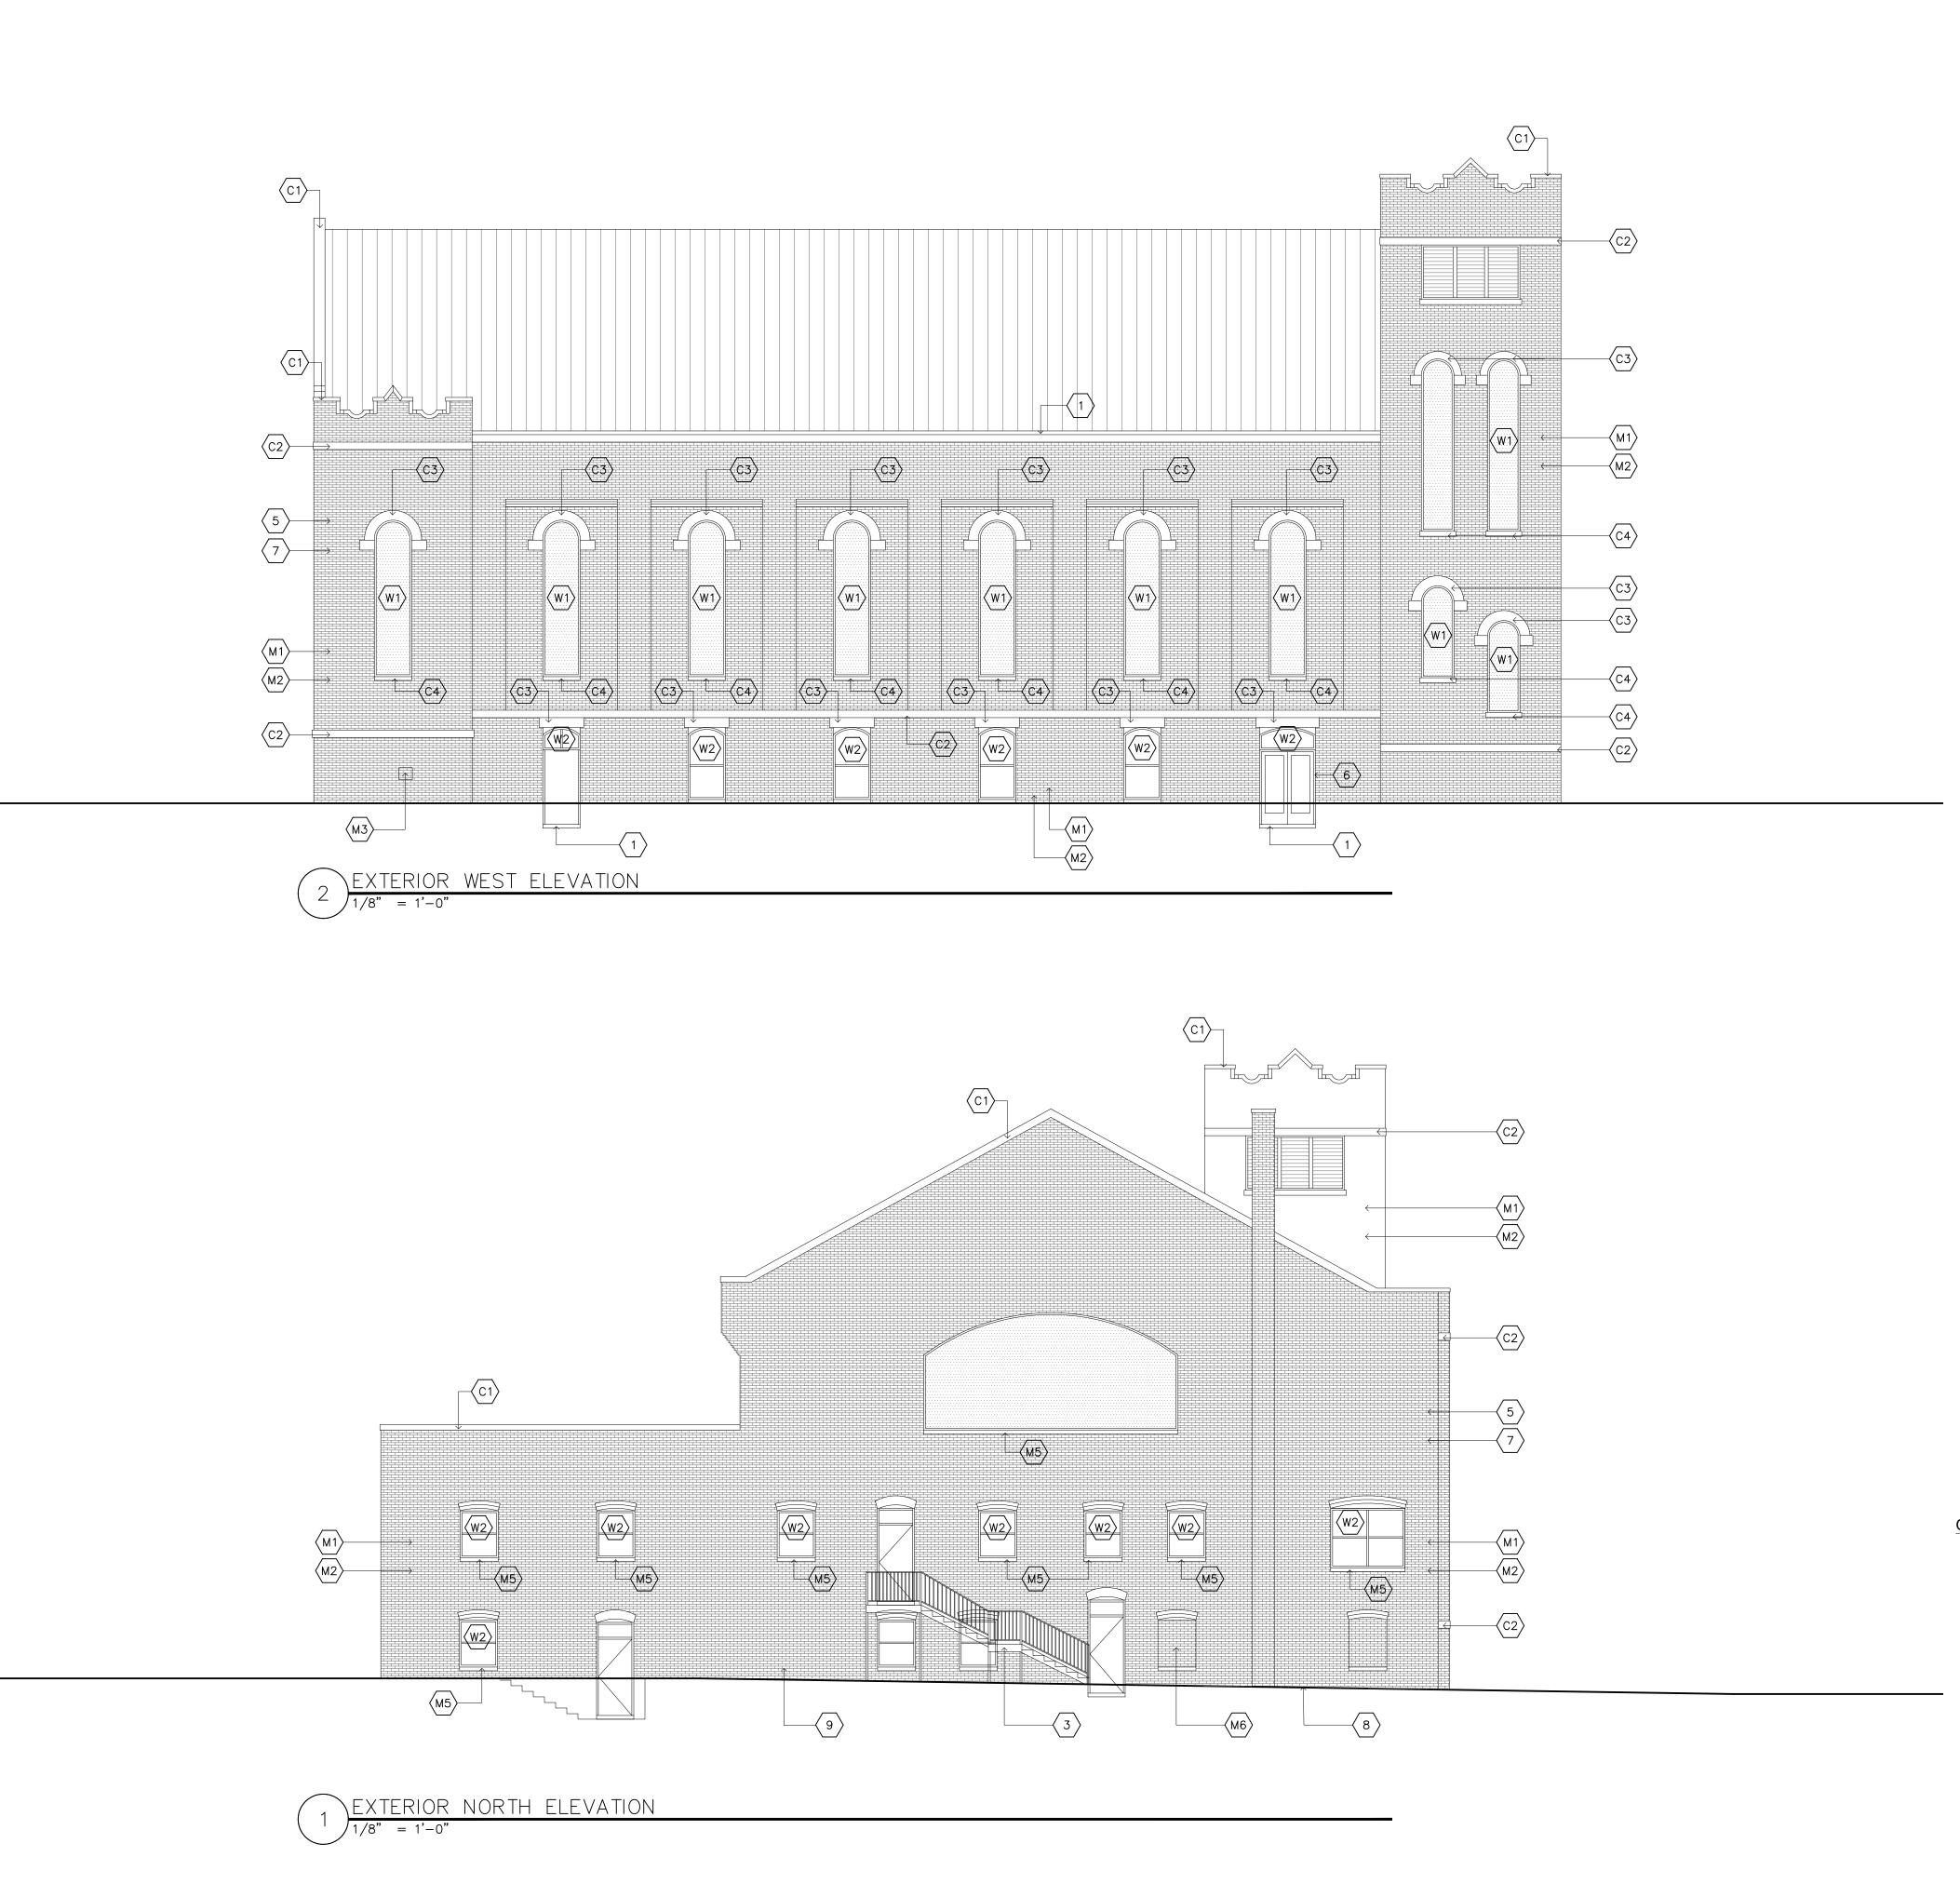
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REVISED

SOUTH ELEVATION EAST ELEVATION





SYMBOL	DESCRIPTION	PROJECT MAN APPENDIX A PAGE #
	MASONRY	
$\langle M1 \rangle$	TUCK POINT MORTAR JOINT	7
$\langle M2 \rangle$	INFILL BRICK VOIDS	43,25,39
$\langle M3 \rangle$	REMOVE AND REPLACE BRICK INFILL	29
$\overline{\langle M4 \rangle}$	REPAIR BRICK PARAPET	37
$\langle M5 \rangle$	REPAIR BRICK SILL	38
(M6)	INFILL ABANDONED OPENING	34,35
	WINDOWS	
⟨W1⟩	RESTORE STAIN GLASS WINDOW : PROVIDE $\frac{1}{4}$ " CLEAR TEMPERED GLASS STORM WINDOW PROTECTION, ALIGN STORM WINDOW HORIZ. JOINTS WITH WINDOW MULLIONS	9-15
W2	RESTORE DOUBLE HUNG WINDOW	40-41
	CONCRETE / LIMESTONE	
(C1)	REPAIR CONCRETE COPING	8,22,26
C2	REPAIR CONCRETE BANDING	28
(C3)	REPAIR CONCRETE LINTEL /ARCH	23,24
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(C5)	REPAIR CONCRETE STEP	17,20,21,31
(C6)	REPAIR LIMESTONE CAP	18
	GENERAL	
	CLEAN OUT GUTTERS, DOWNSPOUT AND REPAIR DRAINS	36
2	RESTORE WOOD VENTS	16,19
3	REPAIR METAL HANDRAIL	33
4	REPAIR DOWNSPOUT	44
5	DEMO ABANDONED UTILITY LINES AND INFILL BRICK VOID FROM SUPPORT	32,42
6	RESTORE DOOR WOOD JAMB SURROUND	30
$\langle 7 \rangle$	NOT USED	
8	DEMO EXISTING SIDEWALK & INSTALL NEW 5'-0" WIDE ADA CONCRETE SIDEWALK	33
9	REMOVE VEGETATION FROM FACE OF BUILDING	
(10)	PROVIDE 300 PSI TEST PATCH WALL WASH FOR REVIEW WITH HISTORIC TAX CONSULTANT. IF htc APPROVES, PROCEED WITH SELECTIVE ELEVATION	

# GENERAL NOTE :

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- 3. FOR ADDITIONAL DETAILS ON SCOPE OF WORK, REFER TO PROJECT MANUAL APPENDIX A, FACILITY SCOPE OF WORK.



SIXTH MOUNT ZION BAPTIST CHURCH 14 WEST DUVAL STREET RICHMOND, VA 23220

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NORTH ELEVATION WEST ELEVATION



## COMMONWEALTH OF VIRGINIA DEPARTMENT OF HISTORIC RESOURCES

#### PART 2 - DESCRIPTION OF REHABILITATION

# STATE HISTORIC REHABILITATION TAX CREDIT PROGRAM HISTORIC PRESERVATION CERTIFICATION APPLICATION

DHR Project No.:	
------------------	--

Instructions: Read the instructions carefully before completing application. No certification will be made unless a completed application form has been received. Type or print clearly in black ink. If additional space is needed, use the Continuation/Amendment Form found at the back of this application. A copy of this form may be provided to the Virginia Department of Taxation. The decision by the Virginia Department of Historic Resources with respect to certification is made on the basis of the descriptions in this application form. In the event of any discrepancy between the application form and other, supplementary material submitted with it (such as architectural plans, drawings and specifications), the application form shall take precedence.

•	Name of property: Si	xth Mount Zion Baptist	Church	(DHR ID# 127-04	72; 127-0237-0482)
	Address of property:	Street 14 West Duval S			
		City Richmond	County N/A	StateVA	Zip 23220
	■ Listed individually in	the Virginia Landmarks R	egister: date of listing: 6/19	0/1996	
			: Jackson Ward Historic		
			ance) been submitted for the Listed on Registers Da		
	NPS Project Number	(if application for federal	tax credits submitted): N/A		
•	Data on building and	l rehabilitation project:			
	Date building construc	cted: <u>c1887</u>	Total number of	housing units before rehabi	litation: 0
		Masonry		r that are low-moderate inco	
		tation: Church		housing units after rehabilit	
		rehabilitation: <u>Church</u>		er that are low-moderate inc	
	Estimated cost of reha	bilitation: \$3,570,000		rehabilitation: 9,024 squar	
				ehabilitation: <u>8,904 square</u>	
	Is this a phased projec			es (include a phasing plan):	
		e (est.): <u>February 2007</u>		(est.): <u>January 2020</u>	
	Is the building protect	ed by an easement?   ye	es <b>no</b> If yes, list the eas	ement holder? N/A	
•	Project contact:				
	Name Paige Pollard		Signature	D	Date
	Street PO Box 11083		City Norfolk		
	State VA	Zip_23517	Daytime Te	elephone Number <u>(757)923</u>	3-1900
	Email Address <u>admir</u>	1@commonwealthpreserv	ationgroup.com		
•	Owner:	61 4 4 5 6			1 . 7
			n provided is, to the best of n		
			n of false records or falsifi		
	department is grounds	for denial of the certificat	tion of completed work and	is punishable under Virgini	a and federal law.
	Name <u>Trustee Rober</u>	t Brown	Signature	D	Date
	Organization Sixth Mo	ount Zion Baptist Church			
	Social Security or Tax	payer Identification Number	ber <u>54-0612200</u>		
	Street 14 West Duval	Street	City Richmond		
	State VA	Zip <u>23220</u>	<u>)                                    </u>	time Telephone Number (8	304) 648-7511
	Email Address advis	orroh@comeast not	•	•	

#### HISTORIC PRESERVATION CERTIFICATION APPLICATION PART 2

Property Name Sixth Mount Zion Baptist Church

Property Address 14 West Duval Street, Richmond

DHR Project Number:	
DOK Project Number:	

# 5. DETAILED DESCRIPTION OF REHABILITATION/PRESERVATION WORK – Fully describe all work at the property, including site work, new construction, alterations, etc. Complete below.

#### Number 1.

Architectural feature <u>Sixth Mount Zion Baptist Church</u> Approximate date of feature <u>c1887</u>, 1925

Describe existing feature and its condition:

Sixth Mount Zion Baptist Church is a c1887 brick masonry Romanesque Revival church located in the Jackson Ward neighborhood of Richmond, Virginia. The original church construction was overseen by the founding pastor, Reverend John Jasper, and builder George Boyd.

The exterior of the church was altered significantly during a 1925 renovation, which resulted in the modification of the façade and west elevation, as well as the construction of the adjacent education annex; the interior of the sanctuary largely retains its original c1887 configuration. This renovation was designed by prominent African American architect, Charles T. Russell, and builder I. Lincoln Bailey.

Few modifications have been made to the church and annex since 1925; upgrades have been limited to finishes and systems. The building is in good condition, with some areas of deferred maintenance visible, particularly on the interior where there are large areas of deteriorated plaster within the sanctuary.

Photo no. All Drawing no. All

Describe work and impact on existing feature:

The applicant proposes to rehabilitate the historic church building for continued use. This application includes the ongoing maintenance and repairs undertaken in recent years, as well as more significant upcoming repairs. Remaining historic features and finishes will be retained, and proposed alterations will be contemporary yet compatible in order to differentiate them as modern insertions. Modifications are required at the choir loft ship ladders, as they are currently undersized and very steep, posing a significant hazard for the choir. Existing bathrooms will also be updated to better serve the congregation.

Impact will be to rehabilitate the historic church building and education annex to support its continued use.

#### Number 2.

Architectural feature Roof, Gutters, and Downspouts
Approximate date of feature modern – 2012, unknown
Describe existing feature and its condition:

The existing modern roof on the church was replaced in 1999 with a new standing seam metal roof with a baked enamel finish. Upon inspection in the 2010s, the church found that the baked enamel finish was failing, and that the recently replaced modern roof required replacement a second time.

The education annex had a modern membrane roof which was in deteriorated condition.

Photo no. <u>1-2</u>, <u>8-10</u>, <u>14</u>, <u>22</u> Drawing no. <u>A3.1-3.2</u>, <u>S1.2</u>; Roofing Cut Sheet

Describe work and impact on existing feature:

The applicant replaced the modern (1999) standing seam metal roof on the church in 2012 due to the failure of the baked enamel finish on the 1999 replacement roof; this modern roof was replaced with a new standing seam metal roof with a Kynar finish (cut sheet enclosed). This previously completed work is included in this application in order to capture credits on the expenses incurred during the 2012 replacement. The applicant also replaced the roof over the education annex in 2011 with a modern TPO roof.

The northernmost truss is damaged at the bearing point on the west wall; details of the proposed truss end repairs have been provided on S1.2. A thorough inspection of remaining trusses will be conducted, any required repairs will be in keeping with the approach outlined on S1.2.

Gutters were repaired in 2016. Gutters and downspouts will be inspected and repaired as needed to ensure that water is being adequately shed from the roofs and away from the building. Gutters will be cleaned out in conjunction with this work.

Impact will be to retain the existing modern roofs and to inspect and repair gutters and downspouts as needed.

DHR Form TC-2; Revised 10/15

Page 2 of 7

Owner Initials\_\_\_\_\_

# HISTORIC PRESERVATION CERTIFICATION APPLICATION PART 2

Property Name Sixth Mount Zion Baptist Church

Property Address 14 West Duval Street, Richmond

#### Number 3.

Architectural feature Exterior Walls

Approximate date of feature <u>c1887, 1925, modern-unknow</u>n Describe existing feature and its condition:

The exterior walls of the building are brick masonry; primary elevations (south and west) are laid in a stretcher bond, while secondary (north and east) elevations feature a five-course common bond. A portion of the original east elevation remains visible above and behind the annex; the color of the brick and detailing on the pilasters differ from those seen on the west elevation, which were refaced during the 1925 renovation. Masonry and mortar joints are generally in good condition, although there are areas with severe mortar loss (primarily around downspouts) and voids in brick and mortar where systems are/were attached.

In addition to the brick masonry, details appear in the form of bands, coping, steps, and window lintels, arches and sills; these are a combination of limestone and concrete. In many locations, concrete coping pieces have separated.

A modern elevator tower was constructed at the connection between the historic church and school annex. The brick color and pattern match the adjacent historic walls.

Two modern CMU sheds have been appended to the northeast elevation of the education annex.

Photo no. <u>1-4, 7-27, 33-39, 78; Historic photo</u> Drawing no. <u>A3.1-3.2</u>

Describe work and impact on existing feature:

As a result of this project, the applicant will inspect all exterior masonry walls. Mortar will be inspected and repointed using guidance provided in Preservation Brief No. 2, *Repointing Mortar Joints in Historic Masonry Buildings*; new mortar will match the historic in color, strength, composition, tooling pattern, and joint profile. Abandoned utility lines will be removed and any voids in the brick or mortar will be repaired using materials that match the adjacent historic materials.

Concrete details will be inspected and repaired as necessary using guidance provided in Preservation Brief No. 15, *The Preservation of Historic Concrete*. Separated concrete coping will be reset. Portions of window arches that have been sealed with caulk rather than mortar will be repaired. Caulk will be removed from joints; mortar which matches the historic in color, strength, and composition, will be inserted, matching the joint profile and tooling pattern of historic joints.

Concrete coping that has shifted and separated over time will be removed and reset.

The modern CMU sheds will be removed.

Impact will be to repair the exterior masonry, concrete, and stone, and to remove the modern CMU sheds.

#### Number 4.

Architectural feature Exterior Doors

Approximate date of feature modern - unknown

Describe existing feature and its condition:

Exterior doors in the building are all modern. Primary entry door openings along the facade are modern aluminum storefront doors or fixed storefront. Secondary entry doors are modern hollow metal doors. All existing exterior doors are in good to fair condition.

At the north elevation (rear), a single basement door has been infilled with plywood.

Photo no. <u>1-4, 7-12, 14, 19, 21-22, 25, 27, 41, 71, 100, 124,</u> 128, 130, 133, 136

Drawing no. <u>D1.1</u>, <u>A1.1</u>, <u>A3.1-3.2</u>

Describe work and impact on existing feature:

All existing doors will be retained and repaired as needed to ensure they operate properly and are secure.

The plywood infill at the north elevation will be replaced as needed to secure this opening.

Impact will be to retain and repair existing modern doors.

#### Number 5.

Architectural feature Windows and Louvered Openings
Approximate date of feature 1925, modern - unknown
Describe existing feature and its condition:

The historic stained glass remains in the church building, which was installed in conjunction with the 1925 renovation. The bell tower and front-facing gable of the church also contain wooden louvers, which are in fair condition.

Other windows include historic six-over-six double hung wood

Describe work and impact on existing feature:

Owner Initials

As a result of this project, the applicant will restore the historic stained-glass windows located within the church building. Some of this work has already been completed; the large stained-glass window over the choir loft was restored by Jennings Stained Glass and two other windows were repaired by the contractor (see enclosed elevation drawings indicating which windows have already been repaired). The applicant has hired Sanctuary Glass

DHR Form TC-2; Revised 10/15 Page 3 of 7

#### HISTORIC PRESERVATION CERTIFICATION APPLICATION PART 2

Property Name Sixth Mount Zion Baptist Church

Property Address 14 West Duval Street, Richmond

DHR	Project Number:	
$\nu$	I TOTCCL I TUITIOCI.	

windows, as well as modern six-over-six and one-over-one vinyl replacement windows, which appear primarily at the second floor of the education annex and within the modern elevator tower. The first-floor windows in the annex are wood and feature wood screens and metal security bars.

At the north elevation (rear), a single basement window opening has been infilled with plywood.

Photo no. 1-2, 4, 7-10, 12-18, 21-23, 26, 42, 46, 49-51, 68, 72-

73, 92, 111, 116-118, 124-125, 130, 133, 135-136, 139-141, 146-147, 152-153, 155-156, 165, 169, 173-174, 176, 179, 184, 186, 189-191, 193, 195-196, 198, 200-203, 205-209, 211-212, 216, 219-221, 227, 229-230

Drawing no. <u>D1.1-1.2</u>, <u>A1.1-1.2</u>, <u>A3.1-3.2</u>; <u>Stained glass</u>

restoration proposal

and Furniture Company of Burlington, North Carolina for the restoration of the remaining stained-glass windows; their proposal is enclosed for review. Once the stained glass is repaired and reinstalled, storm windows will be installed to protect them. The storm windows will have ½" tempered glass and the storm frames will be narrower than the window frames and will be aligned with the window mullions to reduce visual impact.

Wooden louvers will be removed for repairs and reinstalled; rotten pieces will be replaced in kind and once repaired, the louvers will be scraped, primed, and repainted. The openings will be secured to prevent water infiltration while the louvers are being repaired.

Double hung windows, both historic wood and modern vinyl, will be retained and repaired as needed. Wood screens and security bars will be repaired as needed and retained.

The plywood infill at the north elevation will be replaced as needed to secure this opening.

Impact will be to retain and repair all existing windows and louvers in the building.

#### Number 6.

Architectural feature Site

Approximate date of feature <u>c1887, 1925, 1957, modern</u>
Describe existing feature and its condition:

The building sits on its original site, facing West Duval Street, which runs along the south elevation of the church. The church purchased the two adjacent parcels to the east and west, which now contain parking.

Concrete sidewalks are in place at all elevations around the building. Along the façade, adjacent to the street, is a brick sidewalk. Stairs up to the entry doors of the church are concrete with metal railings. The limestone cap at the southwest entry steps is damaged. At the southeast corner of the church site, concrete steps and a ramp with metal handrails provide access to the entry level of the annex building; modern brick planters and metal fencing also appear in this area.

A historic iron fence rail (salvaged from a different location at an unknown date) is installed in the modern concrete sidewalk at the west elevation. Mechanical units at this elevation are enclosed within a chain link fence.

At the north elevation (rear), the sidewalk is pitched towards the building. A chain link fence separates the rear of the parcel from Interstate 95, which was constructed just north of the church, severing the Jackson Ward neighborhood. Overgrown vegetation is growing against the building at this elevation. A modern metal stair provides egress from the first floor to grade at the north elevation; the stair is rusting.

Photo no. <u>1-14</u>, <u>16-17</u>, <u>19-32</u> Drawing no. ASP; Sealant spec Describe work and impact on existing feature:

As a result of this project, the applicant proposes to make limited site improvements:

At the façade, the concrete steps and limestone cap will be repaired as necessary. Cracks in the concrete will be sealed and damaged areas will be replaced with concrete to match the existing material.

The damage to the limestone cap will be repaired using concrete.

At the east elevation, the modern CMU sheds will be removed.

Along the west elevation, the applicant will retain existing site features. Cracks in concrete steps and sidewalks will be sealed.

At the north elevation, the applicant will remove the existing concrete walkway and repour it so that it slopes away from the building. The exterior metal stair will be repaired as needed, scraped, and repainted.

Impact will be to repair modern site features, such as sidewalks, stairs, and exterior stairs, and to remove the modern sheds at the east elevation.



#### COMMONWEALTH of VIRGINIA

#### **Department of Historic Resources**

Matt Strickler Secretary of Natural Resources 2801 Kensington Avenue, Richmond, Virginia 23221

Julie V. Langan *Director* 

Tel: (804) 367-2323 Fax: (804) 367-2391 www.dhr.virginia.gov

July 30, 2019

Mr. Robert Brown, Trustee Sixth Mount Zion Baptist Church 14 West Duval Street Richmond, VA 23220

Re: Sixth Mount Zion Baptist Church

14 West Duval Street - Richmond

Part 2 Response DHR # 2019-093

Dear Mr. Brown -

Thank you for submitting the State Rehabilitation Tax Credit Application, Part 2, "Description of Rehabilitation," for the property located at 14 West Duval Street in Richmond. We are also in receipt of the necessary State application fee and appreciate its timely submission. Based on the materials provided, the proposed scope of work is consistent with the Secretary of the Interior's *Standards for Rehabilitation*, and the project is approved as submitted.

Please be aware that DHR is conducting a physical inspection of all properties as part of the Part 3 review process. Consequently, we anticipate that review of completed projects will take approximately 60 days from the date of submission. If determined necessary, DHR may conduct an inspection at the end of an initial phase that is submitted for Part 3 certification.

Please remember to submit an Amendment should the scope of work change from what has been previously reviewed and approved; the appropriate form can be found on page 7 of the Part 2 application. Otherwise, we will look forward to receiving the Part 3 application, "Request for Certification of Completed Work," upon completion of the project. In the meantime, please feel free to contact me with questions or concerns at 804-482-6095 or by e-mail at Carolyn.Zemanian@dhr.virginia.gov.

Sincerely,

Carolyn Zemanian
Tax Credit Reviewer

Division of Preservation Incentives

cc: Paige Pollard