

COMMISSION OF ARCHITECTURAL REVIEW

APPLICATION FOR CERTIFICATE OF APPROPRIATENESS

The same of the sa	A STATE OF THE PARTY OF THE PAR				
PROP	ERTY (loca	ation of work)		Date/time rec'd:	
Addres	s 2301	Venable Street, Richmond VA	A 23223	Rec'd by:	
	district	Church Hill North		Application #: Hearing date:	
APPLI	CANT IN	FORMATION			
Name	Erica Si	ms		Phone 804-915-4940	
Compa	ny Magg	ie Walker Community Land Tr	ust	Email erica@hdadvisors.net	
Mailing	Address	203 N. Robinson Street Richmond, VA 23220		Applicant Type: ☒ Owner ☐ Agent ☐ Lessee ☐ Architect ☐ Contractor ☐ Other (please specify):	
OWN	R INFOR	MATION (if different from a	above)		
Name	same	as above		Company	
Mailing	Address			Phone	
				Email	
PROJE	CT INFO	RMATION			
Review	Type:	Ճ Conceptual Review	☐ Final Review		
Project	Туре:	□ Alteration	☐ Demolition	☑ New Construction	
Project	(Conceptual Review Required) t Description: (attach additional sheets if needed)				
	struction o		ly home on a vacant	t corner lot. Additional Narrative is contained in th	
ACKN	OWLEDG	EMENT OF RESPONSIBIL	ITY		
and may	require a ı	new application and CAR approva	al. Failure to comply w	A. Revisions to approved work require staff review with the COA may result in project delays or legal tional year, upon written request.	
Require	ments: A co	omplete application includes all a	applicable information	requested on checklists to provide a complete	

Requirements: A complete application includes all applicable information requested on checklists to provide a complete and accurate description of existing and proposed conditions. Applicants proposing major new construction, including additions, should meet with Staff to review the application and requirements prior to submitting an application. Owner

contact information and signature is required. Late or incomplete applications will not be considered.

Zoning Requirements: Prior to Commission review, it is the responsibility of the applicant to determine if zoning approval is required and application materials should be prepared in compliance with zoning.

Signature of Owner

Date 4-26-19

CERTIFICATE OF APPROPRIATENESS APPLICATION INSTRUCTIONS

In advance of the application deadline please contact staff to discuss your project, application requirements, and if necessary, to make an appointment to meet with staff for a project consultation in the office or on-site. The Commission of Architectural Review website has additional project guidance and forms:

http://www.richmondgov.com/CommissionArchitecturalReview/index.aspx

Division of Planning and Preservation 804.646.6335 Carey.Jones@Richmondgov.com

SUBMISSION INSTRUCTIONS

Submit the following items to the Division of Planning and Preservation, Rm. 510, 900 E. Broad Street:

- One (1) signed and completed application property owners signature required
- Eleven (11) copies of supporting documentation, as indicated on appropriate check-list, collated and stapled
- All plans and elevations should be printed 11x17 and all text easily legible
- One digital copy of the application and supporting documentation, depending on size emailed to staff or saved to a thumb drive or CD and delivered with the application materials.
- Applications are due by 12 PM (noon) on the deadline date (see table below).
- <u>Exception</u>: revisions to items deferred, denied or presented conceptually at the previous Commission meeting are due one week after the application due date. Please contact staff to confirm this date.
- Application deadlines are firm. All materials must be submitted by the deadline to be considered at the
 following Commission meeting. Designs must be final at the time of application; revisions will not be
 accepted after the deadline. Incomplete and/or late applications will not be placed on the agenda.
- The Commission will <u>not</u> accept new materials, revisions, or redesigns at the meeting. Deferral until the following month's meeting may be necessary in such cases to allow for adequate review by staff, Commissioners, and public notice if required.

MEETING SCHEDULE AND DUE DATES

Commission meetings start at 3:30 PM in the 5th floor conference room of City Hall, 900 E. Broad Street.
 The owner and/or applicant is encouraged to attend the meeting.

2019 Commission Meeting Date	Application Deadline (Friday at noon unless otherwise noted)	
January 22 nd	December 28 th , 2018	
February 26 th	January 25 th	
March 26 th	March 1 st	
April 23 rd	March 29 th	
May 28 th	April 26 th	
June 25 th	May 31 st	
July 23 rd	June 28 th	
August 27 th	July 26 th	
September 24 th	August 30 th	
October 22 nd	September 27 th	
November 26 th	October 25 th	
December 17 th	November 22 nd	

Architectural Review Application Narrative

April 26, 2019

SUMMARY

ADDRESS: 2301 Venable St, Richmond, VA 23223

PARCEL ID: E0000427001
NEIGHBORHOOD: Union Hill

CURRENT USE: R Single-Family Vacant (R-63)

SOURCE: City of Richmond direct sale (tax delinquent)



Written Description

The proposed new construction for this lot is an as-of-right, two-story, single family home. The home has been designed to maximize the use of the lot and to fit into the context of the surrounding the neighborhood. The foundation consists of a standard 24" conditioned /insulated foundation wall crawl space to meet new energy standards. Fiber cement siding is specified for the exterior with brick elements as noted on the elevations and specifications to provide contextual texture. Wood trim and vinyl, solid composite PVC trim for exterior including porch elements. Wood-clad aluminum windows, insulated metal exterior doors with insulated glass accents as noted on drawings, The roof is a mix of modified bitumen roof sloped roof) and asphalt architectural dimensional shingles (flat roof). A treated 6 foot high, rear yard wood privacy fence enclosing a PVC deck and integral hard surface landscaping areas extends from the back of the house along the sidewalk west lot line and along the alley property line.

References to the Richmond Old and Historic Districts Handbook and Design Review Guidelines

The front façade treatment and front yard treatment for this corner lot have been designed with the contextual simplicity referenced on Page 77 of the Handbook.

The front and side elevations have been designed in reference to Page 48 wherein the fiber cement siding used has been carried onto the corner/ side elevation. Foundation material references the historic and the height is in keeping with the surrounding character. Windows for the corner-side and front elevations are proportional and aligned. Architectural elements typical of corner lots in historic districts have been incorporated.

Fencing has been designed and specified to conform specifically with references on Page 51 and 78 of the Handbook which emphasize the need for contextual elements with related building materials and paint or stain colors that are opaque and compliment the main structure.

Photos – 2301 Venable Street



Figure 1 2301 Venable Lot looking South from Venable St



Figure 2 2301 Venable looking East from Tulip St



Figure 3 2301 Venable St looking north from alleyway.



Figure 4 2301 Venable looking South from North side of Venable St



Figure 5 2303 Venable (neighboring house to the east)



Figure 6 looking West on Venable (from north side of Venable)





Figure 8 West side of Tulip St - photo taken from 2301 Venable lot

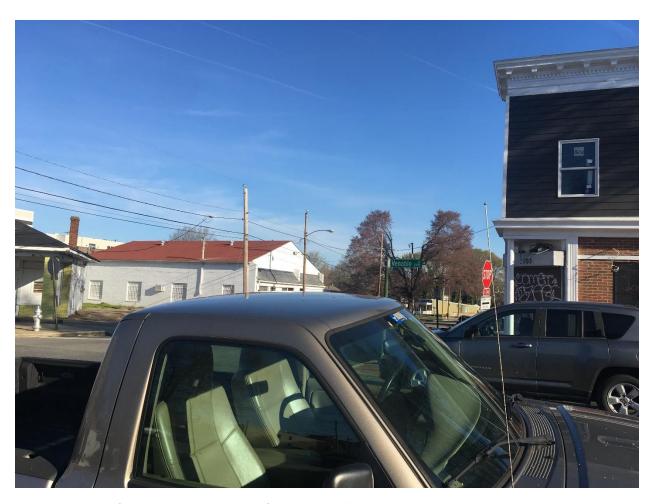


Figure 9 North side of Venable Street - photo taken from 2301 Venable St

Address: #2301 Venable Street


Current Owner: Maggie Walker Community Land Trust

Parcel ID: E0000427001

I.D. 2018 8453

Note: Bearings protracted from City Baseline sheet 9 NE.

10' Public Alley

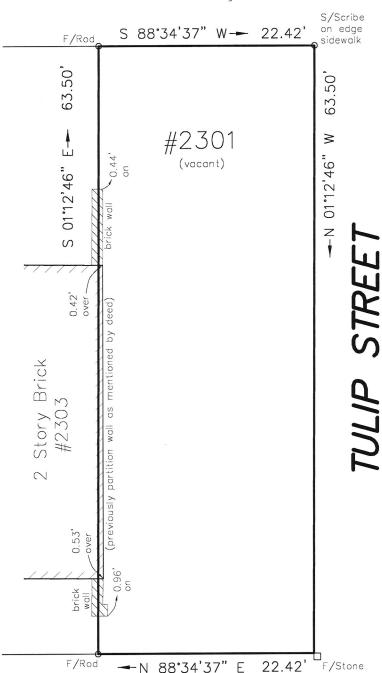

VENABLE STREET




Survey and Plat of

The Propety Known as #2301 Venable Street in the City of Richmond, VA

This is to certify that on 08/07/18 I mode an accurate field survey of the premises shown hereon that all improvements and eosements known or visible are shown hereon, that there are no encroachments by improvements either from adjoining premises or from subject premises upon adjoining premises other than shown hereon. THIS PLAT WAS MADE WITHOUT THE BENEFIT OF A TITLE SURVEY OR REPORT.

FLOOD INSURANCE NOTE: By graphics plotting only, this property is in ZONE X of the Flood Insurance Rate Map, Community Panel No. 5101290041E effective date of 07/16/14 Exact designations can only be determined by an Elevation Certificate. Based on the above information, this property IS NOT in a Special Flood Hazard Area.

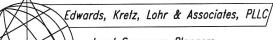



Land Surveyors-Planners


Virginia-North Carolina

1900 Byrd Avenue, Suite 103 Richmond, Virginia, 23230 Phone (804) 673–9666 Fax (804) 673–9990

Scale: 1"=10' Drawn: TCJ Job: 1440-18 Date: 08/08/18 Checked: JAL

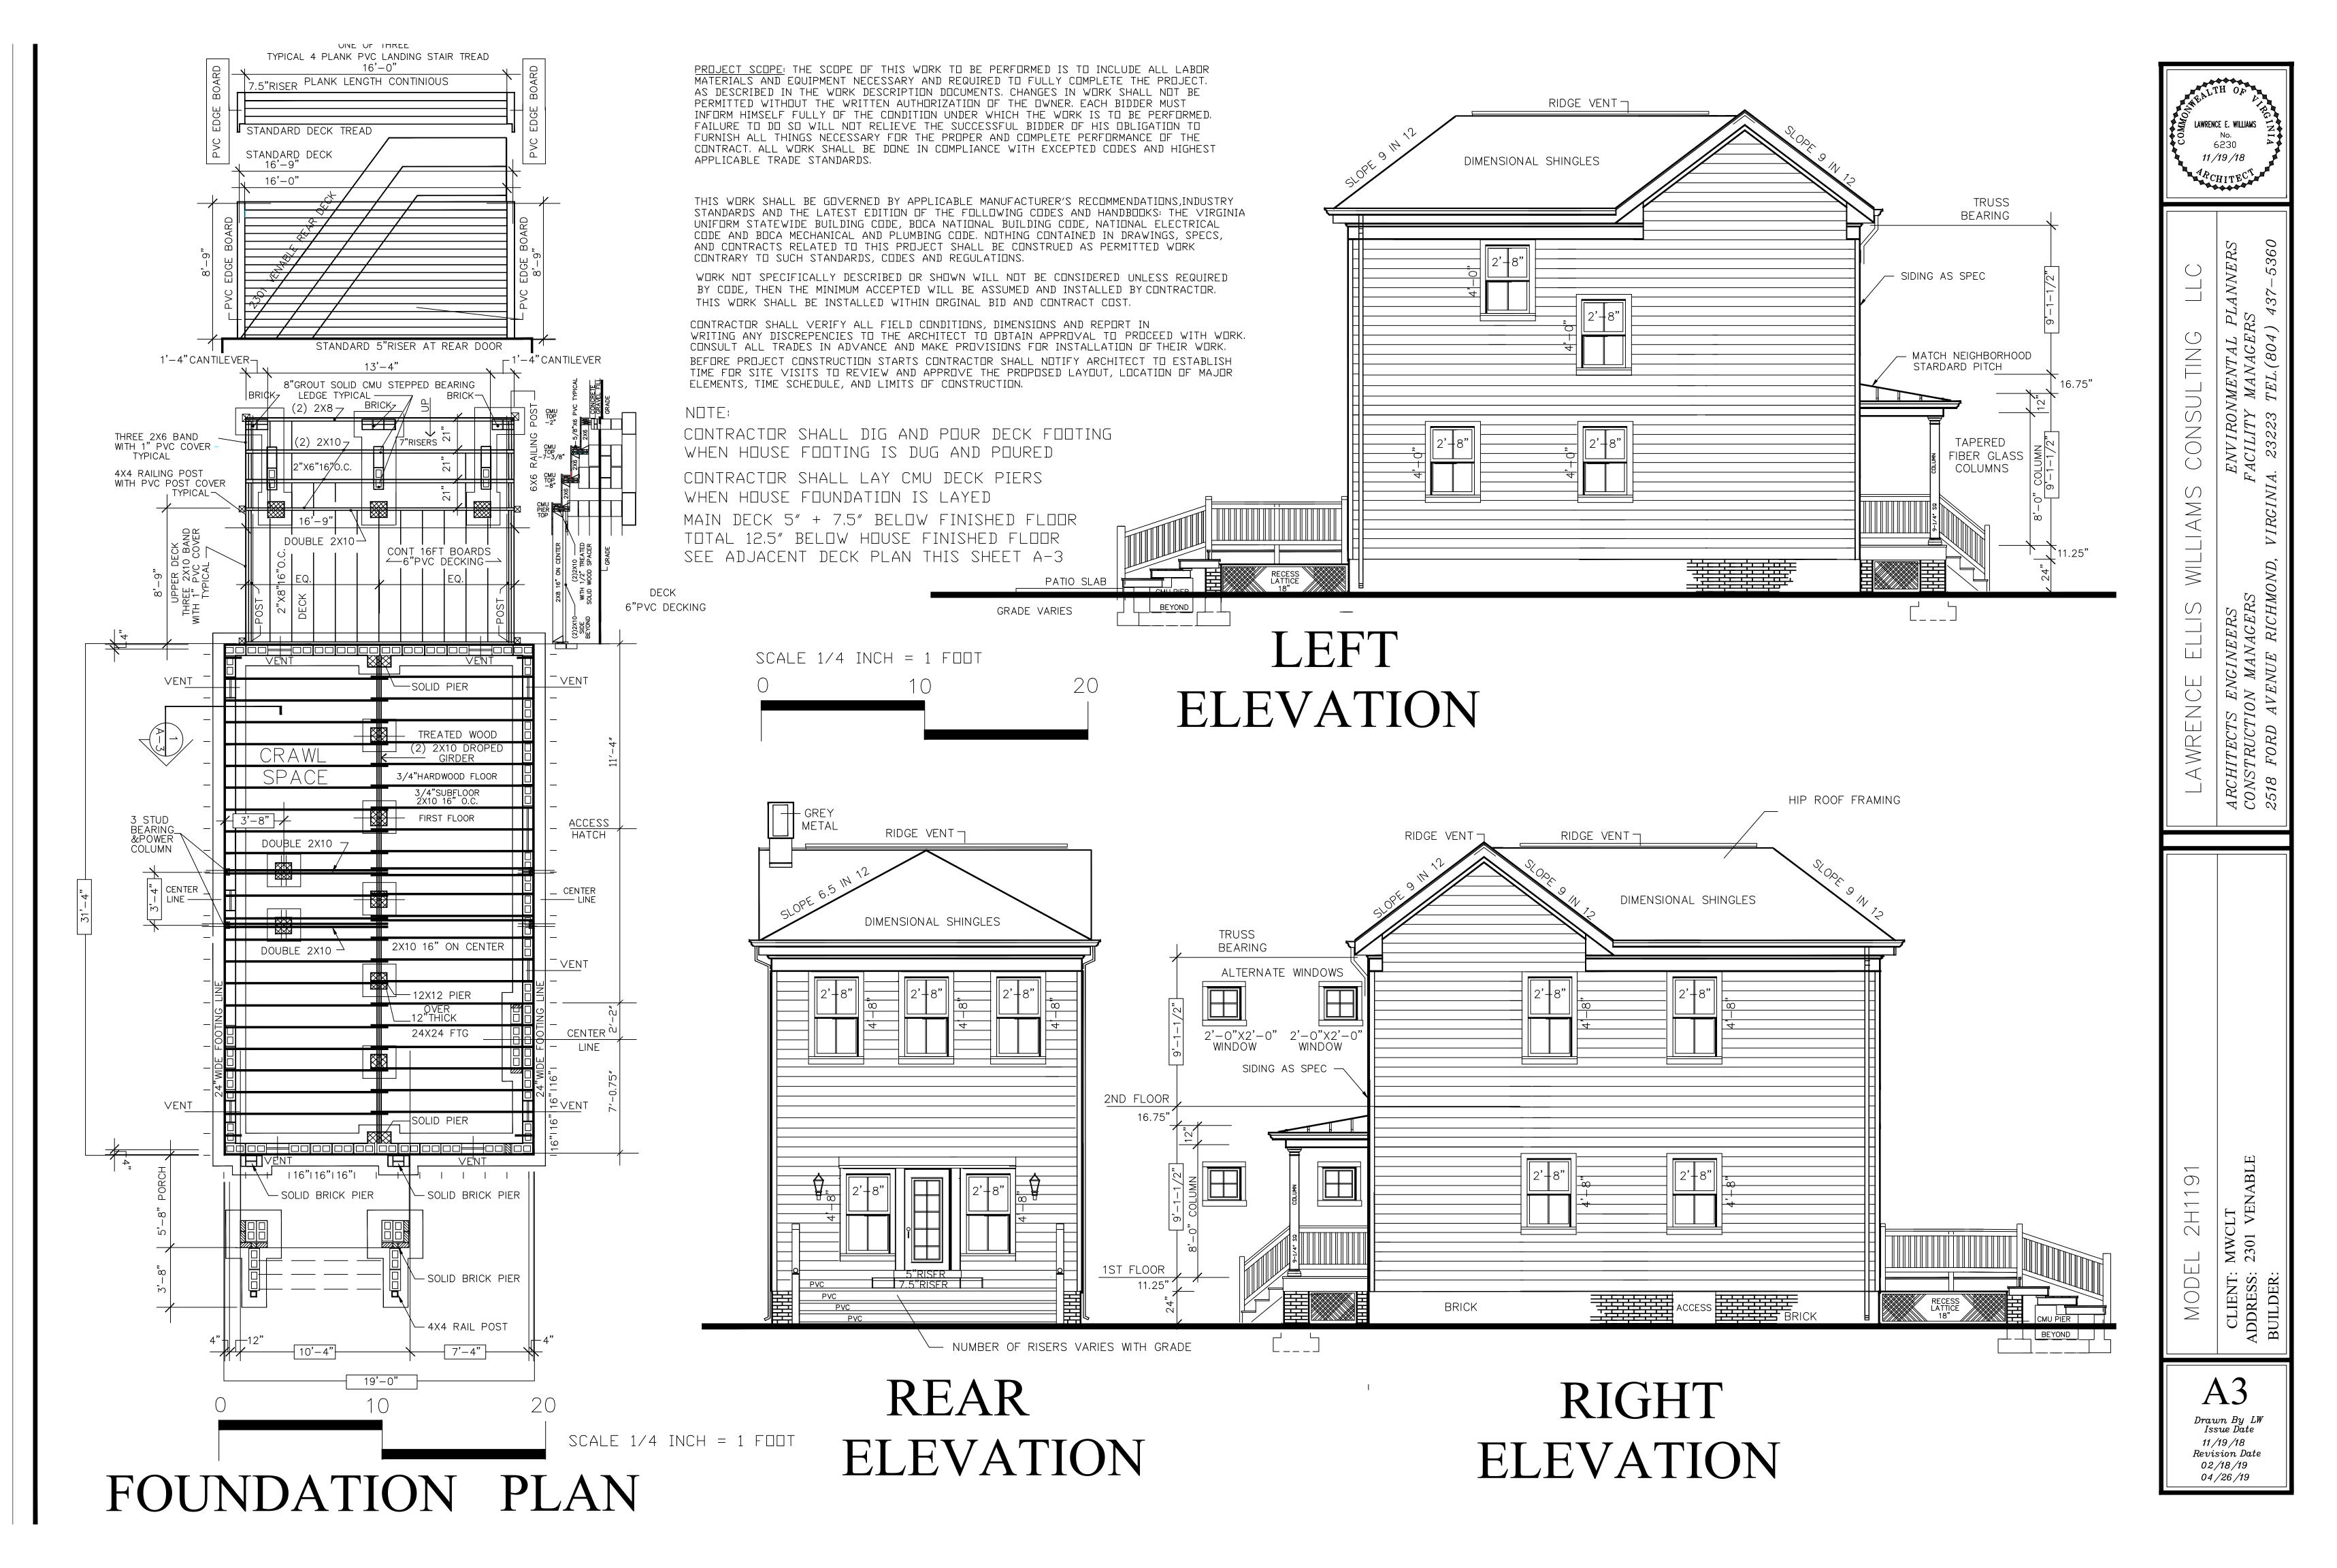


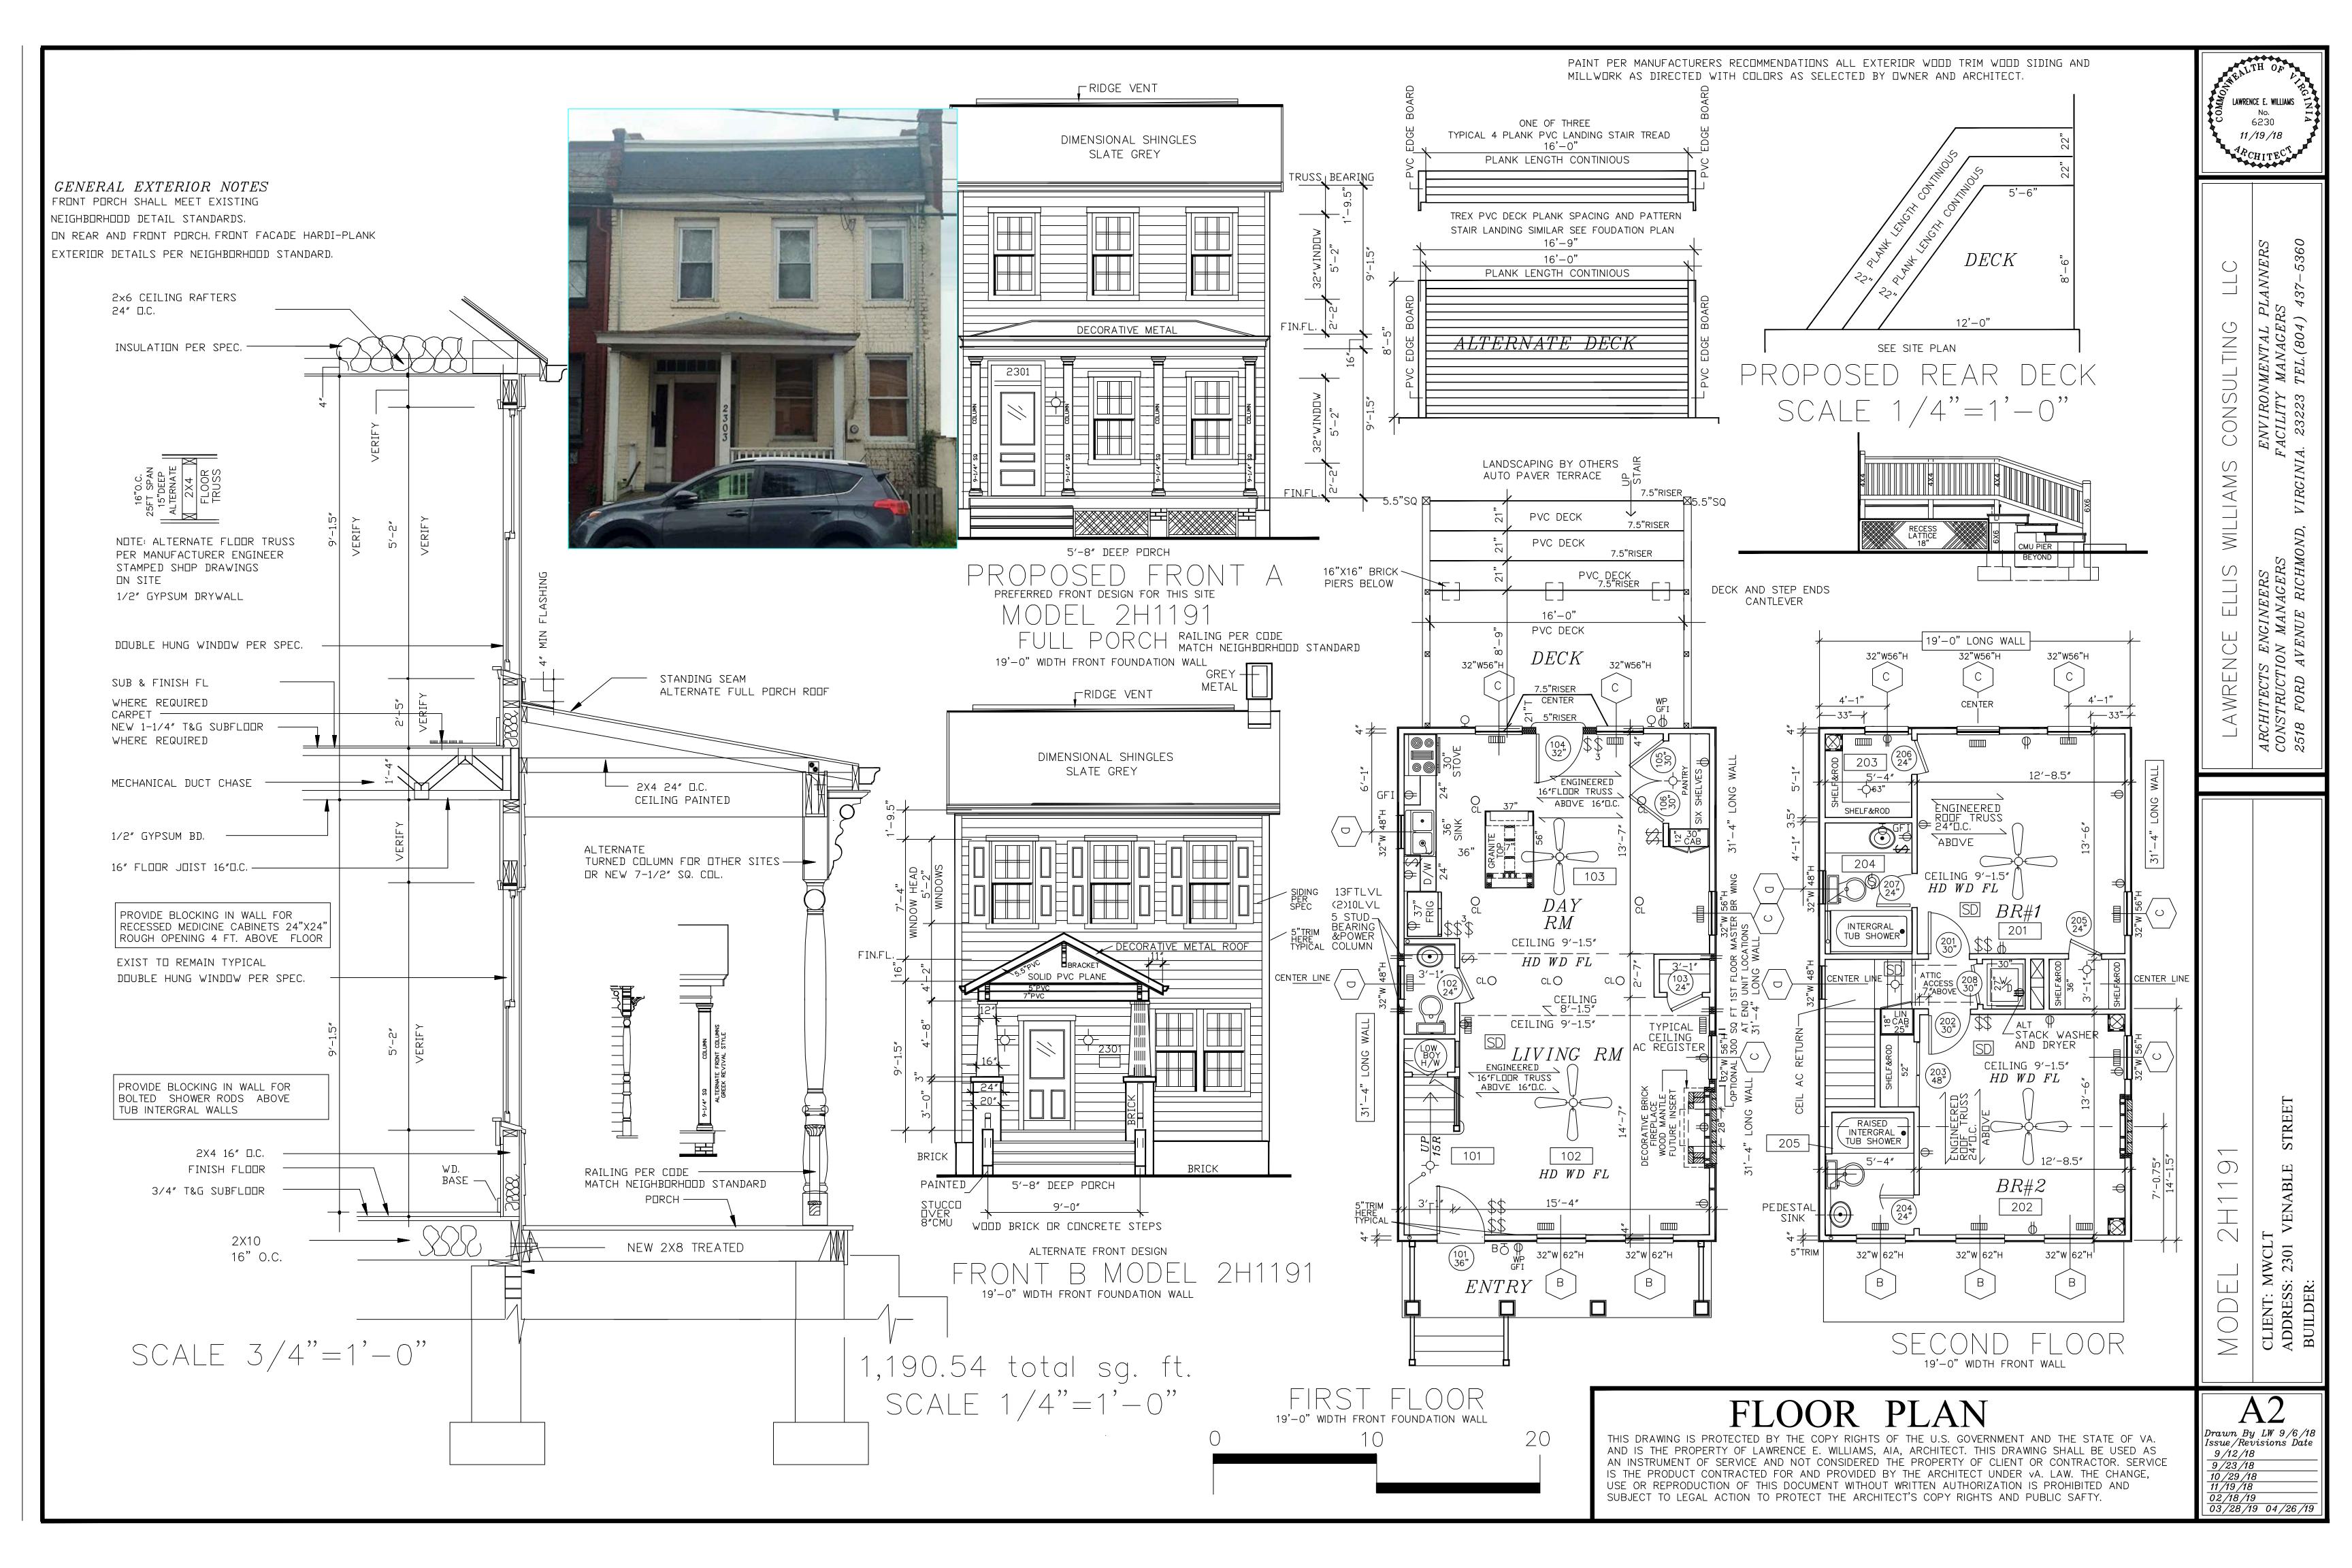

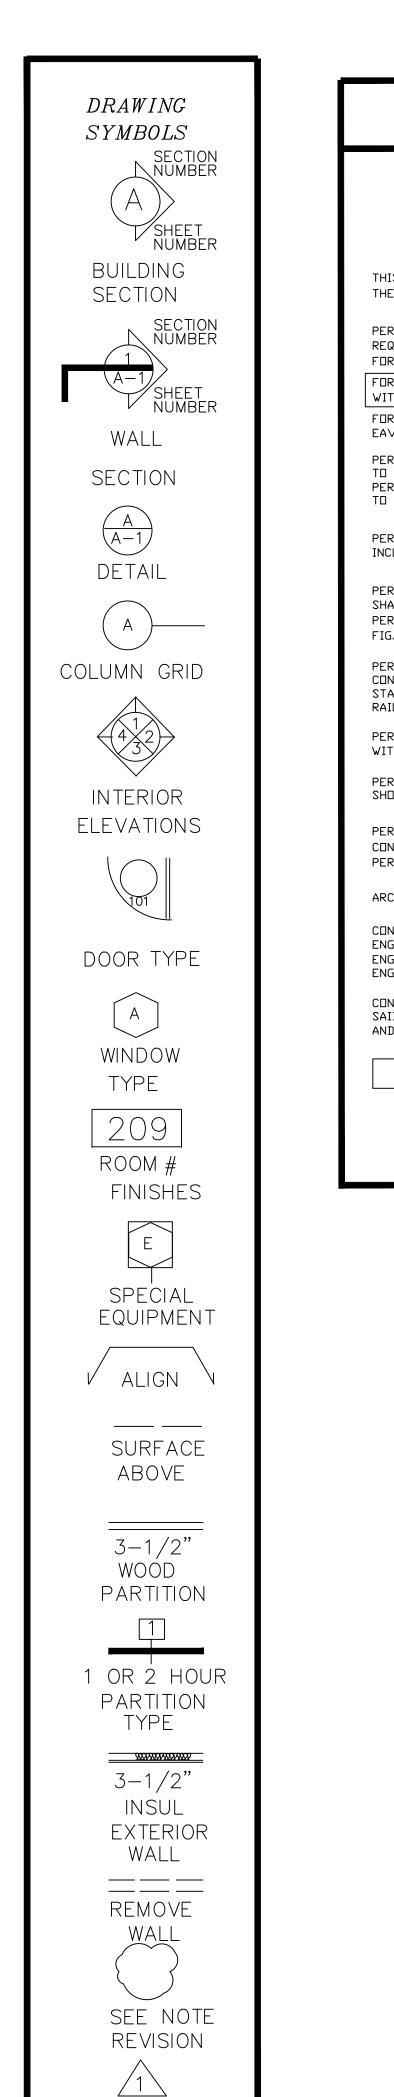


REVISION

ADDENDUM

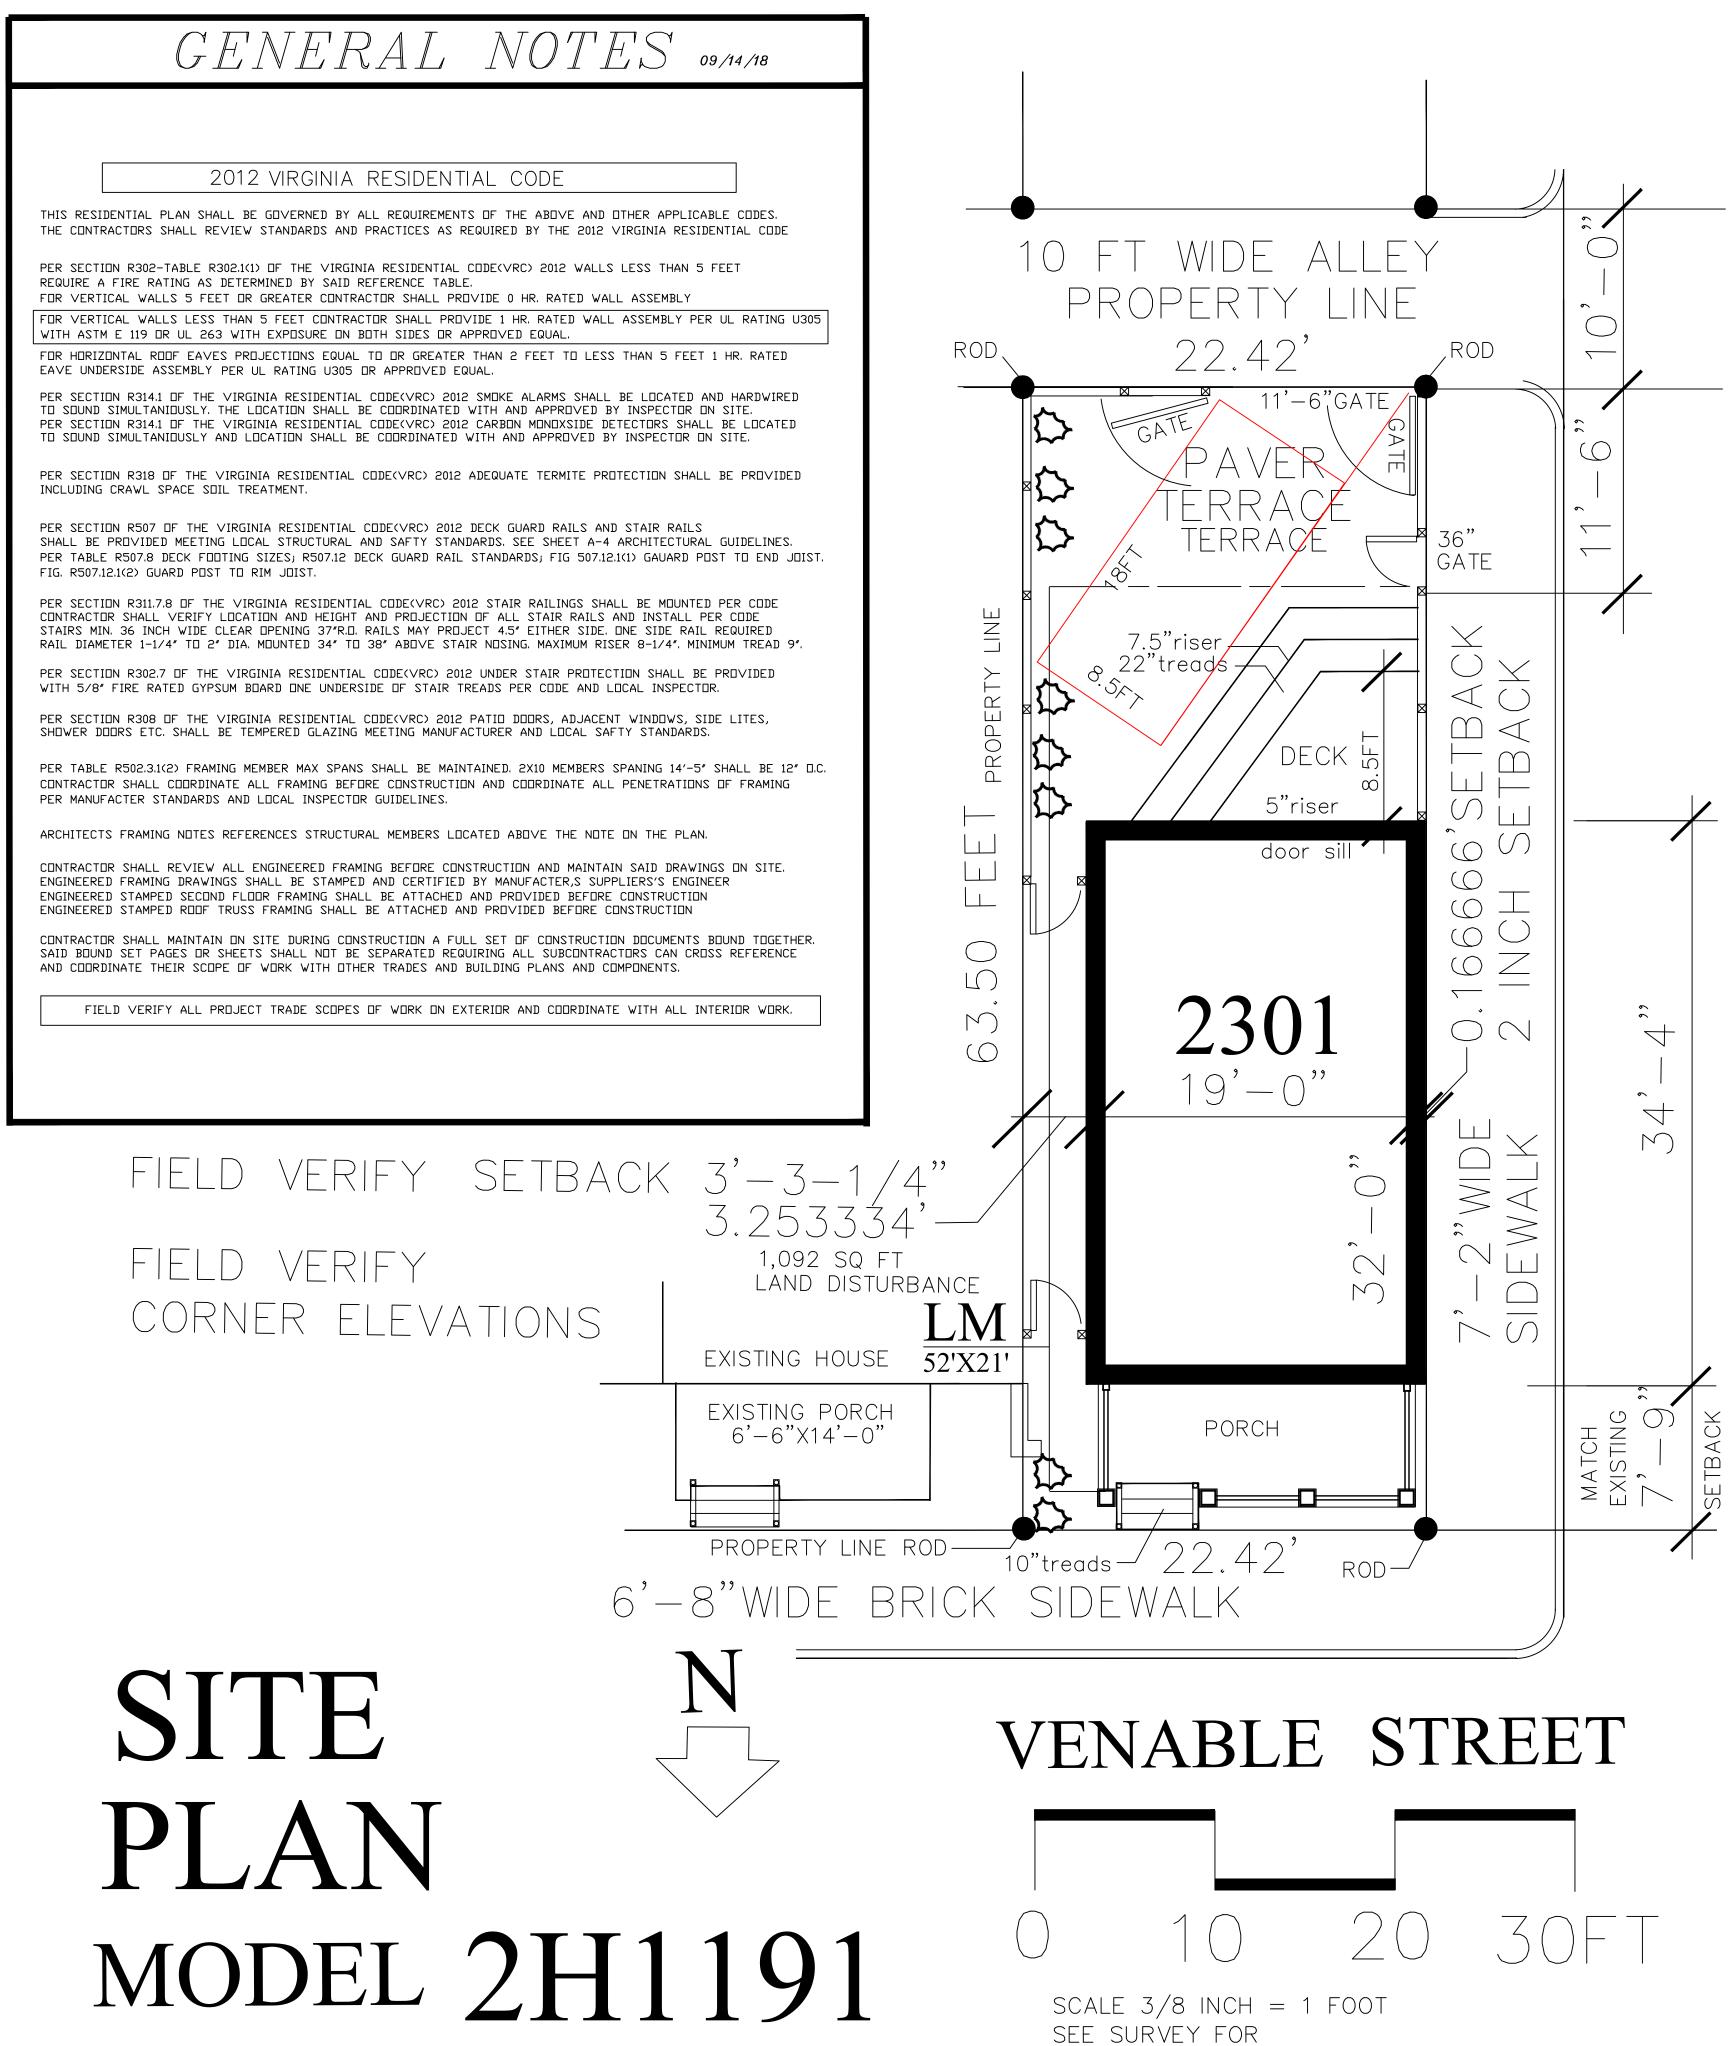

PROPERTY LINE

LOCATION AND ORIENTATION

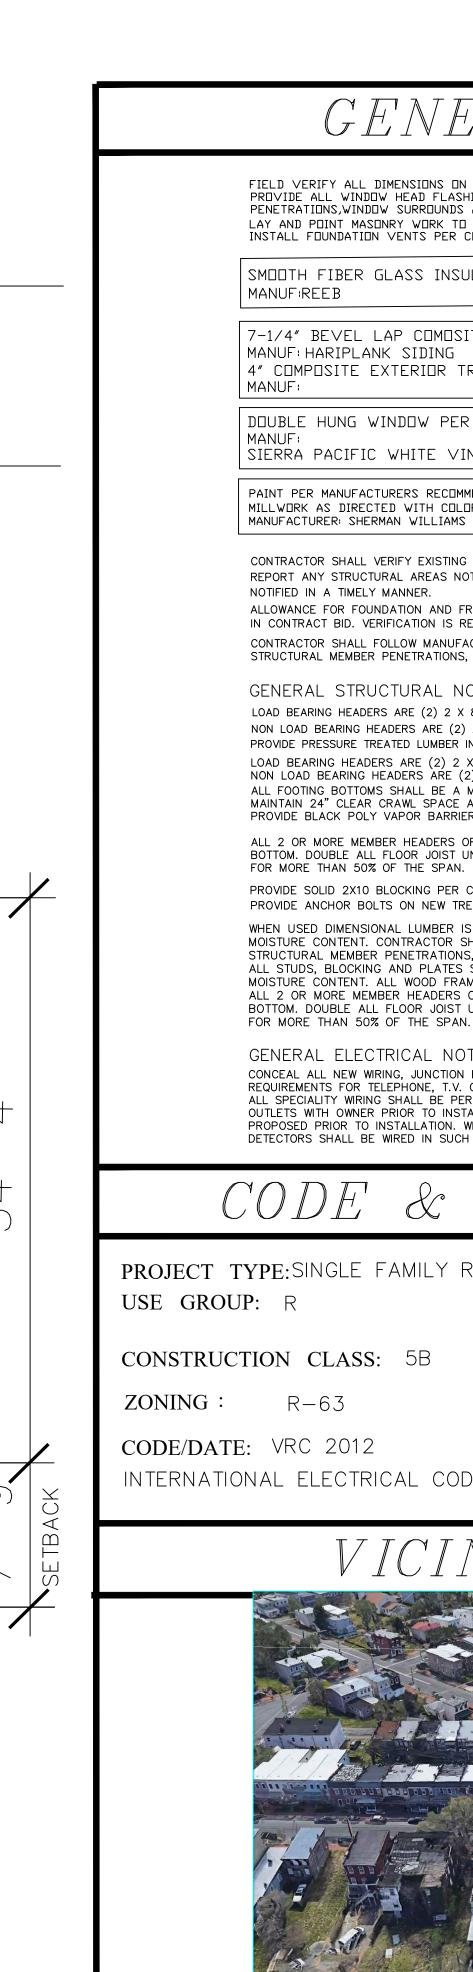

GENERAL NOTES

FIELD VERIFY ALL DIMENSIONS ON EXTERIOR AND COORDINATE WITH ALL INTERIOR DIMENSIONS. PROVIDE ALL WINDOW HEAD FLASHING AS REQUIRED AND AT CORNICE, ROOFING CONDITION, ROOF PENETRATIONS, WINDOW SURROUNDS AND DOORS TO INSURE WATERTIGHT BUILDING ENEVELOPE. LAY AND POINT MASONRY WORK TO INSURE WATERTIGHT CONDITION AND VISUAL CORRECTNESS. INSTALL FOUNDATION VENTS PER CODE.

SMOOTH FIBER GLASS INSULATED GLASS DOOR PER MANUFACTURER SPECS

7-1/4" BEVEL LAP COMOSITE SIDING 5" EXPOSURE MANUF: HARIPLANK SIDING 4" COMPOSITE EXTERIOR TRIM OR APPROVED EQUAL

DOUBLE HUNG WINDOW PER SPEC. SIERRA PACIFIC WHITE VINYL 8000

PAINT PER MANUFACTURERS RECOMMENDATIONS ALL EXTERIOR WOOD TRIM WOOD SIDING AND MILLWORK AS DIRECTED WITH COLORS AS SELECTED BY OWNER AND ARCHITECT. MANUFACTURER: SHERMAN WILLIAMS TWO COATS EMERALD EXTERIOR ONE COAT LATEX PRIMER TINT P-5 GRAY

CONTRACTOR SHALL VERIFY EXISTING CONDITIONS OF FOUNDATION AND FRAMING MEMBERS AND REPORT ANY STRUCTURAL AREAS NOT IN ACCORDANCE WITH THESE PLANS. ARCHITECT SHALL BE NOTIFIED IN A TIMELY MANNER.

ALLOWANCE FOR FOUNDATION AND FRAMING MODIFICATIONS TO MEET ALL RELEVANT CODES SHALL BE INCLUDED IN CONTRACT BID. VERIFICATION IS RECOMMENDED BEFORE SUBMITTING BID.

CONTRACTOR SHALL FOLLOW MANUFACTURER'S RECOMMENDATIONS FOR STRUCTURAL MEMBER PENETRATIONS, BLOCKING AND STIFFENERS.

GENERAL STRUCTURAL NOTES

LOAD BEARING HEADERS ARE (2) 2 X 8 IF NOT SHOWN ON PLAN NON LOAD BEARING HEADERS ARE (2) 2 X 4 IF NOT SHOWN ON PLAN PROVIDE PRESSURE TREATED LUMBER IN AREAS THAT MEET CONCRETE OR MASONRY LOAD BEARING HEADERS ARE (2) 2 X 8 IF NOT SHOWN ON PLAN NON LOAD BEARING HEADERS ARE (2) 2 X 4 IF NOT SHOWN ON PLAN ALL FOOTING BOTTOMS SHALL BE A MINIMUM OF 24" BELOW GRADE. MAINTAIN 24" CLEAR CRAWL SPACE ADEQUATE TO SERVICE CRAWL SPACE DUCTS PROVIDE BLACK POLY VAPOR BARRIER IN CRAWL SPACE

ALL 2 OR MORE MEMBER HEADERS OR BEAMS SHALL BE NAILED TOGETHER @ 12" O.C. TOP AND BOTTOM. DOUBLE ALL FLOOR JOIST UNDER ANY PARTITION WHICH RUN PARALLEL TO FLOOR JOIST FOR MORE THAN 50% OF THE SPAN.

PROVIDE SOLID 2X10 BLOCKING PER CODE BETWEEN FLOOR JOIST MID SPAN

PROVIDE ANCHOR BOLTS ON NEW TREATED SILL PLATE FRAMING ABOVE FOUNDATIONS

WHEN USED DIMENSIONAL LUMBER IS SIZED BASED ON #2 SOUTHERN YELLOW PINE. KILM DRIED WITH 19% MOISTURE CONTENT. CONTRACTOR SHALL FOLLOW MANUFACTURER'S RECOMMENDATIONS FOR STRUCTURAL MEMBER PENETRATIONS, BLOCKING AND STIFFENERS. ALL STUDS, BLOCKING AND PLATES SHALL BE #2 SOUTHERN PINE OR #2 SPRUCE WITH 19% MOISTURE CONTENT. ALL WOOD FRAMING BEARING ON MASONRY SHALL BEAR ON TREATED WD. PLATE. ALL 2 OR MORE MEMBER HEADERS OR BEAMS SHALL BE NAILED TOGETHER @ 12" O.C. TOP AND BOTTOM. DOUBLE ALL FLOOR JOIST UNDER ANY PARTITION WHICH RUN PARALLEL TO FLOOR JOIST

GENERAL ELECTRICAL NOTES:

CONCEAL ALL NEW WIRING, JUNCTION BOXES AND CONDUIT. CONTRACTOR SHALL VERIFY INSTALLATION REQUIREMENTS FOR TELEPHONE, T.V. CABLE AND ALARM SYSTEM AND INCLUDE IN THIS CONTRACT. ALL SPECIALITY WIRING SHALL BE PER MANUFACTURERS RECOMMENDATION. VERIFY LOCATION OF OUTLETS WITH OWNER PRIOR TO INSTALLATION. VERIFY FIXTURE ALLOWANCE AND TYPE OF FIXTURE PROPOSED PRIOR TO INSTALLATION. WIRING SHALL BE COPPER PER NEC REQUIREMENTS. ALL SMOKE DETECTORS SHALL BE WIRED IN SUCH A MANNER THAT ALL SHALL ALARM WHEN ONE IS ACTIVATED.

CODE & ZONING DATA

PROJECT TYPE: SINGLE FAMILY RESIDENTIAL SITE AREA:

CIVIL

SQ.FT.


TOTAL BUILDING 1,190.54 SQ.FT.

CODE/DATE: VRC 2012

INTERNATIONAL MECHANICAL CODE

INTERNATIONAL ELECTRICAL CODE

INTERNATIONAL PLUMBING CODE

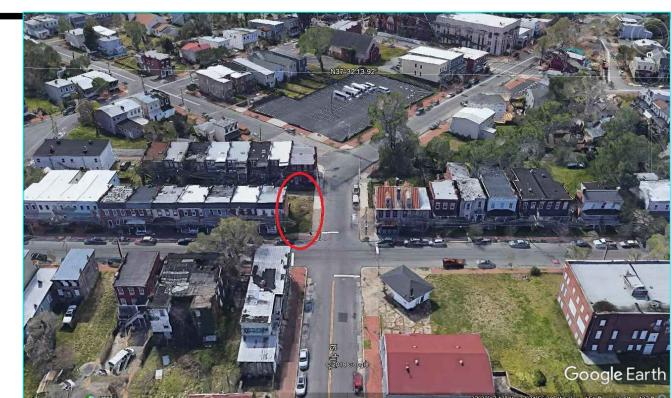

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Drawn By LW Issue Date 09/06/18 Revision Date 09 /12 /18 09/24/18 11/19/18 02/18/19 03/01/19 03/08/19 04/26/19

LAWRENCE E. WILLIAMS

6230

11 /19 /18

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C. Finish: Provide smooth—true—plumb—sanded finish throughout ready

for painting or other wall surface treatment.

02/28/18

02/18/19

11 /19 /18

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SUBJECT TO LEGAL ACTION TO PROTECT THE ARCHITECT'S COPY RIGHTS PUBLIC TRUST AND PUBLIC SAFTY.

A. Upon completion of the work of this Section secure, fill out, and properly

having jurisdiction.

post such certificate of compliance as required by government agencies

manufacturers, tooling the joints to neat and smooth profile.

