

Application for URBAN DESIGN COMMITTEE Review

Department of Planning and Development Review
Planning & Preservation Division
900 E. Broad Street, Room 510
Richmond, Virginia 23219
(804) 646-6335

http://www.richmondgov.com/CommitteeUrbanDesign

Application Type Addition/Alteration to Existing Structure New Construction Streetscape Site Amenity	Encroachment Master Plan Sign Other	Review Type Conceptual Final
Project Name:		
Project Address:		
Applicant Information (on all applications other than encroachments, a City agence)	·	
Name:	Email:	
City Agency.	Phone:	
Address:		
Main Contact (if different from Applicant):		
Company:		
Email:		

Submittal Deadlines

All applications and support materials must be filed no later than 21 days prior to the scheduled meeting of the Urban Design Committee (UDC). Please see the schedule on page 3 as actual deadlines are adjusted due to City holidays. Late or incomplete submissions will be deferred to the next meeting.

Filing

Applications can be mailed or delivered to the attention of "Urban Design Committee" at the address listed at the top of this page. It is important that the applicant discuss the proposal with appropriate City agencies, Zoning Administration staff, and area civic associations and residents prior to filing the application with the UDC.

UDC Background

The UDC is a ten member committee created by City Council in 1968 whose purpose is to advise the City Planning Commission on the design of projects on City property or right-of-way. The UDC provides advice of an aesthetic nature in connection with the performance of the duties of the Commission under Sections 17.05, 17.06 and 17.07 of the City Charter. The UDC also advises the Department of Public Works in regards to private encroachments in the public right-of-way.



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Submission Requirements

- 10 copies of the application cover sheet and all support materials (see below), unless the application is for an encroachment, in which case only 6 copies are required. Plan sheets should be 11" x 17", folded to 8 1/2" x 11". If it is not possible to scale plans to these dimensions, please provide one set of larger, scaled plans.
- An electronic copy (PDF preferred) of all application materials, which can be burned to disc, emailed, or delivered by FTP.

All applications must include the attached cover sheet and the following support materials, as applicable to the project:

For Conceptual Review

- A detailed project narrative which includes the following: purpose of the project, project background, project budget and funding sources, description of construction program and estimated construction start date (description should also provide information on the surrounding area to provide context).
- A site plan for the project indicating site characteristics which include: building footprints, parking areas, pedestrian routes, recreation areas, open areas and areas of future expansion.
- A set of floor plans and elevations, as detailed as possible.
- A landscaping plan which shows the general location and character of plant materials and notes any existing tree to be removed.

For Final Review

- A detailed project narrative which includes the following: purpose of the project, project background, project budget and funding sources, description of construction program and estimated construction start date (description should also provide information on the surrounding area to provide context).
- A site plan for the project indicating site characteristics which include: building footprints, parking areas, pedestrian routes, recreation areas, open areas and areas of future expansion.
- A set of floor plans and elevations, as detailed as possible.
- A landscaping plan that includes a complete plant schedule, the precise location of all plant materials, and a landscape maintenance analysis. The plant schedule must show number, size and type of each planting proposed. If existing trees are to be removed, their size, type and location must be noted on the landscape plan.
- The location of all lighting units should be noted on a site plan, including wall-mounted, site and parking lot lighting. Other site details, such as benches, trash containers and special paving materials, should also be located. Include specification sheets for each item.
- Samples of all proposed exterior building materials, including but not limited to brick, mortar, shingles, siding, glass, paint and stain colors. When as actual sample cannot be provided, a product information sheet that shows the item or a photo of an existing item may be substituted.

Review and Processing

Once an application is received, it is reviewed by staff, who compiles a report that is sent to the UDC. A copy of the report and the meeting agenda will be sent to the applicant prior to the meeting. The applicant or a representative should be present at the UDC meeting or the application may be deferred to the next regularly scheduled meeting. It is also strongly suggested that a representative of the City Agency which will have final responsibility for the item be present at the meeting (if the applicant and the representative are not the same). Once the UDC recommends action on the application, it is automatically placed on the agenda for the next City Planning Commission (CPC) meeting. An exception to this is encroachment applications, recommendations for which are forwarded to the Department of Public Works. The applicant or a representative must be present at the CPC meeting or the application may be deferred to the next regularly scheduled meeting.

CITY OF RICHMOND URBAN DESIGN COMMITTEE (UDC)

MEETING SCHEDULE

UDC Meetings	UDC Submission Deadlines	Anticipated Date of Planning Commission Following the UDC Meeting
December 7, 2017	November 9, 2017	December 18, 2017
January 4, 2018	December 7, 2017**	January 16, 2018 ¹
February 8, 2018	January 18, 2018	February 20, 2018 ²
March 8, 2018	February 15, 2018	March 19, 2018
April 5, 2018	March 15, 2018	April 16, 2018
May 10, 2018	April 19, 2018	May 21, 2018
June 7, 2018	May 17, 2018	June 18, 2018
July 5, 2018	June 14, 2018	July 16, 2018
August 9, 2018	July 19, 2018	August 20, 2018 ³
September 6, 2018	August 16, 2018	September 17, 2018
October 4, 2018	September 13, 2018	October 15, 2018
November 8, 2018	October 18, 2018	November 19, 2018
December 6, 2018	November 15, 2018*	December 17, 2018 ⁴

¹ Monday, January 15, 2018 is a City of Richmond Holiday.

The Richmond Urban Design Committee (UDC) is a ten member advisory committee created by City Council in 1968. Its purpose is to advise the City Planning Commission on the design of City projects. The UDC reviews projects for appropriateness in "location, character and extent" and for consistency with the City's Master Plan and forwards recommendations to the Planning Commission. The UDC also advises the Department of Public Works in regards to private encroachments in the public right-of-way.

Regular meetings are scheduled for the Thursday after the first Monday of each month at 10:00 a.m. in the 5th floor conference room of City Hall. Special meetings are scheduled as needed.

For additional information, please contact the Planning and Preservation Division staff at (804) 646-3741 or joshua.son@richmondgov.com.

² Monday, February 19, 2018 is a City of Richmond Holiday.

³ This August CPC Meeting may be canceled. If so, Planning Commission hearing would be Tuesday, September 4, 2018.

⁴ This December CPC Meeting may be canceled. If so, Planning Commission hearing would be Monday, January 7, 2019.

^{**} Moved forward to account for Winter Holiday Schedule

THE SAUER CENTER

BROAD STREET STREETSCAPE NARRATIVE

August 16, 2018

PROJECT PURPOSE

With redevelopment of the 20-acre portion of The Sauer Center site, located on the north side of the 2000 block of West Broad Street between North Meadow Street and Allison Street, the sidewalk north of West Broad Street needed repair and a new functional design to encourage pedestrian activity and upgrade the streetscape appeal related to our development. With most street trees currently missing, portions of the sidewalk in poor condition, street light poles being shifted as required by the City, pedestrian lighting levels below desirable levels, the existing curb almost flush with the asphalt driving lanes (being raised as required by the City), redesign of the streetscape was critical to reflect the first-class development intentions of The Sauer Center. The streetscape design will be the front door to The Sauer Center, creating the first visual impression of this special development. This development will also draw new pedestrian activity and for those reasons the design makes extensive use of quality materials such as brick to this section of the City, granite tree well curbing, new site furniture and new pedestrian lighting. Sustainable items incorporated into the streetscape design include larger than usual 6'x18' tree wells, electric car charging stations and solar panels (extensively used on roof tops and carports within The Sauer Center site outside of the right of way). The large tree wells are designed to provide more space for tree root development, hence providing for longer longevity of the street trees. Natural gray scored concrete has been incorporated to create visual interest in the walkways. Brick pavers have been used to create a 'site furnishings' zone along the curb for tree wells, benches, trash receptacles, bike racks, and more. Brick pavers have also been used at special entrances in front of the Putney building (formerly Department of Taxation), and the Whole Foods Broad Street entrance and outdoor dining area (under roof). The pavers incorporate patterns that help define the site furnishings zone, walking zone, potential outdoor dining zone, and call attention to the special building entrances. LED In-ground up-lights are being used to light the building facades starting with The CF Sauer Company headquarter building and working west to the end of the development at the Putney building. The intent is to accentuate the development at night much in the same fashion as the buildings have been lit up on Main Street in the Fan district between Morris and Harvie Streets by the developer in the last part of the 20th century.

PROJECT BACKGROUND

The total Sauer Center development is comprised of approximately 40 acres of land north of Broad Street assembled over many years with 20 acres on each side of Hermitage Road. This application concerns the Broad Street streetscape connected to the 20 acres west of Hermitage Road. Sauer Properties, the real estate arm of The CF Sauer Company whose existing

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headquarters renovation is part of the project, is currently redeveloping the 20 acres west of Hermitage Road. The site has several historic buildings to be renovated and adapted to new office and retail uses, while the existing headquarters (in operation for over 100 years) will remain an office, warehouse, and manufacturing facility. A future high-rise apartment building with structured parking is proposed behind the Putney Building in a future phase of development. The site was designated a historic district with the intent of rehabilitating the historic buildings back to their original architectural character. Along West Broad Street, the site is comprised of several buildings, starting at the western end with the historic Putney Building, Lee's Famous Recipe Chicken (also getting a complete re-design upgrade), the new Whole Foods (which incorporates the historic Kaufmann building into its design), the historic Shepherd's Ice Cream Building, The CF Sauer warehouse, and finally the CF Sauer Headquarters Building. Previously renovated in 2005 is the historic Atlantic Motors Building on the east side of Meadow/Hermitage Road which won the national Palladio award for its sensitive rehabilitation. The remaining 20 acres of land on the east side of Hermitage Road has future potential opportunities for new construction along Hermitage Road and West Leigh Street. The old Sears building on West Broad Street and its former automotive building (to the rear) was purchased by the CF Sauer Company in 1978 when Sears closed its doors and has been adapted into a manufacturing facility by The CF Sauer Company. It will continue to be used as a manufacturing facility.

SURROUNDING AREA CONTEXT

The surrounding area of The Sauer Center includes the Department of Motor Vehicles (DMV) as a next-door neighbor to its western border. DMV has a suburban building design style with siting on the land not conducive to typical urban development. The land further west has only a few historically significant buildings fronting on West Broad Street including the Virginia Science Museum, which is also set back from the right of way line, and the old William Byrd Hotel, adapted to senior living apartments. The other buildings are scattered between many parking lots. To the immediate south of West Broad Street and The Sauer Center there are several historically significant buildings set forward to the right of way line with some missing buildings that now have small parking lots in their place. Many of the buildings have no parking on site, although the Book Bindery, now an office use, has its own parking garage that is set against the Broad Street right of way line. There are a variety of commercial uses such as restaurants, office, car rental, hair salon, and convenience grocery store. A significant number of vacant buildings also comprises the mix. To the south of the commercial strip along West Broad Street lies the Fan District full of residential single-family row type town houses and apartments. Allison Street and North Meadow Street are two streets providing pedestrian access directly to the West Broad Street sidewalk fronting and providing access to The Sauer Center. The Sauer Center is situated on an unusually long city block of approximately 1,570 linear feet of which The Sauer Center comprises two thirds of the block with over 1,000 linear feet giving The Sauer Center a dominant presence on Broad Street. A typical City block is only about 500-600 linear feet by comparison. The Sauer Center and the immediate historic district neighbors constitute a bit of an historic island within this part of Broad Street. For that reason, the use of brick pavers on the sidewalk is appropriate and in keeping with buildings built in the late 19th century and early 20th century throughout Richmond. This new development and sidewalk are expected to be a major 'seed' to encouraging new growth and renovations in this part of West Broad Street.

PROJECT BUDGET

The costs for implementing the new sidewalk design are based on actual bid pricing as listed below.

In-Ground Up-Lights	\$ 45,000
Irrigation	25,000
Concrete/Curb & Gutter	210,000
Hardscapes	175,000
Site Amenities/Furnishings	41,000
Landscaping/Plantings	20,000
Total	\$ 516,000

FUNDING SOURCES

Usually funding for City streetscape projects in the right of way come from the City of Richmond except in this situation. The CF Sauer Company has a long history, commitment, and civic minded philosophy to this location and City of Richmond. Because they would like it to be a special location, they are extensively using brick to set off and elevate their development, and become a major destination point in the City. For that reason, they are taking on the burden of paying for all costs involved in remaking and maintaining the sidewalk within the Broad Street right of way for approximately 1,000 linear feet. While in the early design phase, Sauer Properties was instructed by the Planning Department to use the Children's Hospital next to City Hall as a guide to the streetscape design. Even though the City may not be using brick on the rest of the Broad Street streetscape, the vertical elements of the streetscape and the scored concrete will still be in keeping with the Broad Street streetscape design currently being developed by City consultants.

DESCRIPTION OF CONSTRUCTION PROGRAM

The intent is to build the entire sidewalk to completion this year from the Putney building to the corner of North Meadow/Hermitage Road. The sidewalk work has been started, but work on the aesthetic items will not begin until after approval by the UDC.


ESTIMATED CONSTRUCTION START DATE

Anyone driving down Broad Street can see the new construction taking place with Whole Foods under roof. The general contractor, LF Jennings, thought they had the proper work in right of way permits and has demolished the existing sidewalk not realizing they needed the Urban Design Committee approval first. For that reason and as instructed by Mark Olinger, they will not be proceeding with any aesthetic improvements, but only work on unseen underground utilities and the such. There have been numerous unforeseen delays with permit acquisitions, and deadlines missed, that it is imperative construction be allowed to continue as soon as possible in order to meet the Whole Foods deadlines and not jeopardize the development agreement between them and Sauer Properties. Upon UDC and DPR approval, the contractor intends to charge forward with construction.

Proposed Streetscape Plans for:

WEST BROAD STREET, RICHMOND, VIRGINIA

2000–2220 WEST BROAD STREET · CITY OF RICHMOND · VIRGINIA

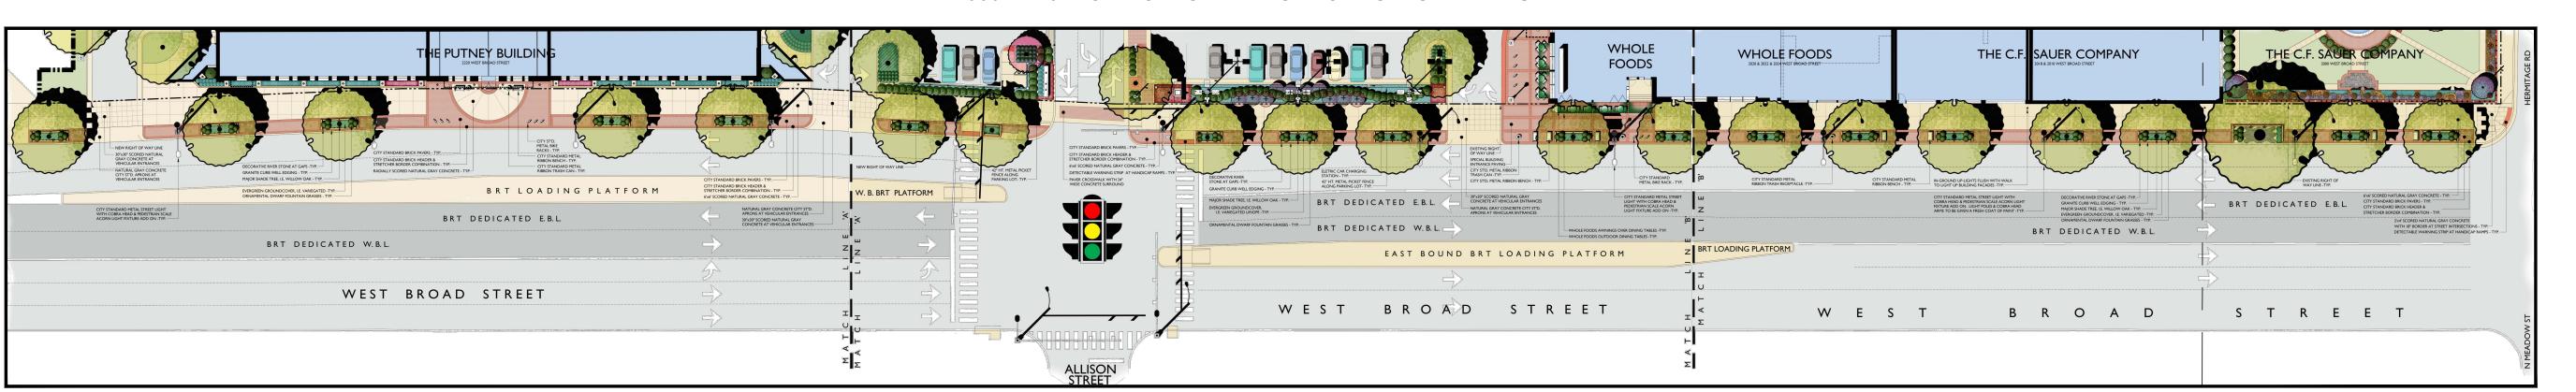


Abbreviations:

EXISTING

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BV.	ABOVE	EXP.	EXPANSION	P.O.B.	POINT OF BEGINNING
LUM.	ALUMINUM	E.J.	EXPANSION JOINT	PTD	PAINTED
PPROX.	APPROXIMATE	FT	FEET OR FOOT	PWD	PLYWOOD
SPH.	ASPHALT	FF	FINISH FLOOR	PVC	POLYVINYL CHLORIDE
D.	BOARD	FIN	FINISH (ED)	PSF	POUNDS PER SQUARE FOOT
EL.	BELOW	FTG	FOOTING	PSI	POUNDS PER SQUARE INCH
ITUM.	BITUMINOUS	F.O.C.	FACE OF CURB	P.I.P.C.	POURED IN PLACE CONCRETE
LDG.	BUILDING	GA	GAUGE	P.C.C.	PRECAST CONCRETE
.O.C.	BACK OF CURB	GALV.	GALVANIZED	PT	PRESSURE TREATED
RK.	BRICK	GC	GENERAL CONTRACTOR	PVMT.	PAVEMENT
S	BOTTOM OF STEP	HT	HEIGHT	RAD	RADIUS
/T	BETWEEN	HP	HIGH POINT	RCP	REINFORCED CONCRETE PIPE
W	BOTTOM OF WALL	HORIZ	HORIZONTAL	REF	REFERENCE
S.B.	CATCH BASIN	HB	HOSE BIB	REINF	REINFORC (ED) (ING)
E.J.	CAULKED EXPANSION JOINT	INCL.	INCLUDE (D) (ING)	RND.	ROUND
F	CUBIC FEET	I.D.	INSIDE DIAMETER	SCH.	SCHEDULE
I.P.C.	CAST IN PLACE CONCRETE	INV	INVERT	SECT.	SECTION
i.l.	CAST IRON	JT	JOINT	SIM	SIMILAR
O	CLEAN OUT	LF	LINEAR FOOT	SD	STORM DRAIN
OL.	COLUMN	LP	LOW POINT	S	SOUTH
ONTR.	CONTRACTOR	MH	MANHOLE	SFCMU	SPLIT FACE CONC. MASONRY UN
5.J.	CONTROL JOINT	MFR.	MANUFACTURE (R)	SPEC.	SPECIFICATION (S)
LR.	CLEAR	MAS	MASONRY	SQ.	SQUARE
ONC.	CONCRETE	MTL	METAL	S.S.	STAINLESS STEEL
MU	CONC. MASONRY UNIT	MAX	MAXIMUM	STD.	STANDARD
ONSTR.	CONSTRUCTION	MED	MEDIUM	ST	STEEL
ONT.	CONTINUOUS	MTL	METAL	THK	THICK
TR.	CENTER	MIN	MINIMUM	T&G	TONGUE AND GROOVE
Υ	CUBIC YARD	MISC	MISCELLANEOUS	TC	TOP OF CURB
ET	DETAIL	NO.	NUMBER	TS	TOP OF STEP
lΑ	DIAMETER	NOM	NOMINAL	T.O.W.	TOP OF WALL
IM	DIMENSION	N	NORTH	TYP.	TYPICAL
WG	DRAWING	N.I.C.	NOT IN CONTRACT	U.O.N.	UNLESS OTHERWISE NOTED
A.	EACH	N.T.S.	NOT TO SCALE	V.I.F.	VERIFY IN FIELD
/P	EDGE OF PAVEMENT	O/C	ON CENTER	VERT.	VERTICAL
LEC	ELECTRICAL	O.D.	OUTSIDE DIAMETER	W/	WITH
L	ELEVATION	OA	OVERALL	W/O	WITHOUT
Q.	EQUAL	OPP	OPPOSITE	WD.	WOOD


Symbol Legend:

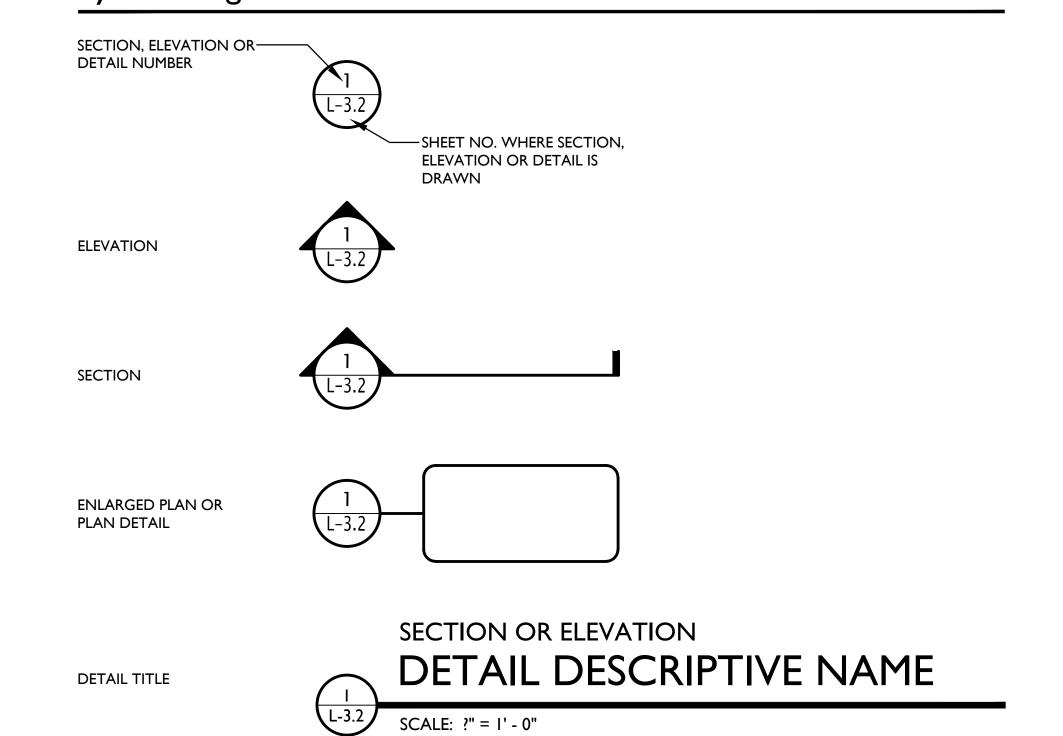

Drawing Index:

OVERALL STREETSCAPE KEY PLAN, ABBREVIATIONS, LEGEND, AND DRAWING INDEX
HARDSCAPE & PLANTING PLAN: THE PUTNEY BLDG & LEE'S CHICKEN
HARDSCAPE & PLANTING PLAN: WHOLE FOODS & THE C.F. SAUER COMPANY
OVERALL IRRIGATION KEY PLAN
IRRIGATION PLAN: THE PUTNEY BLDG & LEE'S CHICKEN
IRRIGATION PLAN: WHOLE FOODS & THE C.F. SAUER COMPANY
PLANTING DETAILS & SCHEDULE

HARDSCAPE & SITE FURNISHINGS DETAILS
HARDSCAPE & IN-GROUND UP-LIGHT DETAILS
ATYPICAL TREEWELL HARDSCAPE DETAILS

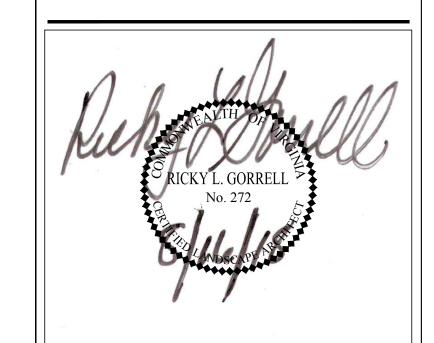

5701 grove avenue

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THE SAUER CENTER ****

West Broad Street Streetscape

2220-2014 West Broad Street Richmond, Virginia

REVISION	S
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No. Description


Sheet Number

GRAPHIC SCALE: 1"=40'

OVERALL SHEET

KEY PLAN

Designed By:	RLG
Drawn By:	RLG
Checked By:	RLG
Date:	08.16.2018
Project Number:	M15026

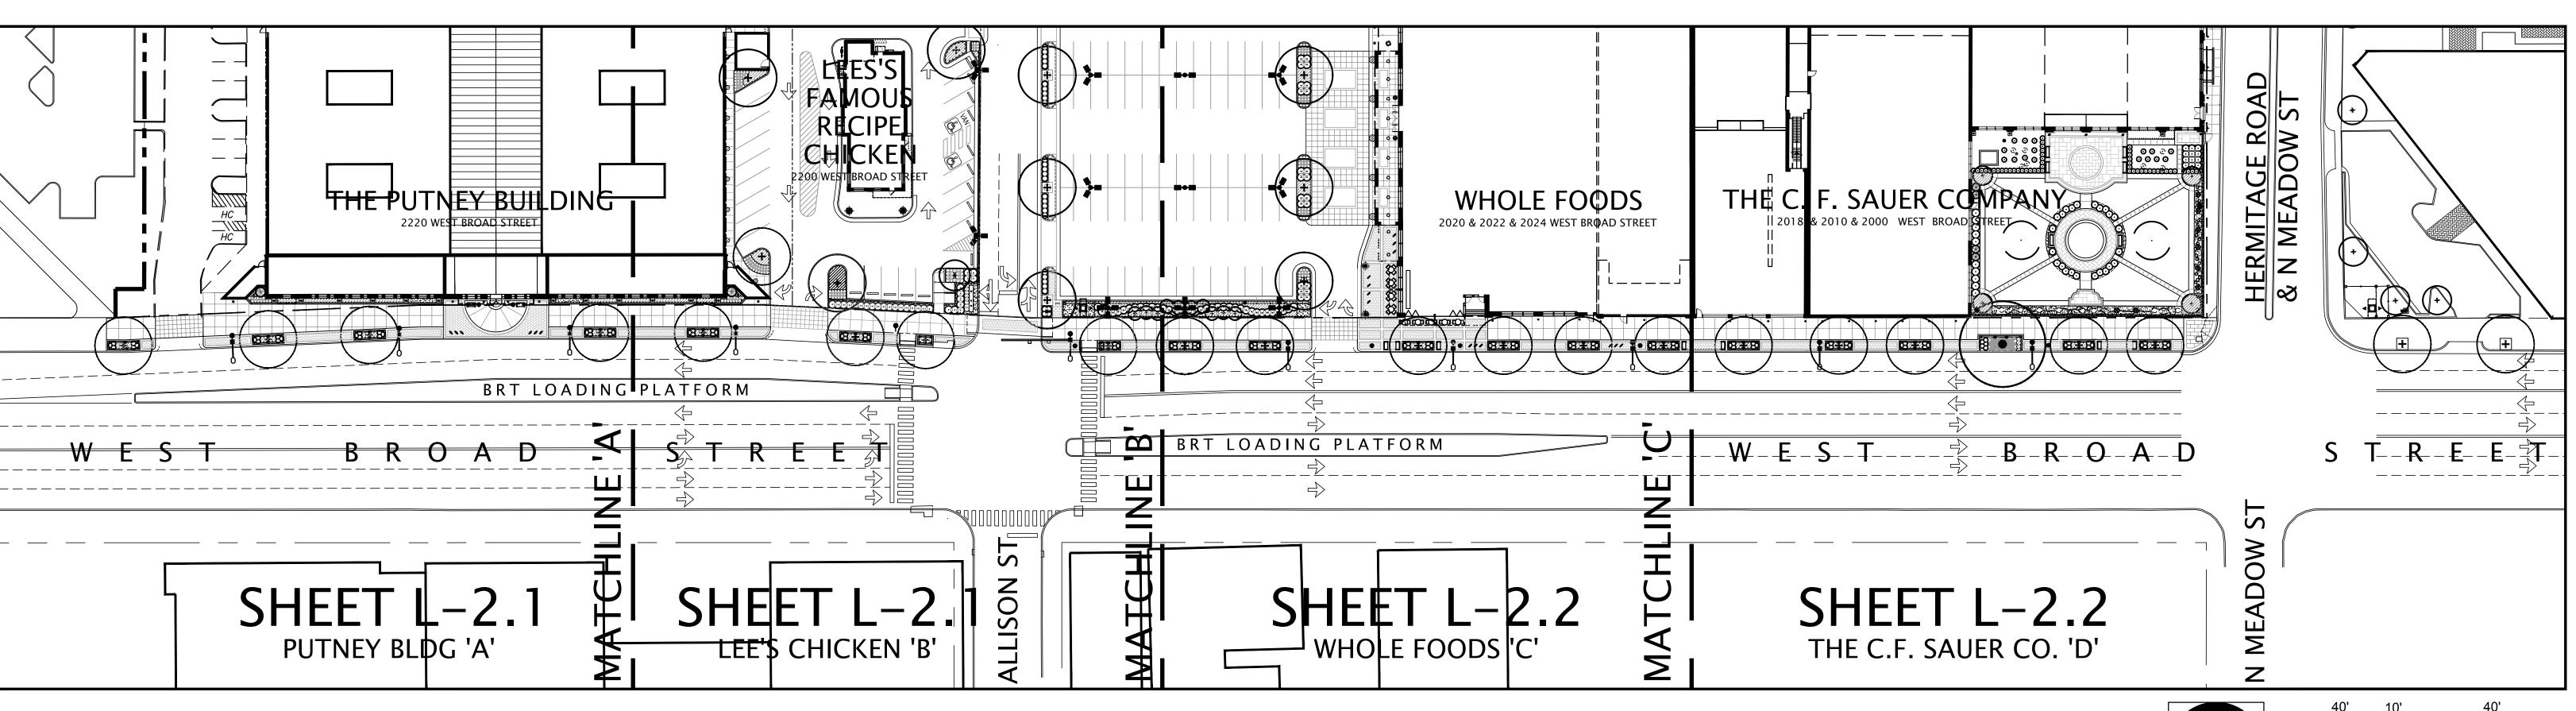


PLAN VIEW


THE SAUER CENTER OVERALL STREETSCAPE KEY PLAN

WELDED WIRE FABRIC

2000–2200 WEST BROAD STREET · CITY OF RICHMOND · VIRGINIA · SCALE: 1"=40'



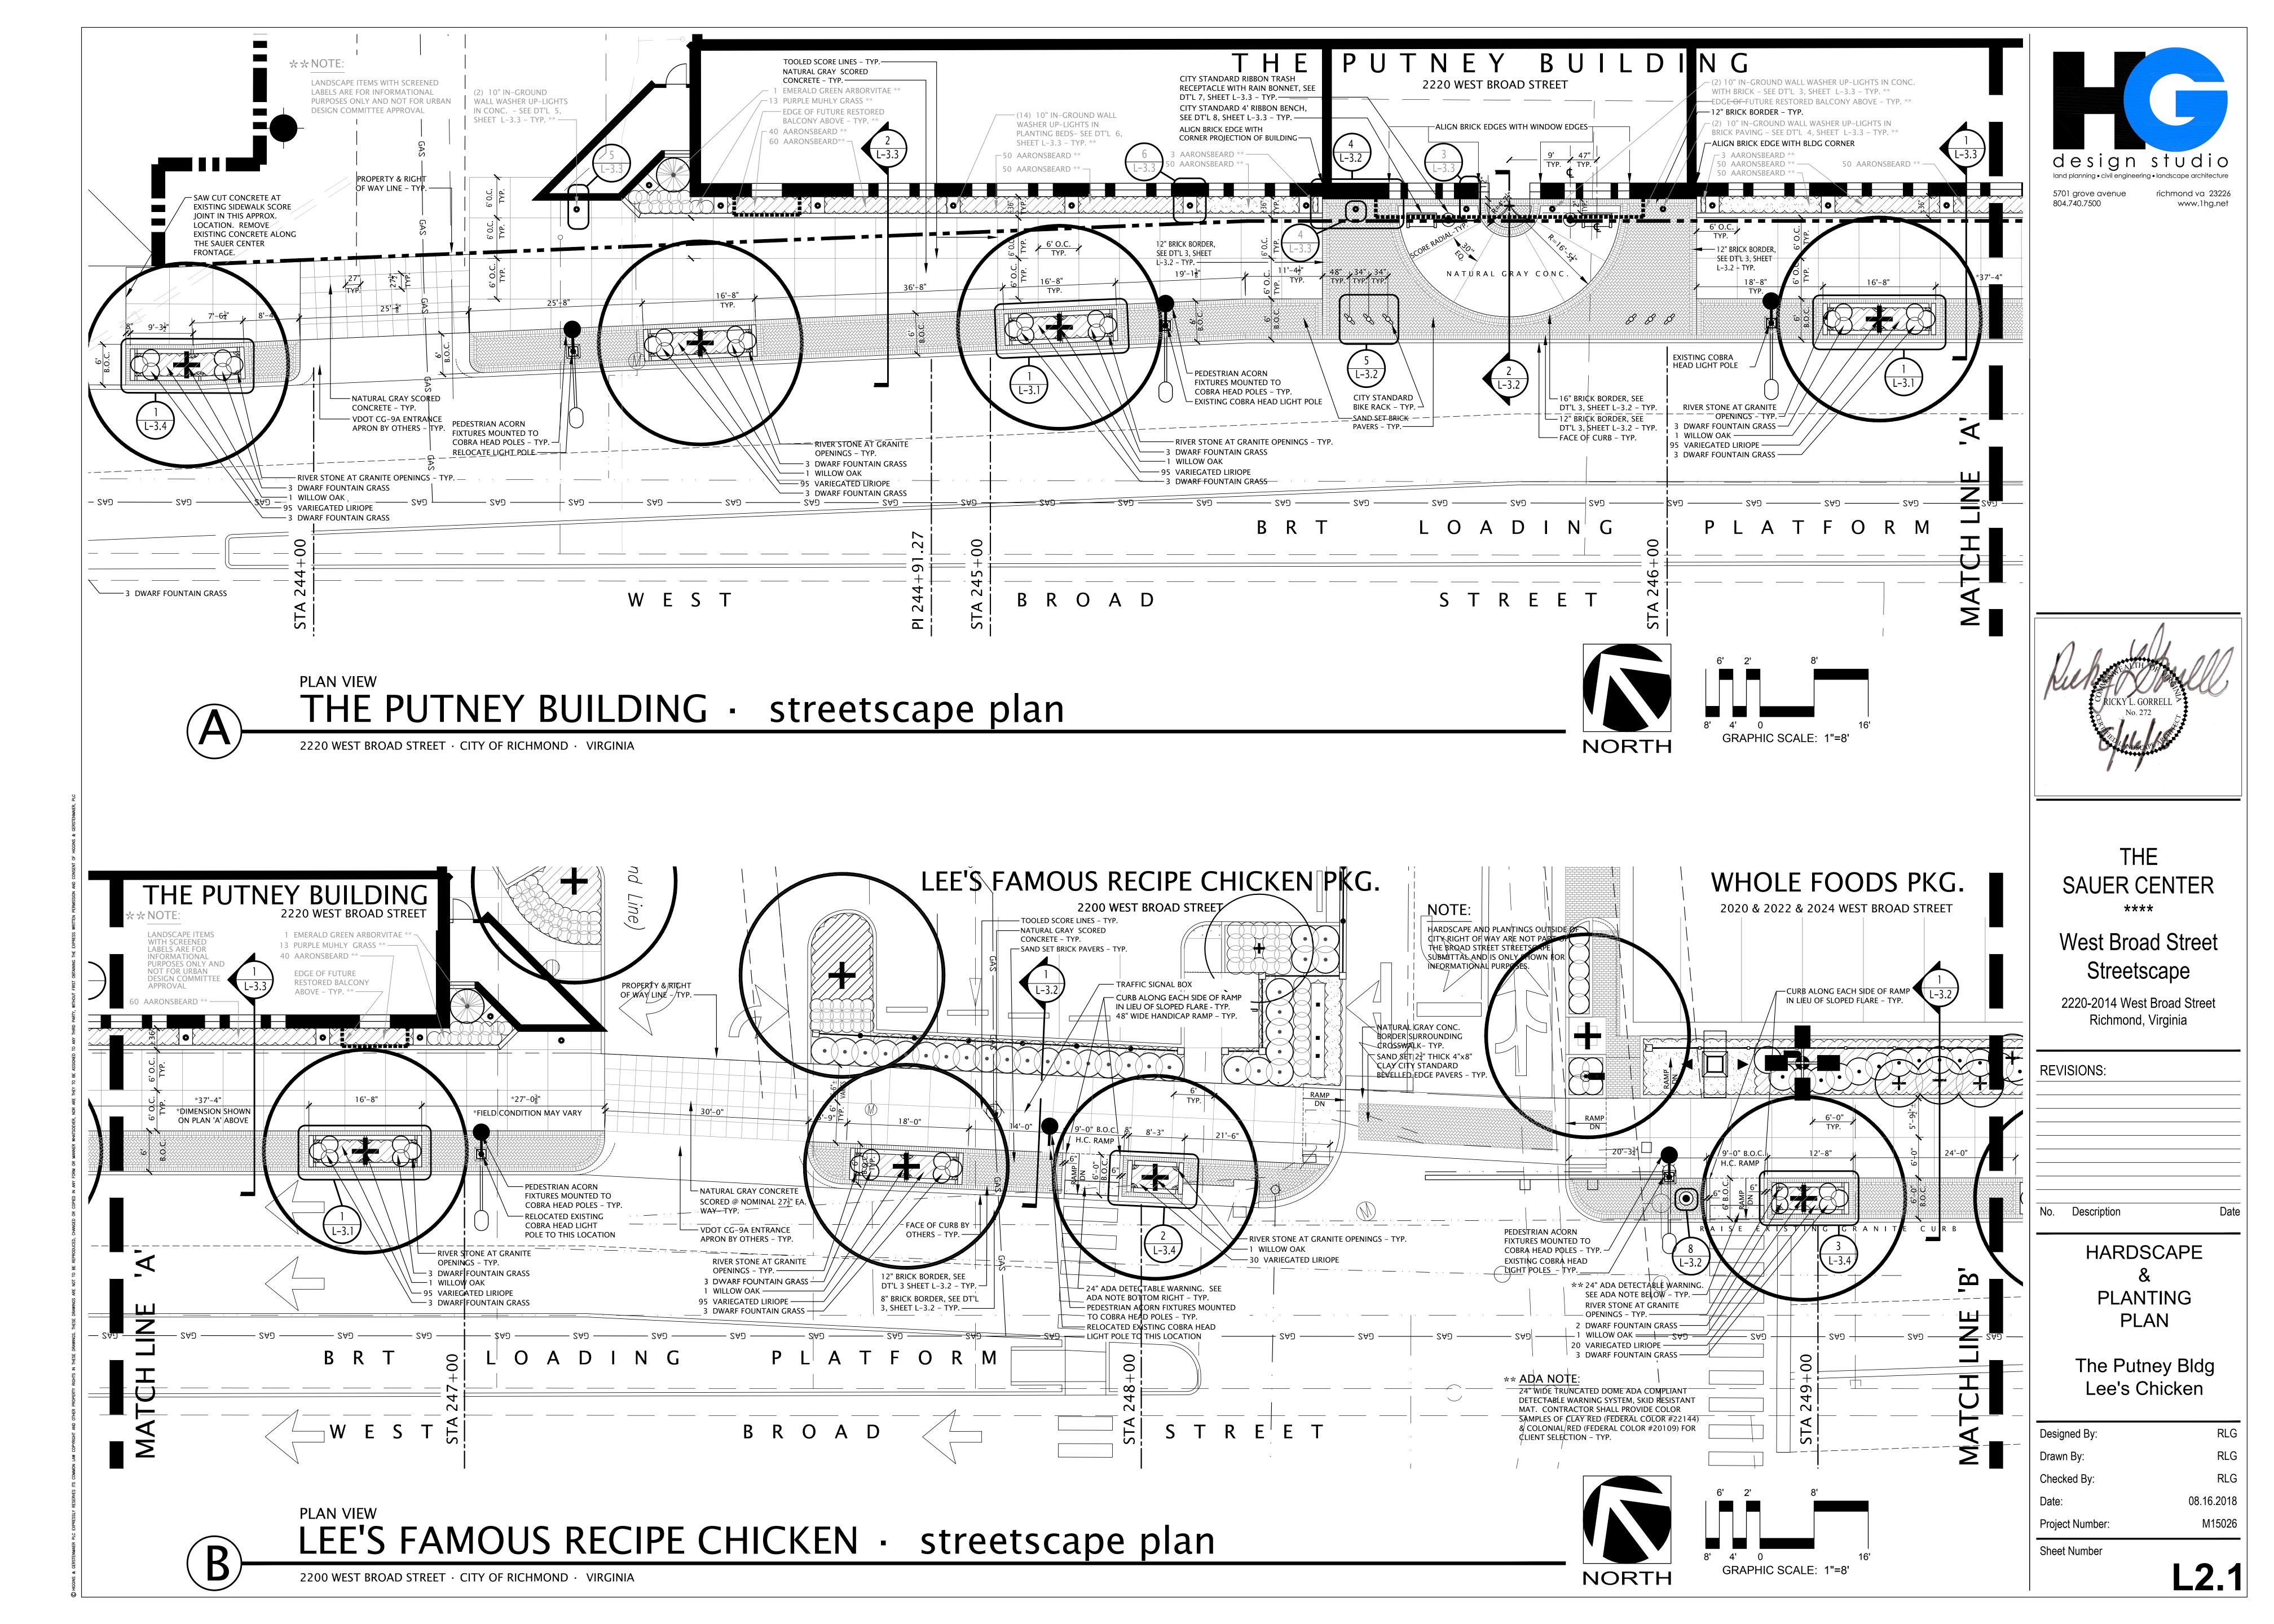

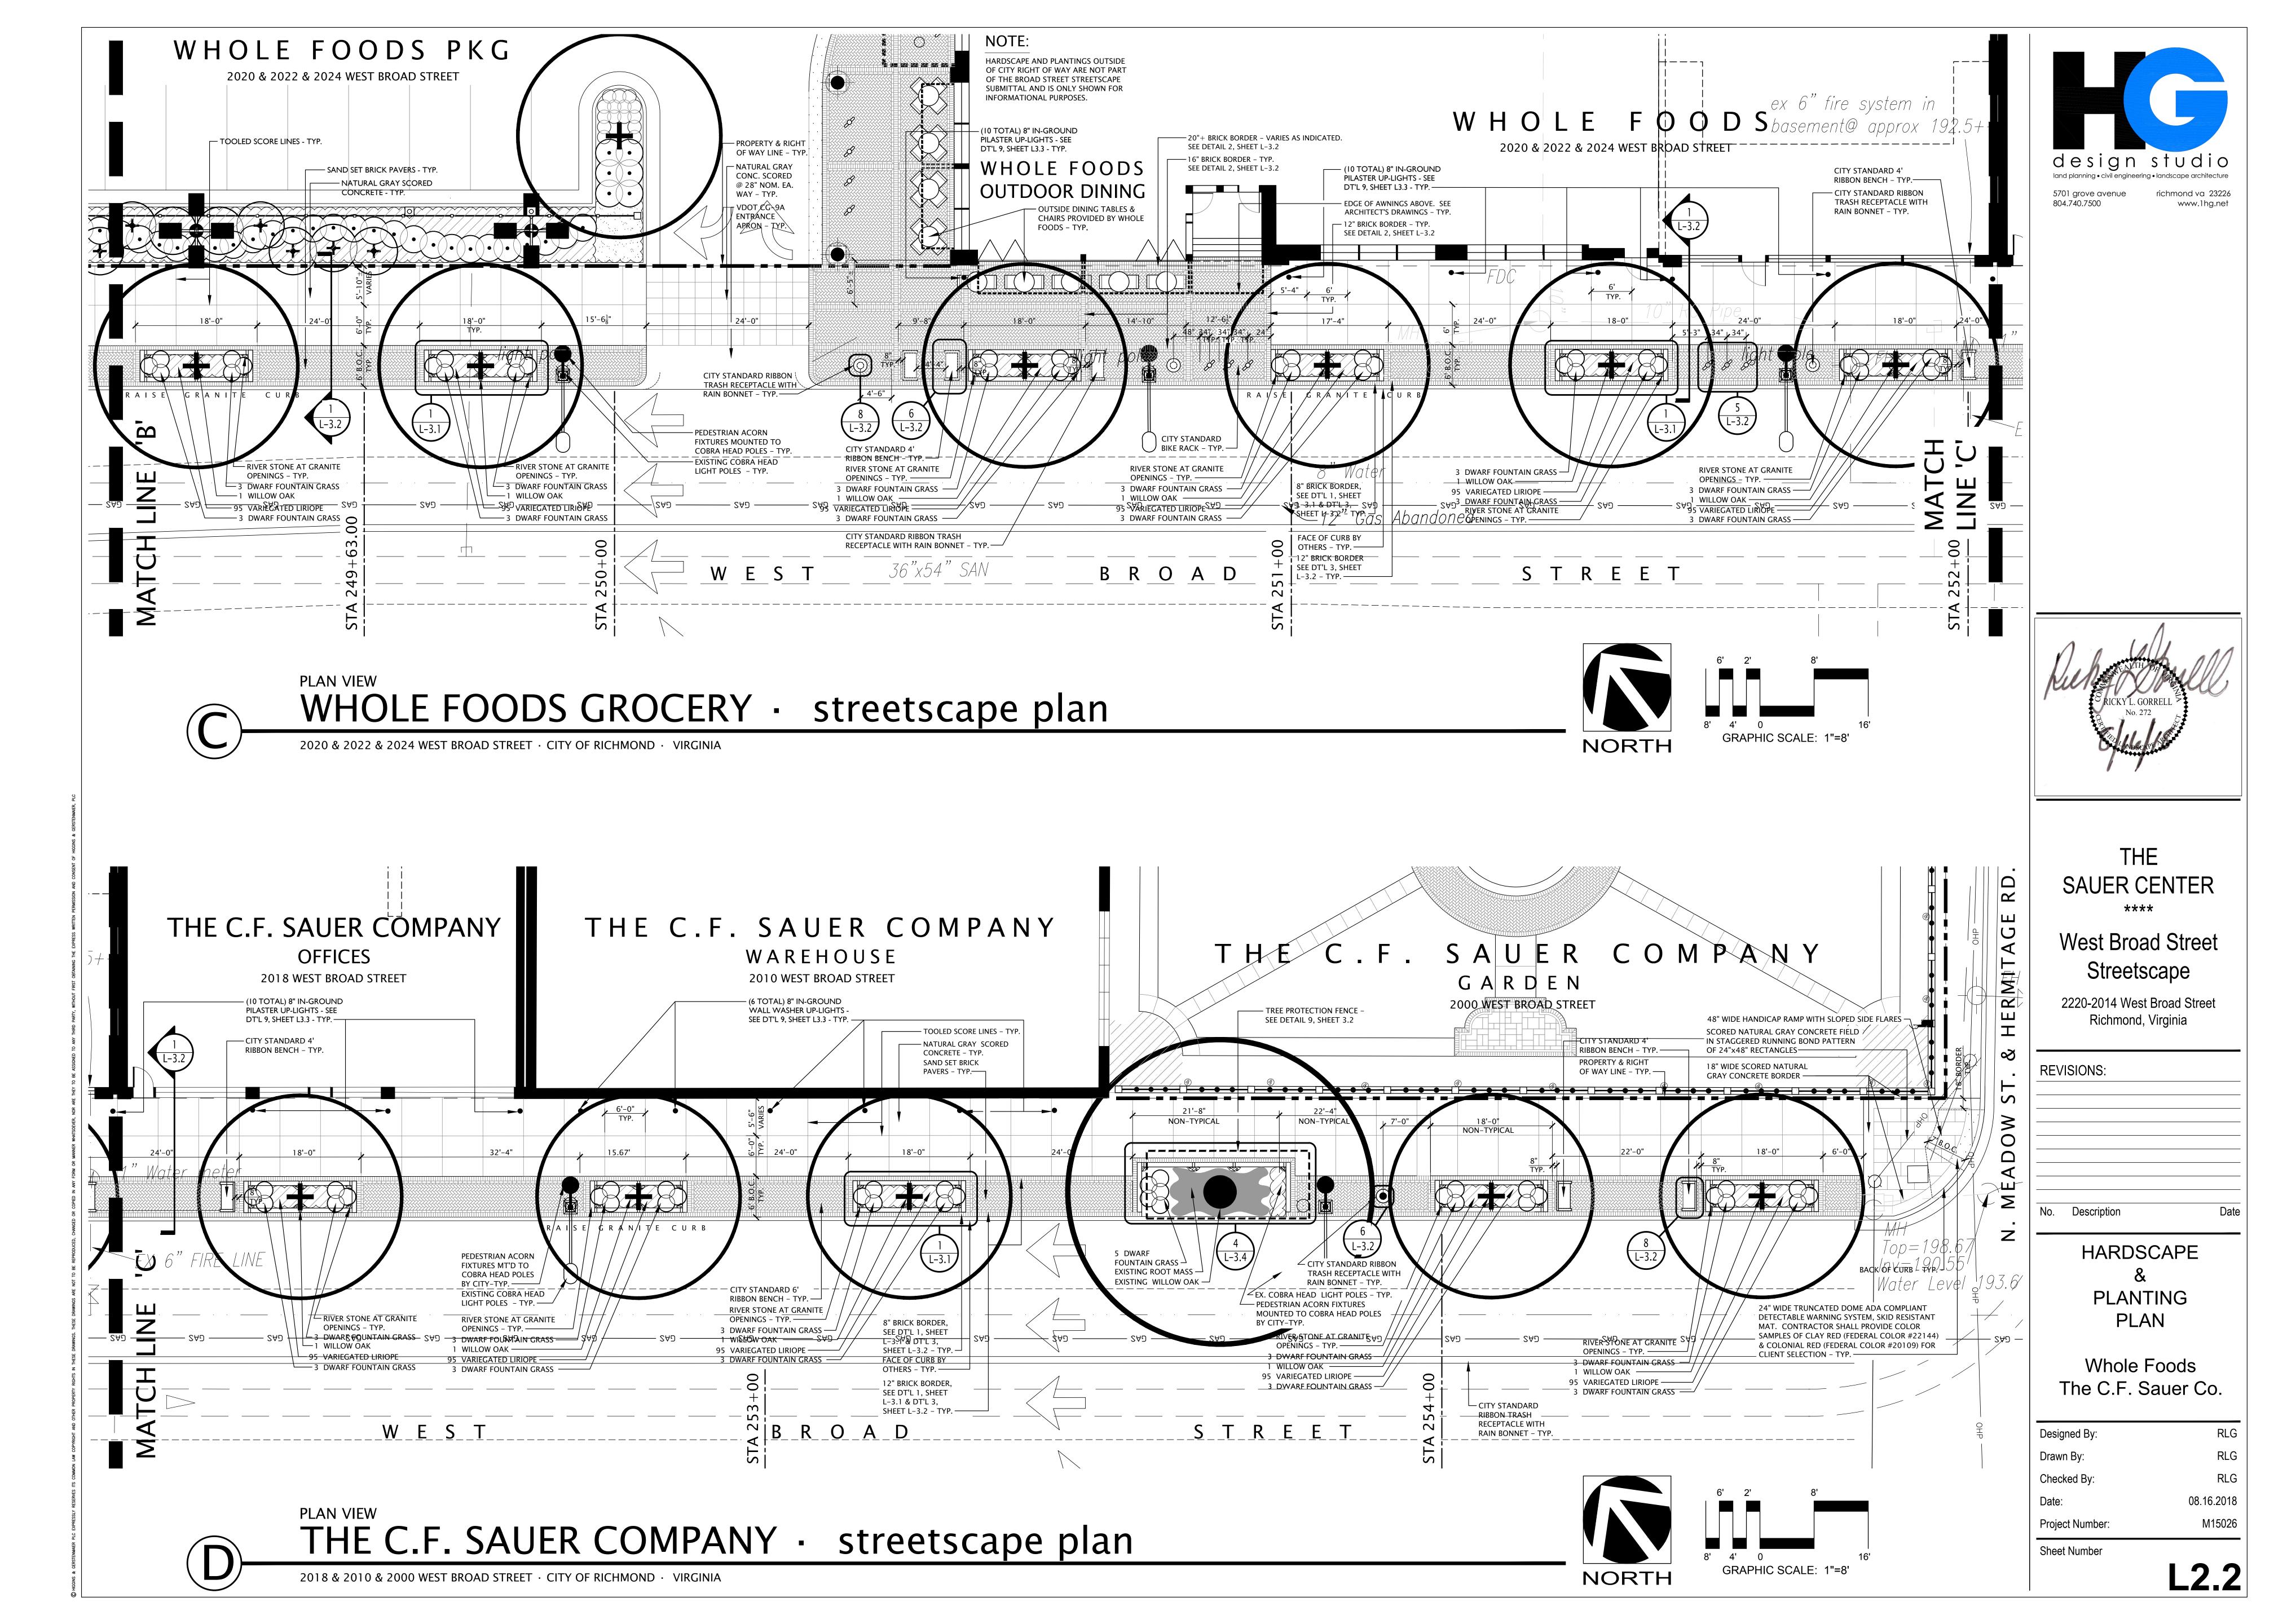

IRRIGATION NOTES & LEGEND

HEADS

- TORO SERIES 570Z-12HP 12" HIGH POP SPRINKLER HEAD FITTED WITH FIXED SPRAY 570 SERIES 12' SERIES (MAXIMUM 13' RADIUS) PRECISION SPRAY NOZZLE.
- RADIUS) PRECISION SPRAY NOZZLE.

 TORO SERIES 570Z-12HP 12" HIGH POP SPRINKLER HEAD FITTED WITH FIXED SPRAY 570 SERIES 15' SERIES (MAXIMUM 16' RADIUS) PRECISION SPRAY NOZZLE.
- TORO SERIES 570Z-12HP 12" HIGH POP SPRINKLER HEAD FITTED WITH FIXED SPRAY 570 SERIES 10' SERIES (MAXIMUM 11' RADIUS) PRECISION SPRAY NOZZLE.
 TORO SERIES 570Z-12HP 12" HIGH POP SPRINKLER HEAD
- TORO SERIES 570Z-12HP 12" HIGH POP SPRINKLER HEAD
 FITTED WITH FIXED SPRAY 570 SERIES 8' SERIES (MAXIMUM 9'
- RADIUS) PRECISION SPRAY NOZZLE.

 TORO SERIES 570Z-12HP HIGH POP UP SPRINKLER WITH 12"
 POP UP STROKE AND FITTED WITH FIXED SPRAY 570 SERIES SPECIAL
 PATTERN (4'X 15' RECTANGULAR END MOUNT STRIP) PRECISION SPRAY
 NOZZLE.
- TORO SERIES 570Z-12HP HIGH POP UP SPRINKLER WITH 12"
 POP UP STROKE AND FITTED WITH FIXED SPRAY 570 SERIES SPECIAL
 PATTERN (4'X 30' RECTANGULAR SIDE MOUNT STRIP) PRECISION SPRAY
 FR. NO77LE
- FB NOZZLE.

 TORO SERIES 570Z-12HP HIGH POP UP SPRINKLER WITH 12"
 POP UP STROKE AND FITTED WITH FIXED SPRAY 570 SERIES FLOOD
- BUBBLER (FB50PC).

 TORO SERIES 570Z-6P POP UP 6" POP UP SPRINKLER HEAD
- FITTED WITH FIXED SPRAY 570 SERIES SPECIAL PATTERN (4'X 30' RECTANGULAR SIDE MOUNT STRIP) PRECISION SPRAY NOZZLE.

 TORO SERIES 570Z-6P POP UP 6" POP UP SPRINKLER HEAD
- FITTED WITH FIXED SPRAY 570 SERIES SPECIAL PATTERN (4'X 15' RECTANGULAR END MOUNT STRIP) PRECISION SPRAY NOZZLE.

 TORO SERIES 570Z-6P POP UP SPRINKLER WITH 6" POP-UP STROKE AND FITTED WITH FIXED SPRAY 570 SERIES 8' SERIES
- (MAXIMUM 9' RADIUS) PRECISION SPRAY NOZZLE.

 TORO SERIES 570Z-6P POP UP SPRINKLER WITH 6" POP-UP STROKE AND FITTED WITH FIXED SPRAY 570 SERIES 12' SERIES
- (MAXIMUM 13' RADIUS) PRECISION SPRAY NOZZLE.

 TORO SERIES 570Z-6P POP UP SPRINKLER WITH 6" POP-UP STROKE AND FITTED WITH FIXED SPRAY 570 SERIES 15' SERIES

 (MAXIMUM 16' RADIUS) PRECISION SPRAY NOZZI E
- (MAXIMUM 16' RADIUS) PRECISION SPRAY NOZZLE.

 RAINBIRD ROOT WATERING SYSTEM W/ CHECK VALVE, .25 GPM (RWS-M-B-C-1401)

PIPE

——— – DENOTES ROUTE OF PR 200 PVC LATERAL PIPING.

LATERAL PIPE SIZING SCHEDULE

- ZERO TO FIFTEEN GPM ACCUMULATED FLOW USE 1" PR 200 PVC PIPE

- GREATER THAN FIFTEEN UP TO THIRTY-FIVE GPM USE 1.5" PR 200 PVC PIPE

---- DENOTES ROUTE OF 1.5" PR 200 MAIN LINE PIPING.

VALVES

- LOCATION OF ELECTRIC 24 V.A.C. REMOTE CONTROL VALVE WITH FLOW CONTROL FEATURE, TORO TPV.
- LOCATION OF LINE SIZED ISOLATION VALVE.

CONTROLLERS

 LOCATION OF THE IRRIGATION CONTROLLERS. THE CONTROLLERS SHALL BE TORO CUSTOM COMMAND SERIES SOLID STATE UNITS WHICH SHALL BE OF THE WALL MOUNT STYLE. THE CONTROLLERS SHALL BE AS LISTED:

A. CC-M36 B. CC-M12 C. CC-M12 D. CC-M12

- THE CONTROLLERS SHALL BE MOUNTED IN THE APPROXIMATE LOCATIONS SHOWN ON THE PLAN.

- ALL ELECTRICAL CONNECTIONS AND INSTALLATIONS SHALL BE PERFORMED IN ACCORDANCE WITH LOCAL CODE REQUIREMENTS. ALL 120 VAC WIRING SHALL BE INSTALLED IN ACCORDANCE WITH ALL APPLICABLE ELECTRICAL CODE REQUIREMENTS.

- THE OWNER SHALL BE RESPONSIBLE FOR PROVIDING A 120 VAC POWER CIRCUIT AT THE CONTROLLER LOCATION. THE POWER SOURCE SHALL BE CAPABLE OF SUPPORTING A 10 AMPERE LOAD AT 120 VAC.

SENSORS

P - DENOTES THE LOCATION OF WIRELESS RAIN SENSOR.

BACKFLOW PREVENTION

- DENOTES THE LOCATION OF REDUCED PRESSURE BACKFLOW PREVENTER ASSEMBLY WHICH SHALL BE THE RESPONSIBILITY OF THE IRRIGATION CONTRACTOR. THE BFP FOR SYSTEM "A" SHALL BE 1" IN SIZE. THE BFP FOR SYSTEMS "B,C,& D" SHALL BE 3/4" IN SIZE.

WATER SUPPLY

- DENOTES THE LOCATION OF THE PROPOSED IRRIGATION METER. THE METER SHALL BE THE OWNER'S RESPONSIBILITY. THE METER FOR SYSTEM "A" SHALL BE 1" IN SIZE. THE METERS FOR ALL OTHER SYSTEMS SHALL BE 5/8" IN SIZE.

- IRRIGATION SYSTEM "A" SHALL BE CAPABLE OF DELIVERING 30 GPM
AT 70 PSI MAXIMUM WITH ONE STATION OPERATING WITH 40 PSI AT THE
BASE OF THE HEAD FOR OPTIMUM PERFORMANCE OF THE IRRIGATION SYSTEM
AS DESIGNED AND SPECIFIED.
- ALL OTHER IRRIGATION SYSTEMS SHALL BE CAPABLE OF DELIVERING 15 GPM
AT 70 PSI MAXIMUM WITH ONE STATION OPERATING WITH 40 PSI AT THE
BASE OF THE HEAD FOR OPTIMUM PERFORMANCE OF THE IRRIGATION SYSTEM
AS DESIGNED AND SPECIFIED.

NOTE: IF THE WATER SUPPLY IS NOT CAPABLE OF THE DESIGNED CAPACITY (FLOW AND/OR PRESSURE), THE IRRIGATION SYSTEM WILL NEED TO BE REDESIGNED, WHICH MAY ALTER THE IRRIGATION MATERIAL ESTIMATE.

SLEEVING

DENOTES LOCATION OF PVC SLEEVES FOR IRRIGATION PIPING.
 SIZE AS LABELED.

- WHERE WIRE RUNS OCCUR, A SEPARATE 2" PVC ELECTRICAL CONDUIT SLEEVE SHALL BE USED FOR 24 VAC WIRING PER ELECTRICAL CODE.

- WHERE IRRIGATION PIPING CROSSES SIDEWALKS, THE CONTRACTOR SHALL BE RESPONSIBLE FOR PLACING A SLEEVE 2 SIZES LARGER THAN THE PIPE THAT IS CROSSING THROUGH IT.

NOTE: THE IRRIGATION SYSTEMS ARE DISPLAYED SCHEMATIC IN NATURE.
THE IRRIGATION CONTRACTOR MAY BE REQUIRED TO MAKE
MINOR ADJUSTMENTS IN THE FIELD. THESE MINOR ADJUSTMENTS
SHALL BE MADE AT NO ADDITIONAL COST TO THE OWNER BUT
SHALL BE MADE ONLY AFTER NOTIFICATION IS MADE TO THE

THIS DESIGN IS BASED ON THE SITE INFORMATION AND/OR DRAWINGS SUPPLIED BY THE CLIENT OF RECORD WITH DESIGN CRITERIA BEING SET BY THE CLIENT AND/OR PROJECT OWNER (I.E. AREA TO BE IRRIGATED, MANUFACTURER'S EQUIPMENT TO BE EMPLOYED, WATER SOURCE (LOCATION, FLOW & PRESSURE) CAPACITIES, ELECTRICAL POWER AVAILABILITY FOR IRRIGATION SYSTEM USE, ETC.). SMITH TURF & IRRIGATION BEARS NO RESPONSIBILITY OR LIABILITY FOR ANY ERRORS IN DESIGN OR APPLICATION WHICH MIGHT ARISE DUE TO INACCURACIES IN THE ABOVE REFERENCED INFORMATION SUPPLIED TO SMITH TURF & IRRIGATION IN RELATION TO THIS SPECIFIC PROJECT UNLESS OTHERWISE NOTED.

OWNER OR HIS REPRESENTATIVE.



SAUER CENTER

West Broad Street

Streetscape

2220-2014 West Broad Street


Richmond, Virginia


OVERALL

IRRIGATION

REVISIONS:

No. Description

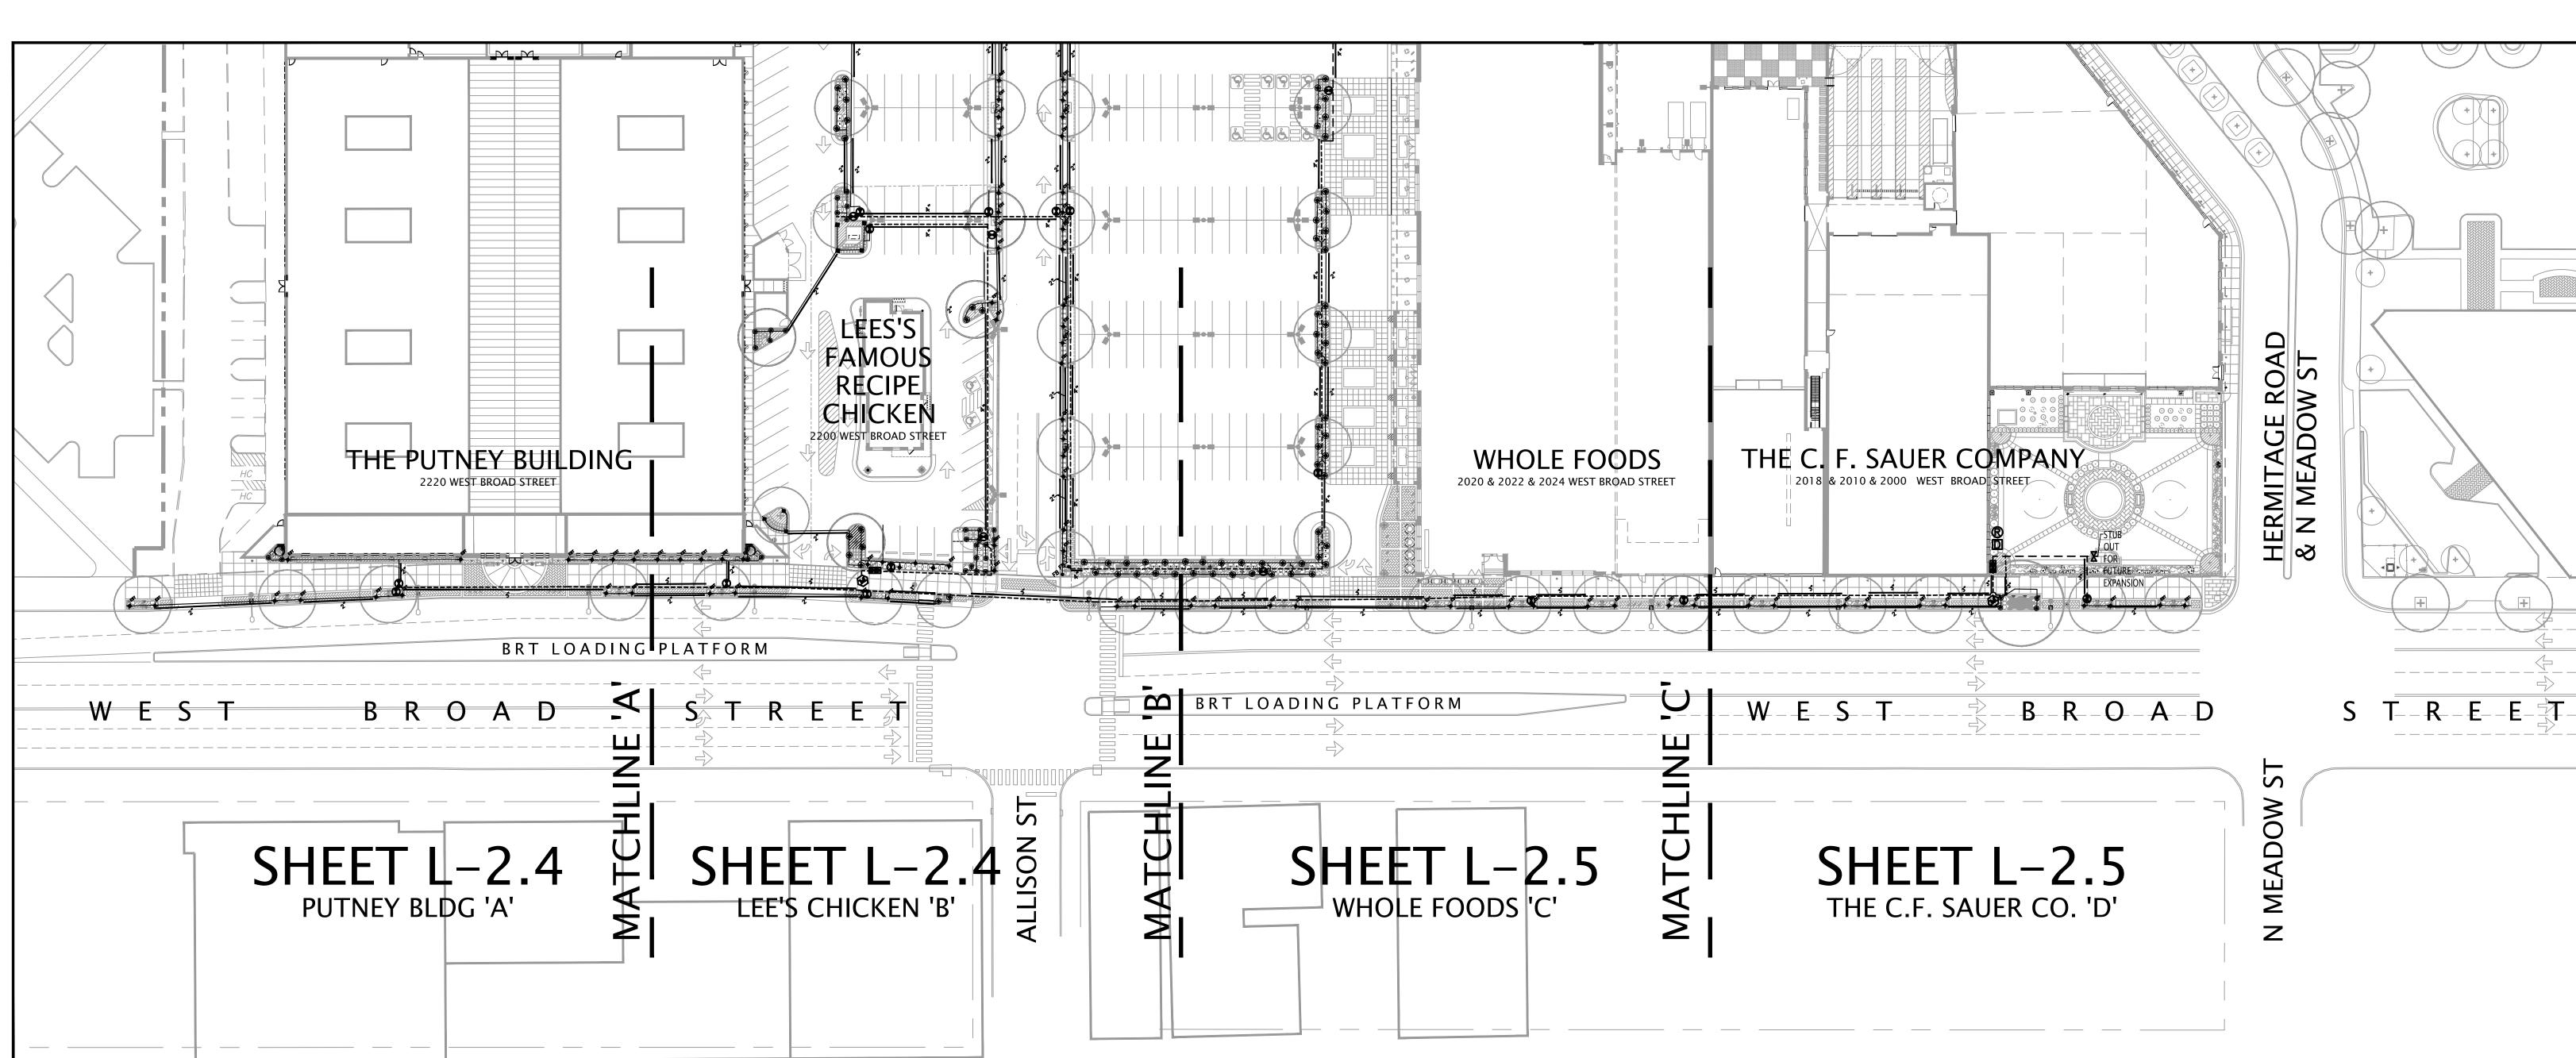

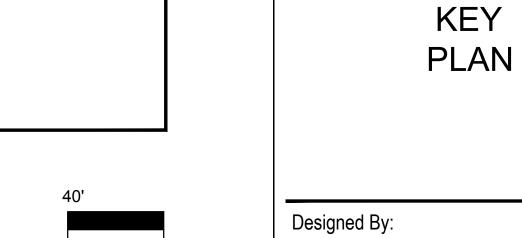

Designed By: RLG

Drawn By: RLG

Checked By: RLG

GRAPHIC SCALE: 1"=40'

Date: 08.16.2018

Project Number: M15026


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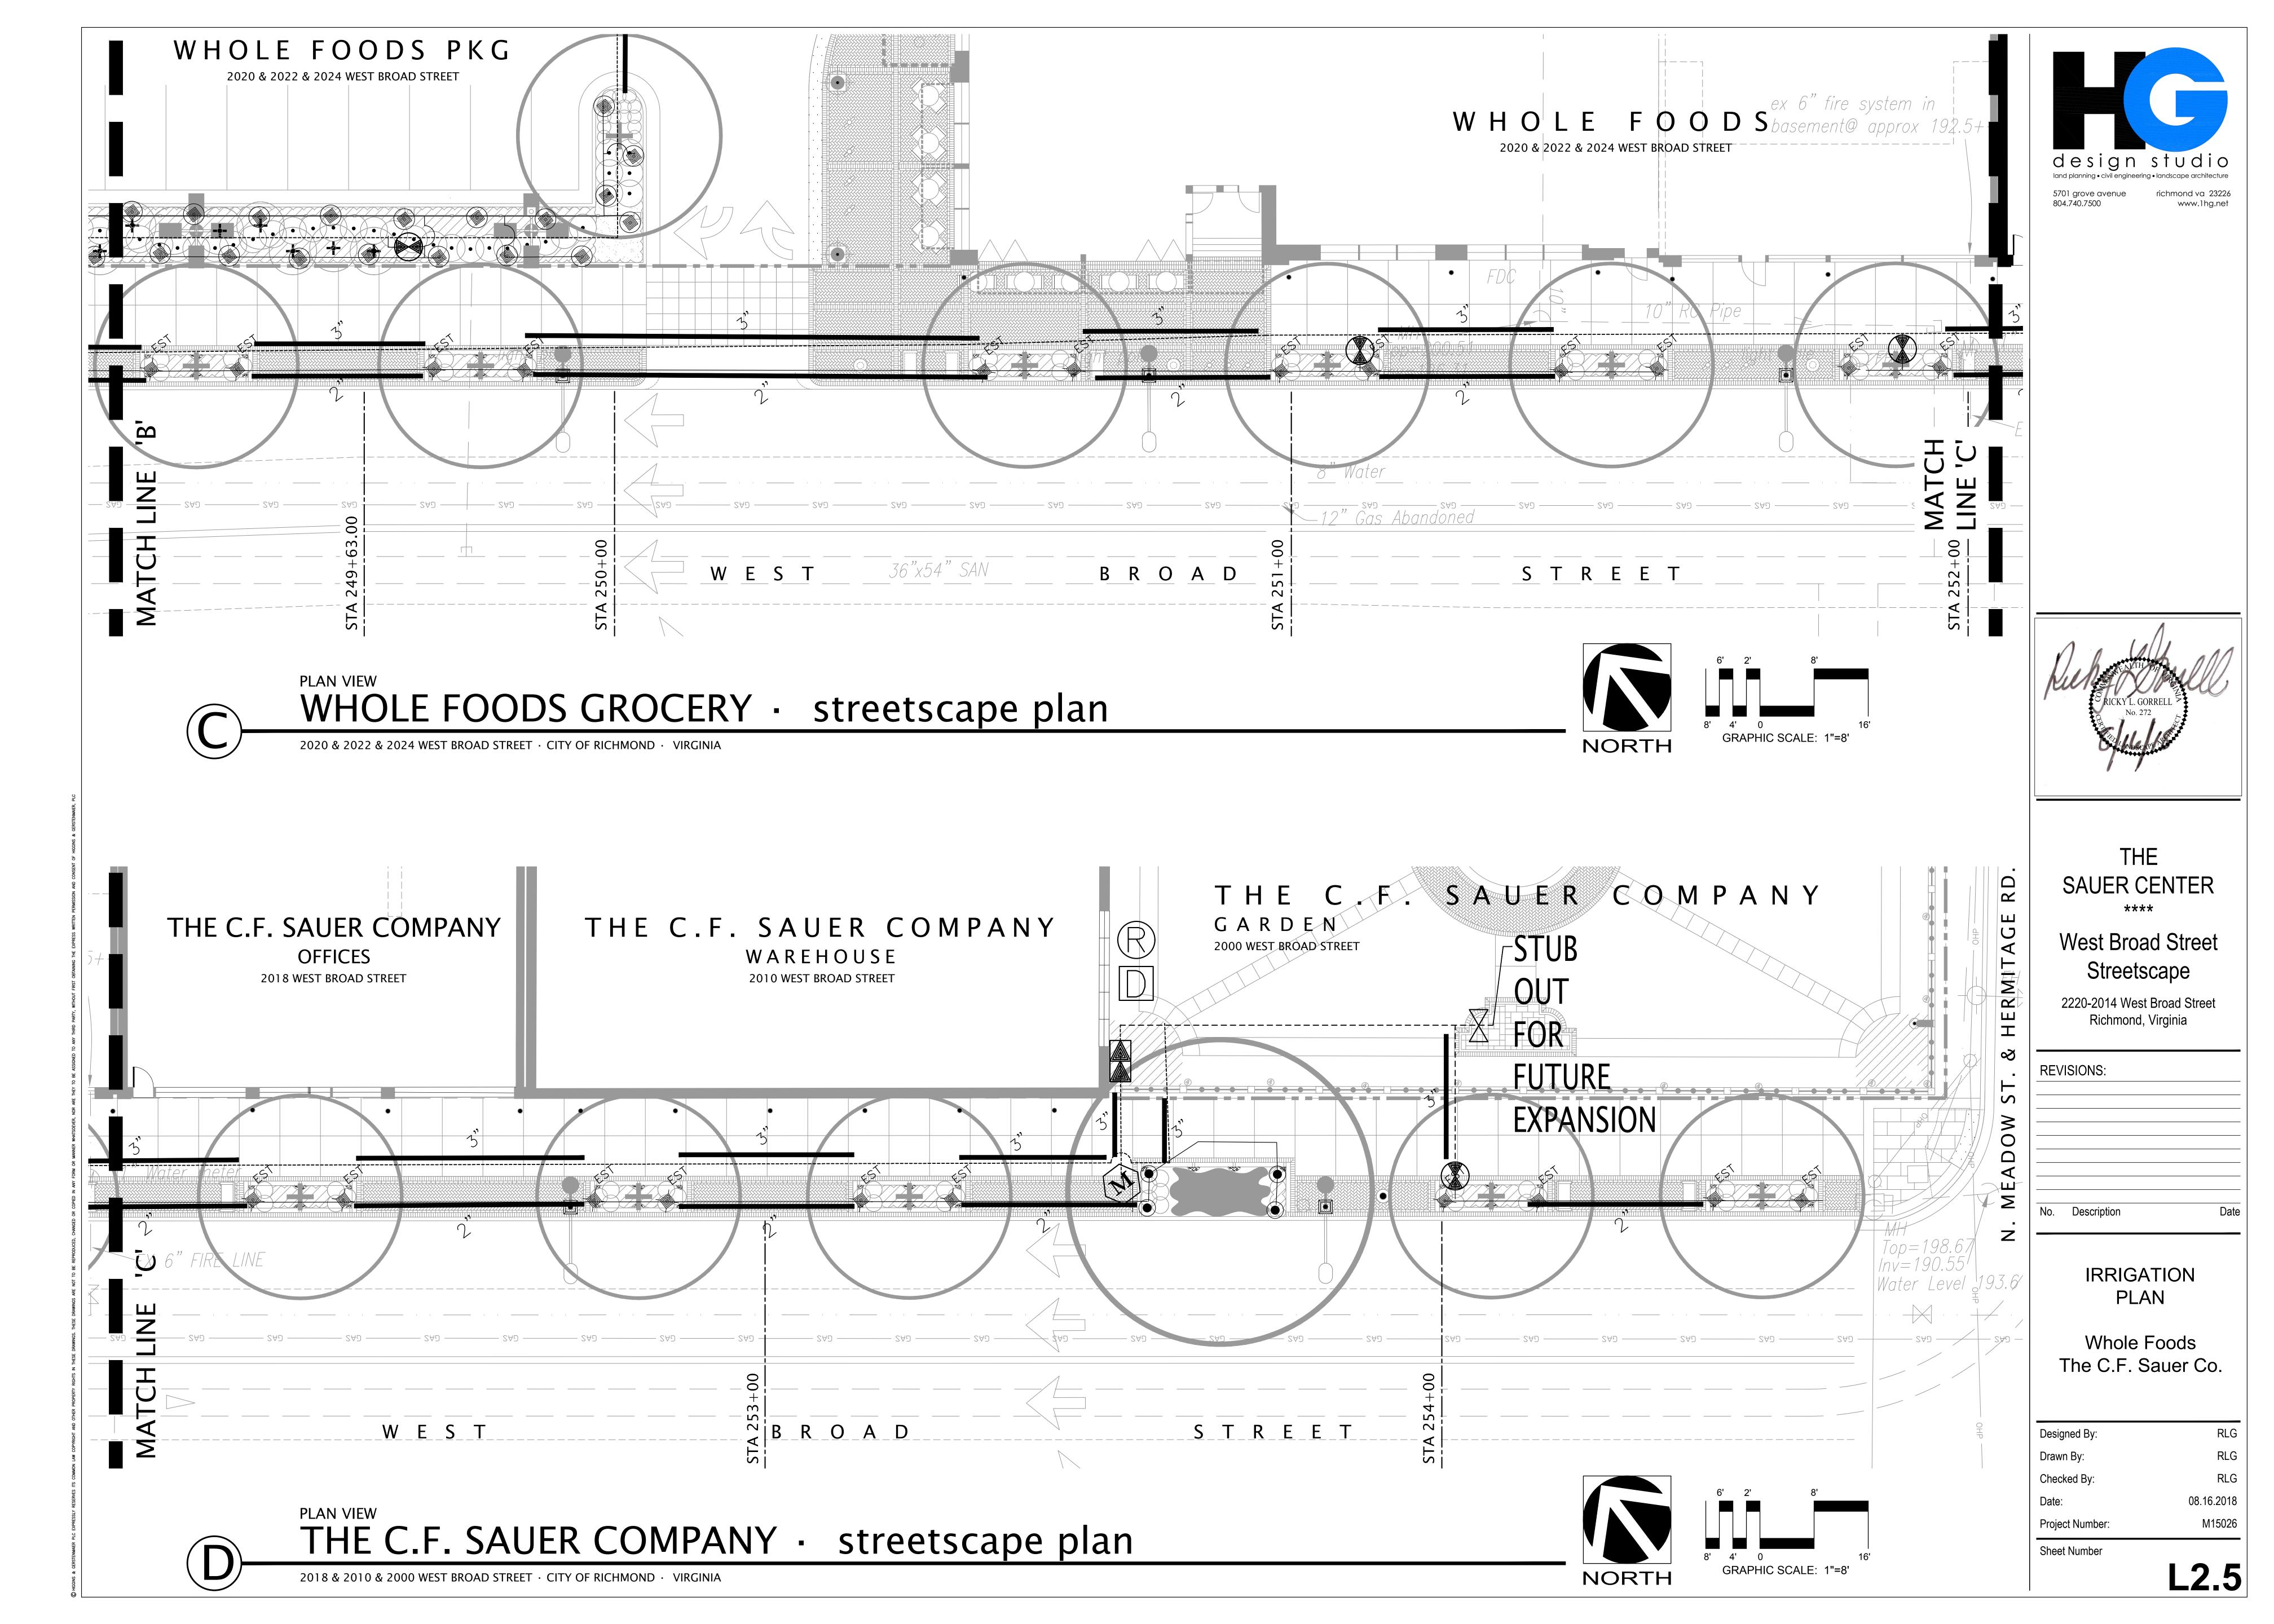
PLAN VIEW


THE SAUER CENTER OVERALL IRRIGATION KEY PLAN

2000–2200 WEST BROAD STREET · CITY OF RICHMOND · VIRGINIA · SCALE: 1"=40'

L2.3



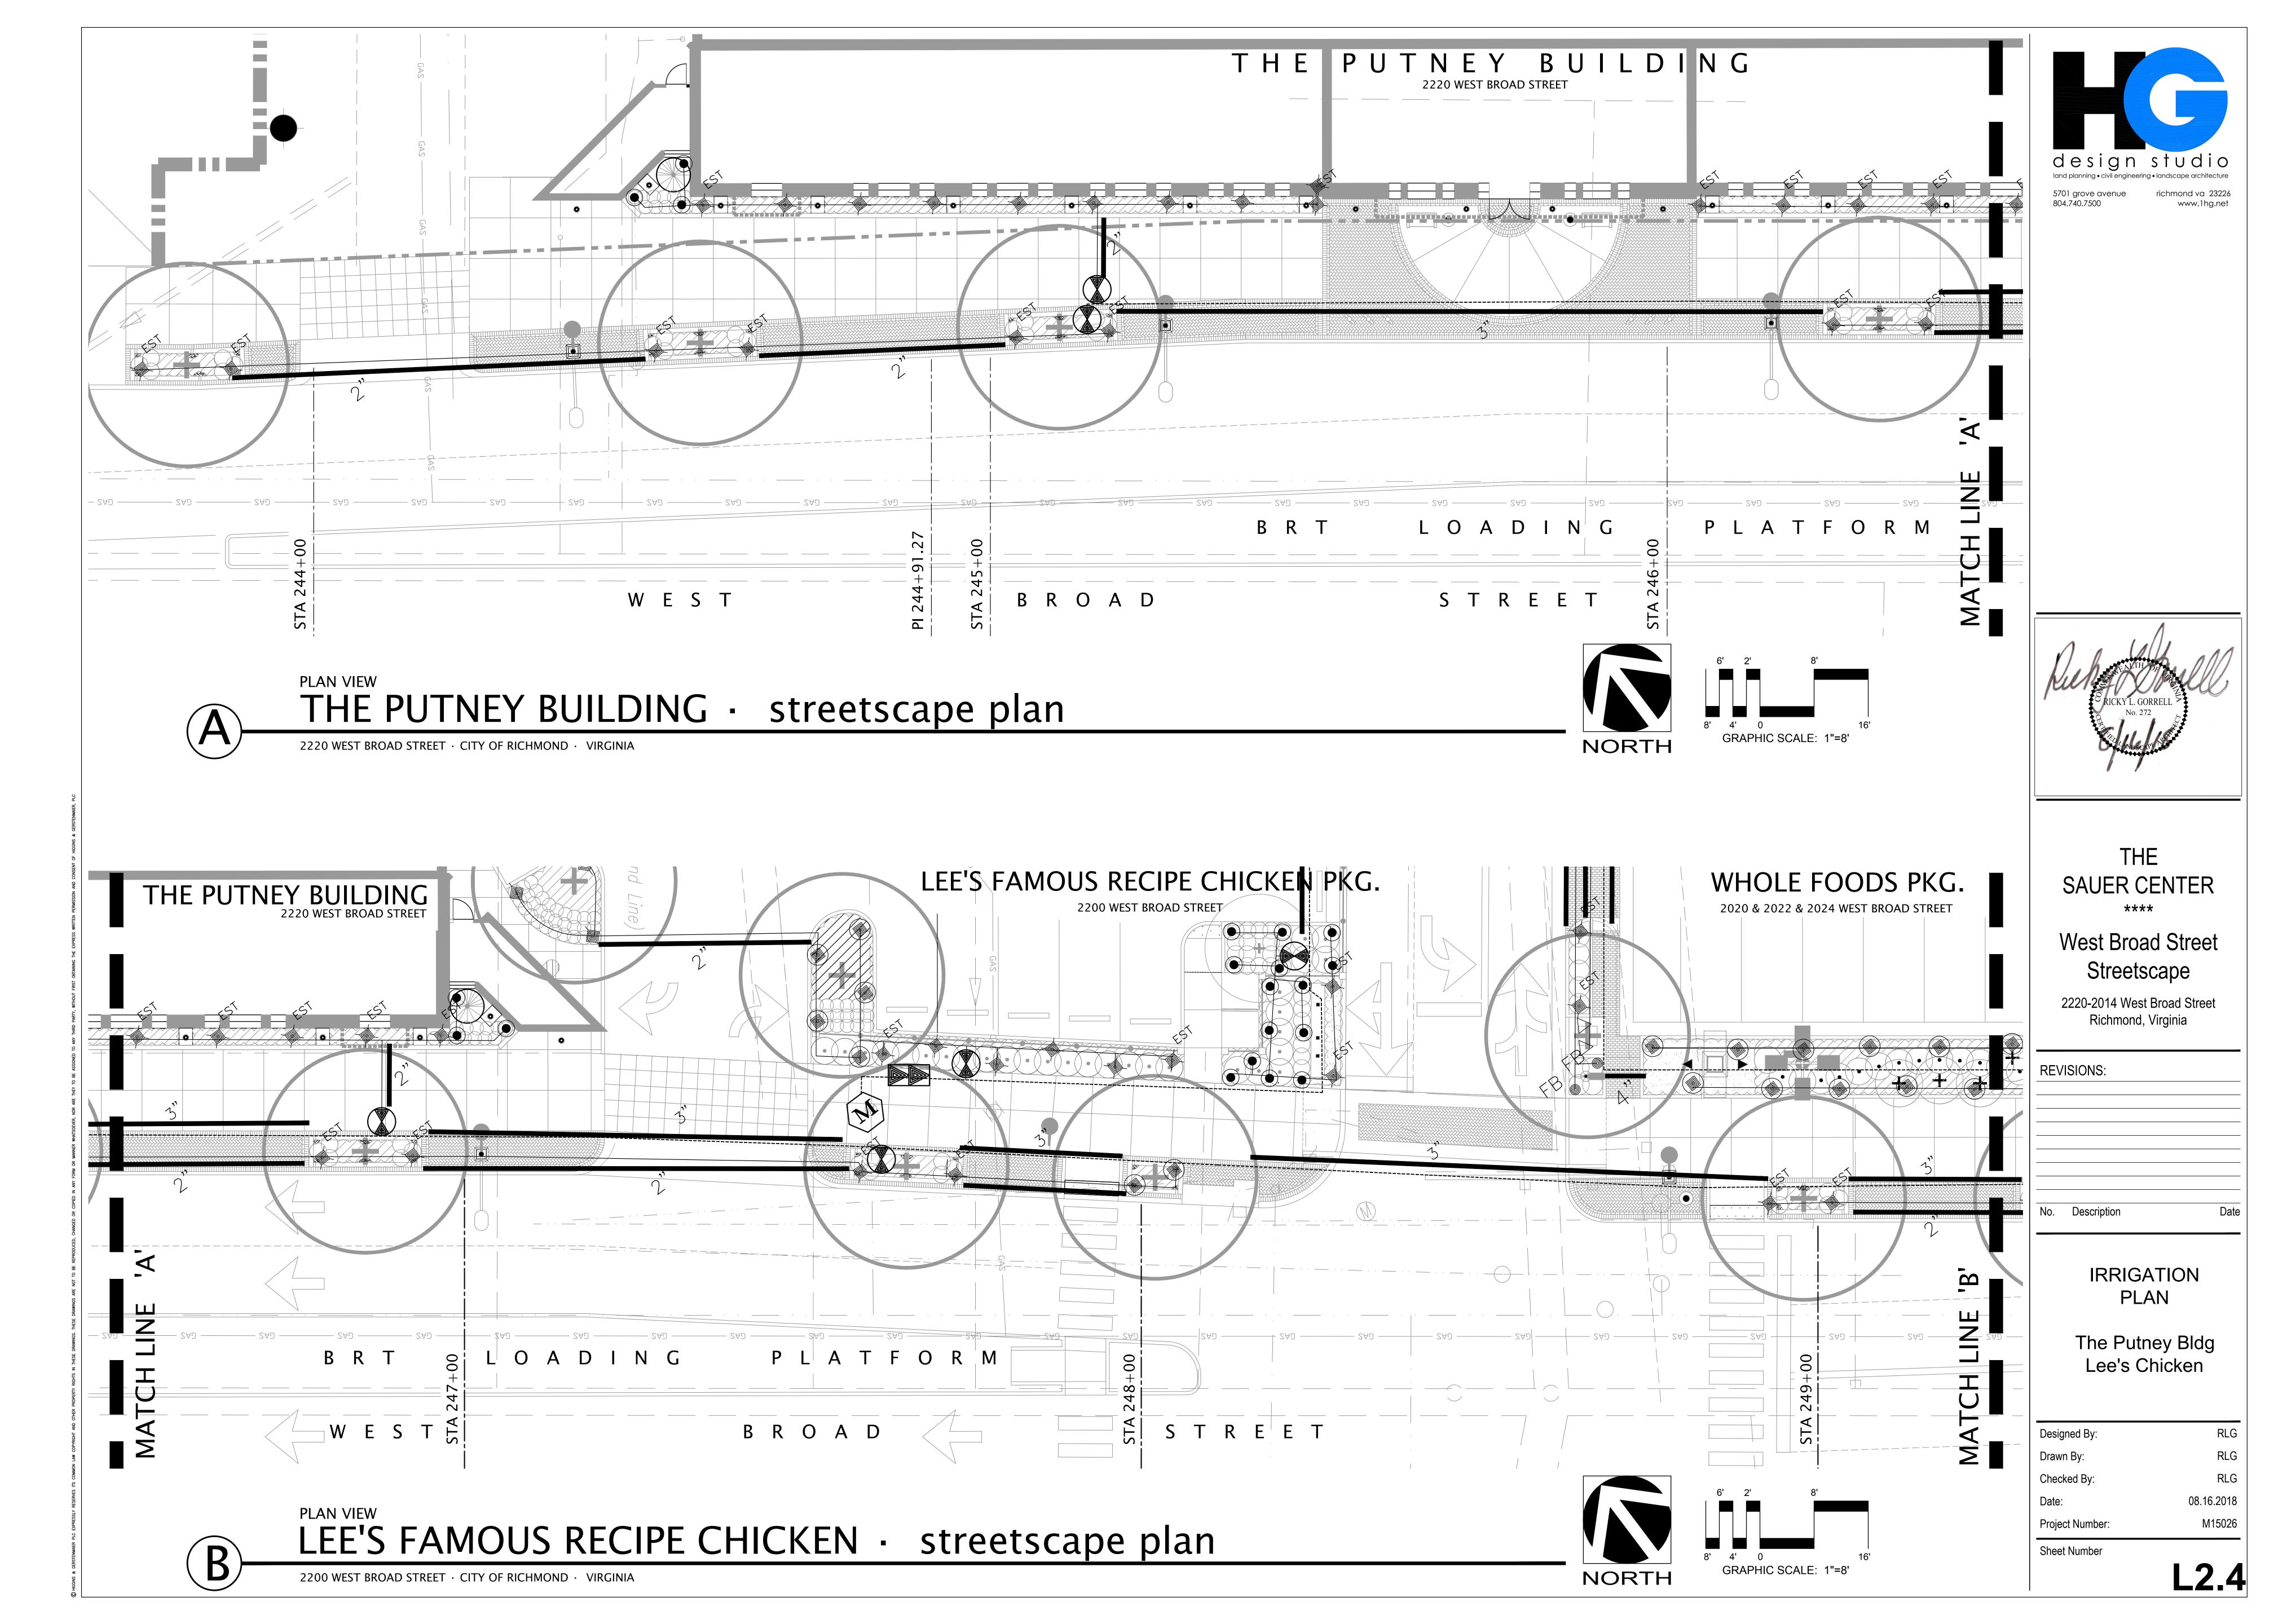

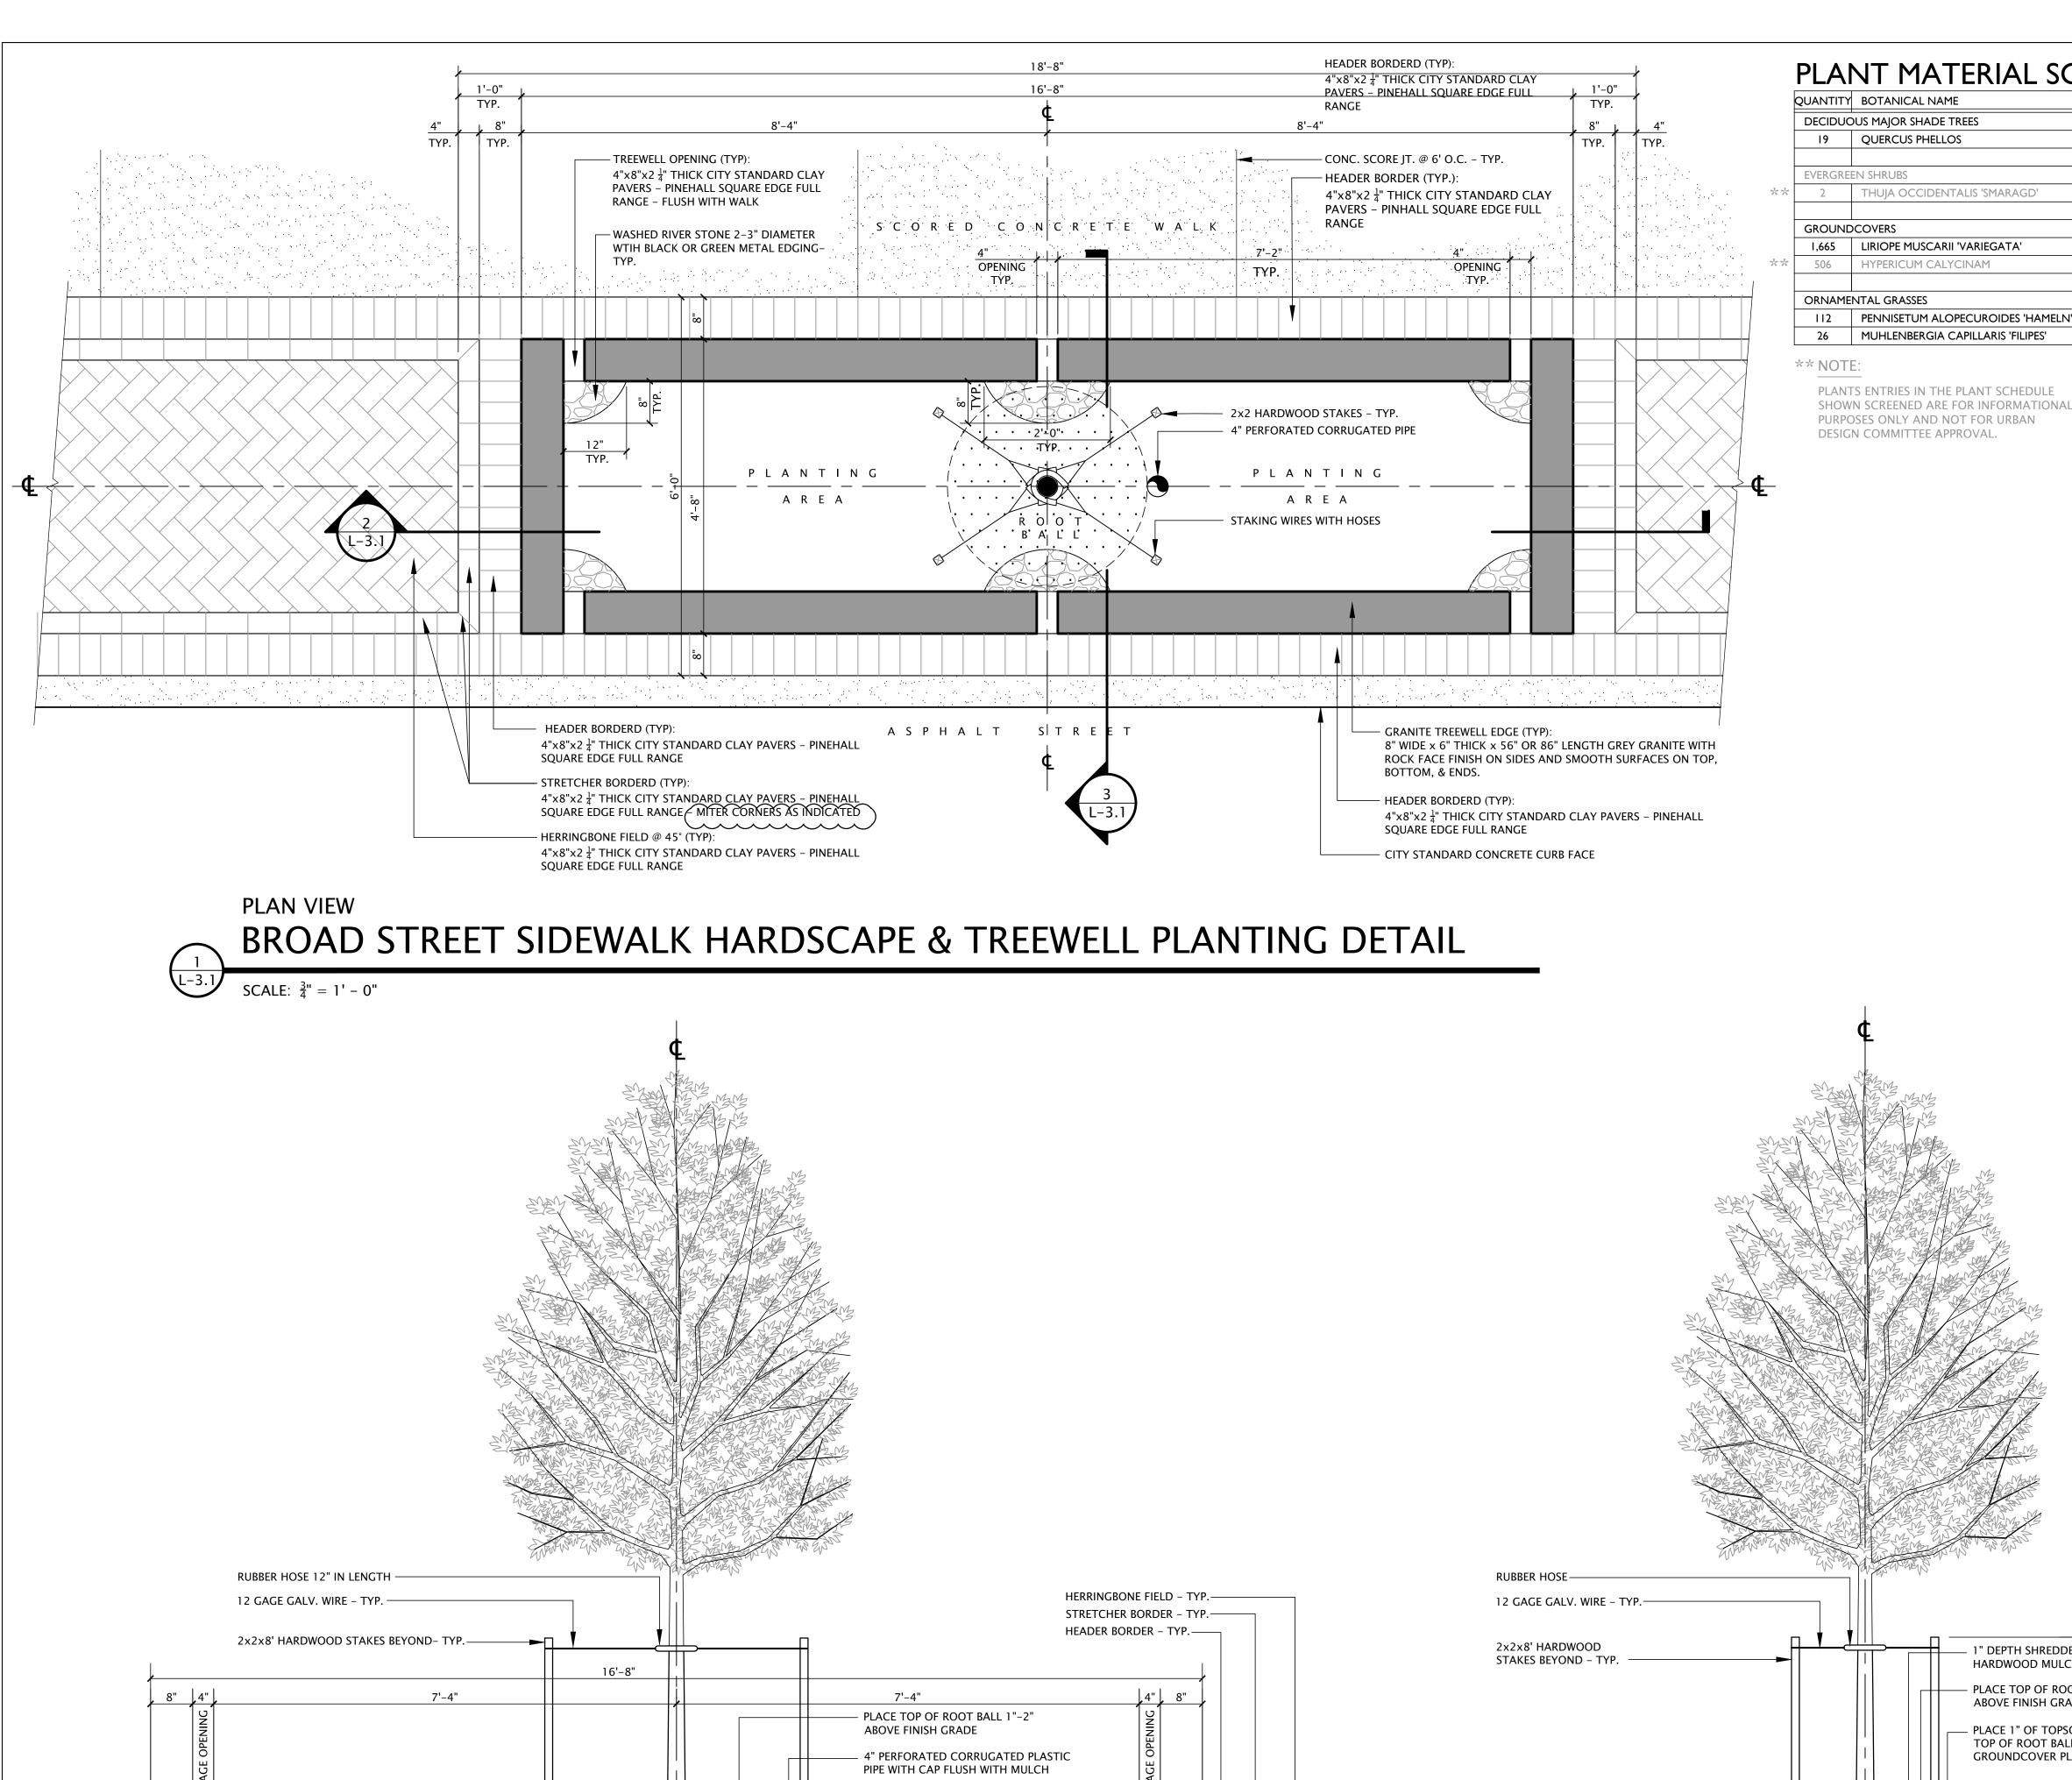

— TOP OF GRANITE BEYOND

WITH AMENDED TOPSQIL

CITY ST'D. $4"x8"x 2\frac{1}{4}"$ PINEHALL

WITH SAND SWEPT JTS. - TYP. -

3" SAND SETTING BED - TYP. —

4" CONC. 3,000 PSI BASE - TYP. —

COMPACTED SUBGRADE - TYP. -

4" COMPACTED 21A STONE BASE - TYP. -

SQ. EDGE FULL RANGE CLAY PAVER

– 1" DEPTH SHREDDED

-REMOVE BURLAP/WIRE FROM TOP 1/2

COMPACTED TOPSOIL

—EXISTING SUBGRADE

BROAD STREET TREEWELL PLANTING DETAIL - LENGTH

BACKFILL UNDER ROOTBALL

OF ROOT BALL & TWINE AROUND TRUNK

HARDWOOD MULCH

− 2"−3" DIA. DECORATIVE

WASHED RIVER STONE - TYP.

NON-ROT FILTER FABRIC WITH

TURNED UP EDGES - TYP.

- 8" W x 6" HT GRANITE CURBING

TOP & BOTTOM – TYP.

GRANITE ABOVE - TYP.

 $\frac{3}{4}$ " MORTAR SETTING BED.

PROVIDE SPACERS TO SUPPORT

SECTION

SCALE: $\frac{3}{4}$ " = 1' - 0"

WITH ROCK FACE SIDES & SMOOTH

OPENING IN

TREE & ROOTBALL SHALL BE

POSITIONED AS SHOWN

MIDDLE BEHIND

ROOTBALL

PLANT MATERIAL SCHEDLILE

1" DEPTH SHREDDED

HARDWOOD MULCH

ABOVE FINISH GRADE

CITY STANDARD $4"x8"x 2\frac{1}{4}"$

SAND SWEPT JTS. - TYP. -

BROAD STREET CURB —

BROAD STREET ASPHALT ROAD SURFACE—

 $\frac{1}{2}$ " X 4" PREFORMED EXP. JT.—

 $\frac{3}{4}$ " SAND SETTING BED – TYP.—

4" COMPACTED 21A

STONE BASE - TYP.

4" CONC. 3,000 PSI BASE - TYP.—

8" W x 6" HT GRANITE CURBING

SMOOTH TOP & BOTTOM - TYP. -

PROVIDE SPACERS TO SUPPORT

WITH ROCK FACE SIDES &

 $\frac{3}{4}$ " MORTAR SETTING BED.

GRANITE ABOVE - TYP. —

SECTION

SCALE: $\frac{3}{4}$ " = 1' - 0"

PINEHALL SOUARE EDGE FULL RANGE CLAY PAVER WITH

PLACE 1" OF TOPSOIL ON TOP OF ROOT BALL FOR

GROUNDCOVER PLANTINGS

− ½"R TOOLED EDGE &

– 4" CONC. 4,000 PSI

WITH BROOM FINISH

COMPACTED 21A STONE BASE

BACKFILL PLANTING PIT/TREEWELL

COMPACTED TOPSOIL BACKFILL

-REMOVE BURLAP OR WIRE FROM TOP HALF OF

ROOT BALL AND ALL TWINE AROUND TRUNK

WITH AMENDED TOPSOIL MIX

UNDER ROOTBALL.

TREE & ROOTBALL SHALL BE

BROAD ST TREEWELL PLANTING DT'L - WIDTH

POSITIONED AS SHOWN

SCORE JTS. - TYP.

PLACE TOP OF ROOT BALL 1"-2"


UANTIT	Y BOTANICAL NAME	COMMON NAME	SPACING	CALIPER	HEIGHT	ROOT TYPE	DETAIL	REMARKS
DECIDU	JOUS MAJOR SHADE TREES					-		
19	QUERCUS PHELLOS	WILLOW OAK	AS SHOWN	3.5-4"	14-16'	B&B	1, 2, &3	STRAIGHT CENTRAL LEADER, LIMB UP 6'
EVERGR	REEN SHRUBS							
2	THUJA OCCIDENTALIS 'SMARAGD'	EMERALD GREEN ARBORVITAE	AS SHOWN	-	14-16'	B&B		MULCH ENTIRE BED
GROUN	 NDCOVERS							
1,665	LIRIOPE MUSCARII 'VARIEGATA'	VARIEGATED LIRIOPE	10" O.C.	-	-	2.25" POTS	4	MULCH ENTIRE BED
506	HYPERICUM CALYCINAM	AARONSBEARD	10" O.C.	-	-	2.25" POTS	4	MULCH ENTIRE BED
ORNAM	 1ENTAL GRASSES							
112	PENNISETUM ALOPECUROIDES 'HAMELN'	DWARF FOUNTAIN GRASS	18" O.C.	-	-	GAL POTS	2 & 4	MULCH ENTIRE BED
26	MUHLENBERGIA CAPILLARIS 'FILIPES'	PURPLE MUHLY GRASS	24" O.C.	-	-	GAL POTS	4	MULCH ENTIRE BED

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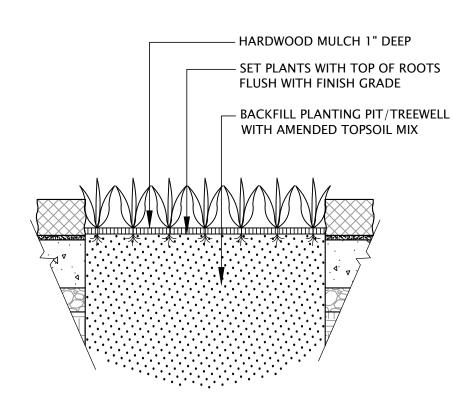
PLANTING NOTES:

I. CONTRACTOR SHALL VERIFY PLANT MATERIAL QUANTITIES SHOWN ON PLAN WITH TOTALS IN PLANTING SCHEDULE. NOTIFY LANDSCAPE ARCHITECT OF ANY DISCREPANCIES PRIOR TO FINAL BIDDING. UNIT PRICES SHALL BE SUBMITTED AS PART OF FINAL

- 2. ALL PLANT MATERIALS SHALL BE GUARANTEED FOR ONE FULL YEAR TO BE IN A HEALTHY GROWING CONDITION. PLANT MATERIALS WHICH DO NOT FULFILL THIS GUARANTEE SHALL BE REPLACED AT NO COST TO THE OWNER. REPLACEMENT SHALL BE GUARANTEED THROUGHOUT THE ORIGINAL GUARANTEE PERIOD. PLANTS THAT DIE SHALL BE REPLACED IMMEDIATELY.
- 3. CONTRACTOR IS RESPONSIBLE FOR WATERING ALL PLANT MATERIAL DURING INSTALLATION AND UNTIL FINAL INSPECTION AND ACCEPTANCE BY OWNER. CONTRACTOR SHALL NOT ASSUME IRRIGATION SYSTEM IS FULLY OPERATIONAL AT COMPLETION OF PLANTING INSTALLATION
- 4. CONTRACTOR RESPONSIBLE FOR CONTACTING MISS UTILITY PRIOR TO BEGINNING OF CONSTRUCTION FOR LOCATION OF ALL UTILITY LINES. NOTIFY LANDSCAPE ARCHITECT IF ANY CONFLICTS OCCUR.
- 5. THE LANDSCAPE ARCHITECT IS THE OWNERS REPRESENTATIVE AND SHALL BE THE APPROVING AUTHORITY FOR INFORMATION PROVIDED IN THESE PLANS AND SPECIFICATIONS.
- 6. ALL PLANT MATERIALS, TOPSOIL, MULCH, FERTILIZERS, SOIL AMENITIES, PLANTING SUPPLIES AND METHODS SHALL BE SUBJECT TO LANDSCAPE ARCHITECTS APPROVAL. REJECTED MATERIALS SHALL BE REMOVED FROM THE SITE WITHOUT DELAY.
- 7. ALL PLANT MATERIALS AND PLANTING METHODS SHALL CONFORM TO A.A.N. STANDARDS.
- 8. CONTRACTOR SHALL LAYOUT AND MARK LOCATION FOR ALL PLANT MATERIAL, PLANTING, AND IMPROVEMENTS SHOWN AND REQUEST IN FIELD APPROVAL FROM LANDSCAPE ARCHITECT.
- 9. BEDS TO CONTAIN SHRUBS OR GROUND COVER SHALL BE TILLED TO A DEPTH OF 6" AND THE SOIL CONDITIONED BY ADDING CLEAN, WELL ROTTED MANURE. IF EXISTING SOIL IS CONSIDERED TO BE UNUSABLE BY OWNER, BEDS SHALL BE TREATED TO ELIMINATE WEEDS AND WEED SEEDS.
- 10. ALL PLANTING BED AREAS SHALL BE COVERED WITH A 3" MINIMUM LAYER OF MEDIUM TEXTURE SHREDDED HARDWOOD MULCH
- 11. ALL SUBSTITUTIONS OF PLANT MATERIAL SHALL BE REQUESTED IN WRITING TO THE LANDSCAPE ARCHITECT AND APPROVED IN WRITING BY THE OWNER.
- 12. ALL PLANTING OPERATIONS SHALL BE UNDER THE SUPERVISION OF AN EXPERIENCED PLANTSMAN.
- 13. LANDSCAPE ARCHITECT RESERVES THE RIGHT TO SELECT PLANT MATERIALS IN THE NURSERY.
- 14. FOR TREES BALLED IN WIRE BASKETS, CUT AND REMOVE TOP AND SIDES OF BASKET AFTER INSTALLATION.
- 15. LANDSCAPE ARCHITECT RESERVES THE RIGHT TO REJECT ANY PLANTS AND MATERIALS THAT ARE IN AN UNHEALTHY OR UNSIGHTLY CONDITION, AS WELL AS PLANTS AND MATERIALS THAT DO NOT CONFORM TO A.A.N. STANDARDS. SEE AMERICAN STANDARD FOR NURSERY STOCK, ANSI Z60.1-(CURRENT EDITION).
- 16. SOIL SHALL BE FREE OF ALL WEEDS.
- 17. PLANT SIZES, QUANTITIES, AND SPECIES WILL BE CHECKED BY CITY INSPECTION FOR COMPLIANCE WITH PLANT SCHEDULE AS APPROVED BY THE CITY. CONTRACTOR SHALL BE HELD RESPONSIBLE FOR DELAY IN ISSUANCE OF CERTIFICATE OF OCCUPANCY BY THE CITY RESULTING FROM UNAUTHORIZED SUBSTITUTIONS OR DOWNSIZING.
- 18. UPON COMPLETION OF LANDSCAPE INSTALLATION, THE LANDSCAPE CONTRACTOR SHALL NOTIFY THE GENERAL CONTRACTOR WHO WILL VERIFY COMPLETENESS, INCLUDING THE REPLACEMENT OF ALL DEAD PLANT MATERIAL, AND SCHEDULE A FINAL INSPECTION FOR ACCEPTANCE BY OWNER
- 19. THE ONE YEAR GUARANTEE PERIOD SHALL BEGIN UPON THE OWNER'S APPROVAL AND ACCEPTANCE OF THE PLANTING INSTALLATION. THE OWNER SHALL ASSUME RESPONSIBILITY FOR MAINTENANCE INCLUDING WATERING, WEEDING, PEST CONTROL, AND FERTILIZATION.
- 20. CONTRACTOR SHALL REMOVE STAKING FROM TREES AT THE END OF THE ONE YEAR WARRANTY PERIOD.

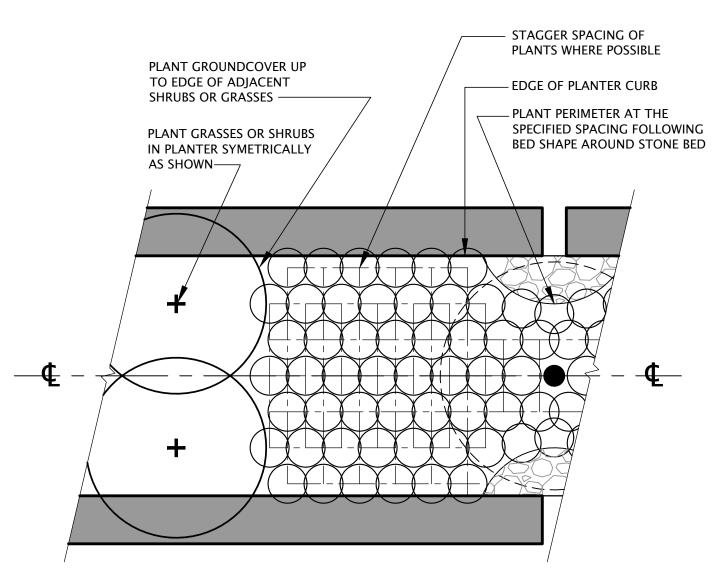

PLAN VIEW



SECTION VIEW

GROUNDCOVER PLANTING DT'L

PLANTING **DETAILS SCHEDULE**

SAUER CENTER

West Broad Street

Streetscape

2220-2014 West Broad Street


Richmond, Virginia

REVISIONS:

No. Description

Designed By: Drawn By: Checked By 08.16.2018 Date: Project Number:

Sheet Number

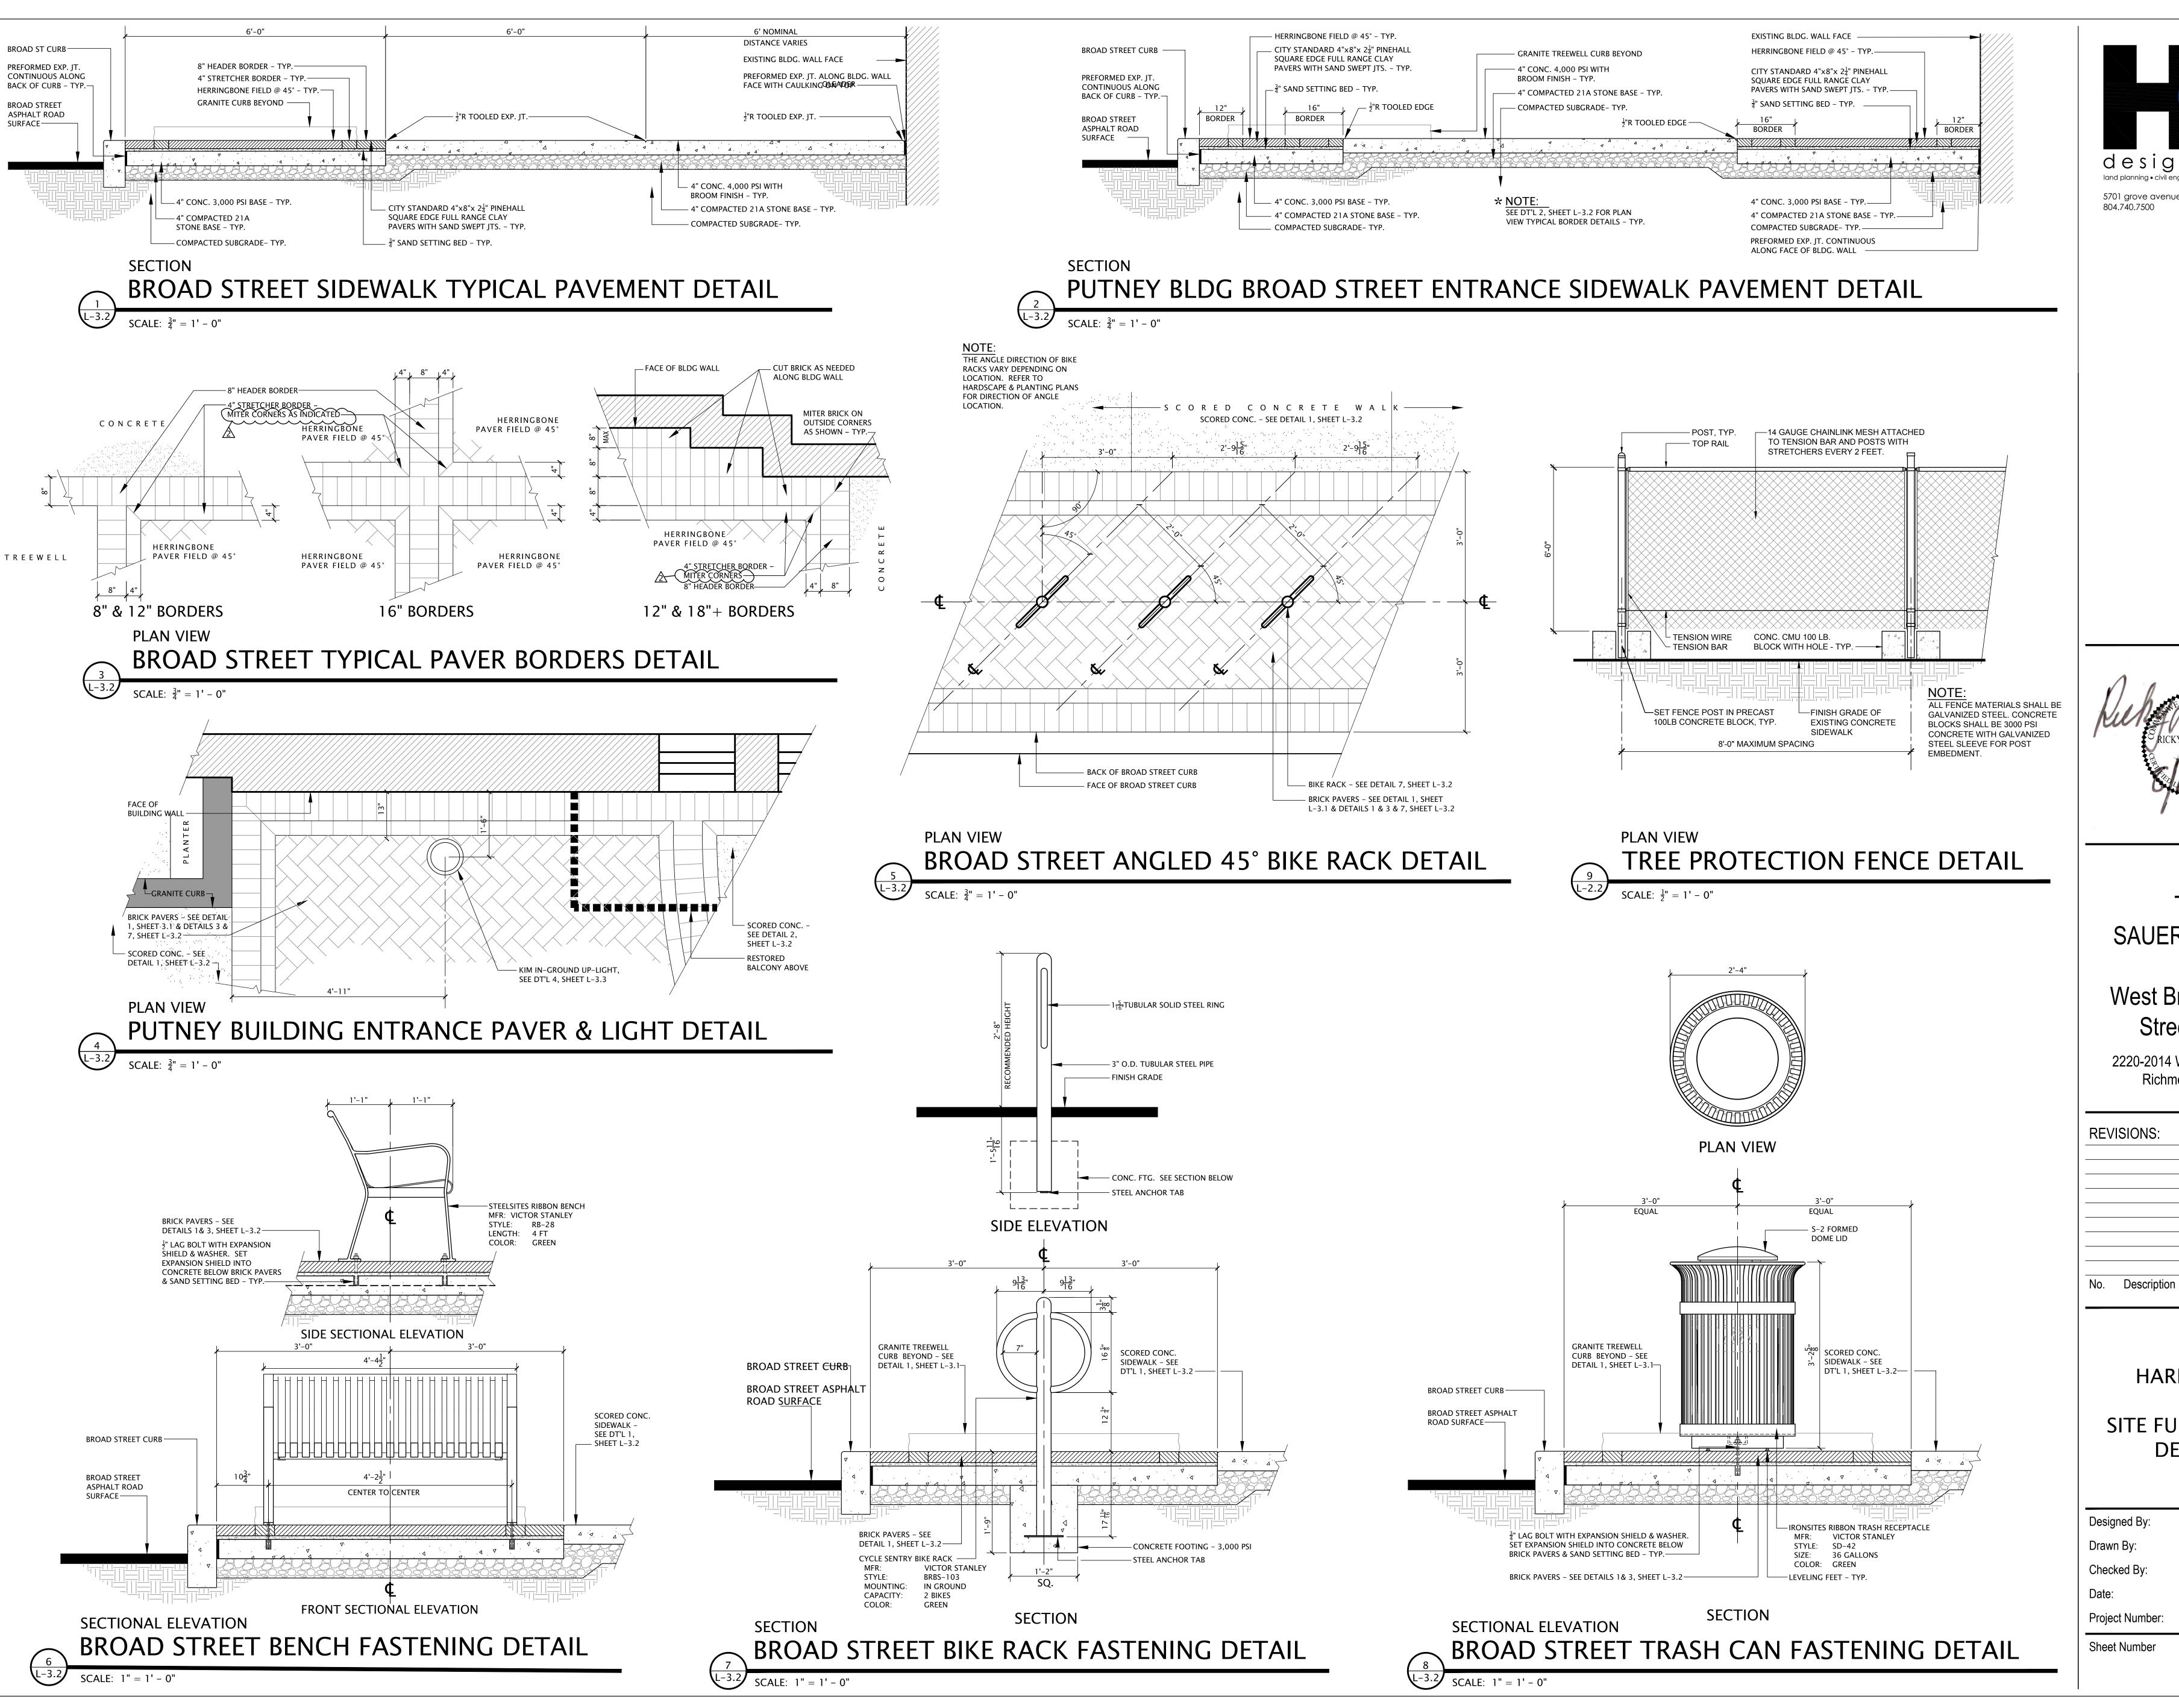

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THE SAUER CENTER ****

West Broad Street Streetscape

2220-2014 West Broad Street Richmond, Virginia

REVISIONS:


HARDSCAPE SITE FURNISHINGS

DETAILS

Designed By: Drawn By: Checked By 08.16.2018 Project Number:


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L3.2

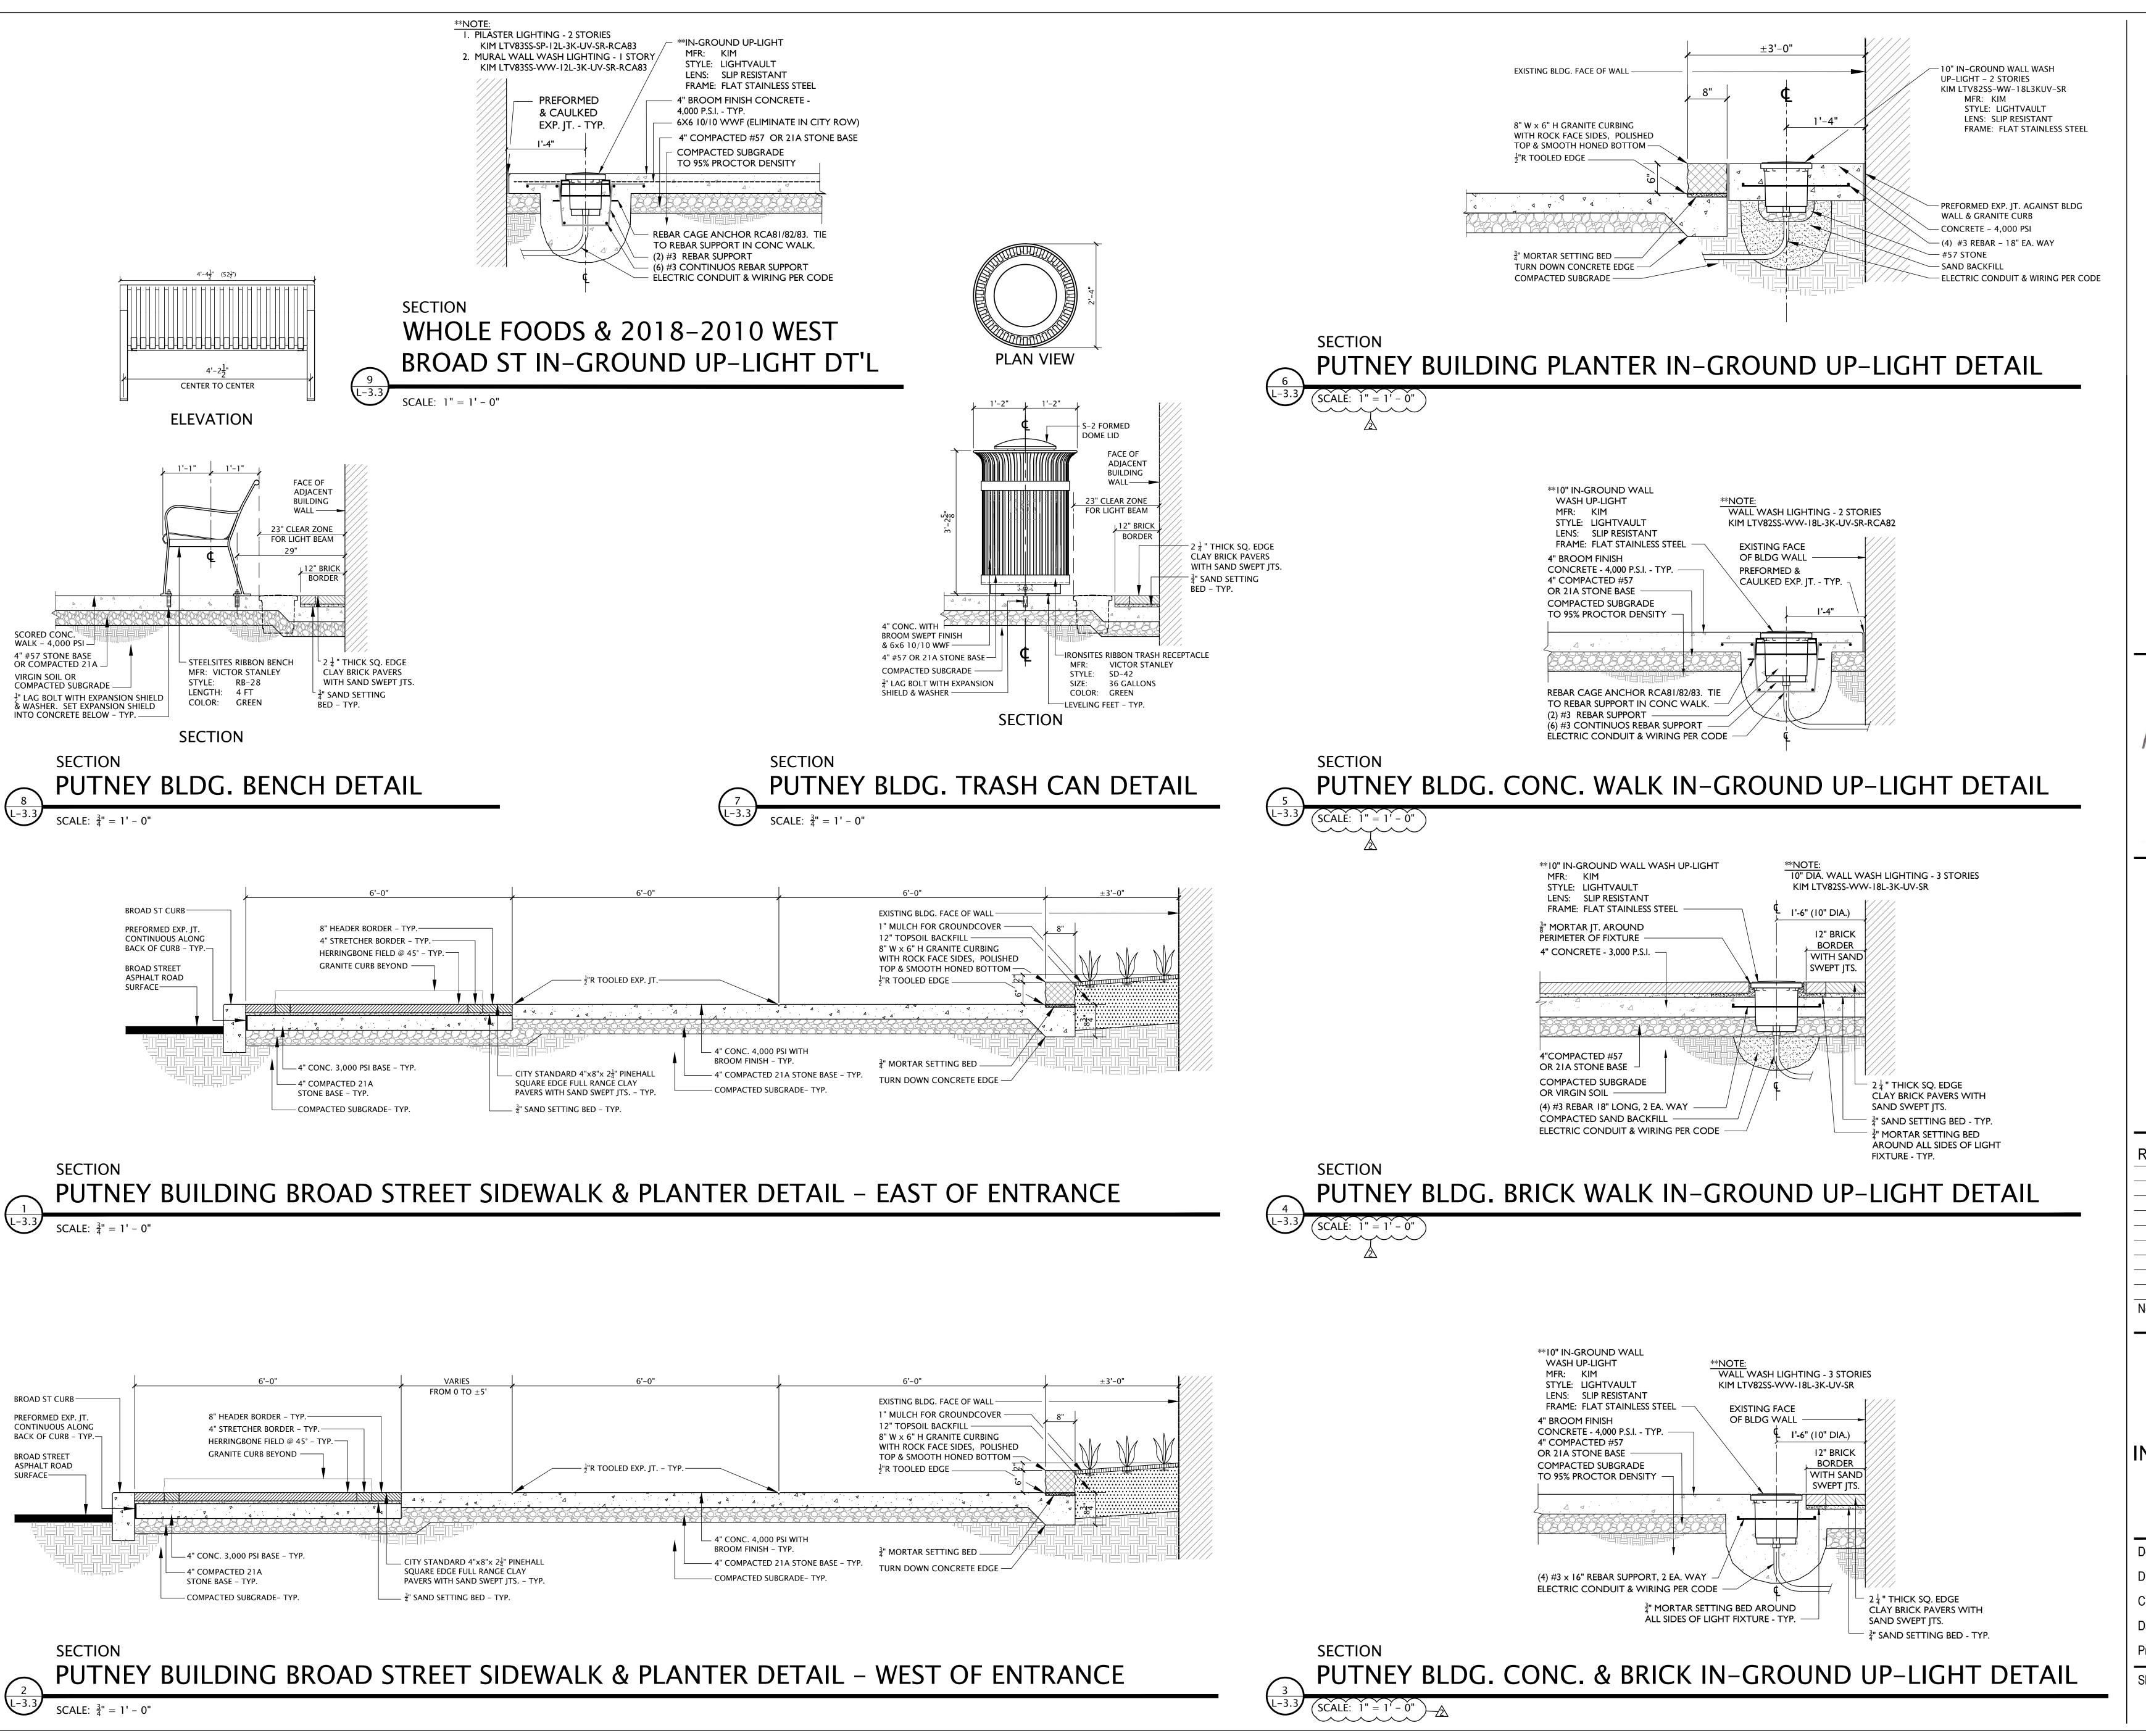

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THE
SAUER CENTER

West Broad Street
Streetscape

2220-2014 West Broad Street Richmond, Virginia

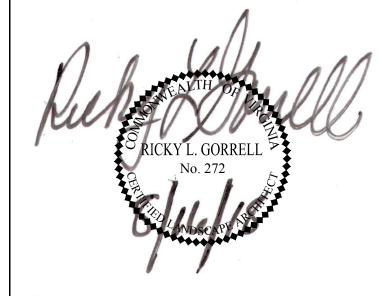REVISIONS:

No. Description

HARDSCAPE & IN-GROUND UP-LIGHT DETAILS

Designed By:

Drawn By:

Checked By:

Project Number:

RLG

RLG


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Sheet Number

L3.3



 $4"x8"x2\frac{1}{4}"$ THICK CITY STANDARD CLAY

- GRANITE TREEWELL EDGE (TYP):

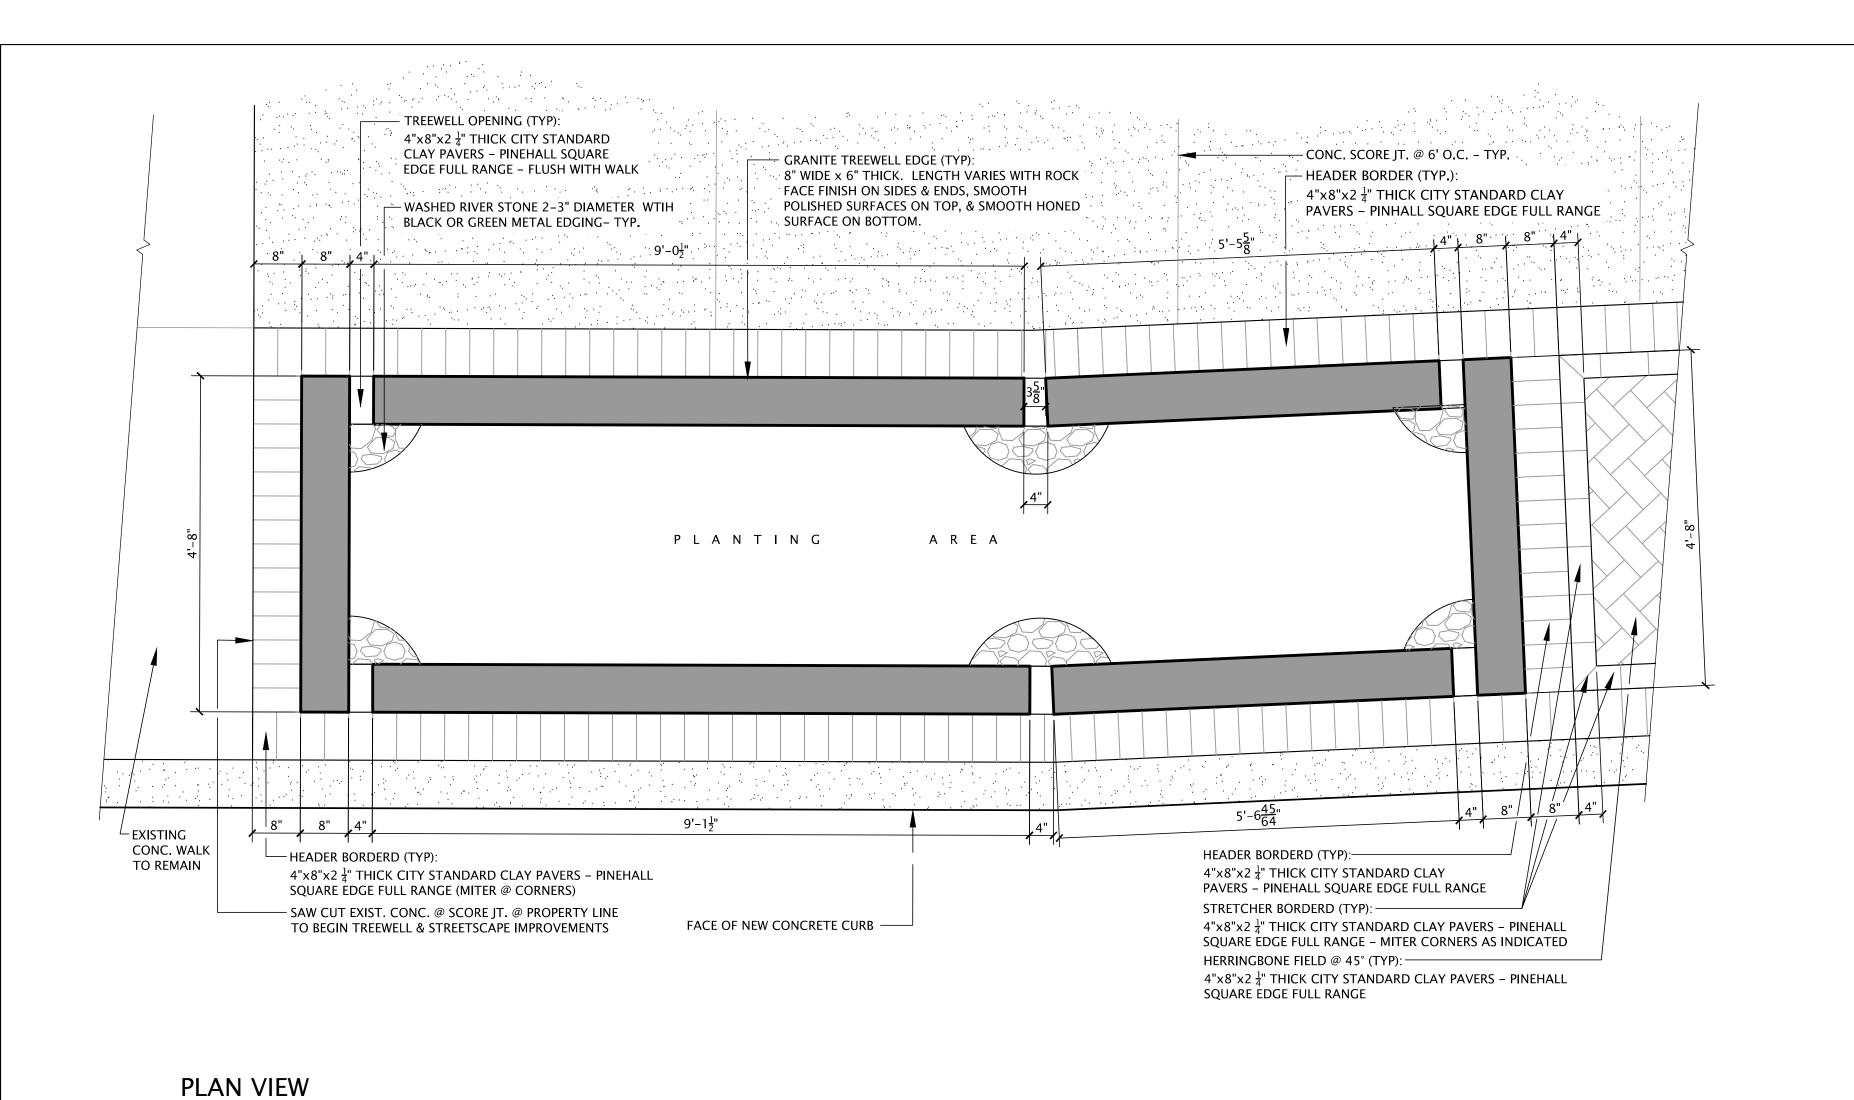PAVERS – PINHALL SQUARE EDGE FULL RANGE

TOP, & SMOOTH HONED SURFACE ON BOTTOM.

8" WIDE x 6" THICK. LENGTH VARIES WITH ROCK FACE

FINISH ON SIDES & ENDS, SMOOTH POLISHED SURFACES ON

DROP INLET

CONC / SURFACE

CONTRACTOR SHALL

IF LESS THAN 8'-11",


REDUCE LENGTH OF

GRANITE CURB BY

AMOUNT SHORT.

PUTNEY BUILDING FAR WEST ATYPICAL TREEWELL DETAIL

SCALE: $\frac{3}{4}$ " = 1' - 0"

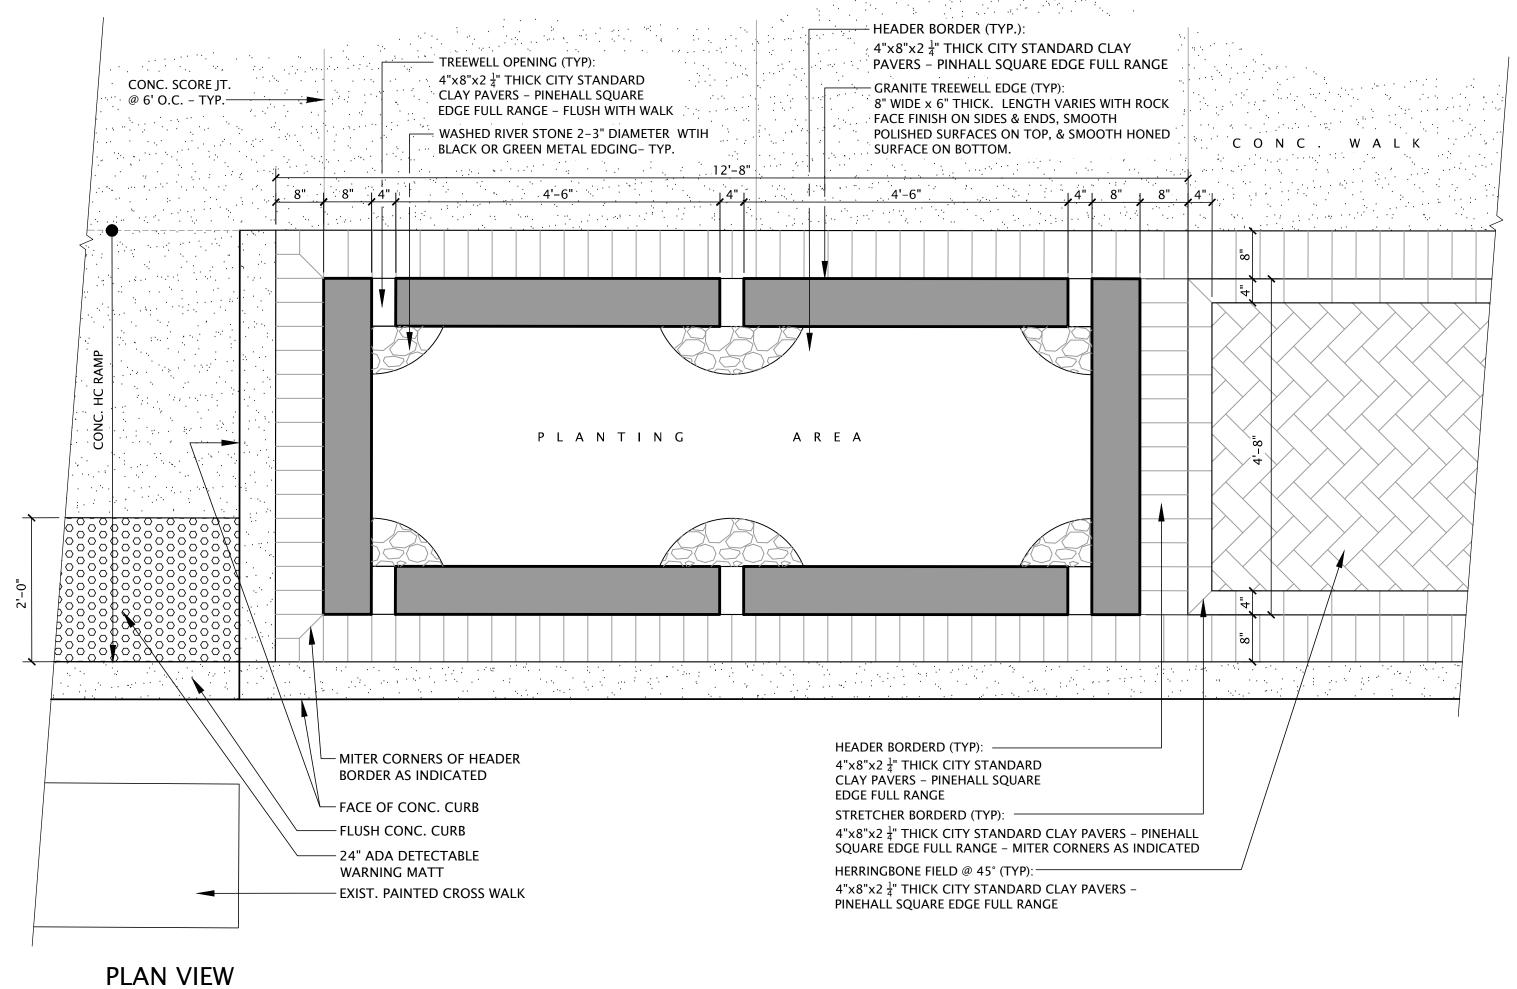

WHOLE FOODS ALLISON DRIVE AISLE ATYPICAL TREEWELL DETAIL

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SAUER CENTER

West Broad Street Streetscape

2220-2014 West Broad Street Richmond, Virginia

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ATYPICAL TREEWELL HARDSCAPE **DETAILS**

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Sheet Number

 $4"x8"x2\frac{1}{4}"$ THICK CITY STANDARD GRANITE TREEWELL EDGE (TYP): CONC. SCORE JT. @ 6' O.C. - TYP. CLAY PAVERS - PINEHALL SQUARE 8" WIDE x 6" THICK. LENGTH VARIES WITH ROCK FACE EDGE FULL RANGE – FLUSH WITH WALK - HEADER BORDER (TYP.): FINISH ON SIDES & ENDS, SMOOTH POLISHED SURFACES 4"x8"x2 ¹/₄" THICK CITY STANDARD CLAY
PAVERS – PINHALL SQUARE EDGE FULL RANGE ─ WASHED RIVER STONE 2-3" DIAMETER WTIH ON TOP, & SMOOTH HONED SURFACE ON BOTTOM. ·· S C O R E D C O N C W A L K BLACK OR GREEN METAL EDGING- TYP. PLANTING AREA HEADER BORDERD (TYP): ---— HEADER BORDERD (TYP): $4"x8"x2\frac{1}{4}"$ THICK CITY STANDARD CLAY PAVERS – PINEHALL $4"x8"x2\frac{1}{4}"$ THICK CITY STANDARD CLAY PAVERS – PINEHALL SQUARE EDGE FULL RANGE EXISTING WILLOW OAK TO REMAIN -SQUARE EDGE FULL RANGE EXISTING GRANITE CURB UNDER — STRETCHER BORDERD (TYP): STRETCHER BORDERD (TYP): -TREE ROOTS TO REMAIN — VERIFY 8'-11" DISTANCE. $4"x8"x2\frac{1}{4}"$ THICK CITY STANDARD CLAY PAVERS – PINEHALL 4"x8"x2 1 THICK CITY STANDARD CLAY PAVERS - PINEHALL SQUARE EDGE FULL RANGE - MITER CORNERS AS INDICATED SQUARE EDGE FULL RANGE - MITER CORNERS AS INDICATED HERRINGBONE FIELD @ 45° (TYP): — - HERRINGBONE FIELD @ 45° (TYP): 4"x8"x2 ½" THICK CITY STANDARD CLAY PAVERS - PINEHALL 4"x8"x2 1/4" THICK CITY STANDARD CLAY PAVERS - PINEHALL SQUARE EDGE FULL RANGE SQUARE EDGE FULL RANGE

PLAN VIEW LEE'S CHICKEN ATYPICAL TREEWELL DETAIL

CONC. SCORE JT. @ 6' O.C. – TYP.

TREEWELL OPENING (TYP):

 $4"x8"x2\frac{1}{4}"$ THICK CITY STANDARD CLAY PAVERS - PINEHALL SQUARE

EDGE FULL RANGE – FLUSH WITH WALK

BLACK OR GREEN METAL EDGING- TYP.

PLANTING

- MITER CORNERS OF HEADER

— EXIST. PAINTED CROSS WALK

BORDER AS INDICATED

— FACE OF CONC. CURB

— 24" ADA DETECTABLE

WARNING MATT

— FLUSH CONC. CURB

- WASHED RIVER STONE 2-3" DIAMETER WTIH

**6'-3"

AREA

HEADER BORDERD (TYP):

EDGE FULL RANGE

 $4"x8"x2\frac{1}{4}"$ THICK CITY STANDARD

CLAY PAVERS - PINEHALL SQUARE

HERRINGBONE FIELD @ 45° (TYP):-

PINEHALL SQUARE EDGE FULL RANGE

4"x8"x2 1 THICK CITY STANDARD CLAY PAVERS - PINEHALL


SQUARE EDGE FULL RANGE - MITER CORNERS AS INDICATED


 $4"x8"x2\frac{1}{4}"$ THICK CITY STANDARD CLAY PAVERS –

STRETCHER BORDERD (TYP): -

PLAN VIEW THE C.F. SAUER COMPANY HEADQUARTERS ATYPICAL TREEWELL DETAIL

SCALE: $\frac{3}{4}$ " = 1' - 0"

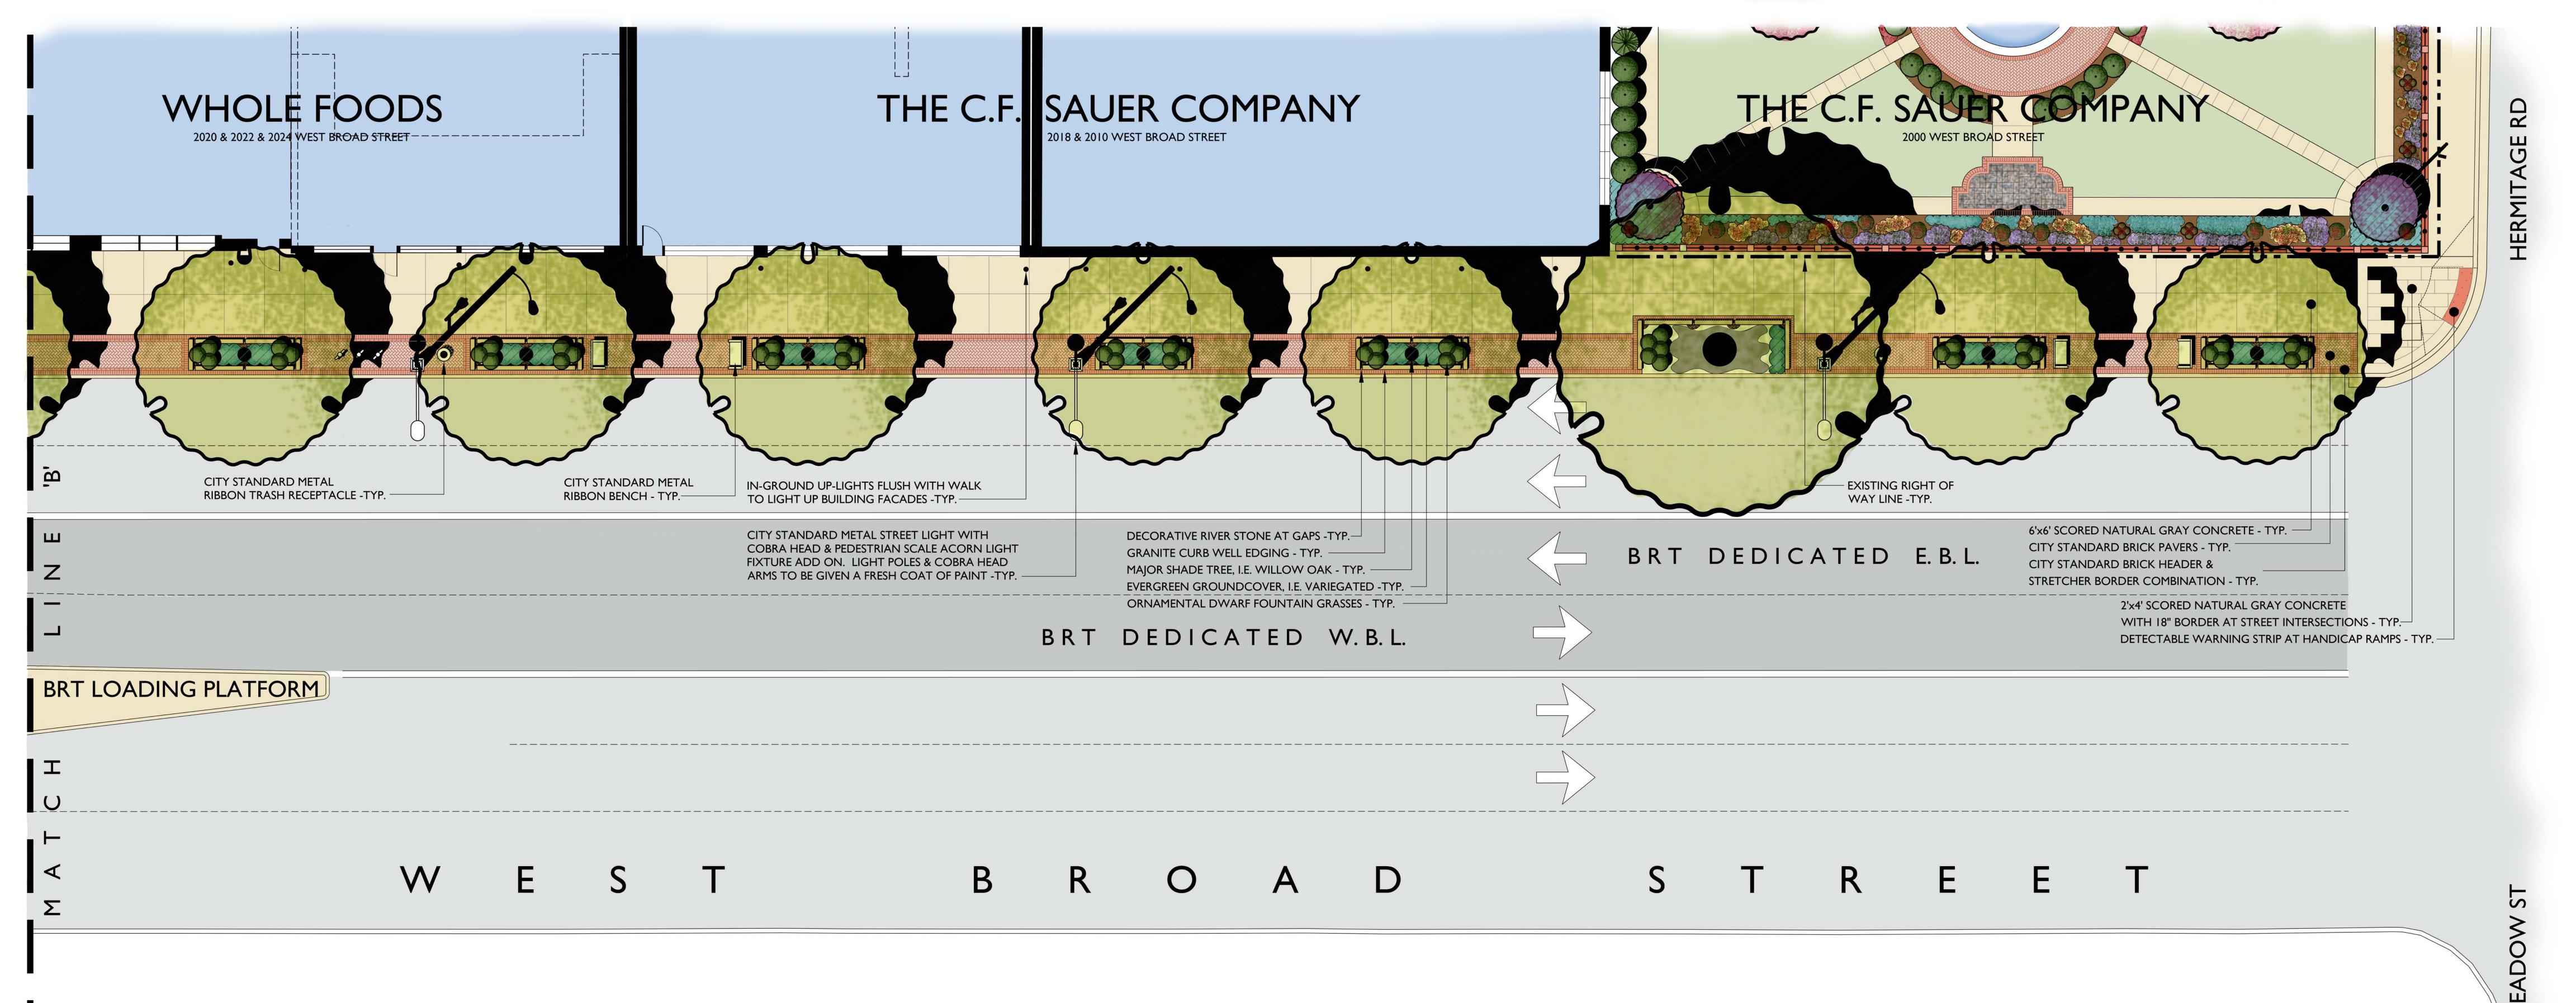


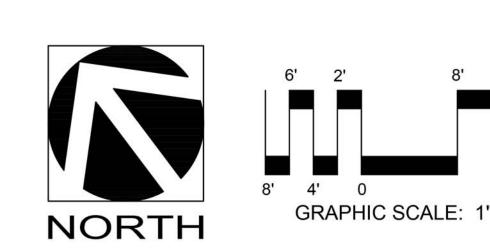


THE SAUER CENTER · illustrative streetscape plan

- 3 east



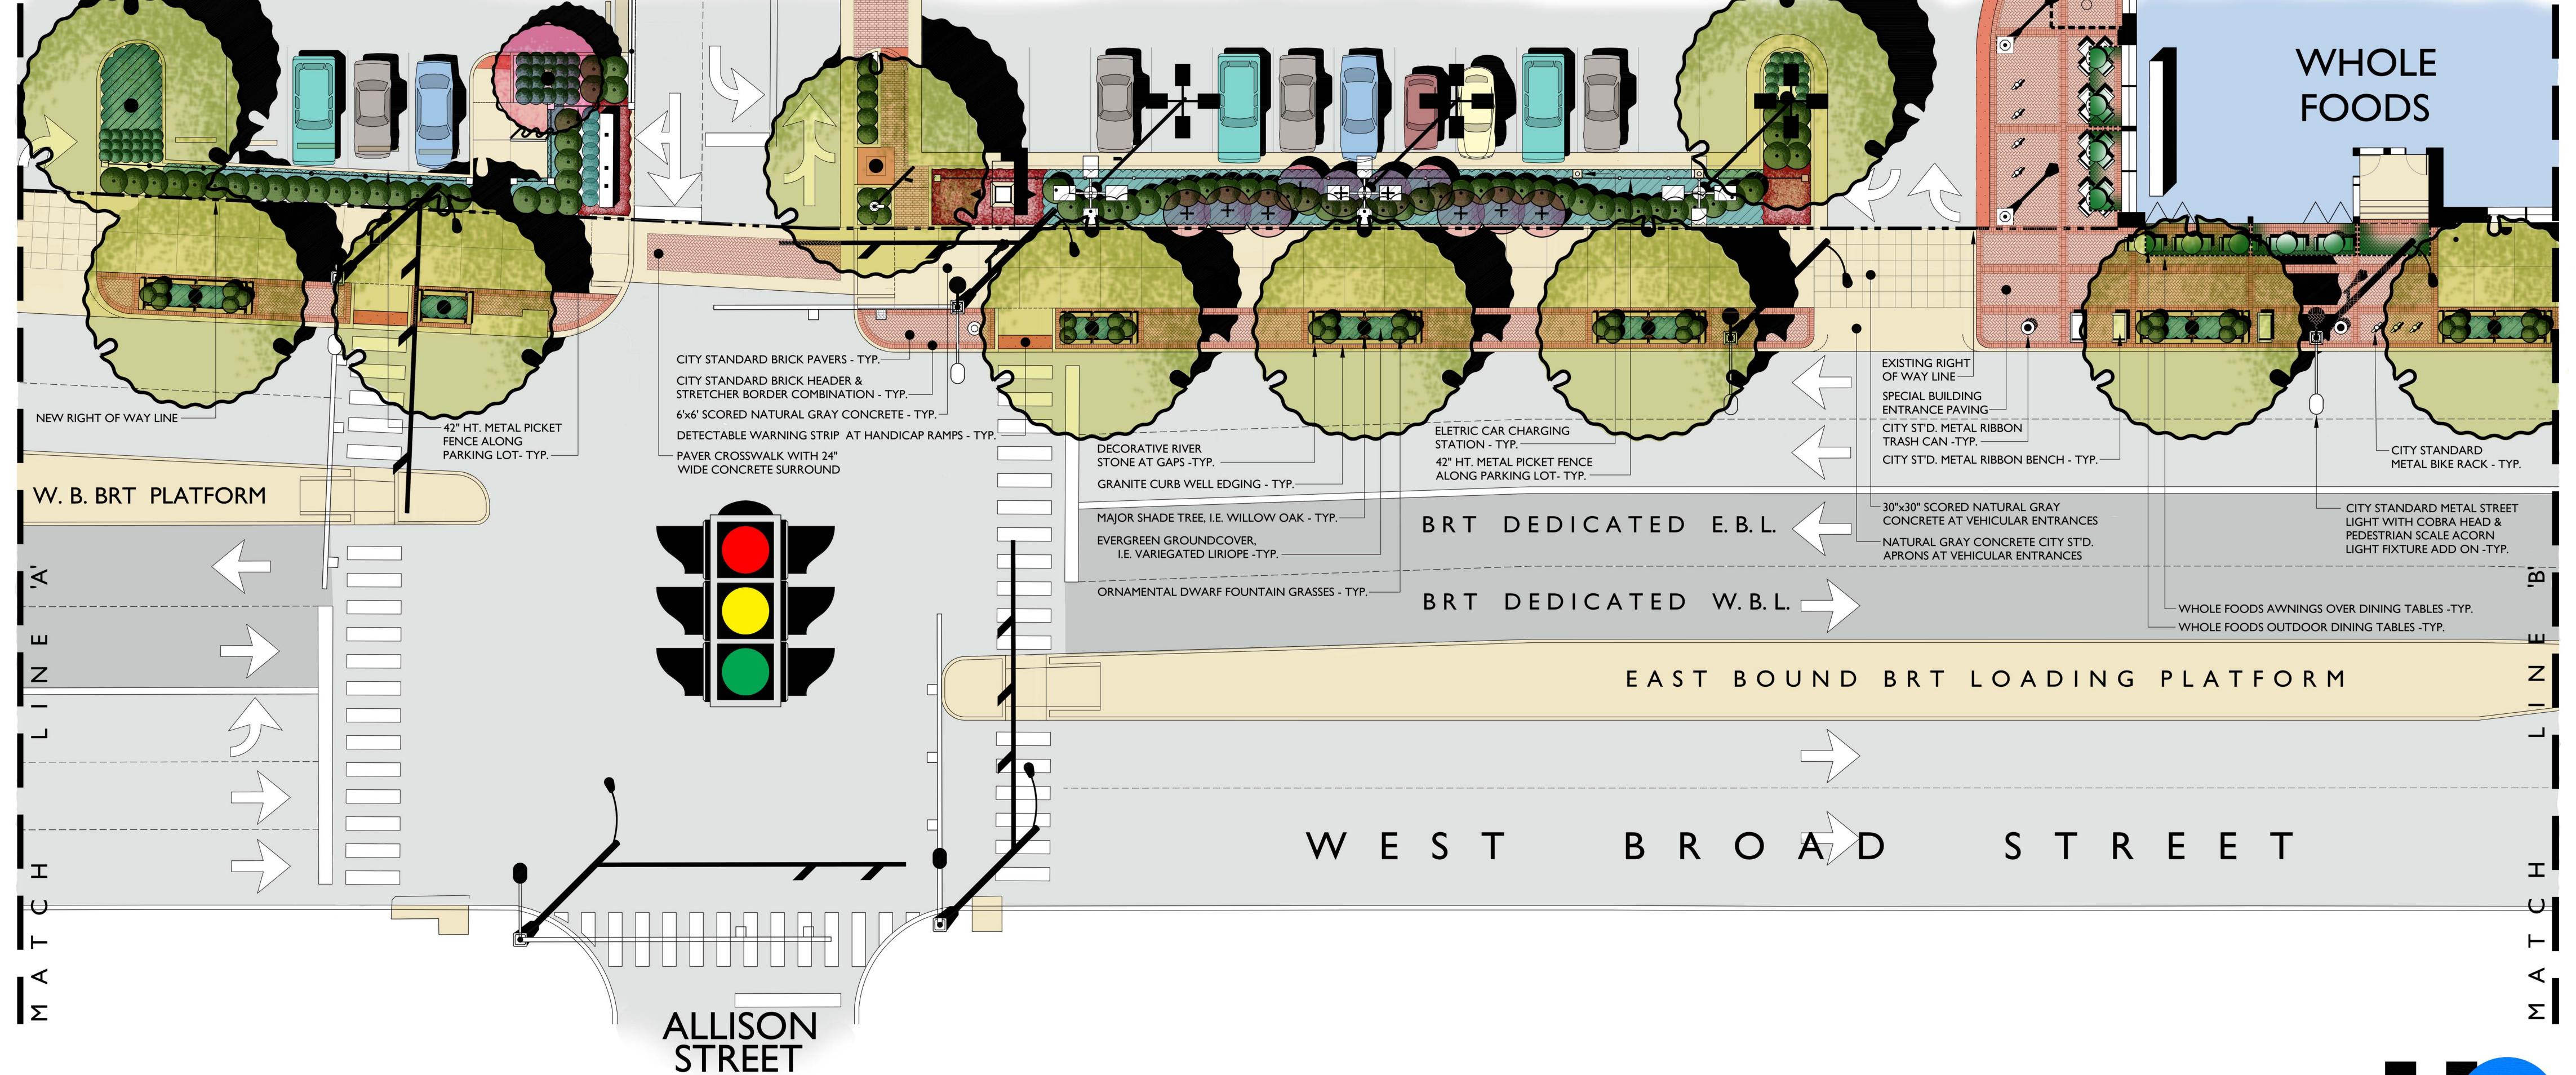




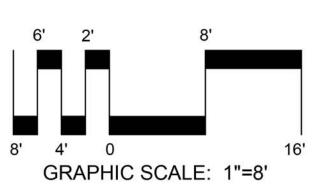


THE SAUER CENTER · illustrative streetscape plan

L·2 middle



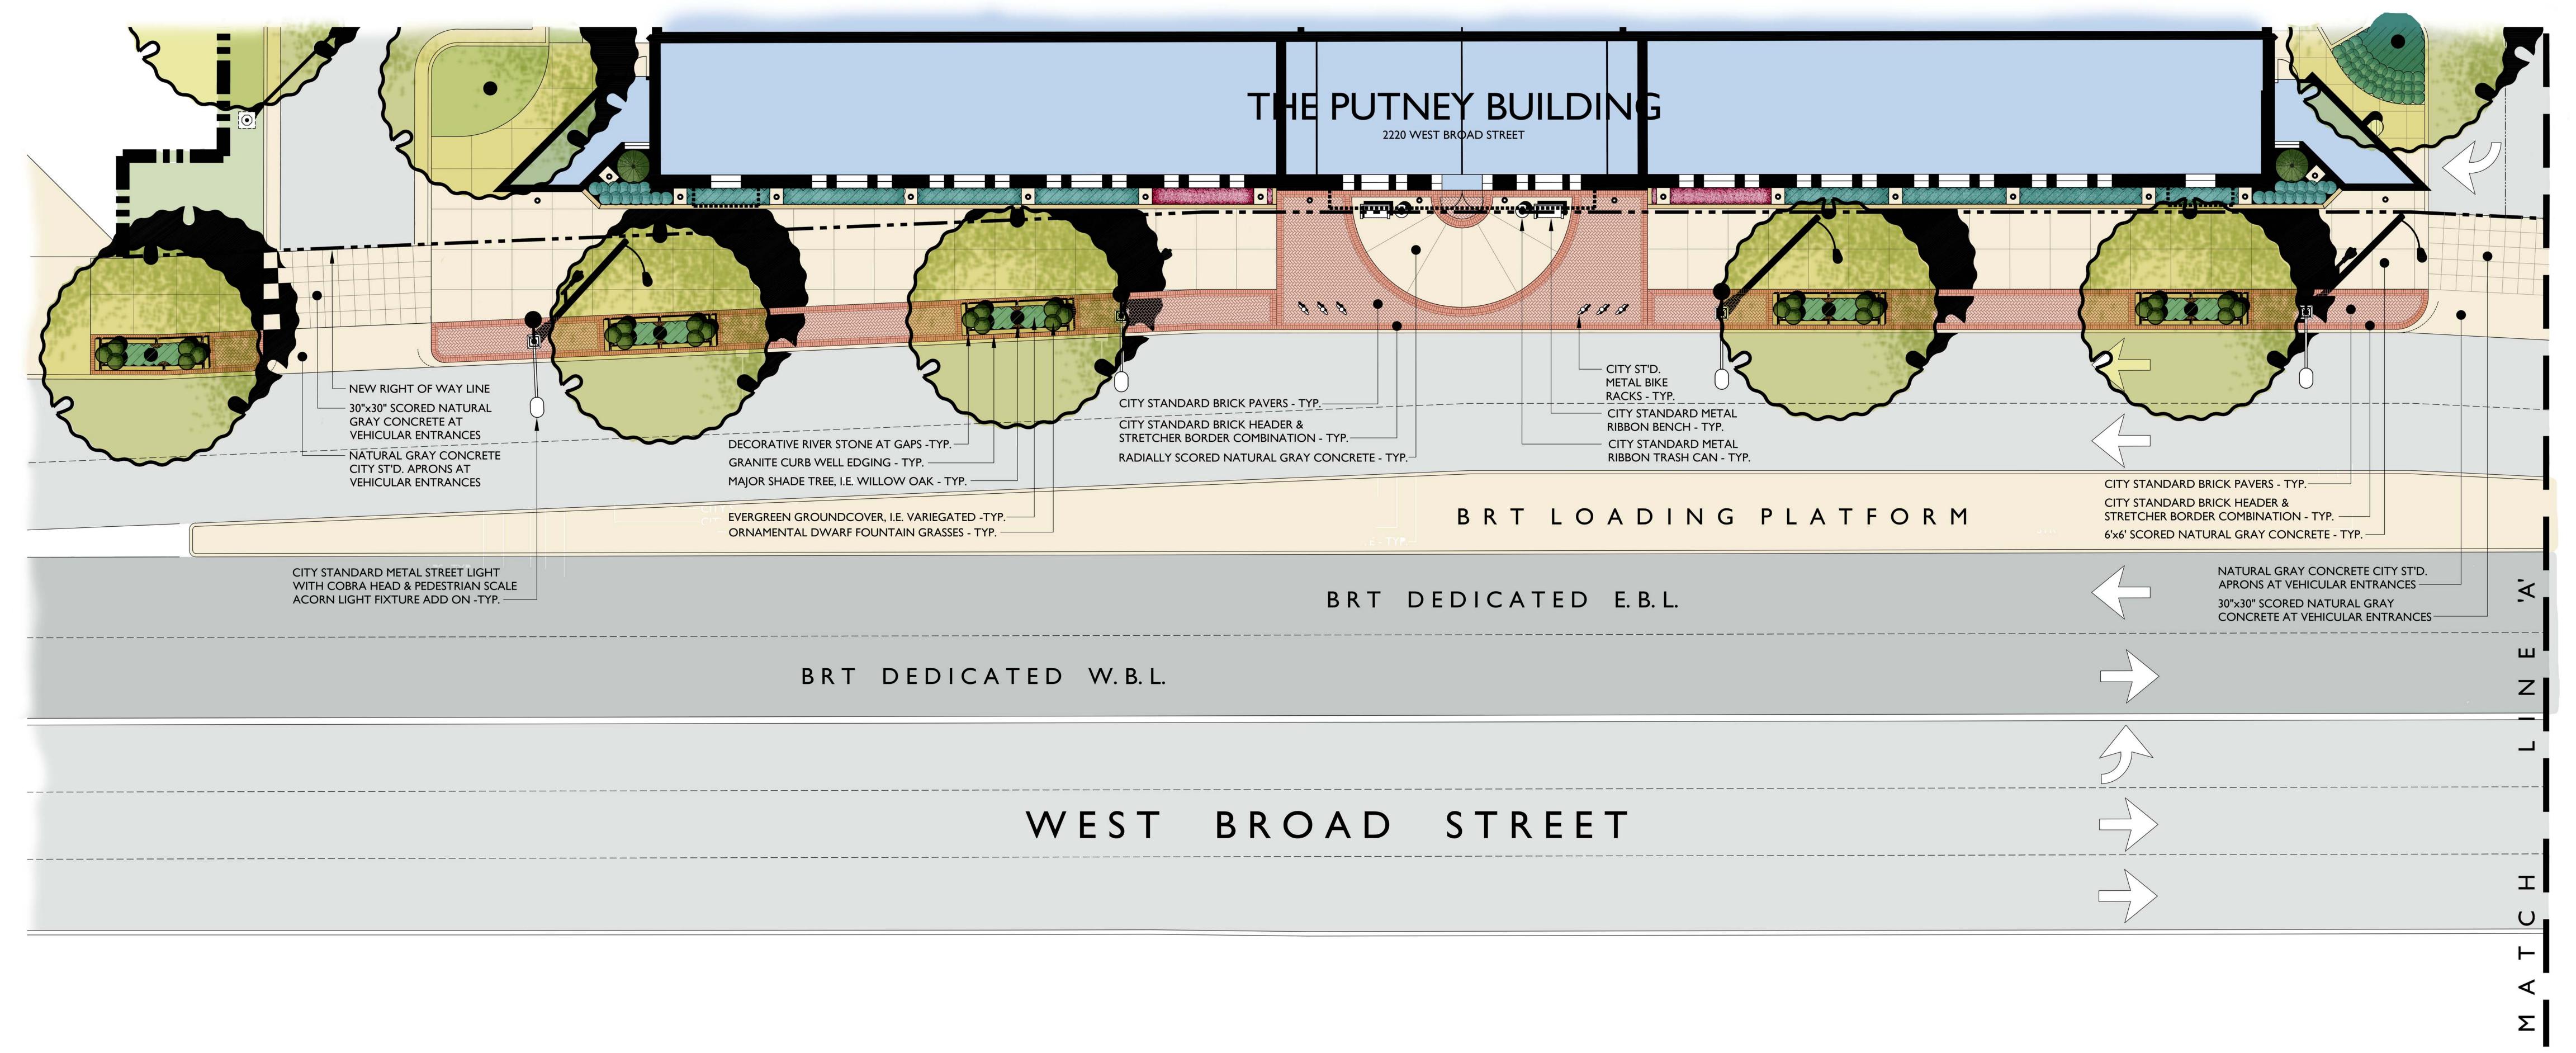

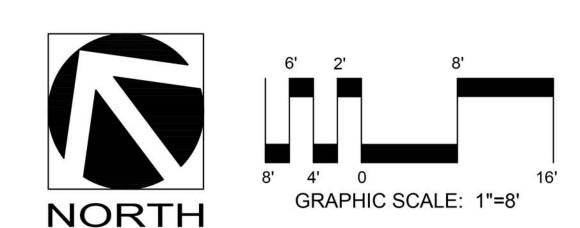

THE SAUER CENTER · illustrative streetscape plan

· I west



