# St. Luke Building

#### SITE DATA

OWNER/DEVELOPER: ST. LUKE BUILDING, LLC. C/O CHARLEY AYERS

3007 HAWTHORNE AVE RICHMOND, VA 23222 PHONE: (804) 358-4731 EMAIL: ericap@ayerslaw.com

ENGINEER: THE BAY COMPANIES, INC. C/O DANIEL CASKIE, P.E.

8500 BELL CREEK ROAD
MECHANICSVILLE, VA 23116
PHONE: (804) 569-7060

EMAIL: dan.caskie@thebaycompanies.com

MAP REFERENCE #(5): N0000107009(IN PART), N0000107010(IN PART), N0000107011, N0000107012, N0000107013,

N0000107014, N0000107015, N0000107022, N0000107023, N0000107024, N0000107025(IN PART),

N0000107025, N0000107027, N0000107025(IN PART), N0000107031(IN PART), N0000107031(IN PART),

N0000107032(IN PART), N0000107033(IN PART), N0000107034(IN PART), N0000107037(IN PART).

N0000107038

ADDRESS: 900 ST. JAMES STREET RICHMOND. VA 23222

ZONING: R-53

TRAFFIC ZONE: 1031

EXISTING USE: 409-B COMMERCIAL SHELL

PROPOSED USE: MULTI-FAMILY RESIDENTIAL

ACREAGE: TOTAL: 0.875 ACRES
RIGHT-OF-WAY: 0.000 ACRES

COMMON AREA: 0.000 ACRES LOTS: 0.875 ACRES

PROPOSED LOTS: 1 LOTS

WATER: PUBLIC

SEWER: PUBLIC

PUBLIC UTILITIES: UNDERGROUND


### TOPOGRAPHY

SOURCE: FIELD SURVEY
SURVEY DATE: FEBRUARY 2017

RESPONSIBLE PARTY: THE BAY COMPANIES: CEDRIC B. YOUNG, L.S

# 900 St. James Street

North District City of Richmond, Virginia

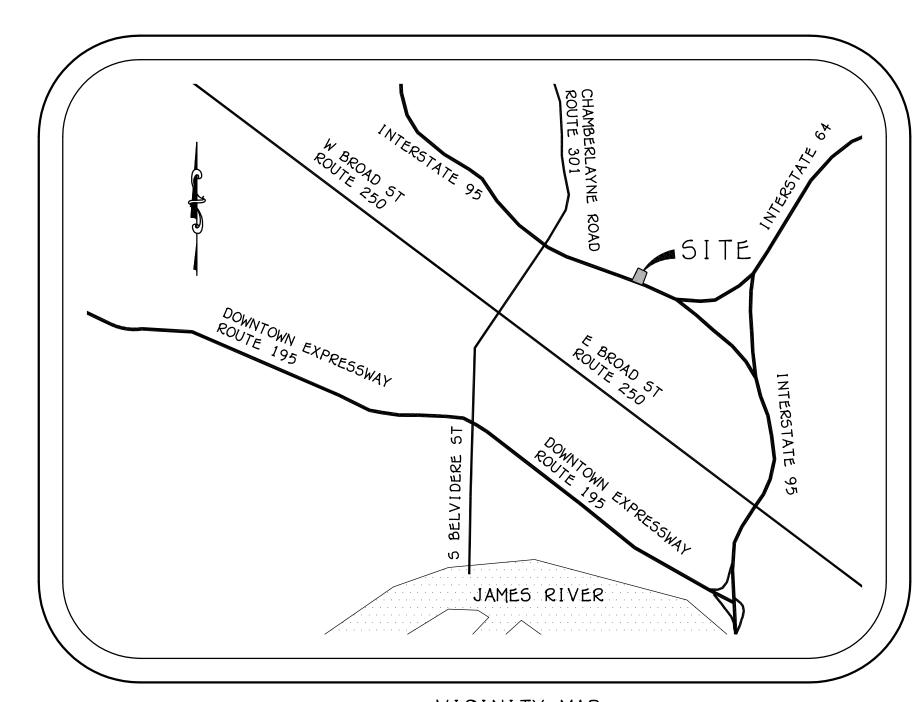

VICINITY MAP

SCALE: 1" = 2000'

### SHEET INDEX

C1 COVER SHEET
C2 LAYOUT & UTILITY AND GRADING & DRAINAGE
C3 OFFSITE STORM PLAN, PROFILE, AND CALCULATIONS
C4 BMP#1 CALCULATIONS AND DETAILS

C5 SITE DETAILS
C6 EROSION CONTROL NOTES AND DETAILS
C7 MINIMUM STANDARDS REG VALSCH

C7 MINIMUM STANDARDS PER VAESCH
C8 UTILITY DETAILS

L1 LANDSCAPE PLAN AND DETAILS

L2 LIGHTING PLAN
L3 LIGHTING DETAIL5

# APPROXIMATE UTILITY QUANTITIES WATER SEWER

> DOGHOUSE MANHOLE..... 1 EA

NOTE:
DRAINAGE AND UTILITY
QUANTITIES INCLUDE ALL ITEMS
LOCATED WITHIN CITY
RIGHT-OF-WAY AND PUBLIC
EASEMENTS.

# EROSION CONTROL QUANTITIES

 SILT FENCE
 499 LF

 INLET PROTECTION
 1 EA

 EC SEEDING a† \$2,200 /AC
 0.21 AC

 EC LAND DISTURBANCE a† \$2,100 /AC
 0.75 AC

NOTES

1. THIS PLAN WAS PREPARED BY A LICENSED PROFESSIONAL ENGINEER REGISTERED IN THE STATE OF

2. ALL EROSION AND SEDIMENT CONTROL MEASURES SHALL BE MAINTAINED AND THE PERMITTEE WILL INSPECT THE EROSION AND SEDIMENT CONTROL MEASURES AT LEAST ONCE EVERY TWO WEEKS AND WITHIN 40 HOURS OF A RAINSTORM EVENT DURING CONSTRUCTION TO ENSURE COMPLIANCE WITH THE APPROVED PLAN. RECORDS OF SELF-INSPECTION SHALL BE MAINTAINED ON THE SITE AND AVAILABLE FOR REVIEW BY COUNTY INSPECTORS.

3. THIS PROJECT COMPLIES WITH MINIMUM STANDARDS (MS) AS SET FORTH BY THE VIRGINIA DEPARTMENT OF CONSERVATION AND RECREATION.

#### ENVIRONMENTAL SITE ASSESSMENT

- 1. BASE FLOOD HAZARD AREAS SITE LIES IN ZONE "OTHER AREAS" PER THE FLOOD INSURANCE RATE MAP FOR CITY OF RICHMOND (PANEL 510129-0041E) DATED JULY 16, 2014.
- 2. NON-TIDAL WETLANDS DO NOT EXIST ON THIS SITE.
- 3. TIDAL WETLANDS DO NOT EXIST ON THIS SITE.
- 4. NO TIDAL SHORES EXIST ON THIS SITE.
- 5. NO TRIBUTARY OR NON-TRIBUTARY STREAMS EXIST ON THIS SITE.
  6. PROPERTY WITHIN THE LIMITS OF THIS SITE IS NOT LOCATED IN CHESAPEAKE BAY PRESERVATION AREA DESIGNATED BY THE CITY OF RICHMOND, VIRGINIA PURSUANT TO CHAPTER 14 OF THE CITY CODE OF

NOTE:
HORIZONTAL DATUM = NAD03
VERTICAL DATUM = NAVD00

FLOOR USE SUMMARY:
FOUR STORY BUILDING:
BASEMENT = STORAGE
1ST FLOOR = RESIDENTIAL/BUSINESS
2ND FLOOR = 4 RESIDENTIAL UNITS
3RD FLOOR = 4 RESIDENTIAL UNITS

4TH FLOOR = 4 RESIDENTIAL UNITS

TWO STORY BUILDING:

1ST FLOOR = VACANT

2ND FLOOR = VACANT

PARKING REQUIREMENTS:

1 SPACE PER RESIDENTIAL UNIT
REQUIRED = 12 SPACES

1 SPACE PER 300 SF OF OFFICE FOR FIRST 1,500 SF, PLUS 1 SPACE PER 400 SF IN EXCESS THEREOF REQUIRED = 7 SPACES

TOTAL REQUIRED = 19 SPACES

TOTAL PROVIDED = 37 SPACES (2 HANDICAP)

<u>BICYCLE</u> <u>REQUIREMENTS</u>: NUMBER OF DWELLING UNITS = 12

SHORT-TERM BICYCLE PARKING REQUIRED: NONE

LONG-TERM BICYCLE PARKING REQUIRED: 4 SPACES
LONG-TERM BICYCLE PARKING PROVIDED: 4 SPACES
(IN BASEMENT)

DATE SHEET NUMBERS

THIS DRAWING IS THE PROPERTY OF THE BAY COMPANIES INC. AND IS NOT TO BE REPRODUCED OR USED FOR ANY PROJECT IN WHOLE OR IN PART WITHOUT EXPRESS WRITTEN PERMISSION.

FILED:

16038\_cov

DATE: MARCH 13, 2017

REVISED:


OCTOBER 11, 2017

REVISED:
NOVEMBER 22, 2017

REVISED:

THE BAY COMPANIES

ENGINEERS

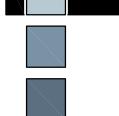

8500 BELL CREEK ROAD MECHANICSVILLE, VA 23116 (804) 569-7060 FAX: (804) 569-7061



PROJECT:

St. Luke Building

900 St. James Street

North District City of Richmond, Virginia


SHEET:


Cover Sheet


SHEET NO:

JOB NO.

16038

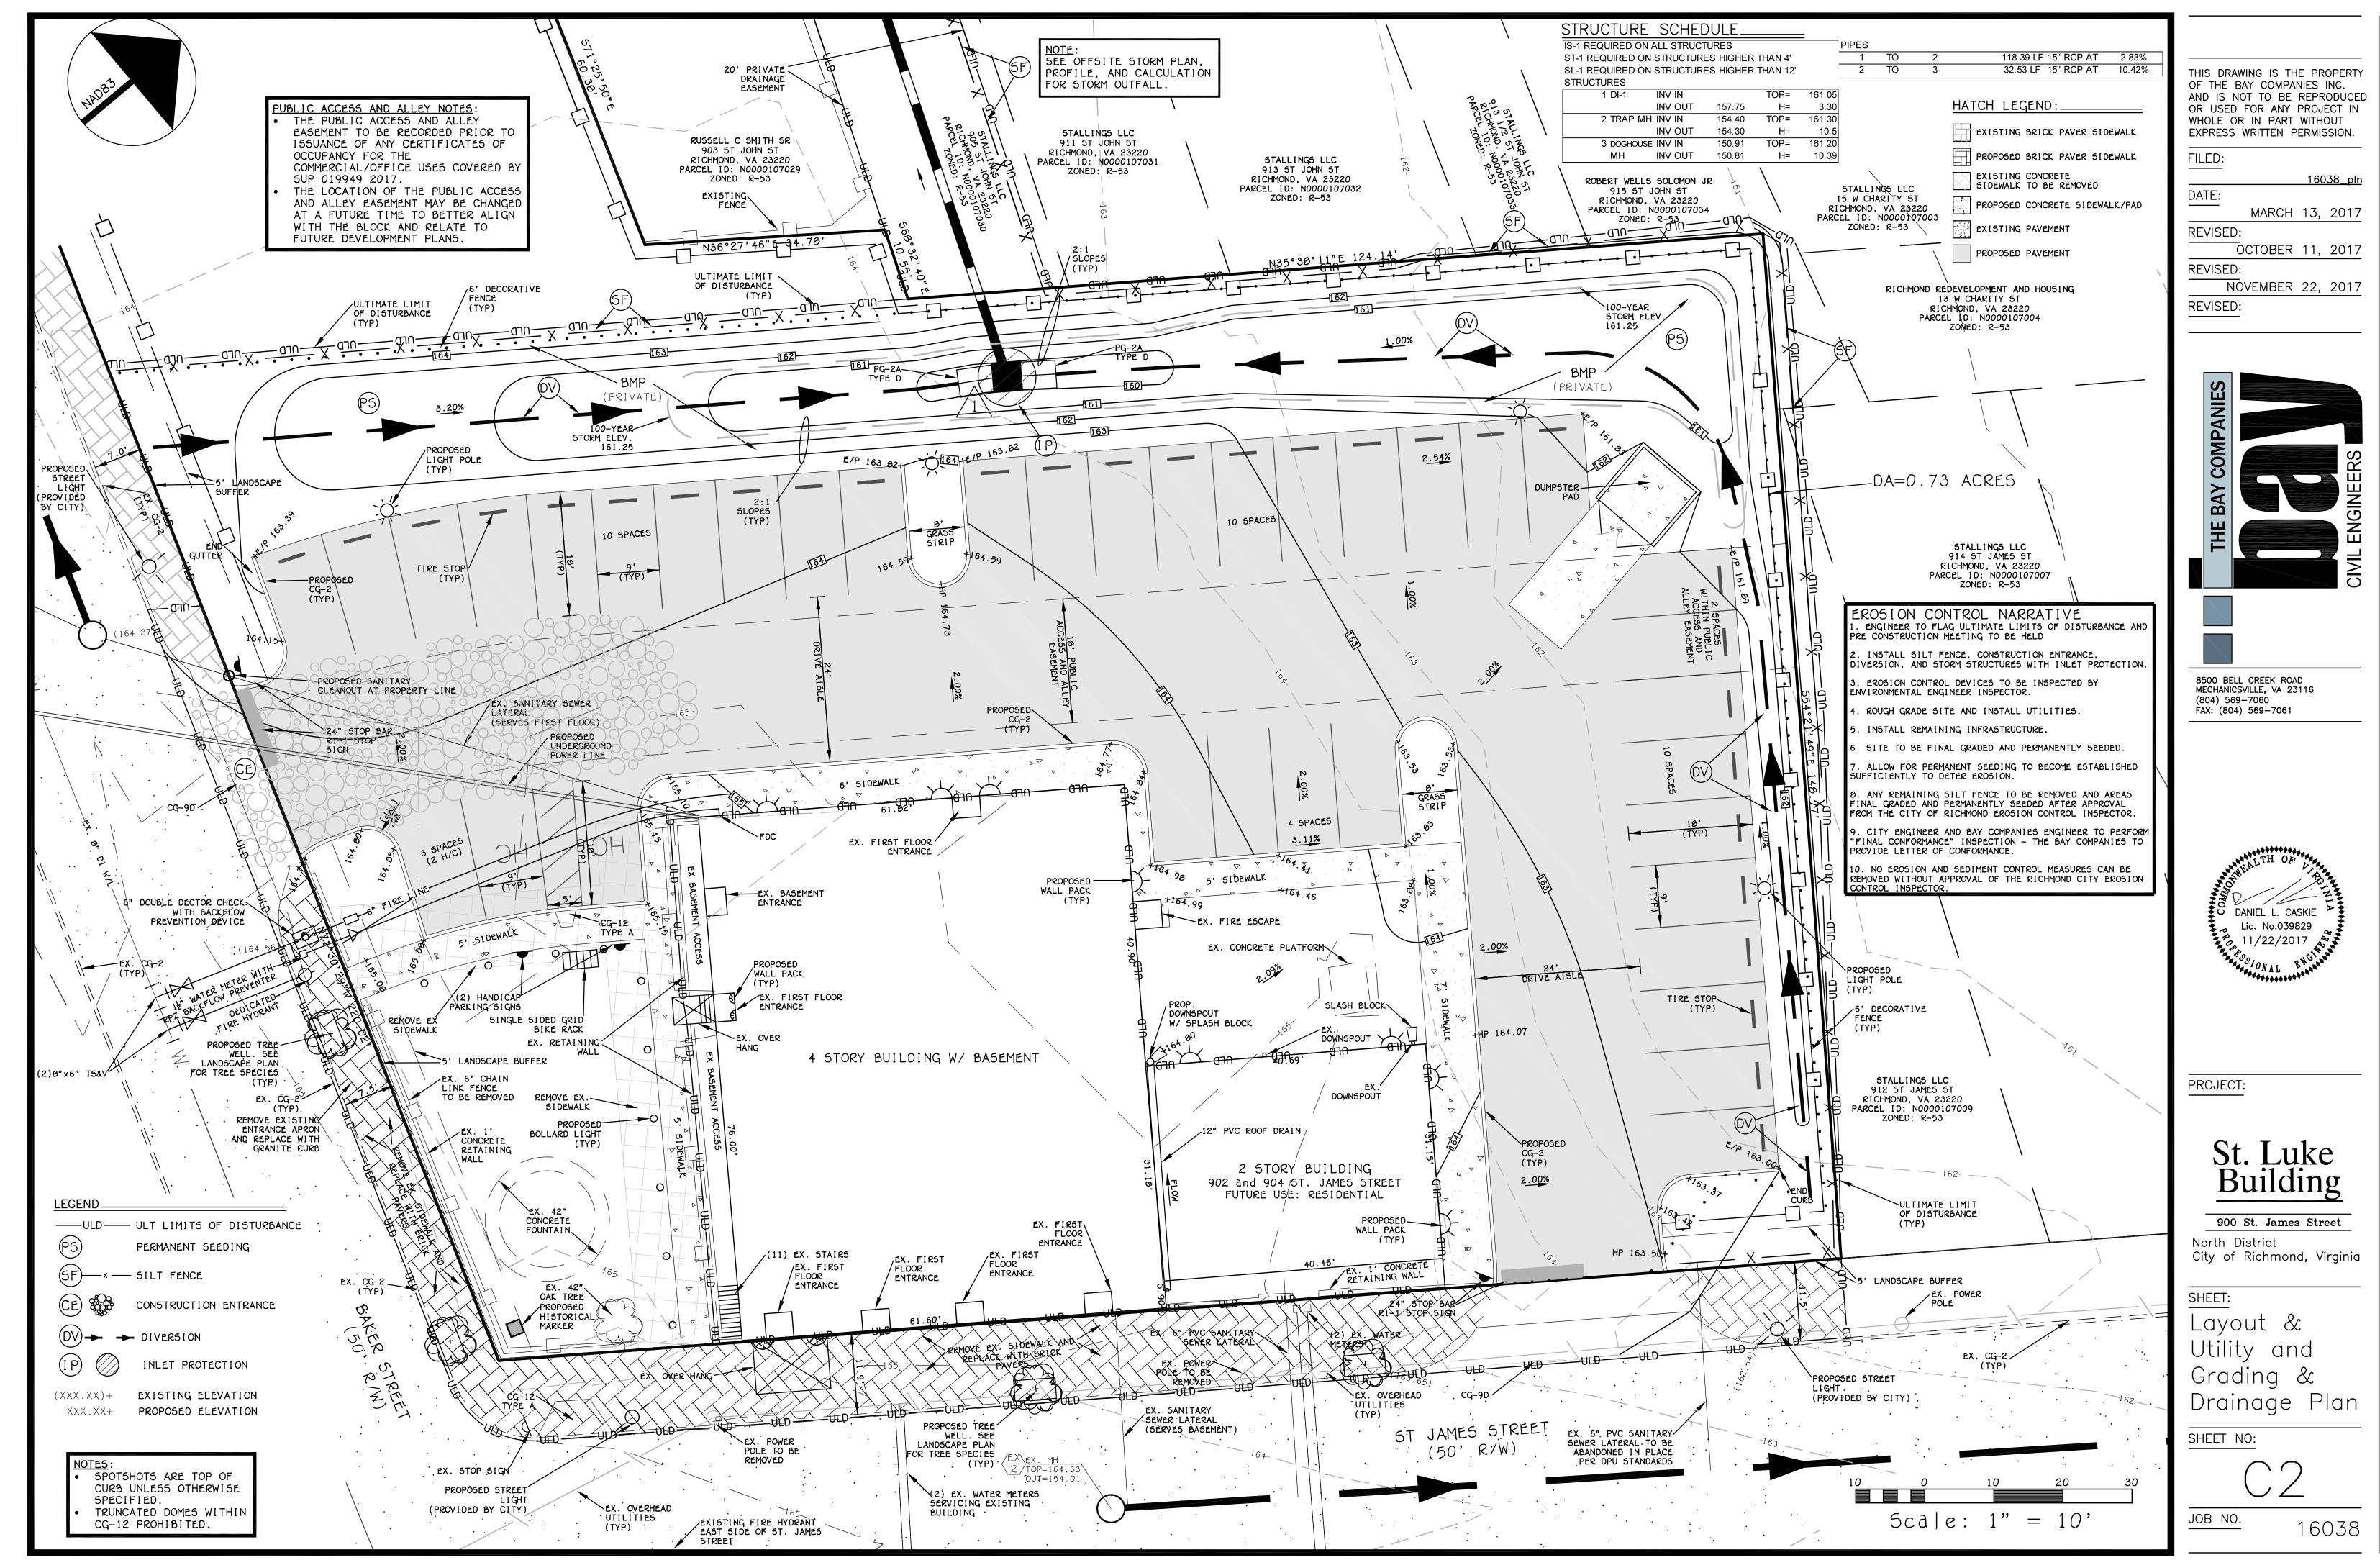

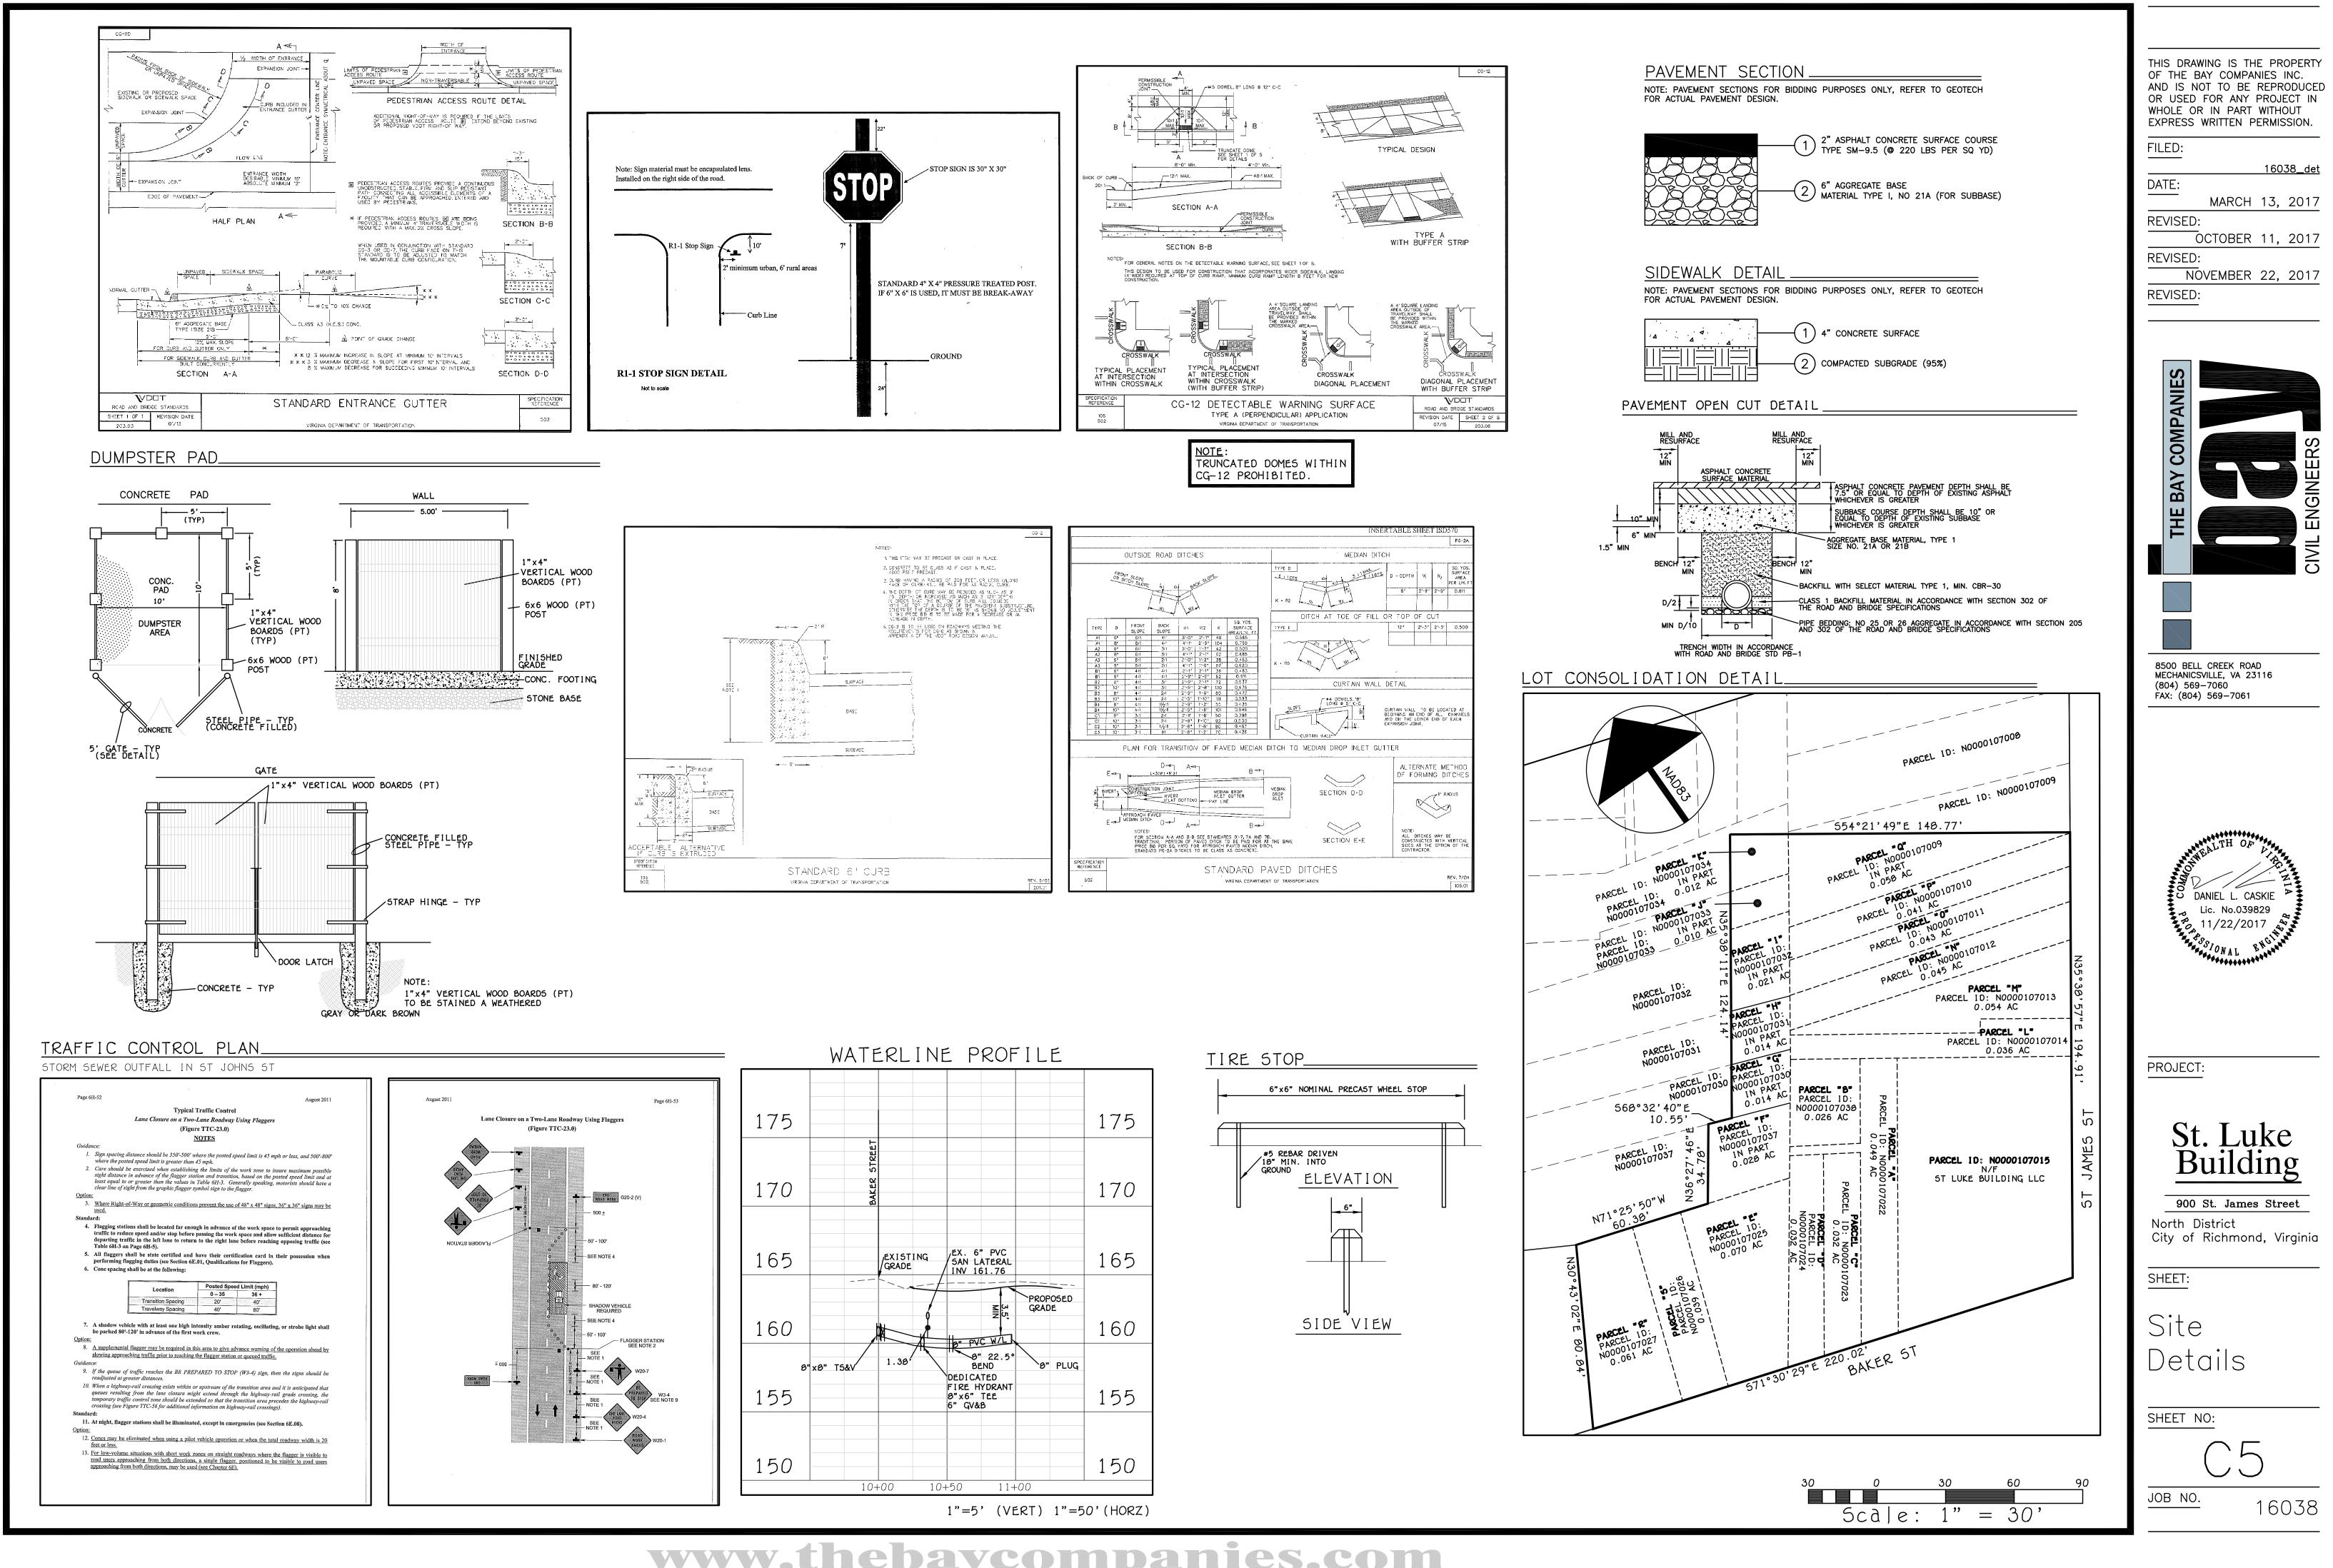

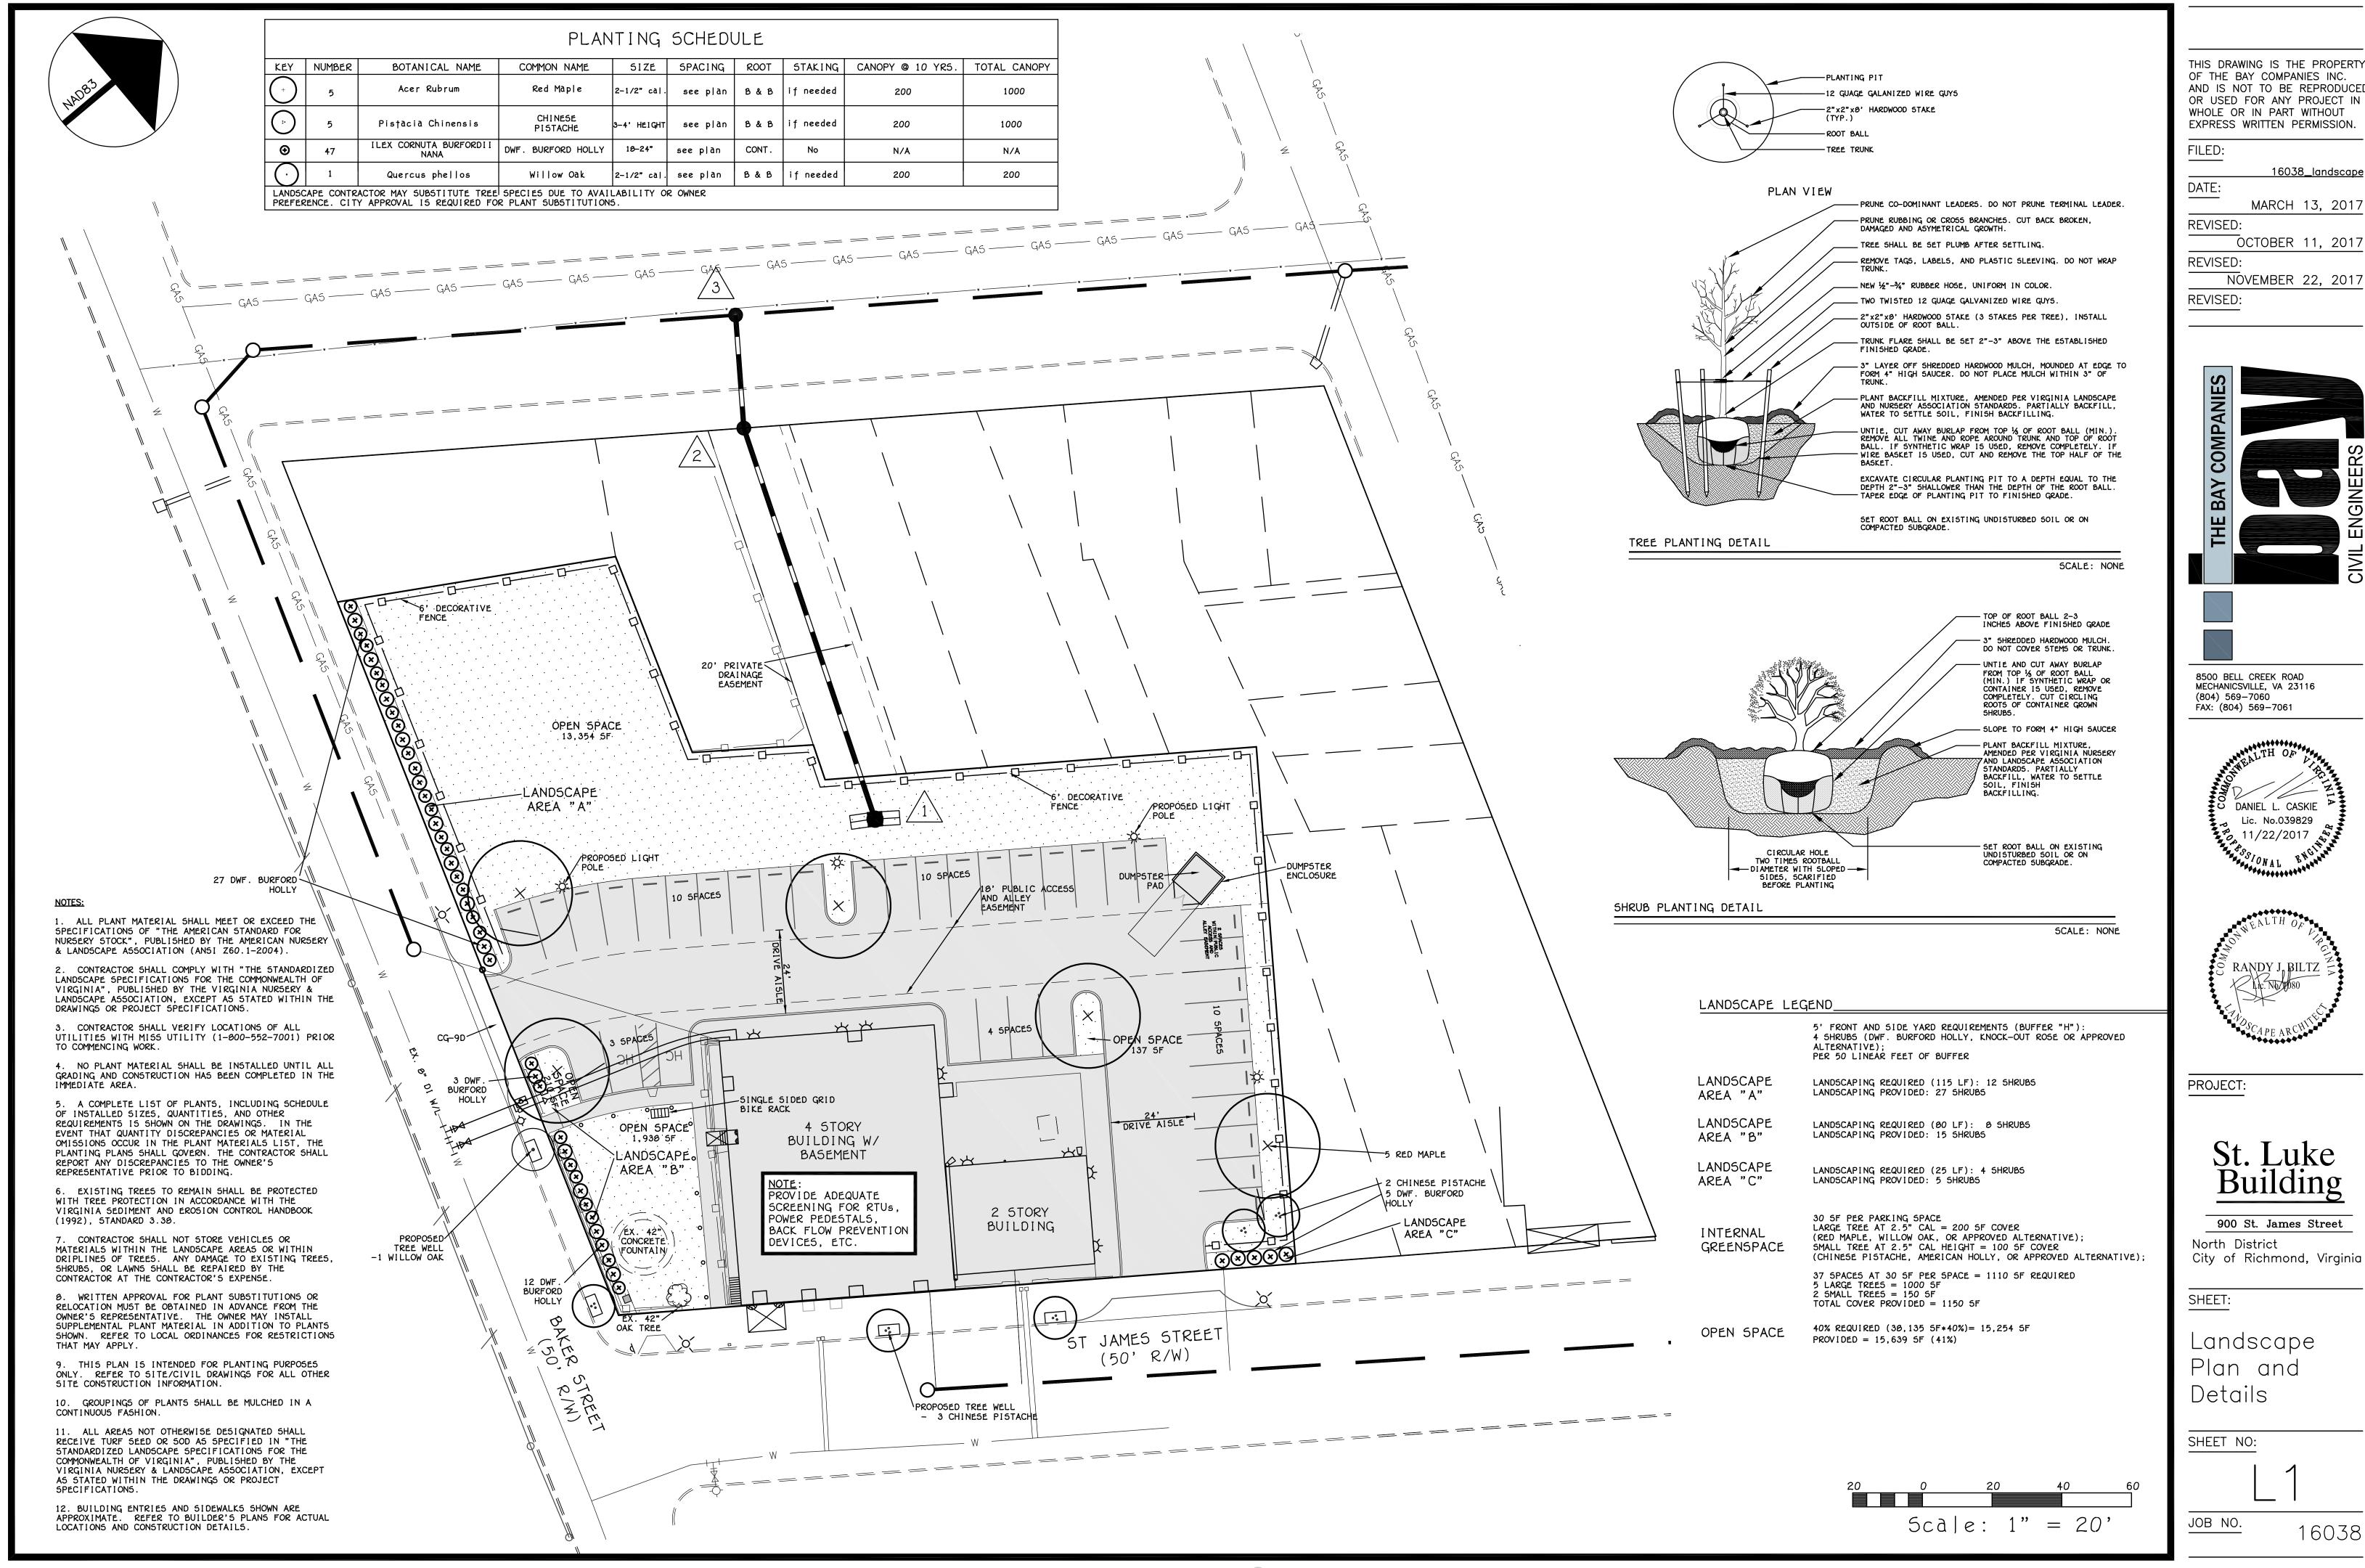


www.thebaycompanies.com

THIS DRAWING IS THE PROPERTY AND IS NOT TO BE REPRODUCED OR USED FOR ANY PROJECT IN

OCTOBER 11, 2017

NOVEMBER 22, 2017



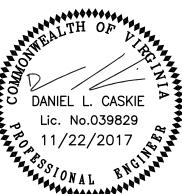



City of Richmond, Virginia

# ST LUKE BUILDING

# RICHMOND, VA 23220

ISSUE DATE

10/17/17

10/17/17

SHEET INDEX PERMIT RESPONSE 2

SHEET TITLE

NO.

COVER SHEET

COVER COVER SHEET

A2.04 ROOF PLAN

A3.00 EAST ELVATION

A3.01 WEST ELEVATION

A4.00 BUILDING SECTIONS

ST. LUKE - ARCHITECTURAL

A2.00 BASEMENT AND FIRST FLOOR PLANS

A2.02 THIRD AND FOURTH FLOOR PLANS

A3.02 NORTH AND SOUTH ELEVATIONS

A5.02 ENLARGED 2ND FLOOR LOFT PLAN

A5.05 ENLARGED 4TH FLOOR LOFT PLAN

A5.06 ENLARGED UNIT SECTIONS - 2ND FLOOR

A5.07 ENLARGED UNIT SECTIONS - 4TH FLOOR

A5.08 ENLARGED HALLWAY ELEVATIONS - NORTH

A5.09 ENLARGED HALLWAY ELEVATIONS - SOUTH

A5.00 ENLARGED 1ST FLOOR PLAN

A5.01 ENLARGED 2ND FLOOR PLAN

A5.03 ENLARGED 3RD FLOOR PLAN

A5.04 ENLARGED 4TH FLOOR PLAN

A2.01 SECOND AND SECOND FLOOR LOFT PLANS

A2.03 FOURTH FLOOR LOFT AND FIFTH FLOOR PLANS

# SPECIAL USE PERMIT OCTOBER 17, 2017





# <u>O W N E R</u>

MR. CHARLES AYERS
ST. LUKE BUILDING, LLC
710 N. HAMILTON STREET
RICHMOND, VA 23221-2035
PH: 804.358.4731

<u>ARCHITECT</u>

COMMONWEALTH ARCHITECTS, P.C.
101 SHOCKOE SLIP
RICHMOND, VIRGINIA 23219
PH: 804.648.5040
F: 804.225.0329

# STRUCTURAL ENGINEER

DUNBAR MILBY WILLIAMS PITTMAN & VAUGHAN, PLLC
CONSULTING STRUCTURAL ENGINEERS
1025 BOULDERS PARKWAY, SUITE 310
RICHMOND, VIRGINIA 23225
PH: 804.323.0656
F: 804.272.3916

MECHANICAL, ELECTRICAL, & PLUMBING ENGINEER

DUNLAP AND PARTNERS ENGINEERS
2112 W. LABURNUM AVE, SUITE 205
RICHMOND, VA 23227
PH: 804.358.9200

# Commonwealth ARCHITECTS

101 SHOCKOE SLIP, THIRD FLOOR RICHMOND, VIRGINIA 23219

TELEPHONE: 804.648.5040 FACSIMILE: 804.225.0329

© Commonwealth Architects expressly reserves its copyright and other common law property rights in and to these plans. These plans may not be altered, reproduced or copied, nor may they be assigned to any third party, without first obtaining the expressed written permission of Commonwealth Architects.

VOLUME 1

- 1. THIS IS A HISTORIC REHABILITATION TAX CREDIT PROJECT. ALL WORK MUST BE ACCORDANCE WITH THE SECRETARY OF THE INTERIOR'S STANDARDS FOR HISTORIC REHABILITATION.
- 2. DIMENSIONS NOTED AS 'ALIGN', 'HOLD', 'CLEAR', ARE TO TAKE PRECEDENCE OVER OTHER DIMENSIONS IN CASE OF DISCREPANCIES BETWEEN DRAWINGS AND ARE ALWAYS TO FINISH FACE. ALL OTHER DIMENSIONS ARE TO FACE OF STUD UNLESS NOTED OTHERWISE. CONTACT ARCHITECT FOR CLARIFICATION
- 3. DOORS SHALL BE LOCATED 4" FROM ADJACENT PARTITIONS (HINGE SIDE) UNLESS NOTED
- 4. ALL PARTITIONS ARE TO BE PARTITION TYPE 1 UNLESS NOTED OTHERWISE. REFER TO SHEET A0.01 FOR WALL TYPES.
- 5. ALL TRANSITIONS OF FLOORING SHALL OCCUR @ CENTER LINE OF DOOR OPENINGS UNLESS NOTED OTHERWISE.
- 6. USE 1/2" WATER RESISTANT GWB IN ALL BATHROOMS UNLESS NOTE OTHERWISE. USE
- 7. ALL AREAS THAT INDICATE NEW INSULATION MUST MEET CURRENT IECC STANDARDS.
- 8. REFER TO ELEVATIONS FOR EXISTING AND NEW WINDOW INFORMATION
- 9. PATCH AND REPAIR EXISTING HISTORIC PLASTER WHERE IT HAS BEEN PREVIOUSLY REMOVED OR WHERE DAMAGED. SEE NPS BRIEF FOR METHODOLOGY
- 10. INTERIOR DEPTH DIMENSION OF CLOSETS TO BE 2'- 0" MINIMUM

CEMENT BACKER BOARD @ ALL TILE LOCATIONS

- 11. REPAIR AND RESTORE PLASTER AT ALL EXTERIOR WALLS, HISTORIC INTERIOR WALLS, AND AT THE FIRST AND THIRD FLOOR CEILING.
- 12. AVOID REFINISHING FLOORS IN HISTORIC AREAS, CLEAN LIGHTLY. SAND ONLY AS NECESSARY AND OIL FLOOR BOARDS INSTEAD

# CONSTRUCTION KEY NOTES - 🗴

- 1 EXISTING VAULT TO REMAIN
- 2 REPAIR AND PAINT EXISTING WAINSCOTING AT EXTERIOR WALLS AND HISTORIC PLASTER INTERIOR WALLS TYP. THROUGHOUT
- 3 REPAIR EXISTING WOOD JOISTS TO MAKE FLOOR STRUCTUALLY SOUND SEE STRUCTURAL
- 4 NEW CONCRETE STAIR AND LANDING AT EXISTING ENTRY SEE STRUCTURAL FOR
- DETAILS 5 REPAIR EXISTING CANOPY
- 6 NEW METAL GUARD RAIL AND HANDRAIL AT ENTRY
- 7 RAISE EXISTING HISTORIC HANDRAIL TO CODE COMPLIANT HEIGHT
- 8 REPAIR AND PAINT EXISTING HISTORIC RAIL/GUARDRAIL 9 NEW LOFT FLOOR AT CONSTRUCTED OUT OF LIGHT GAGE FRAMING - SEE STRUCTURAL
- 10 NEW STAIR IN THIS LOCATION.
- 11 NEW INTERIOR WOOD WINDOW AT BEDROOM WALL
- 12 EXISTING HISTORIC WALL AND TRANSOM WINDOWS TO BE RESTORED AND PAINTED
- 13 EXISTING HISTORIC EXTERIOR STOREFRONT TO BE RESTORED SEE SPECIFICATIONS FOR ALLOWABLE RESTORATION METHODS
- 14 RESTORE AND REPAIR EXISTING DECORATIVE CORNICE
- 15 RESTORE EXISTING BUILT-IN GUTTER
- 16 INSTALL NEW ALUMINUM 4" DOWNSPUT
- 17 NEW MEMBRANE ROOF ON 1/2" COVER BOARD AND (2) LAYERS OF 2" POLYISO INSULATION
- 18 REPAIR AND PAINT EXISTING WOOD DENTAL MOLDING
- 19 EXISTING FIRE ESCAPE DOORS TO REMAIN AND BE FIXED IN PLACE SO THAT THEY ARE NOT OPERABLE. DOORS TO BE REPAIRED AND REPAINTED. EXISTING WIRE GLASS TO BE
- REPAIRED AS NECESSARY. 20 INSTALL NEW WOOD WINDOW IN EXISTING LOCATION 21 INSPECT EXISTING MASONRY AFTER REMOVAL OF INVASIVE VEGETATION. REPAINT AND
- REPAIR BRICK AND MORTAR. MATCH SURROUNDING MORTAR IN MATERIAL, COMPOSITION, COLOR, AGGREGATE, & HARDNESS.
- 22 INSTALL SALVAGED TIN CEILING. SEE REFLECTED CEILING PLANS FOR MORE DETAILS.
- 23 EXISTING VAULT DOOR TO BE OPENED AND FIXED IN PLACE 24 NEW WOOD WINDOW IN INDICATED LOCATION. WINDOW TO MATCH EXISTING
- ADJACENT WINDOWS IN TYPE AND PROFILE
- 25 NEW ROOF ACCESS HATCH & LADDER SEE SHEET A2.05 FOR DETAILS
- 26 EXISTING INTERIOR STOREFRONT TO REAMIN
- 27 EXISTING HISTORIC TELLER PARTITIONS AND STOREFRONT TO REMAIN
- 28 CLEAN AND POLISH EXISTING HISTORIC TILE FLOORS.
- 29 EXISTING DOOR TO REMAIN AND FIXED IN PLACE SO THAT THEY ARE NOT OPERABLE
- 30 EXISTING WOOD DOORS TO BE REPAIRED, RECEIVE NEW HARDWARE, PAINTED, AND RESTORED TO WORKING ORDER - SEE DOOR SCHEDULE FOR MORE INFORMATION
- 31 INSPECT EXISTING FLUE SHAFTS AND REPAIR BRICK AS NECESSARRY TO MAINTAIN A WATER TIGHT ASSEMBLY

STORAGE 1

STORAGE 2

INTERIOR WALL

MOUNTED BICYCLE

STAIR 4

STORAGE 3

30

32 INSTALL NEW FLUE CAP

TOOTH IN NEW BRICK TO

CORRIDOR

2 A3.02

EXISTING VAULT


REPAIR EXISTING HOLE


MECHANICAL ROOM

BASEMENT

A2.00 SCALE: 3/16" = 1'-0"

- 33 NEW DRYER VENT EXHAUST OPENING
- 34 REPAIR AND RESTORE EXISTING HARDWOOD FLOOR AS NECESSARY AND CREATE ONE HOUR FLOOR/CEILING ASSEMBLY - SEE SPECIFICATIONS AND SHEET A0.01 FOR MORE INFORMATION

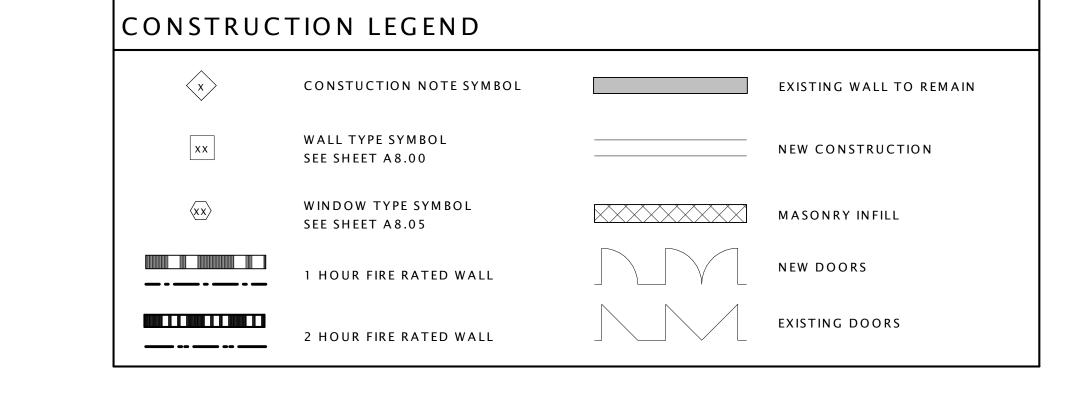

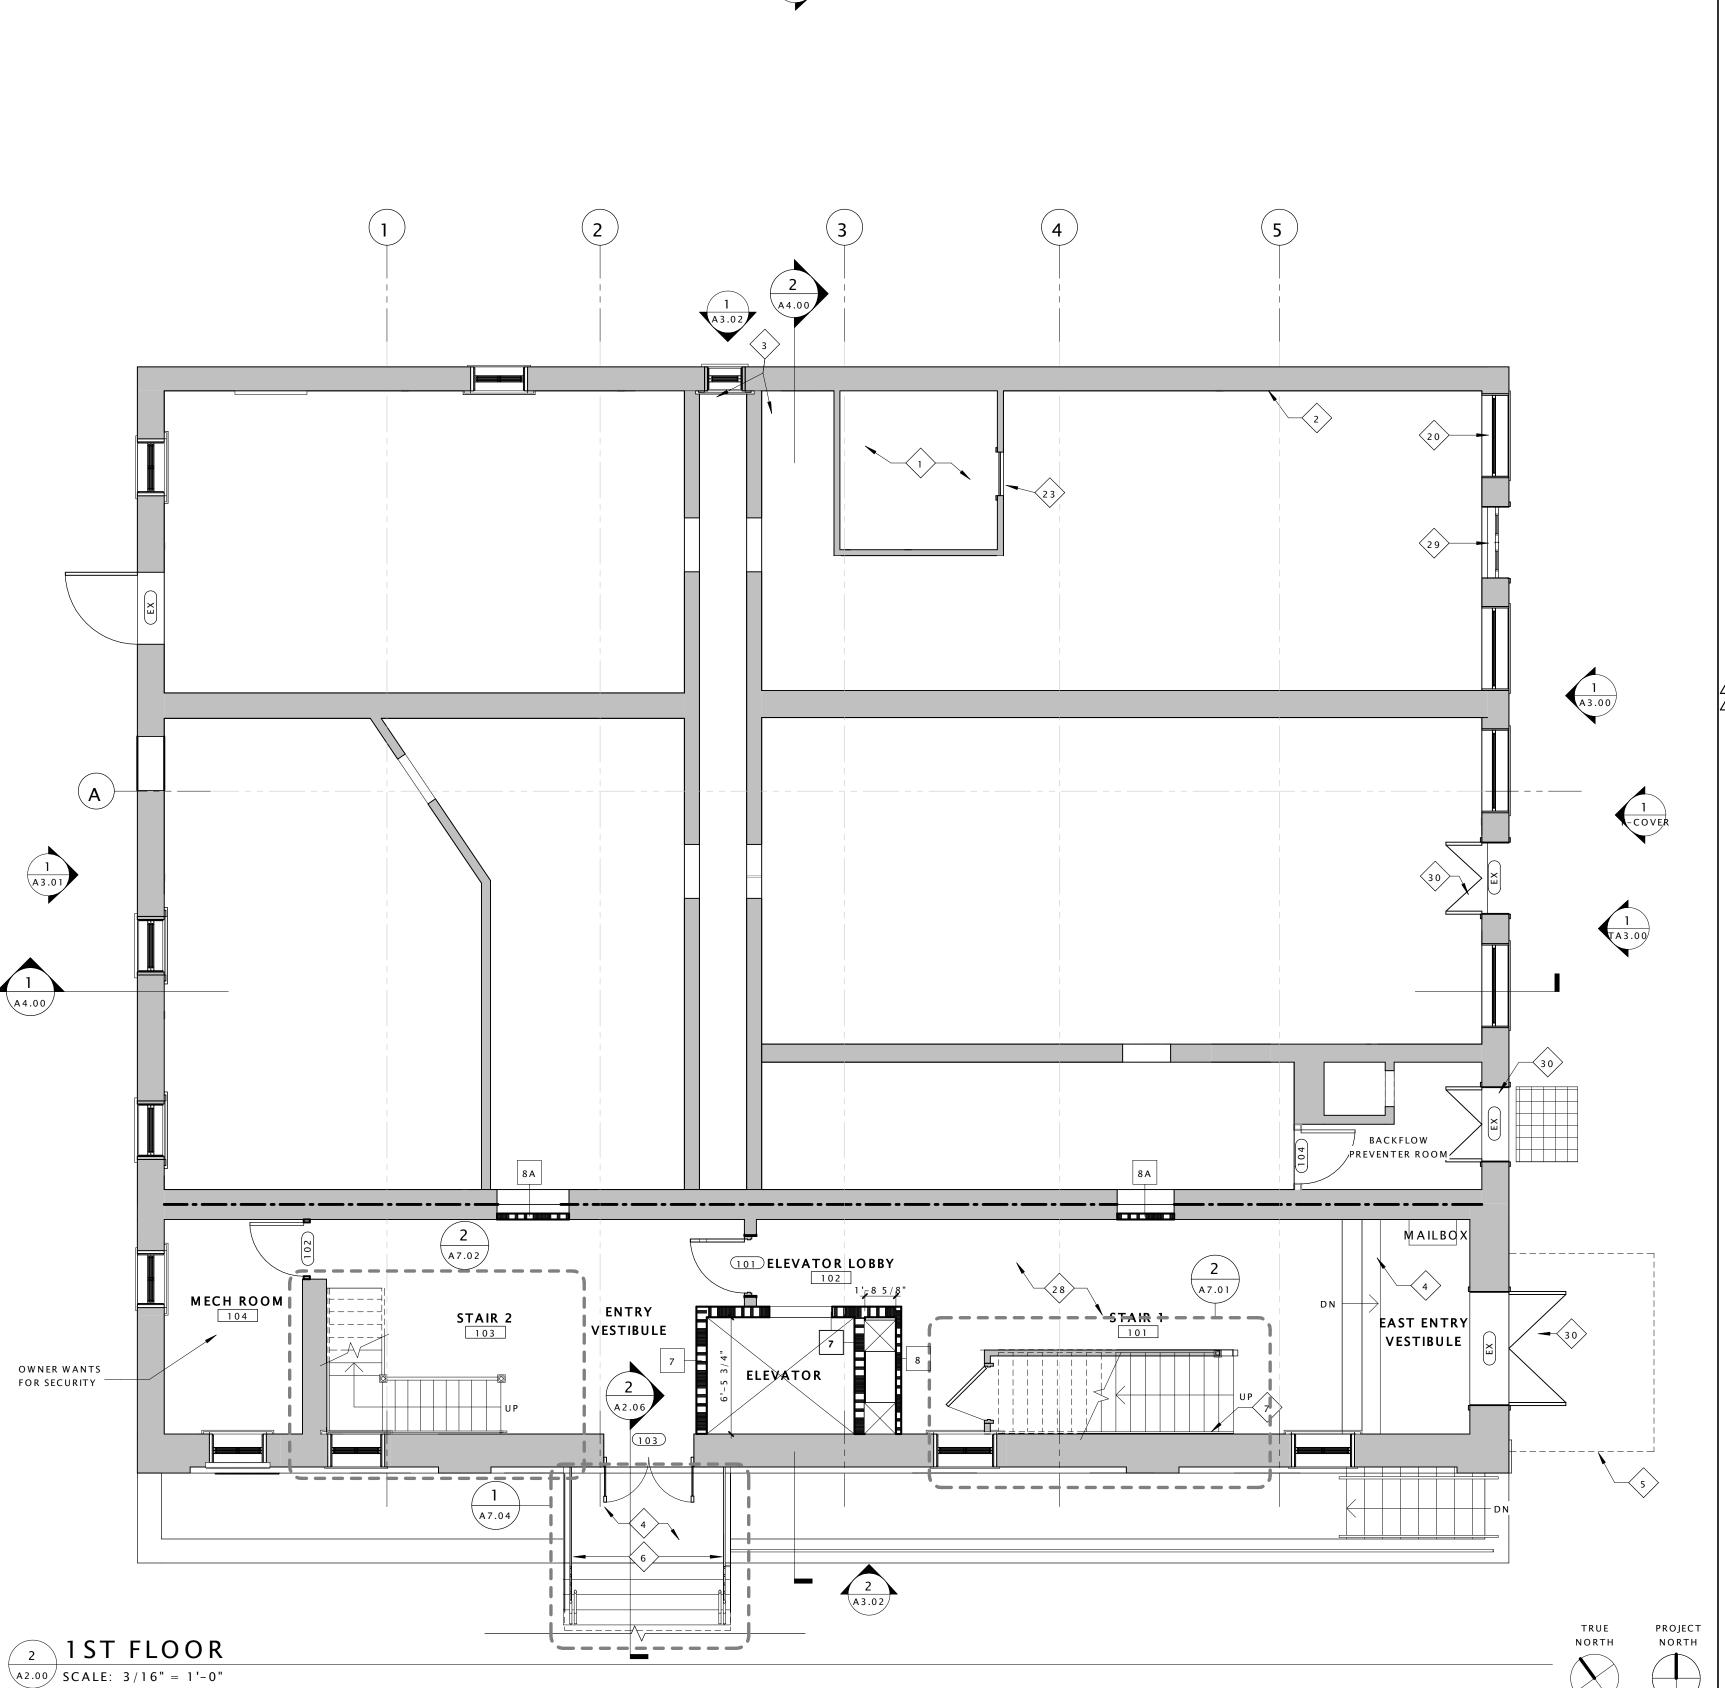

DHR PART II SUBMISSION 10.26.16 PERMIT SET DHR PART II AMENDMENT I PERMIT SET RESPONSE

BASEMENT AND FIRST FLOOR PLANS

Drawing Title

- 1. THIS IS A HISTORIC REHABILITATION TAX CREDIT PROJECT. ALL WORK MUST BE ACCORDANCE WITH THE SECRETARY OF THE INTERIOR'S STANDARDS FOR HISTORIC REHABILITATION.
- 2. DIMENSIONS NOTED AS 'ALIGN', 'HOLD', 'CLEAR', ARE TO TAKE PRECEDENCE OVER OTHER DIMENSIONS IN CASE OF DISCREPANCIES BETWEEN DRAWINGS AND ARE ALWAYS TO FINISH FACE. ALL OTHER DIMENSIONS ARE TO FACE OF STUD UNLESS NOTED OTHERWISE. CONTACT ARCHITECT FOR CLARIFICATION
- 3. DOORS SHALL BE LOCATED 4" FROM ADJACENT PARTITIONS (HINGE SIDE) UNLESS NOTED OTHERWISE.
- 4. ALL PARTITIONS ARE TO BE PARTITION TYPE 1 UNLESS NOTED OTHERWISE. REFER TO SHEET A0.01 FOR WALL TYPES.
- ALL TRANSITIONS OF FLOORING SHALL OCCUR @ CENTER LINE OF DOOR OPENINGS UNLESS NOTED OTHERWISE.
- 6. USE 1/2" WATER RESISTANT GWB IN ALL BATHROOMS UNLESS NOTE OTHERWISE. USE CEMENT BACKER BOARD @ ALL TILE LOCATIONS
- 7. ALL AREAS THAT INDICATE NEW INSULATION MUST MEET CURRENT IECC STANDARDS.
- 8. REFER TO ELEVATIONS FOR EXISTING AND NEW WINDOW INFORMATION
- 9. PATCH AND REPAIR EXISTING HISTORIC PLASTER WHERE IT HAS BEEN PREVIOUSLY REMOVED OR WHERE DAMAGED. SEE NPS BRIEF FOR METHODOLOGY
- 10. INTERIOR DEPTH DIMENSION OF CLOSETS TO BE 2'- 0" MINIMUM
- 11. REPAIR AND RESTORE PLASTER AT ALL EXTERIOR WALLS, HISTORIC INTERIOR WALLS, AND AT THE FIRST AND THIRD FLOOR CEILING.
- 12. AVOID REFINISHING FLOORS IN HISTORIC AREAS, CLEAN LIGHTLY. SAND ONLY AS NECESSARY AND OIL FLOOR BOARDS INSTEAD

# CONSTRUCTION KEY NOTES - 🗴

- 1 EXISTING VAULT TO REMAIN
- 2 REPAIR AND PAINT EXISTING WAINSCOTING AT EXTERIOR WALLS AND HISTORIC PLASTER
- INTERIOR WALLS TYP. THROUGHOUT

  3 REPAIR EXISTING WOOD JOISTS TO MAKE FLOOR STRUCTUALLY SOUND SEE
- STRUCTURAL

  4 NEW CONCRETE STAIR AND LANDING AT EXISTING ENTRY SEE STRUCTURAL FOR
- DETAILS


  5 REPAIR EXISTING CANOPY
- 6 NEW METAL GUARD RAIL AND HANDRAIL AT ENTRY
- 7 RAISE EXISTING HISTORIC HANDRAIL TO CODE COMPLIANT HEIGHT
- 8 REPAIR AND PAINT EXISTING HISTORIC RAIL/GUARDRAIL
- 9 NEW LOFT FLOOR AT CONSTRUCTED OUT OF LIGHT GAGE FRAMING SEE STRUCTURAL FOR DETAILS
- 10 NEW STAIR IN THIS LOCATION.
- 11 NEW INTERIOR WOOD WINDOW AT BEDROOM WALL
- 12 EXISTING HISTORIC WALL AND TRANSOM WINDOWS TO BE RESTORED AND PAINTED
- 13 EXISTING HISTORIC EXTERIOR STOREFRONT TO BE RESTORED SEE SPECIFICATIONS FOR ALLOWABLE RESTORATION METHODS
- 14 RESTORE AND REPAIR EXISTING DECORATIVE CORNICE
- 15 RESTORE EXISTING BUILT-IN GUTTER
- 16 INSTALL NEW ALUMINUM 4" DOWNSPUT
- 17 NEW MEMBRANE ROOF ON 1/2" COVER BOARD AND (2) LAYERS OF 2" POLYISO INSULATION
- 18 REPAIR AND PAINT EXISTING WOOD DENTAL MOLDING
- 19 EXISTING FIRE ESCAPE DOORS TO REMAIN AND BE FIXED IN PLACE SO THAT THEY ARE NOT OPERABLE. DOORS TO BE REPAIRED AND REPAINTED. EXISTING WIRE GLASS TO BE REPAIRED AS NECESSARY.
- 20 INSTALL NEW WOOD WINDOW IN EXISTING LOCATION
  21 INSPECT EXISTING MASONRY AFTER REMOVAL OF INVASIVE VEGETATION. REPAINT AND


REPAIR BRICK AND MORTAR. MATCH SURROUNDING MORTAR IN MATERIAL,


- COMPOSITION, COLOR, AGGREGATE, & HARDNESS.

  22 INSTALL SALVAGED TIN CEILING. SEE REFLECTED CEILING PLANS FOR MORE DETAILS.
- 23 EXISTING VAULT DOOR TO BE OPENED AND FIXED IN PLACE
- 24 NEW WOOD WINDOW IN INDICATED LOCATION. WINDOW TO MATCH EXISTING
- ADJACENT WINDOWS IN TYPE AND PROFILE
- 25 NEW ROOF ACCESS HATCH & LADDER SEE SHEET A2.05 FOR DETAILS
- 26 EXISTING INTERIOR STOREFRONT TO REAMIN
- 27 EXISTING HISTORIC TELLER PARTITIONS AND STOREFRONT TO REMAIN
- 28 CLEAN AND POLISH EXISTING HISTORIC TILE FLOORS.
- 29 EXISTING DOOR TO REMAIN AND FIXED IN PLACE SO THAT THEY ARE NOT OPERABLE
- 30 EXISTING WOOD DOORS TO BE REPAIRED, RECEIVE NEW HARDWARE, PAINTED, AND RESTORED TO WORKING ORDER SEE DOOR SCHEDULE FOR MORE INFORMATION
- 31 INSPECT EXISTING FLUE SHAFTS AND REPAIR BRICK AS NECESSARRY TO MAINTAIN A
- WATER TIGHT ASSEMBLY

  32 INSTALL NEW FLUE CAP
- 33 NEW DRYER VENT EXHAUST OPENING
- 34 REPAIR AND RESTORE EXISTING HARDWOOD FLOOR AS NECESSARY AND CREATE ONE HOUR FLOOR/CEILING ASSEMBLY SEE SPECIFICATIONS AND SHEET A0.01 FOR MORE INFORMATION

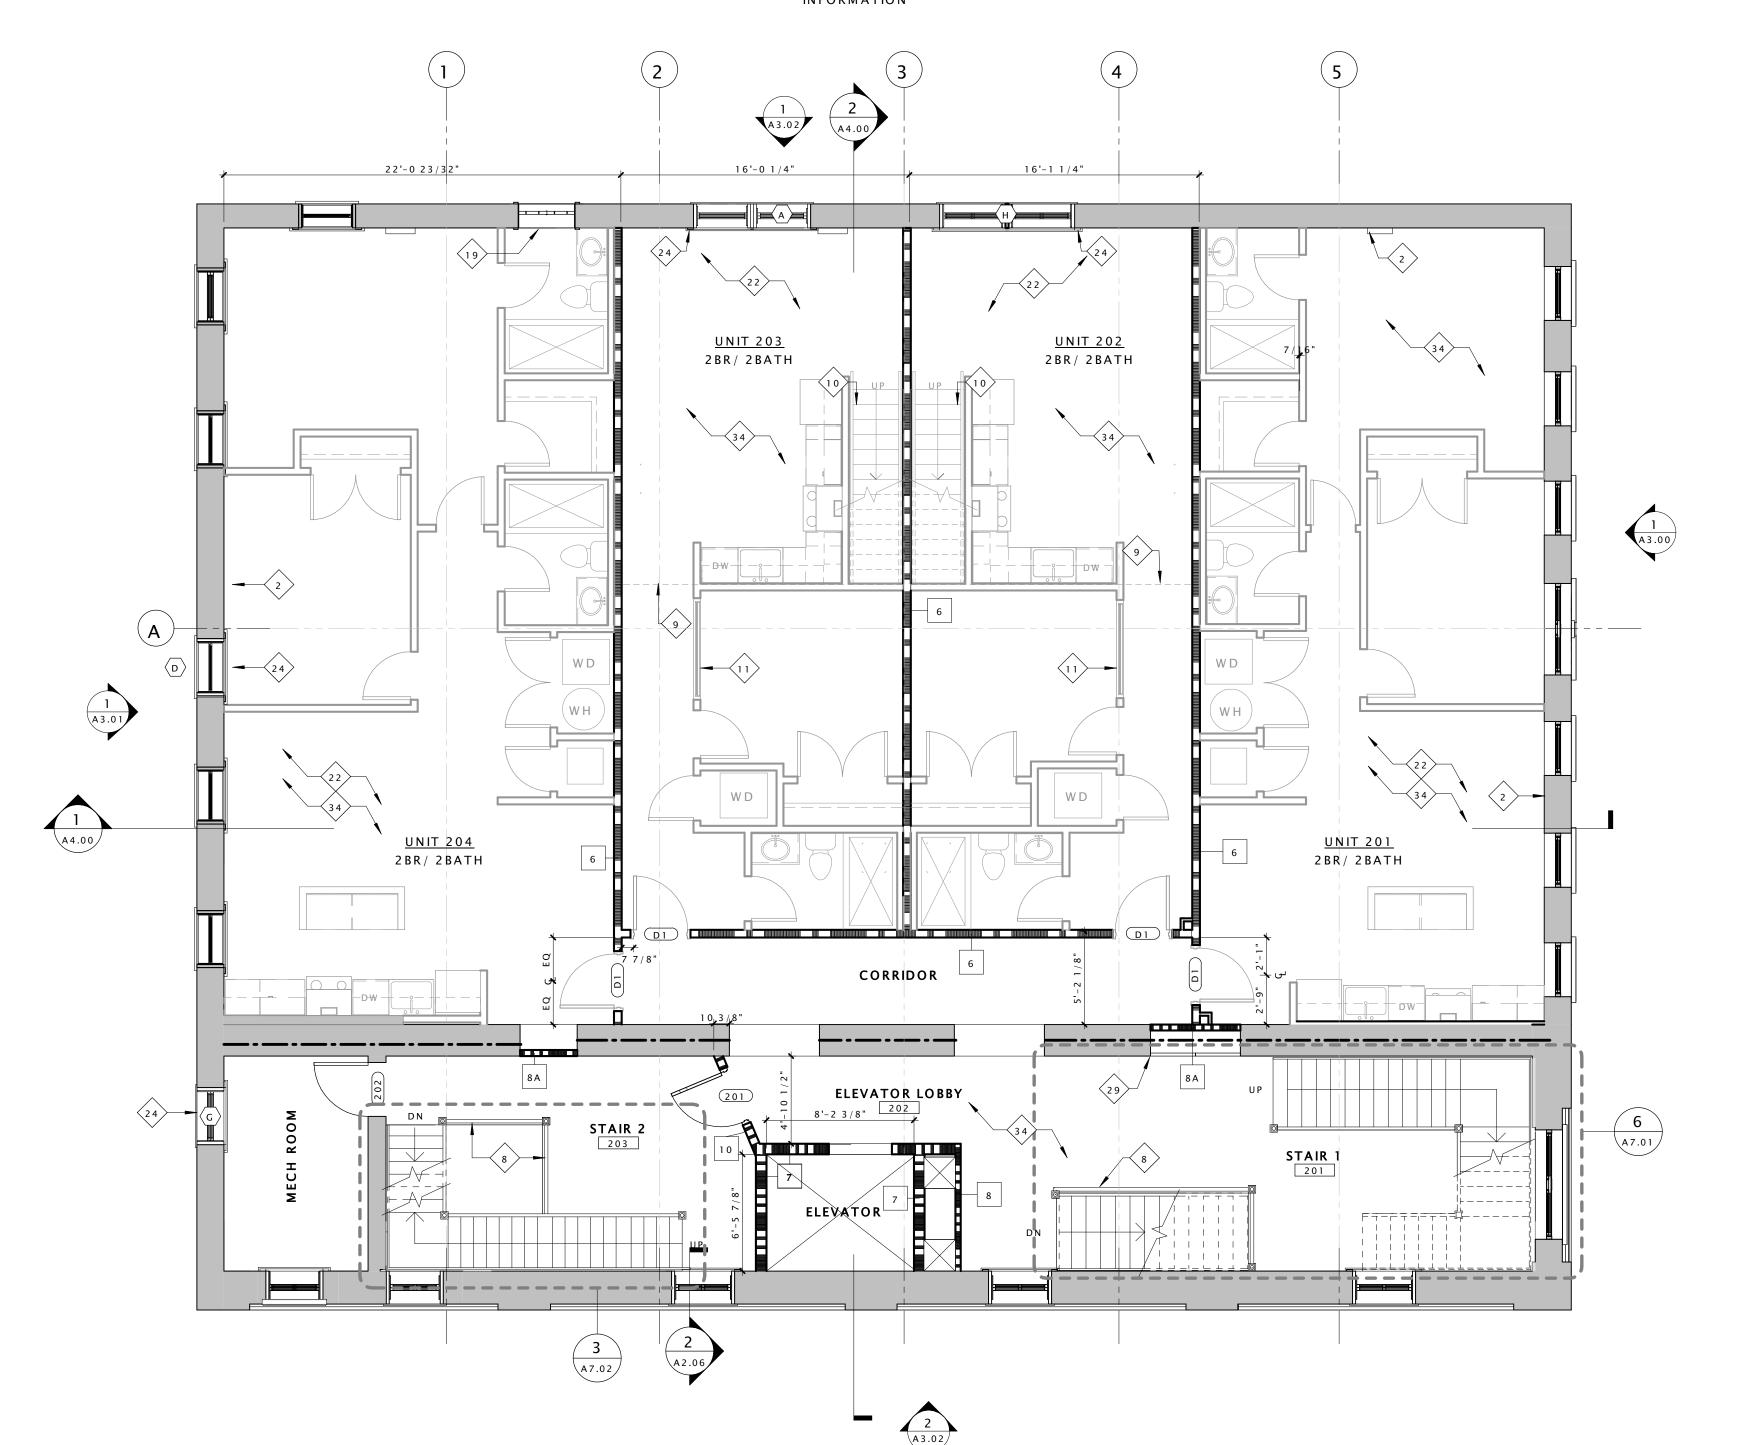

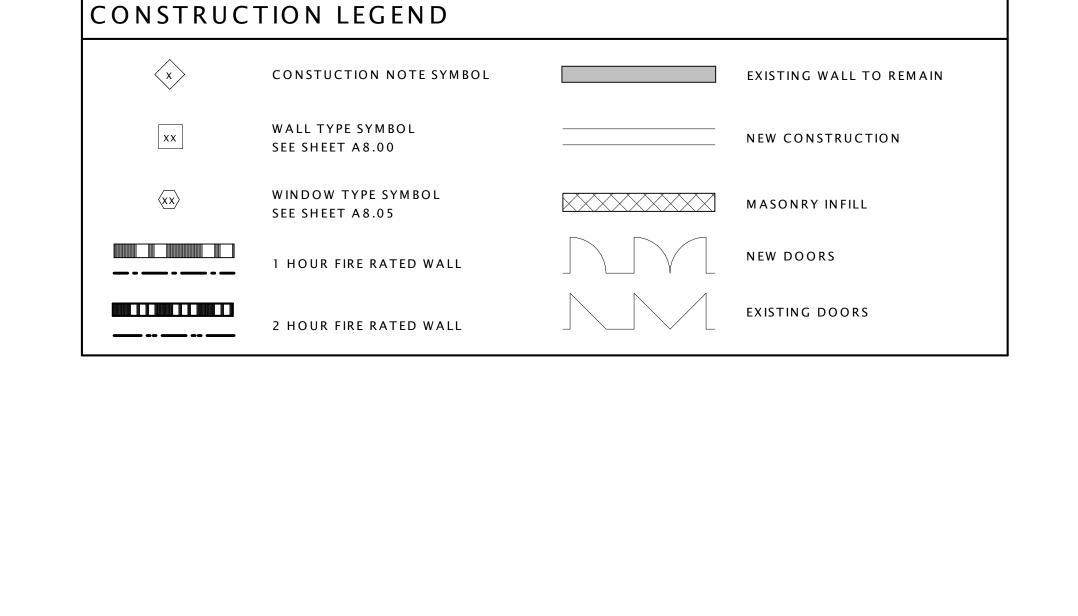

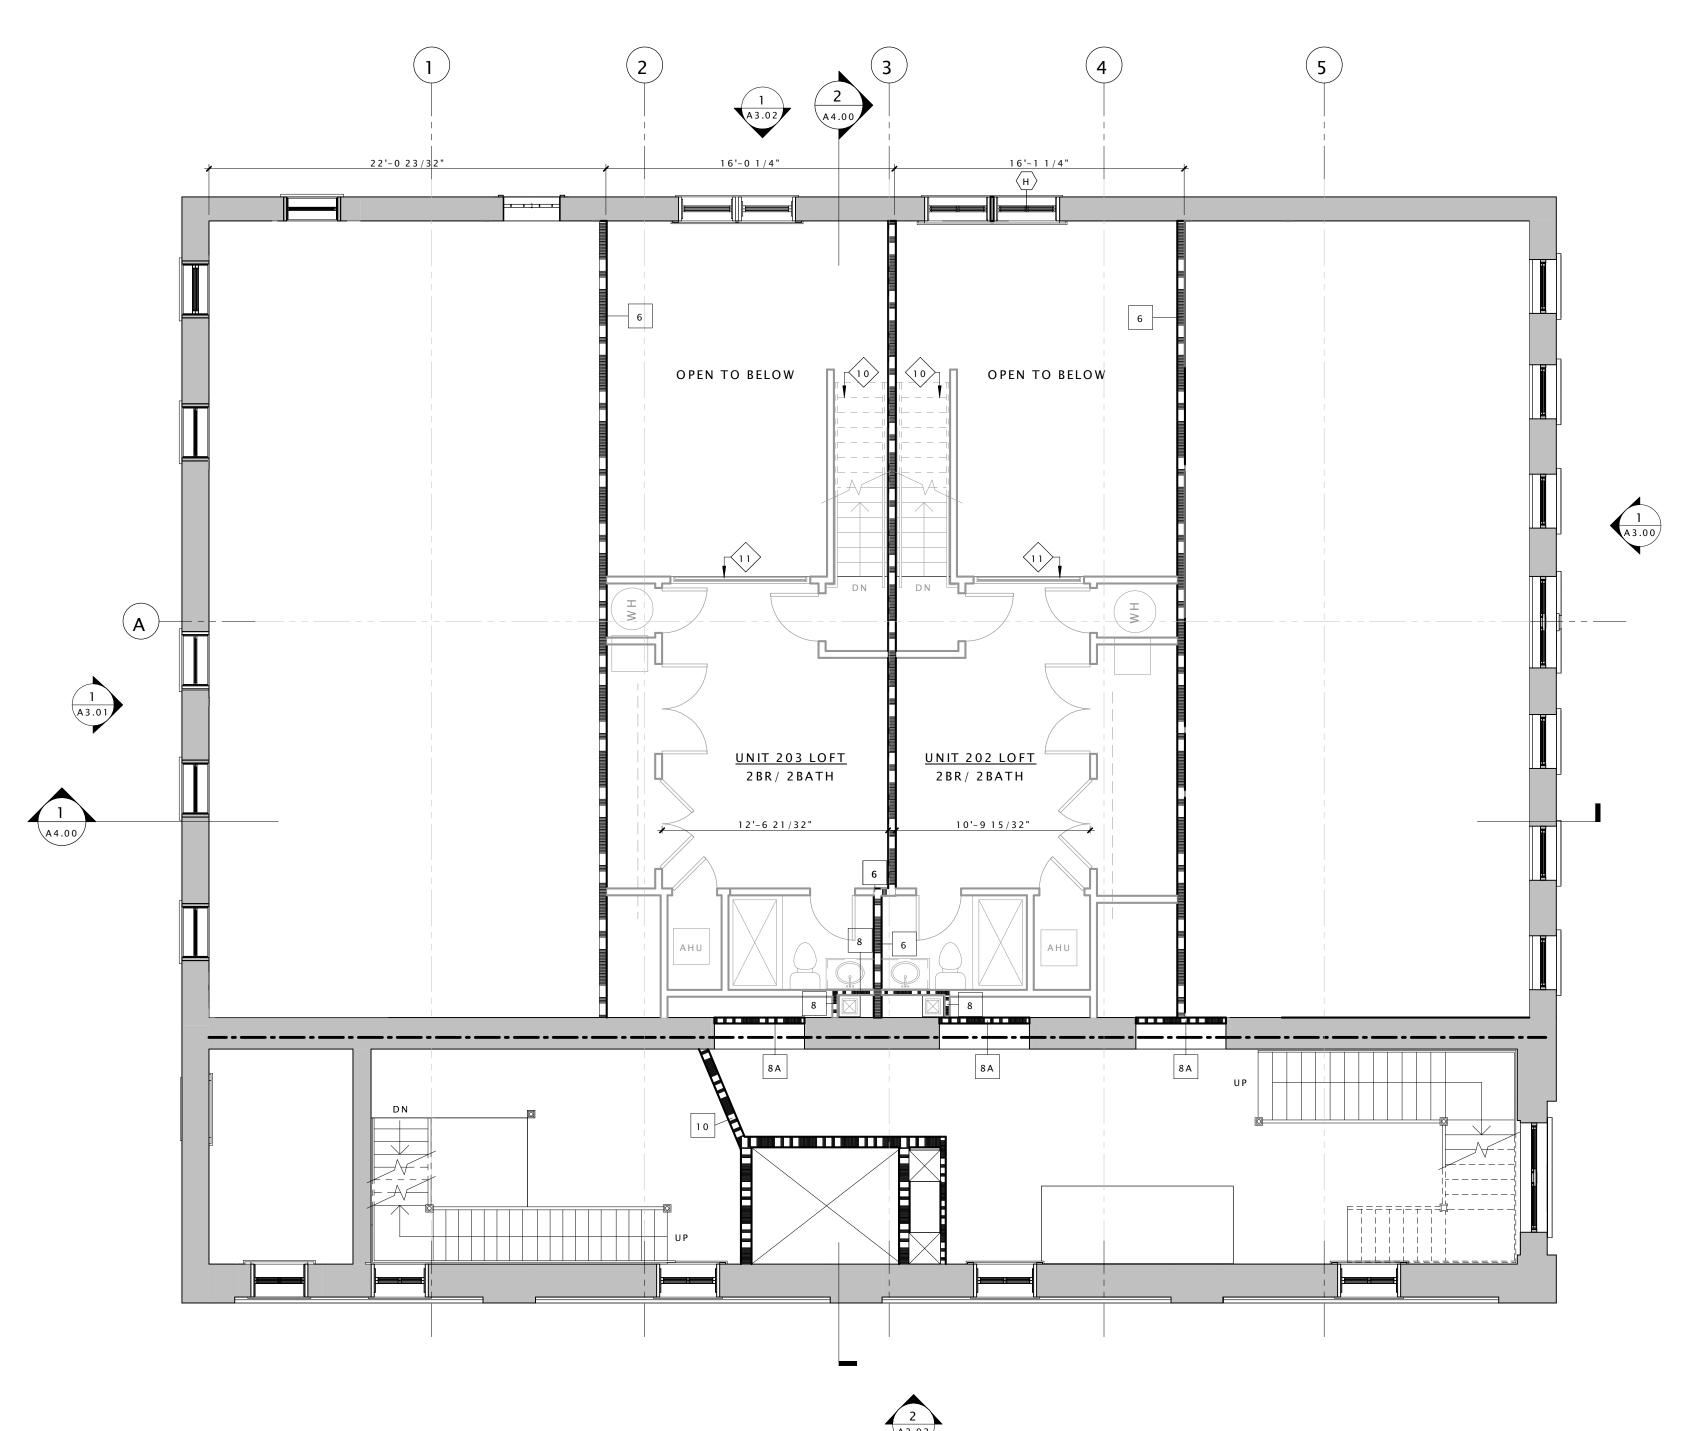

3 2 N D F L O O R L O F T
A2.01 SCALE: 3/16" = 1'-0"

101 SHOCKOE RICHMOND, V

ST LUKE BUILDING

Issue Record Date

DHR PART II SUBMISSION 10.26.1

PERMIT SET 01.18.1

DHR PART II AMENDMENT I 06.30.1

PERMIT SET RESPONSE 09.08.1

PERMIT SET RESPONSE 2 09.29.1

LEH A. SHADBOR Lic. No. 012166

Drawing Title

SECOND AND
SECOND FLOOR
LOFT PLANS

Sheet

A2.01

1 2 N D FLOOR
A2.01 SCALE: 3/16" = 1'-0"


- 1. THIS IS A HISTORIC REHABILITATION TAX CREDIT PROJECT. ALL WORK MUST BE ACCORDANCE WITH THE SECRETARY OF THE INTERIOR'S STANDARDS FOR HISTORIC REHABILITATION.
- 2. DIMENSIONS NOTED AS 'ALIGN', 'HOLD', 'CLEAR', ARE TO TAKE PRECEDENCE OVER OTHER DIMENSIONS IN CASE OF DISCREPANCIES BETWEEN DRAWINGS AND ARE ALWAYS TO FINISH FACE. ALL OTHER DIMENSIONS ARE TO FACE OF STUD UNLESS NOTED OTHERWISE. CONTACT ARCHITECT FOR CLARIFICATION
- 3. DOORS SHALL BE LOCATED 4" FROM ADJACENT PARTITIONS (HINGE SIDE) UNLESS NOTED OTHERWISE.
- 4. ALL PARTITIONS ARE TO BE PARTITION TYPE 1 UNLESS NOTED OTHERWISE. REFER TO SHEET 9 NEW LOFT FLOOR AT CONSTRUCTED OUT OF LIGHT GAGE FRAMING SEE STRUCTURAL A0.01 FOR WALL TYPES.
- 5. ALL TRANSITIONS OF FLOORING SHALL OCCUR @ CENTER LINE OF DOOR OPENINGS UNLESS NOTED OTHERWISE.
- 6. USE 1/2" WATER RESISTANT GWB IN ALL BATHROOMS UNLESS NOTE OTHERWISE. USE CEMENT BACKER BOARD @ ALL TILE LOCATIONS
- 7. ALL AREAS THAT INDICATE NEW INSULATION MUST MEET CURRENT IECC STANDARDS.
- 8. REFER TO ELEVATIONS FOR EXISTING AND NEW WINDOW INFORMATION
- 9. PATCH AND REPAIR EXISTING HISTORIC PLASTER WHERE IT HAS BEEN PREVIOUSLY REMOVED OR WHERE DAMAGED. SEE NPS BRIEF FOR METHODOLOGY
- 10. INTERIOR DEPTH DIMENSION OF CLOSETS TO BE 2'- 0" MINIMUM
- 11. REPAIR AND RESTORE PLASTER AT ALL EXTERIOR WALLS, HISTORIC INTERIOR WALLS, AND AT THE FIRST AND THIRD FLOOR CEILING.
- 12. AVOID REFINISHING FLOORS IN HISTORIC AREAS, CLEAN LIGHTLY. SAND ONLY AS NECESSARY AND OIL FLOOR BOARDS INSTEAD


# CONSTRUCTION KEY NOTES - 💉


- 1 EXISTING VAULT TO REMAIN
- 2 REPAIR AND PAINT EXISTING WAINSCOTING AT EXTERIOR WALLS AND HISTORIC PLASTER INTERIOR WALLS TYP. THROUGHOUT
- STRUCTURAL 4 NEW CONCRETE STAIR AND LANDING AT EXISTING ENTRY - SEE STRUCTURAL FOR

3 REPAIR EXISTING WOOD JOISTS TO MAKE FLOOR STRUCTUALLY SOUND - SEE

- 5 REPAIR EXISTING CANOPY
- 6 NEW METAL GUARD RAIL AND HANDRAIL AT ENTRY
- 7 RAISE EXISTING HISTORIC HANDRAIL TO CODE COMPLIANT HEIGHT
- 8 REPAIR AND PAINT EXISTING HISTORIC RAIL/GUARDRAIL
- FOR DETAILS 10 NEW STAIR IN THIS LOCATION.
- 11 NEW INTERIOR WOOD WINDOW AT BEDROOM WALL
- 12 EXISTING HISTORIC WALL AND TRANSOM WINDOWS TO BE RESTORED AND PAINTED
- 13 EXISTING HISTORIC EXTERIOR STOREFRONT TO BE RESTORED SEE SPECIFICATIONS FOR ALLOWABLE RESTORATION METHODS
- 14 RESTORE AND REPAIR EXISTING DECORATIVE CORNICE
- 15 RESTORE EXISTING BUILT-IN GUTTER 16 INSTALL NEW ALUMINUM 4" DOWNSPUT
- 17 NEW MEMBRANE ROOF ON 1/2" COVER BOARD AND (2) LAYERS OF 2" POLYISO INSULATION
- 18 REPAIR AND PAINT EXISTING WOOD DENTAL MOLDING
- 19 EXISTING FIRE ESCAPE DOORS TO REMAIN AND BE FIXED IN PLACE SO THAT THEY ARE NOT OPERABLE. DOORS TO BE REPAIRED AND REPAINTED. EXISTING WIRE GLASS TO BE REPAIRED AS NECESSARY.
- 20 INSTALL NEW WOOD WINDOW IN EXISTING LOCATION
- 21 INSPECT EXISTING MASONRY AFTER REMOVAL OF INVASIVE VEGETATION. REPAINT AND REPAIR BRICK AND MORTAR. MATCH SURROUNDING MORTAR IN MATERIAL, COMPOSITION, COLOR, AGGREGATE, & HARDNESS.
- 22 INSTALL SALVAGED TIN CEILING. SEE REFLECTED CEILING PLANS FOR MORE DETAILS.
- 23 EXISTING VAULT DOOR TO BE OPENED AND FIXED IN PLACE 24 NEW WOOD WINDOW IN INDICATED LOCATION. WINDOW TO MATCH EXISTING
- ADJACENT WINDOWS IN TYPE AND PROFILE
- 25 NEW ROOF ACCESS HATCH & LADDER SEE SHEET A2.05 FOR DETAILS 26 EXISTING INTERIOR STOREFRONT TO REAMIN
- 27 EXISTING HISTORIC TELLER PARTITIONS AND STOREFRONT TO REMAIN
- 28 CLEAN AND POLISH EXISTING HISTORIC TILE FLOORS.
- 29 EXISTING DOOR TO REMAIN AND FIXED IN PLACE SO THAT THEY ARE NOT OPERABLE
- 30 EXISTING WOOD DOORS TO BE REPAIRED, RECEIVE NEW HARDWARE, PAINTED, AND RESTORED TO WORKING ORDER - SEE DOOR SCHEDULE FOR MORE INFORMATION
- 31 INSPECT EXISTING FLUE SHAFTS AND REPAIR BRICK AS NECESSARRY TO MAINTAIN A
- WATER TIGHT ASSEMBLY 32 INSTALL NEW FLUE CAP
- 33 NEW DRYER VENT EXHAUST OPENING
- 34 REPAIR AND RESTORE EXISTING HARDWOOD FLOOR AS NECESSARY AND CREATE ONE HOUR FLOOR/CEILING ASSEMBLY - SEE SPECIFICATIONS AND SHEET A0.01 FOR MORE INFORMATION

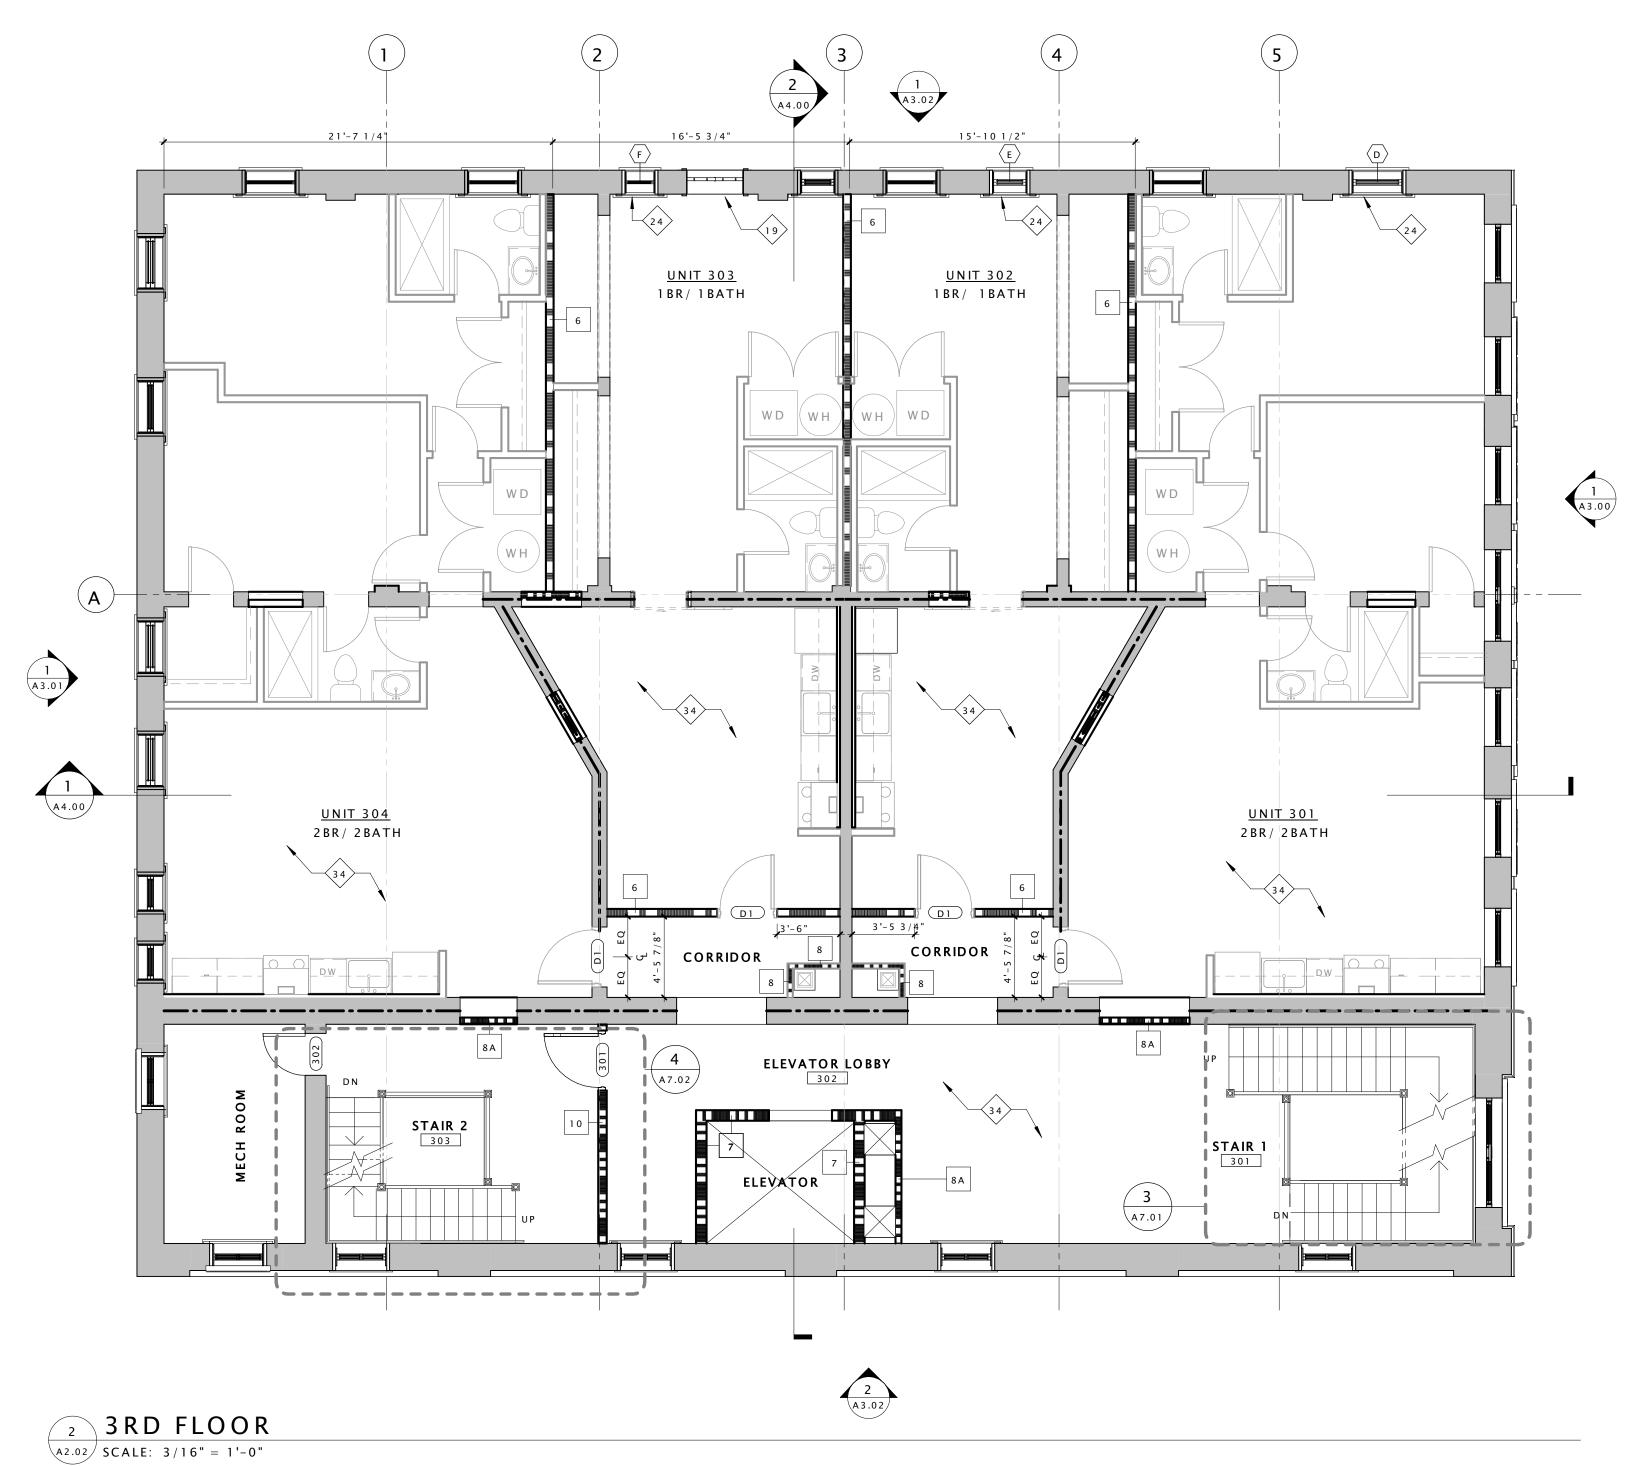

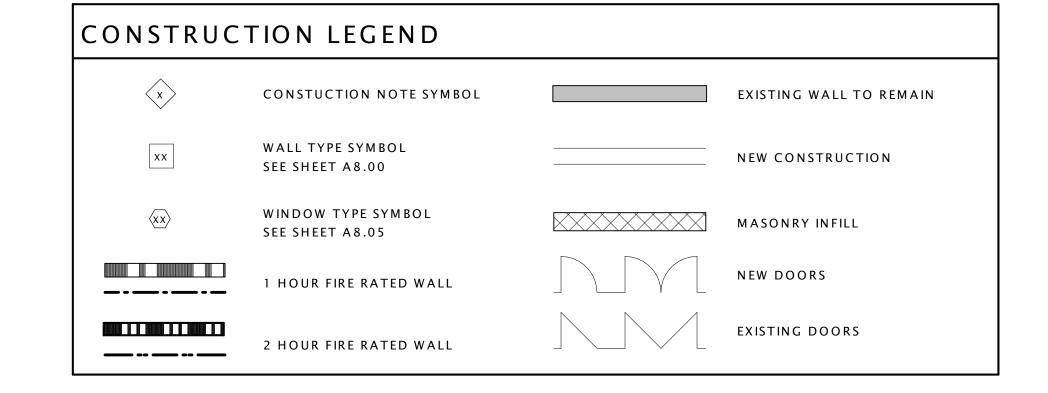

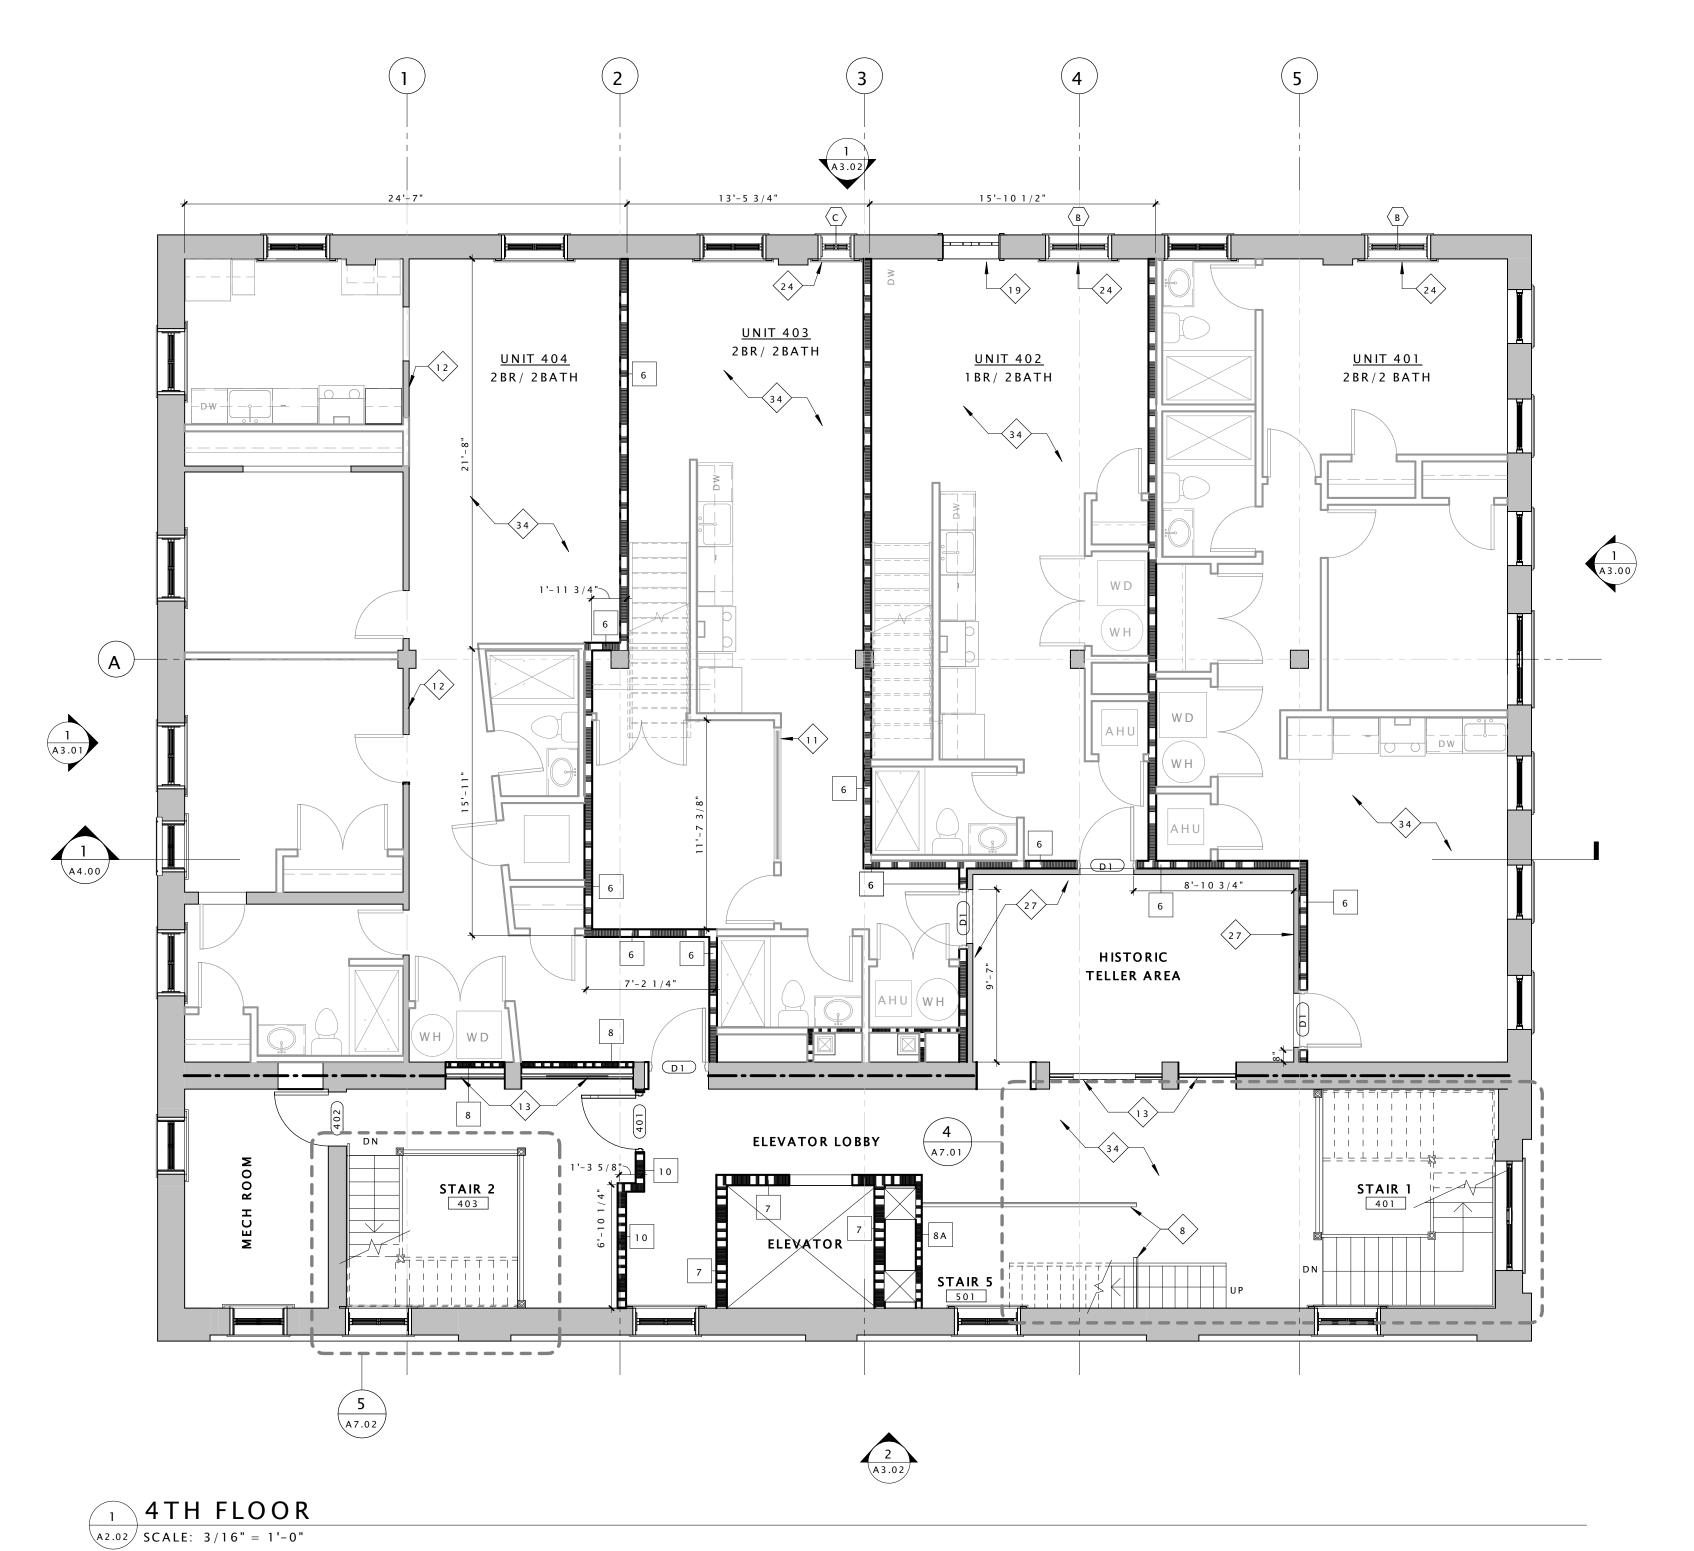

DHR PART II SUBMISSION PERMIT SET DHR PART II AMENDMENT I

Drawing Title

THIRD AND FOURTH FLOOR PLANS

- 1. THIS IS A HISTORIC REHABILITATION TAX CREDIT PROJECT. ALL WORK MUST BE ACCORDANCE WITH THE SECRETARY OF THE INTERIOR'S STANDARDS FOR HISTORIC REHABILITATION.
- 2. DIMENSIONS NOTED AS 'ALIGN', 'HOLD', 'CLEAR', ARE TO TAKE PRECEDENCE OVER OTHER DIMENSIONS IN CASE OF DISCREPANCIES BETWEEN DRAWINGS AND ARE ALWAYS TO FINISH FACE. ALL OTHER DIMENSIONS ARE TO FACE OF STUD UNLESS NOTED OTHERWISE. CONTACT ARCHITECT FOR CLARIFICATION
- 3. DOORS SHALL BE LOCATED 4" FROM ADJACENT PARTITIONS (HINGE SIDE) UNLESS NOTED OTHERWISE.
- 4. ALL PARTITIONS ARE TO BE PARTITION TYPE 1 UNLESS NOTED OTHERWISE. REFER TO SHEET A0.01 FOR WALL TYPES.
- 5. ALL TRANSITIONS OF FLOORING SHALL OCCUR @ CENTER LINE OF DOOR OPENINGS UNLESS NOTED OTHERWISE.
- 6. USE 1/2" WATER RESISTANT GWB IN ALL BATHROOMS UNLESS NOTE OTHERWISE. USE CEMENT BACKER BOARD @ ALL TILE LOCATIONS
- 7. ALL AREAS THAT INDICATE NEW INSULATION MUST MEET CURRENT IECC STANDARDS.
- 8. REFER TO ELEVATIONS FOR EXISTING AND NEW WINDOW INFORMATION
- 9. PATCH AND REPAIR EXISTING HISTORIC PLASTER WHERE IT HAS BEEN PREVIOUSLY REMOVED OR WHERE DAMAGED. SEE NPS BRIEF FOR METHODOLOGY
- 10. INTERIOR DEPTH DIMENSION OF CLOSETS TO BE 2'- 0" MINIMUM

1 4TH FLOOR LOFT
A2.03 SCALE: 3/16" = 1'-0"

- 11. REPAIR AND RESTORE PLASTER AT ALL EXTERIOR WALLS, HISTORIC INTERIOR WALLS, AND AT THE FIRST AND THIRD FLOOR CEILING.
- 12. AVOID REFINISHING FLOORS IN HISTORIC AREAS, CLEAN LIGHTLY. SAND ONLY AS NECESSARY AND OIL FLOOR BOARDS INSTEAD

# CONSTRUCTION KEY NOTES - 🗴

- 1 EXISTING VAULT TO REMAIN
- 2 REPAIR AND PAINT EXISTING WAINSCOTING AT EXTERIOR WALLS AND HISTORIC PLASTER INTERIOR WALLS TYP. THROUGHOUT
- 3 REPAIR EXISTING WOOD JOISTS TO MAKE FLOOR STRUCTUALLY SOUND SEE STRUCTURAL
- 4 NEW CONCRETE STAIR AND LANDING AT EXISTING ENTRY SEE STRUCTURAL FOR DETAILS
- 5 REPAIR EXISTING CANOPY
- 6 NEW METAL GUARD RAIL AND HANDRAIL AT ENTRY
- 7 RAISE EXISTING HISTORIC HANDRAIL TO CODE COMPLIANT HEIGHT
- 8 REPAIR AND PAINT EXISTING HISTORIC RAIL/GUARDRAIL 9 NEW LOFT FLOOR AT CONSTRUCTED OUT OF LIGHT GAGE FRAMING - SEE STRUCTURAL
- FOR DETAILS 10 NEW STAIR IN THIS LOCATION.
- 11 NEW INTERIOR WOOD WINDOW AT BEDROOM WALL
- 12 EXISTING HISTORIC WALL AND TRANSOM WINDOWS TO BE RESTORED AND PAINTED
- 13 EXISTING HISTORIC EXTERIOR STOREFRONT TO BE RESTORED SEE SPECIFICATIONS FOR ALLOWABLE RESTORATION METHODS
- 14 RESTORE AND REPAIR EXISTING DECORATIVE CORNICE
- 15 RESTORE EXISTING BUILT-IN GUTTER 16 INSTALL NEW ALUMINUM 4" DOWNSPUT
- 17 NEW MEMBRANE ROOF ON 1/2" COVER BOARD AND (2) LAYERS OF 2" POLYISO INSULATION
- 18 REPAIR AND PAINT EXISTING WOOD DENTAL MOLDING
- 19 EXISTING FIRE ESCAPE DOORS TO REMAIN AND BE FIXED IN PLACE SO THAT THEY ARE NOT OPERABLE. DOORS TO BE REPAIRED AND REPAINTED. EXISTING WIRE GLASS TO BE REPAIRED AS NECESSARY.

COMPOSITION, COLOR, AGGREGATE, & HARDNESS.

- 20 INSTALL NEW WOOD WINDOW IN EXISTING LOCATION 21 INSPECT EXISTING MASONRY AFTER REMOVAL OF INVASIVE VEGETATION. REPAINT AND REPAIR BRICK AND MORTAR. MATCH SURROUNDING MORTAR IN MATERIAL,
- 22 INSTALL SALVAGED TIN CEILING. SEE REFLECTED CEILING PLANS FOR MORE DETAILS.
- 23 EXISTING VAULT DOOR TO BE OPENED AND FIXED IN PLACE 24 NEW WOOD WINDOW IN INDICATED LOCATION. WINDOW TO MATCH EXISTING
- ADJACENT WINDOWS IN TYPE AND PROFILE
- 25 NEW ROOF ACCESS HATCH & LADDER SEE SHEET A2.05 FOR DETAILS 26 EXISTING INTERIOR STOREFRONT TO REAMIN

OPEN TO BELOW

- 27 EXISTING HISTORIC TELLER PARTITIONS AND STOREFRONT TO REMAIN
- 28 CLEAN AND POLISH EXISTING HISTORIC TILE FLOORS.
- 29 EXISTING DOOR TO REMAIN AND FIXED IN PLACE SO THAT THEY ARE NOT OPERABLE
- RESTORED TO WORKING ORDER SEE DOOR SCHEDULE FOR MORE INFORMATION 31 INSPECT EXISTING FLUE SHAFTS AND REPAIR BRICK AS NECESSARRY TO MAINTAIN A


30 EXISTING WOOD DOORS TO BE REPAIRED, RECEIVE NEW HARDWARE, PAINTED, AND

WATER TIGHT ASSEMBLY

OPEN TO BELOW

<u>UNIT 403</u>

- 32 INSTALL NEW FLUE CAP
- 33 NEW DRYER VENT EXHAUST OPENING
- 34 REPAIR AND RESTORE EXISTING HARDWOOD FLOOR AS NECESSARY AND CREATE ONE HOUR FLOOR/CEILING ASSEMBLY - SEE SPECIFICATIONS AND SHEET A0.01 FOR MORE INFORMATION 1

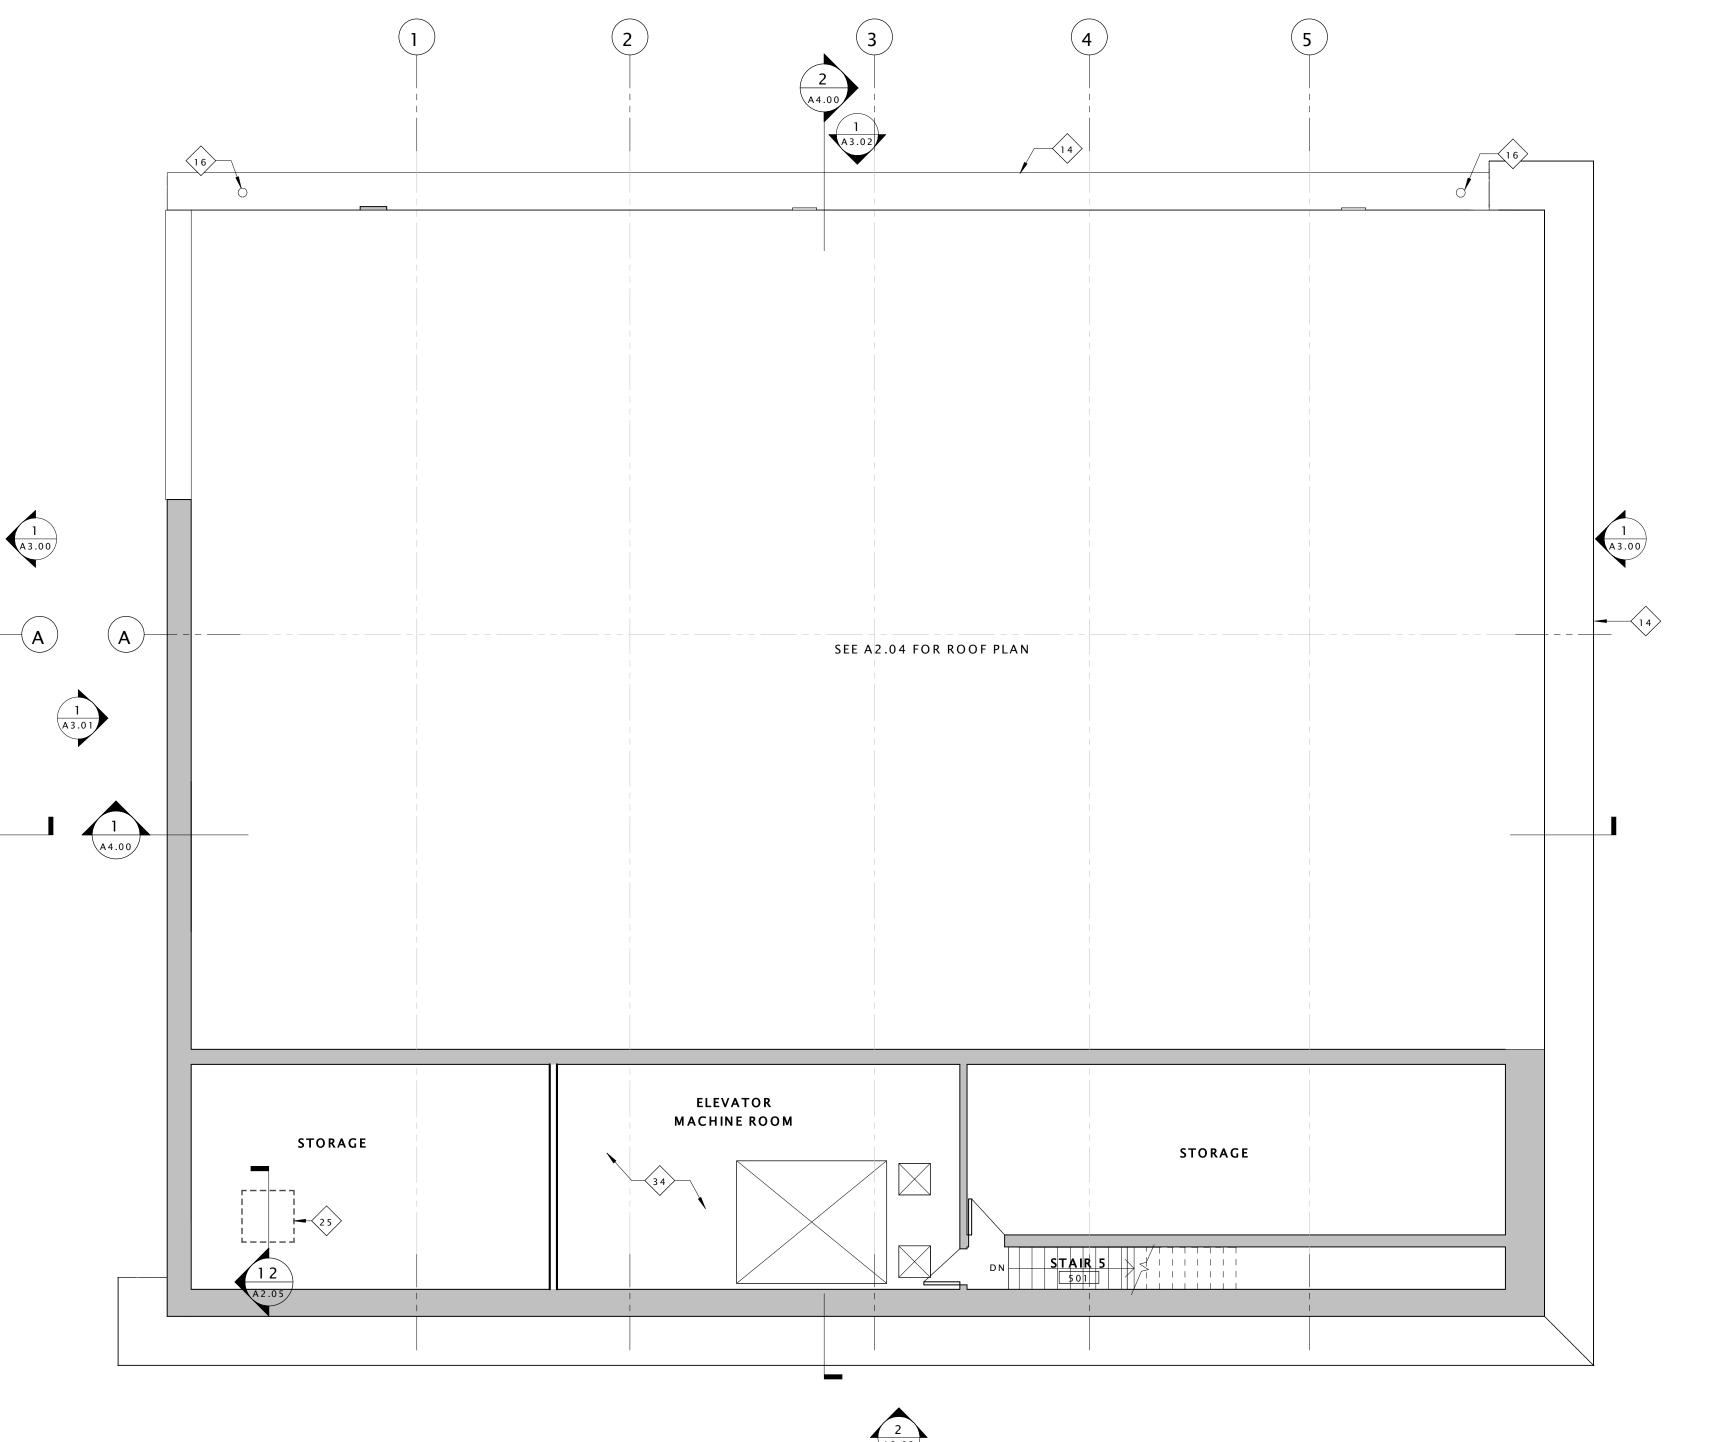

2 5 TH FLOOR
A2.03 SCALE: 3/16" = 1'-0"

CONSTRUCTION LEGEND CONSTUCTION NOTE SYMBOL EXISTING WALL TO REMAIN WALL TYPE SYMBOL NEW CONSTRUCTION SEE SHEET A8.00 WINDOW TYPE SYMBOL MASONRY INFILL SEE SHEET A 8.05 

1 HOUR FIRE RATED WALL

2 HOUR FIRE RATED WALL

\_\_\_\_\_

DHR PART II SUBMISSION 10.26.16 PERMIT SET DHR PART II AMENDMENT I PERMIT SET RESPONSE

Drawing Title

FOURTH FLOOR LOFT AND FIFTH FLOOR PLANS

- 1. THIS IS A HISTORIC REHABILITATION TAX CREDIT PROJECT. ALL WORK MUST BE ACCORDANCE WITH THE SECRETARY OF THE INTERIOR'S STANDARDS FOR HISTORIC REHABILITATION.
- 2. DIMENSIONS NOTED AS 'ALIGN', 'HOLD', 'CLEAR', ARE TO TAKE PRECEDENCE OVER OTHER DIMENSIONS IN CASE OF DISCREPANCIES BETWEEN DRAWINGS AND ARE ALWAYS TO FINISH FACE. ALL OTHER DIMENSIONS ARE TO FACE OF STUD UNLESS NOTED OTHERWISE. CONTACT ARCHITECT FOR CLARIFICATION
- 3. DOORS SHALL BE LOCATED 4" FROM ADJACENT PARTITIONS (HINGE SIDE) UNLESS NOTED OTHERWISE.
- 4. ALL PARTITIONS ARE TO BE PARTITION TYPE 1 UNLESS NOTED OTHERWISE. REFER TO SHEET A0.01 FOR WALL TYPES.
- 5. ALL TRANSITIONS OF FLOORING SHALL OCCUR @ CENTER LINE OF DOOR OPENINGS UNLESS NOTED OTHERWISE.
- 6. USE 1/2" WATER RESISTANT GWB IN ALL BATHROOMS UNLESS NOTE OTHERWISE. USE CEMENT BACKER BOARD @ ALL TILE LOCATIONS
- 7. ALL AREAS THAT INDICATE NEW INSULATION MUST MEET CURRENT IECC STANDARDS.
- 8. REFER TO ELEVATIONS FOR EXISTING AND NEW WINDOW INFORMATION
- 9. PATCH AND REPAIR EXISTING HISTORIC PLASTER WHERE IT HAS BEEN PREVIOUSLY REMOVED OR WHERE DAMAGED. SEE NPS BRIEF FOR METHODOLOGY
- 10. INTERIOR DEPTH DIMENSION OF CLOSETS TO BE 2'- 0" MINIMUM
- 11. REPAIR AND RESTORE PLASTER AT ALL EXTERIOR WALLS, HISTORIC INTERIOR WALLS, AND AT THE FIRST AND THIRD FLOOR CEILING.
- 12. AVOID REFINISHING FLOORS IN HISTORIC AREAS, CLEAN LIGHTLY. SAND ONLY AS NECESSARY AND OIL FLOOR BOARDS INSTEAD

# CONSTRUCTION KEY NOTES - 💉


- 1 EXISTING VAULT TO REMAIN
- 2 REPAIR AND PAINT EXISTING WAINSCOTING AT EXTERIOR WALLS AND HISTORIC PLASTER INTERIOR WALLS TYP. THROUGHOUT
- 3 REPAIR EXISTING WOOD JOISTS TO MAKE FLOOR STRUCTUALLY SOUND SEE STRUCTURAL 4 NEW CONCRETE STAIR AND LANDING AT EXISTING ENTRY - SEE STRUCTURAL FOR
- 5 REPAIR EXISTING CANOPY 6 NEW METAL GUARD RAIL AND HANDRAIL AT ENTRY
- 7 RAISE EXISTING HISTORIC HANDRAIL TO CODE COMPLIANT HEIGHT
- 8 REPAIR AND PAINT EXISTING HISTORIC RAIL/GUARDRAIL 9 NEW LOFT FLOOR AT CONSTRUCTED OUT OF LIGHT GAGE FRAMING - SEE STRUCTURAL FOR DETAILS
- 10 NEW STAIR IN THIS LOCATION.
- 11 NEW INTERIOR WOOD WINDOW AT BEDROOM WALL
- 12 EXISTING HISTORIC WALL AND TRANSOM WINDOWS TO BE RESTORED AND PAINTED
- 13 EXISTING HISTORIC EXTERIOR STOREFRONT TO BE RESTORED SEE SPECIFICATIONS FOR ALLOWABLE RESTORATION METHODS
- 14 RESTORE AND REPAIR EXISTING DECORATIVE CORNICE
- 15 RESTORE EXISTING BUILT-IN GUTTER

16 INSTALL NEW ALUMINUM 4" DOWNSPUT

- 17 NEW MEMBRANE ROOF ON 1/2" COVER BOARD AND (2) LAYERS OF 2" POLYISO
- INSULATION 18 REPAIR AND PAINT EXISTING WOOD DENTAL MOLDING
- 19 EXISTING FIRE ESCAPE DOORS TO REMAIN AND BE FIXED IN PLACE SO THAT THEY ARE NOT OPERABLE. DOORS TO BE REPAIRED AND REPAINTED. EXISTING WIRE GLASS TO BE
- REPAIRED AS NECESSARY. 20 INSTALL NEW WOOD WINDOW IN EXISTING LOCATION

21 INSPECT EXISTING MASONRY AFTER REMOVAL OF INVASIVE VEGETATION. REPAINT AND

- REPAIR BRICK AND MORTAR. MATCH SURROUNDING MORTAR IN MATERIAL,
- COMPOSITION, COLOR, AGGREGATE, & HARDNESS. 22 INSTALL SALVAGED TIN CEILING. SEE REFLECTED CEILING PLANS FOR MORE DETAILS.
- 23 EXISTING VAULT DOOR TO BE OPENED AND FIXED IN PLACE
- 24 NEW WOOD WINDOW IN INDICATED LOCATION. WINDOW TO MATCH EXISTING ADJACENT WINDOWS IN TYPE AND PROFILE
- 25 NEW ROOF ACCESS HATCH & LADDER SEE SHEET A2.05 FOR DETAILS
- 26 EXISTING INTERIOR STOREFRONT TO REAMIN
- 27 EXISTING HISTORIC TELLER PARTITIONS AND STOREFRONT TO REMAIN
- 28 CLEAN AND POLISH EXISTING HISTORIC TILE FLOORS.
- 29 EXISTING DOOR TO REMAIN AND FIXED IN PLACE SO THAT THEY ARE NOT OPERABLE
- 30 EXISTING WOOD DOORS TO BE REPAIRED, RECEIVE NEW HARDWARE, PAINTED, AND RESTORED TO WORKING ORDER - SEE DOOR SCHEDULE FOR MORE INFORMATION
- 31 INSPECT EXISTING FLUE SHAFTS AND REPAIR BRICK AS NECESSARRY TO MAINTAIN A
- WATER TIGHT ASSEMBLY 32 INSTALL NEW FLUE CAP
- 33 NEW DRYER VENT EXHAUST OPENING
- 34 REPAIR AND RESTORE EXISTING HARDWOOD FLOOR AS NECESSARY AND CREATE ONE HOUR FLOOR/CEILING ASSEMBLY - SEE SPECIFICATIONS AND SHEET A0.01 FOR MORE INFORMATION

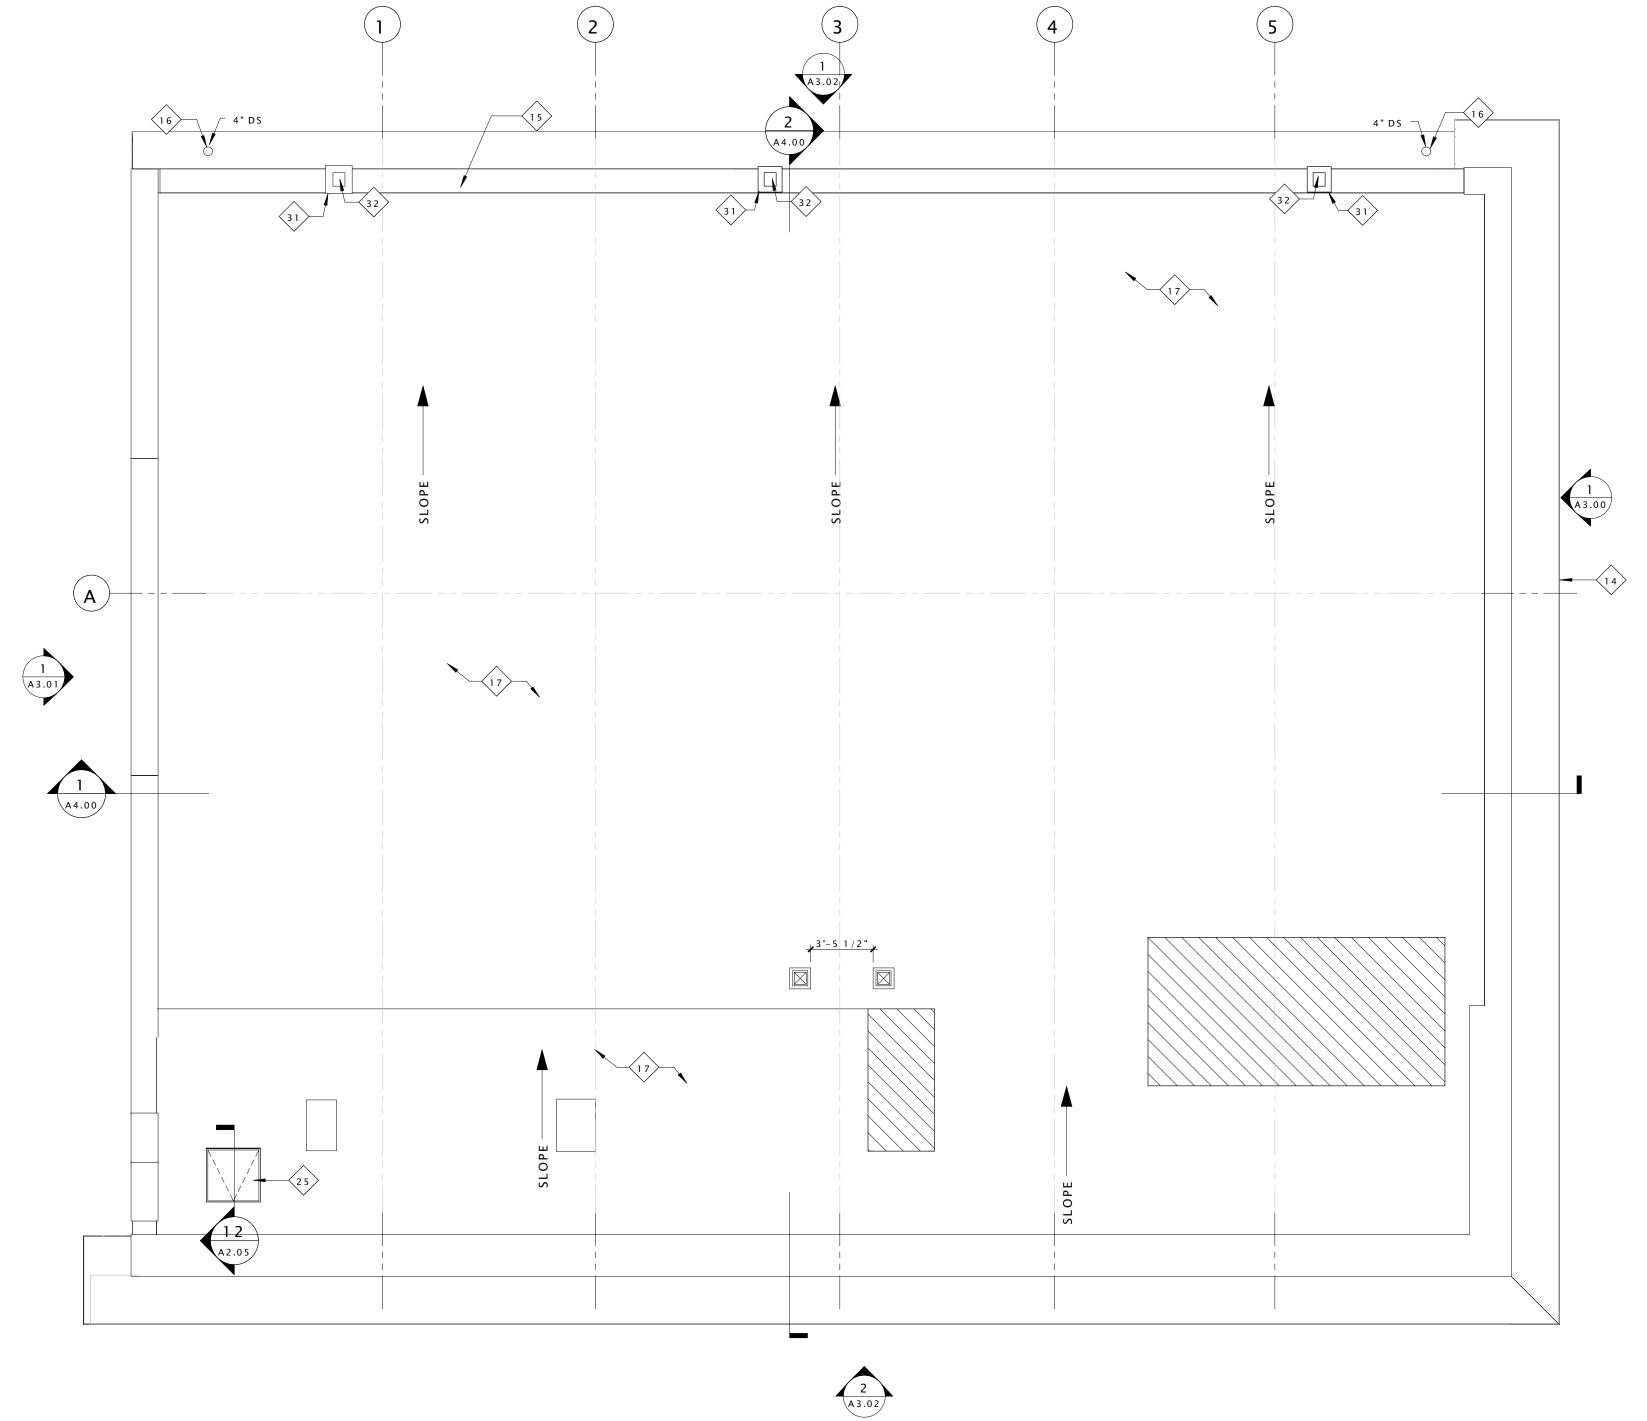

1 ROOF A2.04 SCALE: 3/16" = 1'-0"

CONSTRUCTION LEGEND CONSTUCTION NOTE SYMBOL EXISTING WALL TO REMAIN WALL TYPE SYMBOL NEW CONSTRUCTION SEE SHEET A8.00 WINDOW TYPE SYMBOL MASONRY INFILL SEE SHEET A8.05 1 HOUR FIRE RATED WALL 2 HOUR FIRE RATED WALL

\_\_\_\_\_

DHR PART II SUBMISSION PERMIT SET DHR PART II AMENDMENT I

Drawing Title

ROOF PLAN

# GENERAL ELEVATION NOTES

- 1. THIS IS A HISTORIC REHABILITATION TAX CREDIT PROJECT. ALL WORK MUST BE ACCORDANCE WITH THE SECRETARY OF THE INTERIOR'S STANDARDS FOR HISTORIC REHABILITATION.
- 2. CONTRACTOR SHALL CAREFULLY REVIEW ALL EXISTING CONDITION. ALL REPAIRS NOTED AS TYP. (BY THE SPECIFIC ELEVATION NOTES) OR NOTED UNDER THE GENERAL ELEVATION NOTES SHALL BE THE SOLE RESPONSIBILITY OF THE CONTRACTOR TO VERIFY EXACT LOCATION AND EXTENT OF WORK. TYPICAL NOTES ARE NOT SHOWN AT EVERY LOCATION WHERE SAID WORK IN REQUIRED AND IT IS THE SOLE RESPONSIBILITY OF THE CONTRACTOR TO VERIFY ALL LOCATIONS.
- 3. CONTRACTOR SHALL REPAINT ALL EXPOSED EXTERIOR BRICKS AS NOTED FRO STRUCTURAL SOUNDNESS AND WATER-TIGHTNESS. MATCH EXISTING MORTAR COLOR AND JOINT PROFILE. PROVIDE SAMPLE MOCK-UP ON BUILDING FOR ARCHITECT'S APPROVAL.
- 4. CONTRACTOR SHALL REPAIR/REPLACE ANY DAMAGED, SPLIT, SEVERELY SPALLED BRICK. CONTRACTOR SHALL REWORK BRICK AT NEW OR ENLARGED OPENING AS REQUIRED FOR NEW WINDOWS, DOORS, VENTS, ETC. BRICK SHALL BE REBUILT BY TOOTHING TOGETHER. SAW CUTTING NOT ALLOWED AT AREAS WHERE CUT WOULD BE VISIBLE.
- 5. CONTRACTOR SHALL REMOVE ALL EXTRANEOUS MATERIALS FROM FACE OF BUILDING, INCLUDING BUT NOT LIMITED TO VINES, ABANDONED WIRING AND CONDUITS, ABANDONED PLUMBING AND MECHANICAL PIPES, METAL ANCHORS, NAILS, WOOD BLOCKING, ETC. REPAIR SURFACES BEHIND AS REQUIRED FOR CONTINUOUS APPEARANCE.
- 6. CONTRACTOR SHALL SEAL/CAULK ALL CONNECTIONS OF MATERIALS AND OTHER LOCATIONS AS REQUIRED FOR WATER-TIGHTNESS.
- 7. CONTRACTOR SHALL INSPECT ALL EXISTING WINDOWS, DOORS, AND FRAMES TO REMAIN AND INCLUDED ANY NEEDED REPAIRS/REPLACEMENTS REQUIRED OR LIKE NEW APPEARANCE AND SOUND OPERATION. REPAIRS/REPLACEMENT INCLUDE FLASHING, GLAZING COMPOUND, GLASS, SASH, AND MUNTIN MEMBERS, FRAMES AND OTHER HARDWARE DEVICES, SILLS, LINTELS, ETC.
- 8. CONTRACTOR SHALL PAINT ALL EXTERIOR METAL SURFACES UNLESS THEY SPECIFICALLY NOTED OTHERWISE OR PREFINISHED.
- 9. CONTRACTOR SHALL CAREFULLY INSPECT ALL STRUCTURAL MEMBERS, INCLUDING BUT NOT LIMITED TO BEAMS, LINTELS, MASONRY, ARCHES, ETC. AND NOTIFY THE ARCHITECT IN WRITING OF ANY STRUCTURALLY UNSOUND CONDITIONS REQUIRING REPAIR, REPLACEMENT, OR INVESTIGATION.
- 10. 'PAINT' DENOTES PAINTING ACCORDING TO THE SPECIFICATIONS AND PREPARATION OF SURFACE BY HAND SCRAPING AND SANDING ALL LOOSE AND DAMAGED PAINT AND SANDING TO FEATHER EDGES AT REMAINING LAYER AS REQUIRED FOR CONTINUOUS FINISH.

# CONSTRUCTION KEY NOTES - (x)

- 1 EXISTING VAULT TO REMAIN
- 2 REPAIR AND PAINT EXISTING WAINSCOTING AT EXTERIOR WALLS AND HISTORIC PLASTER INTERIOR WALLS TYP. THROUGHOUT
- 3 REPAIR EXISTING WOOD JOISTS TO MAKE FLOOR STRUCTUALLY SOUND SEE STRUCTURAL
- 4 NEW CONCRETE STAIR AND LANDING AT EXISTING ENTRY SEE STRUCTURAL FOR DETAILS
- 5 REPAIR EXISTING CANOPY
- 6 NEW METAL GUARD RAIL AND HANDRAIL AT ENTRY
- 7 RAISE EXISTING HISTORIC HANDRAIL TO CODE COMPLIANT HEIGHT
- 8 REPAIR AND PAINT EXISTING HISTORIC RAIL/GUARDRAIL
   9 NEW LOFT FLOOR AT CONSTRUCTED OUT OF LIGHT GAGE FRAMING SEE STRUCTURAL
- FOR DETAILS
- 10 NEW STAIR IN THIS LOCATION.

  11 NEW INTERIOR WOOD WINDOW AT REDROOM W
- 11 NEW INTERIOR WOOD WINDOW AT BEDROOM WALL
  12 EXISTING HISTORIC WALL AND TRANSOM WINDOWS TO BE RESTORED AND PAINTED
- 13 EXISTING HISTORIC EXTERIOR STOREFRONT TO BE RESTORED SEE SPECIFICATIONS FOR ALLOWABLE RESTORATION METHODS
- 14 RESTORE AND REPAIR EXISTING DECORATIVE CORNICE
- 15 RESTORE EXISTING BUILT-IN GUTTER
- 16 INSTALL NEW ALUMINUM 4" DOWNSPUT
- 17 NEW MEMBRANE ROOF ON 1/2" COVER BOARD AND (2) LAYERS OF 2" POLYISO INSULATION
- 18 REPAIR AND PAINT EXISTING WOOD DENTAL MOLDING
- 19 EXISTING FIRE ESCAPE DOORS TO REMAIN AND BE FIXED IN PLACE SO THAT THEY ARE NOT OPERABLE. DOORS TO BE REPAIRED AND REPAINTED. EXISTING WIRE GLASS TO BE
- REPAIRED AS NECESSARY.

  20 INSTALL NEW WOOD WINDOW IN EXISTING LOCATION
- 21 INSPECT EXISTING MASONRY AFTER REMOVAL OF INVASIVE VEGETATION. REPAINT AND REPAIR BRICK AND MORTAR. MATCH SURROUNDING MORTAR IN MATERIAL, COMPOSITION, COLOR, AGGREGATE, & HARDNESS.
- 22 INSTALL SALVAGED TIN CEILING. SEE REFLECTED CEILING PLANS FOR MORE DETAILS.
- 23 EXISTING VAULT DOOR TO BE OPENED AND FIXED IN PLACE
- 24 NEW WOOD WINDOW IN INDICATED LOCATION. WINDOW TO MATCH EXISTING ADJACENT WINDOWS IN TYPE AND PROFILE
- 25 NEW ROOF ACCESS HATCH & LADDER SEE SHEET A2.05 FOR DETAILS
- 26 EXISTING INTERIOR STOREFRONT TO REAMIN
- 27 EXISTING HISTORIC TELLER PARTITIONS AND STOREFRONT TO REMAIN
- 28 CLEAN AND POLISH EXISTING HISTORIC TILE FLOORS.
- 28 CLEAN AND POLISH EXISTING HISTORIC FILE FLOORS.

  29 EXISTING DOOR TO REMAIN AND FIXED IN PLACE SO THAT THEY ARE NOT OPERABLE
- 30 EXISTING WOOD DOORS TO BE REPAIRED, RECEIVE NEW HARDWARE, PAINTED, AND RESTORED TO WORKING ORDER SEE DOOR SCHEDULE FOR MORE INFORMATION
- 31 INSPECT EXISTING FLUE SHAFTS AND REPAIR BRICK AS NECESSARRY TO MAINTAIN A
- WATER TIGHT ASSEMBLY
- 32 INSTALL NEW FLUE CAP33 NEW DRYER VENT EXHAUST OPENING
- 33 NEW DRYER VENT EXHAUST OPENING
  34 REPAIR AND RESTORE EXISTING HARDWOOD
- 34 REPAIR AND RESTORE EXISTING HARDWOOD FLOOR AS NECESSARY AND CREATE ONE HOUR FLOOR/CEILING ASSEMBLY SEE SPECIFICATIONS AND SHEET A0.01 FOR MORE INFORMATION



# CONSTRUCTION LEGEND CONSTRUCTION NOTE SYMBOL EXISTING WALL TO REMAIN WALL TYPE SYMBOL SEE SHEET A8.00 WINDOW TYPE SYMBOL SEE SHEET A8.05 1 HOUR FIRE RATED WALL 2 HOUR FIRE RATED WALL EXISTING DOORS EXISTING DOORS

0

Issue Record Date

DHR PART II SUBMISSION 10.26.16

PERMIT SET 01.18.17

DHR PART II AMENDMENT I 06.30.17

PERMIT SET RESPONSE 09.08.17

PERMIT SET RESPONSE 2 09.29.17

S



Drawing Title

EAST ELVATION

Sheet

A3.00

713100

### GENERAL ELEVATION NOTES


- 1. THIS IS A HISTORIC REHABILITATION TAX CREDIT PROJECT. ALL WORK MUST BE ACCORDANCE WITH THE SECRETARY OF THE INTERIOR'S STANDARDS FOR HISTORIC REHABILITATION.
- 2. CONTRACTOR SHALL CAREFULLY REVIEW ALL EXISTING CONDITION. ALL REPAIRS NOTED AS TYP. (BY THE SPECIFIC ELEVATION NOTES) OR NOTED UNDER THE GENERAL ELEVATION NOTES SHALL BE THE SOLE RESPONSIBILITY OF THE CONTRACTOR TO VERIFY EXACT LOCATION AND EXTENT OF WORK. TYPICAL NOTES ARE NOT SHOWN AT EVERY LOCATION WHERE SAID WORK IN REQUIRED AND IT IS THE SOLE RESPONSIBILITY OF THE CONTRACTOR TO VERIFY ALL LOCATIONS.
- 3. CONTRACTOR SHALL REPAINT ALL EXPOSED EXTERIOR BRICKS AS NOTED FRO STRUCTURAL SOUNDNESS AND WATER-TIGHTNESS. MATCH EXISTING MORTAR COLOR AND JOINT PROFILE. PROVIDE SAMPLE MOCK-UP ON BUILDING FOR ARCHITECT'S APPROVAL.
- 4. CONTRACTOR SHALL REPAIR/REPLACE ANY DAMAGED, SPLIT, SEVERELY SPALLED BRICK. CONTRACTOR SHALL REWORK BRICK AT NEW OR ENLARGED OPENING AS REQUIRED FOR NEW WINDOWS, DOORS, VENTS, ETC. BRICK SHALL BE REBUILT BY TOOTHING TOGETHER. SAW CUTTING NOT ALLOWED AT AREAS WHERE CUT WOULD BE VISIBLE.
- 5. CONTRACTOR SHALL REMOVE ALL EXTRANEOUS MATERIALS FROM FACE OF BUILDING, INCLUDING BUT NOT LIMITED TO VINES, ABANDONED WIRING AND CONDUITS, ABANDONED PLUMBING AND MECHANICAL PIPES, METAL ANCHORS, NAILS, WOOD BLOCKING, ETC. REPAIR SURFACES BEHIND AS REQUIRED FOR CONTINUOUS APPEARANCE.
- 6. CONTRACTOR SHALL SEAL/CAULK ALL CONNECTIONS OF MATERIALS AND OTHER LOCATIONS AS REQUIRED FOR WATER-TIGHTNESS.
- 7. CONTRACTOR SHALL INSPECT ALL EXISTING WINDOWS, DOORS, AND FRAMES TO REMAIN AND INCLUDED ANY NEEDED REPAIRS/REPLACEMENTS REQUIRED OR LIKE NEW APPEARANCE AND SOUND OPERATION. REPAIRS/REPLACEMENT INCLUDE FLASHING, GLAZING COMPOUND, GLASS, SASH, AND MUNTIN MEMBERS, FRAMES AND OTHER HARDWARE DEVICES, SILLS, LINTELS, ETC.
- 8. CONTRACTOR SHALL PAINT ALL EXTERIOR METAL SURFACES UNLESS THEY SPECIFICALLY NOTED OTHERWISE OR PREFINISHED.
- 9. CONTRACTOR SHALL CAREFULLY INSPECT ALL STRUCTURAL MEMBERS, INCLUDING BUT NOT LIMITED TO BEAMS, LINTELS, MASONRY, ARCHES, ETC. AND NOTIFY THE ARCHITECT IN WRITING OF ANY STRUCTURALLY UNSOUND CONDITIONS REQUIRING REPAIR, REPLACEMENT, OR INVESTIGATION.
- 10. 'PAINT' DENOTES PAINTING ACCORDING TO THE SPECIFICATIONS AND PREPARATION OF SURFACE BY HAND SCRAPING AND SANDING ALL LOOSE AND DAMAGED PAINT AND SANDING TO FEATHER EDGES AT REMAINING LAYER AS REQUIRED FOR CONTINUOUS FINISH.

# CONSTRUCTION KEY NOTES - 💉



- 1 EXISTING VAULT TO REMAIN
- 2 REPAIR AND PAINT EXISTING WAINSCOTING AT EXTERIOR WALLS AND HISTORIC PLASTER INTERIOR WALLS TYP. THROUGHOUT
- 3 REPAIR EXISTING WOOD JOISTS TO MAKE FLOOR STRUCTUALLY SOUND SEE STRUCTURAL
- 4 NEW CONCRETE STAIR AND LANDING AT EXISTING ENTRY SEE STRUCTURAL FOR
- DETAILS 5 REPAIR EXISTING CANOPY
- 6 NEW METAL GUARD RAIL AND HANDRAIL AT ENTRY
- 7 RAISE EXISTING HISTORIC HANDRAIL TO CODE COMPLIANT HEIGHT
- 8 REPAIR AND PAINT EXISTING HISTORIC RAIL/GUARDRAIL
- 9 NEW LOFT FLOOR AT CONSTRUCTED OUT OF LIGHT GAGE FRAMING SEE STRUCTURAL FOR DETAILS
- 10 NEW STAIR IN THIS LOCATION.
- 11 NEW INTERIOR WOOD WINDOW AT BEDROOM WALL
- 12 EXISTING HISTORIC WALL AND TRANSOM WINDOWS TO BE RESTORED AND PAINTED
- 13 EXISTING HISTORIC EXTERIOR STOREFRONT TO BE RESTORED SEE SPECIFICATIONS FOR ALLOWABLE RESTORATION METHODS
- 14 RESTORE AND REPAIR EXISTING DECORATIVE CORNICE
- 15 RESTORE EXISTING BUILT-IN GUTTER
- 16 INSTALL NEW ALUMINUM 4" DOWNSPUT
- 17 NEW MEMBRANE ROOF ON 1/2" COVER BOARD AND (2) LAYERS OF 2" POLYISO INSULATION
- 18 REPAIR AND PAINT EXISTING WOOD DENTAL MOLDING
- 19 EXISTING FIRE ESCAPE DOORS TO REMAIN AND BE FIXED IN PLACE SO THAT THEY ARE NOT OPERABLE. DOORS TO BE REPAIRED AND REPAINTED. EXISTING WIRE GLASS TO BE REPAIRED AS NECESSARY.
- 20 INSTALL NEW WOOD WINDOW IN EXISTING LOCATION
- 21 INSPECT EXISTING MASONRY AFTER REMOVAL OF INVASIVE VEGETATION. REPAINT AND REPAIR BRICK AND MORTAR. MATCH SURROUNDING MORTAR IN MATERIAL, COMPOSITION, COLOR, AGGREGATE, & HARDNESS.
- 22 INSTALL SALVAGED TIN CEILING. SEE REFLECTED CEILING PLANS FOR MORE DETAILS.
- 23 EXISTING VAULT DOOR TO BE OPENED AND FIXED IN PLACE
- 24 NEW WOOD WINDOW IN INDICATED LOCATION. WINDOW TO MATCH EXISTING ADJACENT WINDOWS IN TYPE AND PROFILE
- 25 NEW ROOF ACCESS HATCH & LADDER SEE SHEET A2.05 FOR DETAILS
- 26 EXISTING INTERIOR STOREFRONT TO REAMIN
- 27 EXISTING HISTORIC TELLER PARTITIONS AND STOREFRONT TO REMAIN
- 28 CLEAN AND POLISH EXISTING HISTORIC TILE FLOORS.
- 29 EXISTING DOOR TO REMAIN AND FIXED IN PLACE SO THAT THEY ARE NOT OPERABLE
- 30 EXISTING WOOD DOORS TO BE REPAIRED, RECEIVE NEW HARDWARE, PAINTED, AND RESTORED TO WORKING ORDER - SEE DOOR SCHEDULE FOR MORE INFORMATION
- 31 INSPECT EXISTING FLUE SHAFTS AND REPAIR BRICK AS NECESSARRY TO MAINTAIN A WATER TIGHT ASSEMBLY
- 32 INSTALL NEW FLUE CAP
- 33 NEW DRYER VENT EXHAUST OPENING
- 34 REPAIR AND RESTORE EXISTING HARDWOOD FLOOR AS NECESSARY AND CREATE ONE HOUR FLOOR/CEILING ASSEMBLY - SEE SPECIFICATIONS AND SHEET A0.01 FOR MORE INFORMATION



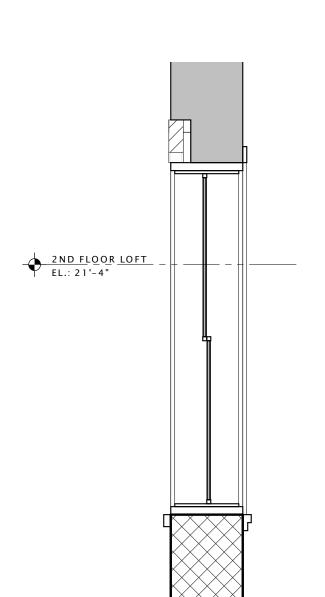

WEST ELEVATION - WALL INFILL DETAIL A3.01 SCALE: 1/2" = 1'-0"

2ND FLOOR EL.: 13'-4"

1 WEST
A3.01 SCALE: 3/16" = 1'-0"

# CONSTRUCTION LEGEND CONSTUCTION NOTE SYMBOL EXISTING WALL TO REMAIN WALL TYPE SYMBOL NEW CONSTRUCTION SEE SHEET A8.00

WINDOW TYPE SYMBOL SEE SHEET A8.05 1 HOUR FIRE RATED WALL -----

2 HOUR FIRE RATED WALL

MASONRY INFILL

0

DHR PART II SUBMISSION 10.26.16 PERMIT SET DHR PART II AMENDMENT I

Drawing Title

WEST ELEVATION

# CONSTRUCTION KEY NOTES - 🗴 GENERAL CONSTRUCTION NOTES 1 EXISTING VAULT TO REMAIN 1. THIS IS A HISTORIC REHABILITATION TAX CREDIT PROJECT. ALL WORK MUST BE CONSTRUCTION LEGEND 2 REPAIR AND PAINT EXISTING WAINSCOTING AT EXTERIOR WALLS AND HISTORIC PLASTER ACCORDANCE WITH THE SECRETARY OF THE INTERIOR'S STANDARDS FOR HISTORIC INTERIOR WALLS TYP. THROUGHOUT REHABILITATION. REPAIR EXISTING WOOD JOISTS TO MAKE FLOOR STRUCTUALLY SOUND - SEE STRUCTURAL CONSTUCTION NOTE SYMBOL EXISTING WALL TO REMAIN 2. DIMENSIONS NOTED AS 'ALIGN', 'HOLD', 'CLEAR', ARE TO TAKE PRECEDENCE OVER OTHER DIMENSIONS IN CASE OF DISCREPANCIES BETWEEN DRAWINGS AND ARE ALWAYS TO FINISH 4 NEW CONCRETE STAIR AND LANDING AT EXISTING ENTRY - SEE STRUCTURAL FOR DETAILS FACE. ALL OTHER DIMENSIONS ARE TO FACE OF STUD UNLESS NOTED OTHERWISE. xx WALL TYPE SYMBOL CONTACT ARCHITECT FOR CLARIFICATION 5 REPAIR EXISTING CANOPY NEW CONSTRUCTION SEE SHEET A8.00 6 NEW METAL GUARD RAIL AND HANDRAIL AT ENTRY 3. DOORS SHALL BE LOCATED 4" FROM ADJACENT PARTITIONS (HINGE SIDE) UNLESS NOTED 7 RAISE EXISTING HISTORIC HANDRAIL TO CODE COMPLIANT HEIGHT OTHERWISE. WINDOW TYPE SYMBOL REPAIR AND PAINT EXISTING HISTORIC RAIL/GUARDRAIL MASONRY INFILL SEE SHEET A8.05 4. ALL PARTITIONS ARE TO BE PARTITION TYPE 1 UNLESS NOTED OTHERWISE. REFER TO SHEE? NEW LOFT FLOOR AT CONSTRUCTED OUT OF LIGHT GAGE FRAMING - SEE STRUCTURAL FOR DETAILS A0.01 FOR WALL TYPES. 1 HOUR FIRE RATED WALL 10 NEW STAIR IN THIS LOCATION. 5. ALL TRANSITIONS OF FLOORING SHALL OCCUR @ CENTER LINE OF DOOR OPENINGS UNLES\$1 NEW INTERIOR WOOD WINDOW AT BEDROOM WALL NOTED OTHERWISE. 12 EXISTING HISTORIC WALL AND TRANSOM WINDOWS TO BE RESTORED AND PAINTED 2 HOUR FIRE RATED WALL 13 EXISTING HISTORIC EXTERIOR STOREFRONT TO BE RESTORED - SEE SPECIFICATIONS FOR 6. USE 1/2" WATER RESISTANT GWB IN ALL BATHROOMS UNLESS NOTE OTHERWISE. USE ALLOWABLE RESTORATION METHODS CEMENT BACKER BOARD @ ALL TILE LOCATIONS 14 RESTORE AND REPAIR EXISTING DECORATIVE CORNICE 7. ALL AREAS THAT INDICATE NEW INSULATION MUST MEET CURRENT IECC STANDARDS. 15 RESTORE EXISTING BUILT-IN GUTTER 16 INSTALL NEW ALUMINUM 4" DOWNSPUT 8. REFER TO ELEVATIONS FOR EXISTING AND NEW WINDOW INFORMATION 17 NEW MEMBRANE ROOF ON 1/2" COVER BOARD AND (2) LAYERS OF 2" POLYISO INSULATION 9. PATCH AND REPAIR EXISTING HISTORIC PLASTER WHERE IT HAS BEEN PREVIOUSLY 18 REPAIR AND PAINT EXISTING WOOD DENTAL MOLDING REMOVED OR WHERE DAMAGED. SEE NPS BRIEF FOR METHODOLOGY 19 EXISTING FIRE ESCAPE DOORS TO REMAIN AND BE FIXED IN PLACE SO THAT THEY ARE NOT OPERABLE. DOORS TO BE REPAIRED AND REPAINTED. EXISTING WIRE GLASS TO BE 10. INTERIOR DEPTH DIMENSION OF CLOSETS TO BE 2'- 0" MINIMUM REPAIRED AS NECESSARY. 11. REPAIR AND RESTORE PLASTER AT ALL EXTERIOR WALLS, HISTORIC INTERIOR WALLS, AND 20 INSTALL NEW WOOD WINDOW IN EXISTING LOCATION AT THE FIRST AND THIRD FLOOR CEILING. 21 INSPECT EXISTING MASONRY AFTER REMOVAL OF INVASIVE VEGETATION. REPAINT AND REPAIR BRICK AND MORTAR. MATCH SURROUNDING MORTAR IN MATERIAL, 12. AVOID REFINISHING FLOORS IN HISTORIC AREAS, CLEAN LIGHTLY. SAND ONLY AS COMPOSITION, COLOR, AGGREGATE, & HARDNESS. NECESSARY AND OIL FLOOR BOARDS INSTEAD 22 INSTALL SALVAGED TIN CEILING. SEE REFLECTED CEILING PLANS FOR MORE DETAILS. 23 EXISTING VAULT DOOR TO BE OPENED AND FIXED IN PLACE 24 NEW WOOD WINDOW IN INDICATED LOCATION. WINDOW TO MATCH EXISTING ADJACENT WINDOWS IN TYPE AND PROFILE 25 NEW ROOF ACCESS HATCH & LADDER - SEE SHEET A2.05 FOR DETAILS 26 EXISTING INTERIOR STOREFRONT TO REAMIN 27 EXISTING HISTORIC TELLER PARTITIONS AND STOREFRONT TO REMAIN 28 CLEAN AND POLISH EXISTING HISTORIC TILE FLOORS. 29 EXISTING DOOR TO REMAIN AND FIXED IN PLACE SO THAT THEY ARE NOT OPERABLE 30 EXISTING WOOD DOORS TO BE REPAIRED, RECEIVE NEW HARDWARE, PAINTED, AND RESTORED TO WORKING ORDER - SEE DOOR SCHEDULE FOR MORE INFORMATION 31 INSPECT EXISTING FLUE SHAFTS AND REPAIR BRICK AS NECESSARRY TO MAINTAIN A WATER TIGHT ASSEMBLY 32 INSTALL NEW FLUE CAP 33 NEW DRYER VENT EXHAUST OPENING 34 REPAIR AND RESTORE EXISTING HARDWOOD FLOOR AS NECESSARY AND CREATE ONE HOUR FLOOR/CEILING ASSEMBLY - SEE SPECIFICATIONS AND SHEET A0.01 FOR MORE 4TH\_FLOOR\_LOFT -4TH FLOOR LOFT \_ \_ \_ 3 RD FLOOR EL.: 30'-0" 1ST FLOOR 2 EL.: 2'-6" 1ST FLOOR EL.: 0'-0"

NORTH

A3.02 SCALE: 3/16" = 1'-0"

2 SOUTH
A3.02 SCALE: 3/16" = 1'-0"

TRUE PROJECT NORTH

A 3 . C

DHR PART II SUBMISSION

DHR PART II AMENDMENT I

Drawing Title


SOUTH


NORTH AND

ELEVATIONS

- THIS IS A HISTORIC REHABILITATION TAX CREDIT PROJECT. ALL WORK MUST BE ACCORDANCE WITH THE SECRETARY OF THE INTERIOR'S STANDARDS FOR HISTORIC REHABILITATION.
- 2. DIMENSIONS NOTED AS 'ALIGN', 'HOLD', 'CLEAR', ARE TO TAKE PRECEDENCE OVER OTHER DIMENSIONS IN CASE OF DISCREPANCIES BETWEEN DRAWINGS AND ARE ALWAYS TO FINISH FACE. ALL OTHER DIMENSIONS ARE TO FACE OF STUD UNLESS NOTED OTHERWISE. CONTACT ARCHITECT FOR CLARIFICATION
- 3. DOORS SHALL BE LOCATED 4" FROM ADJACENT PARTITIONS (HINGE SIDE) UNLESS NOTED OTHERWISE.
- 4. ALL PARTITIONS ARE TO BE PARTITION TYPE 1 UNLESS NOTED OTHERWISE. REFER TO SHEET A0.01 FOR WALL TYPES.
- 5. ALL TRANSITIONS OF FLOORING SHALL OCCUR @ CENTER LINE OF DOOR OPENINGS UNLESS NOTED OTHERWISE.
- 6. USE 1/2" WATER RESISTANT GWB IN ALL BATHROOMS UNLESS NOTE OTHERWISE. USE CEMENT BACKER BOARD @ ALL TILE LOCATIONS
- 7. ALL AREAS THAT INDICATE NEW INSULATION MUST MEET CURRENT IECC STANDARDS.
- 8. REFER TO ELEVATIONS FOR EXISTING AND NEW WINDOW INFORMATION
- 9. PATCH AND REPAIR EXISTING HISTORIC PLASTER WHERE IT HAS BEEN PREVIOUSLY REMOVED OR WHERE DAMAGED. SEE NPS BRIEF FOR METHODOLOGY
- 10. INTERIOR DEPTH DIMENSION OF CLOSETS TO BE 2'- 0" MINIMUM
- 11. REPAIR AND RESTORE PLASTER AT ALL EXTERIOR WALLS, HISTORIC INTERIOR WALLS, AND AT THE FIRST AND THIRD FLOOR CEILING.
- 12. AVOID REFINISHING FLOORS IN HISTORIC AREAS, CLEAN LIGHTLY. SAND ONLY AS NECESSARY AND OIL FLOOR BOARDS INSTEAD

CONSTRUCTION LEGEND			
(x)	CONSTUCTION NOTE SYMBOL		EXISTING WALL TO REMAIN
xx	WALL TYPE SYMBOL SEE SHEET A8.00		NEW CONSTRUCTION
(xx)	WINDOW TYPE SYMBOL SEE SHEET A8.05		MASONRY INFILL
	1 HOUR FIRE RATED WALL		NEW DOORS
	2 HOUR FIRE RATED WALL		EXISTING DOORS

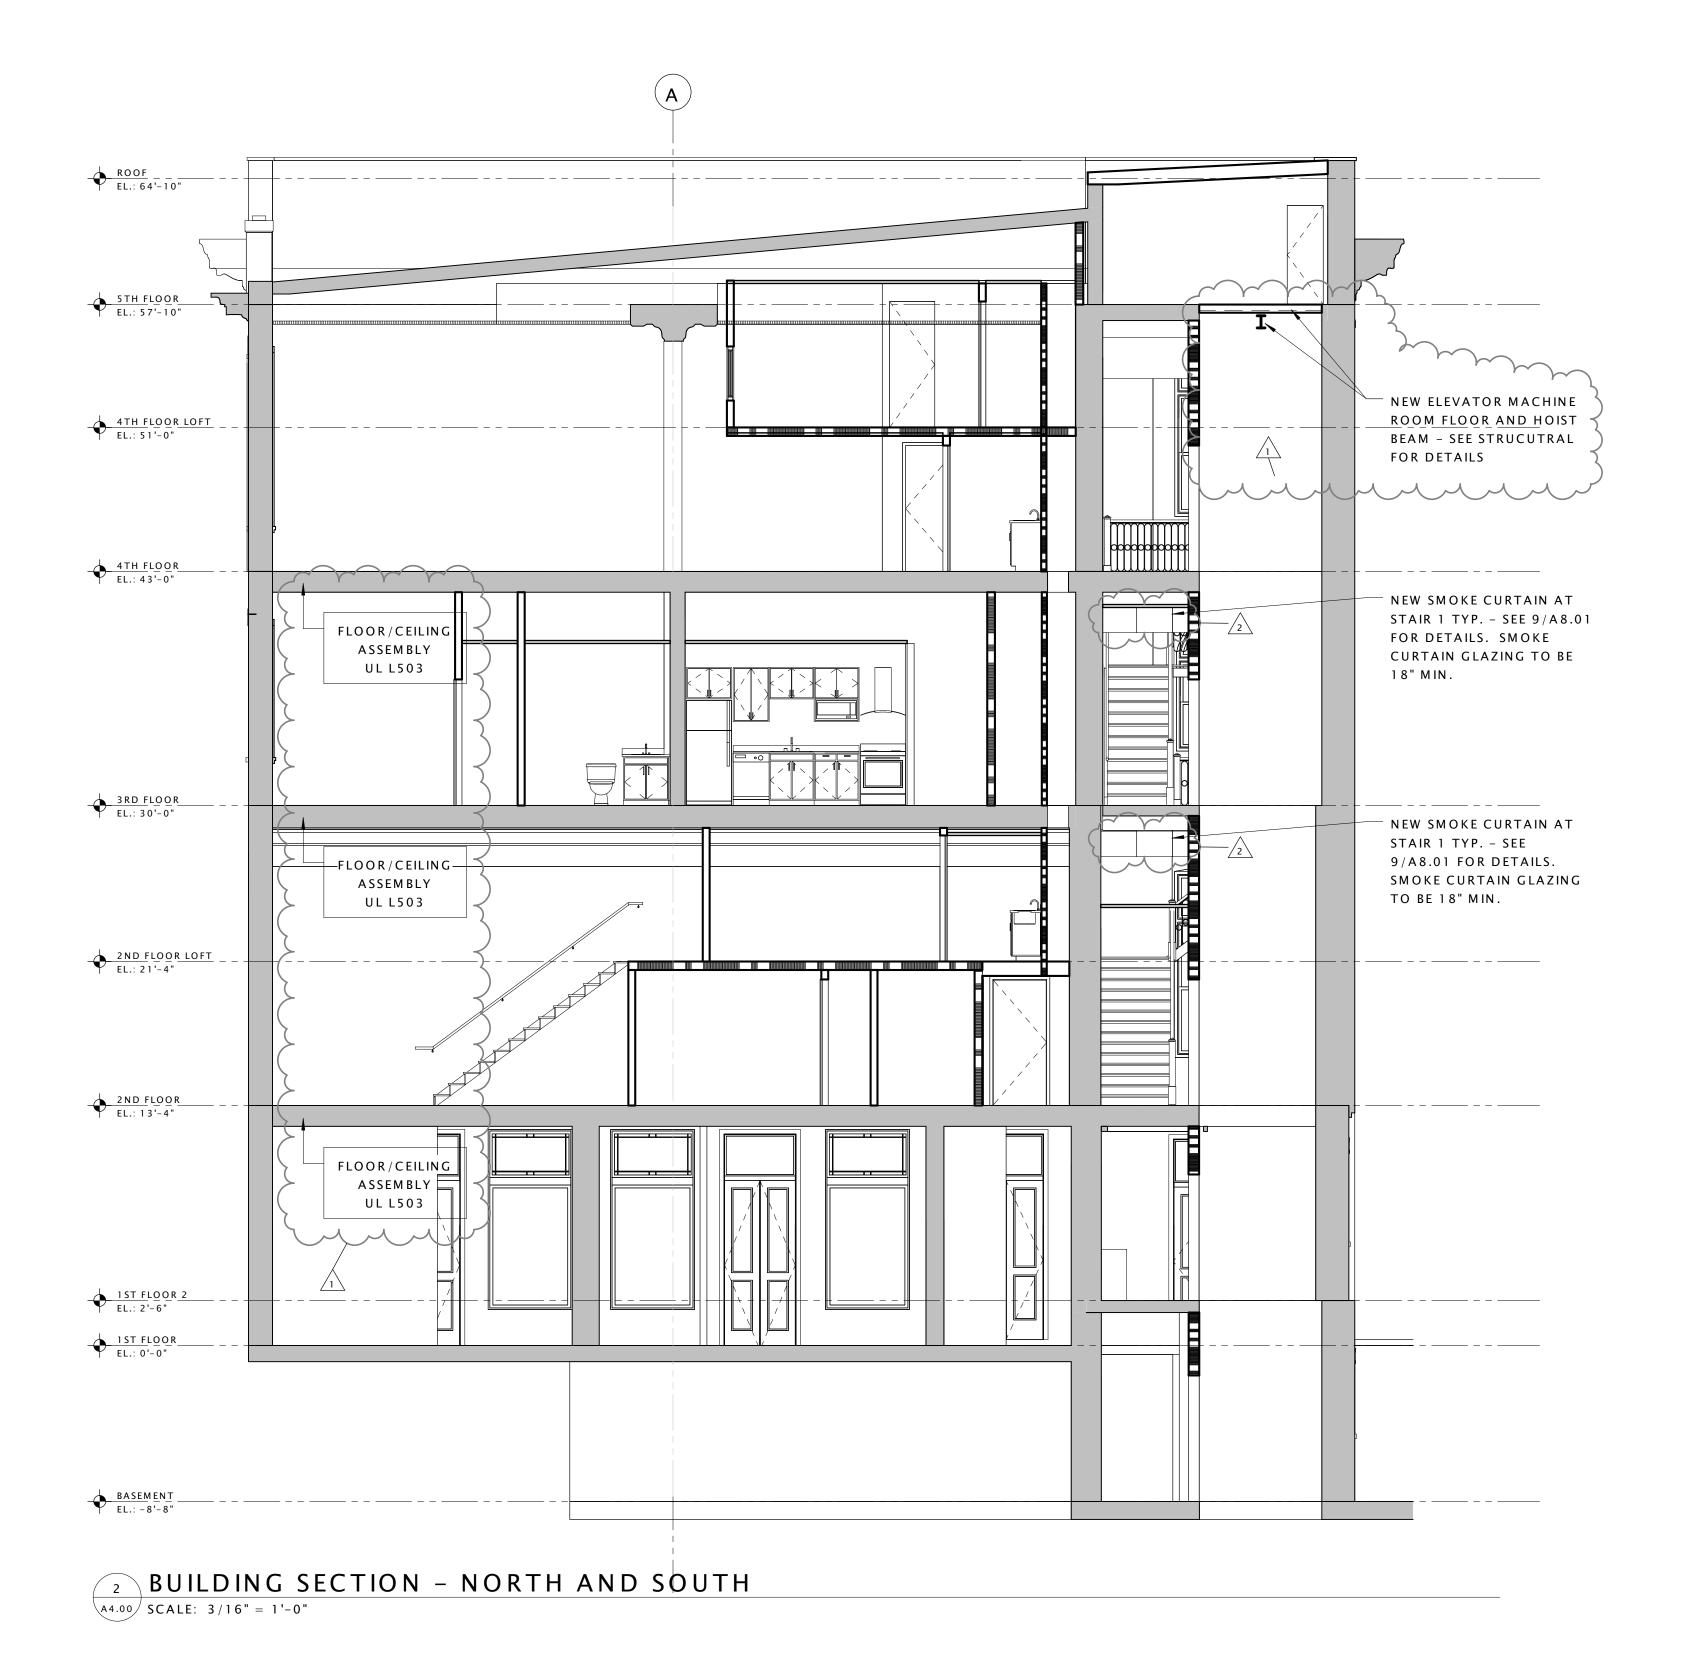

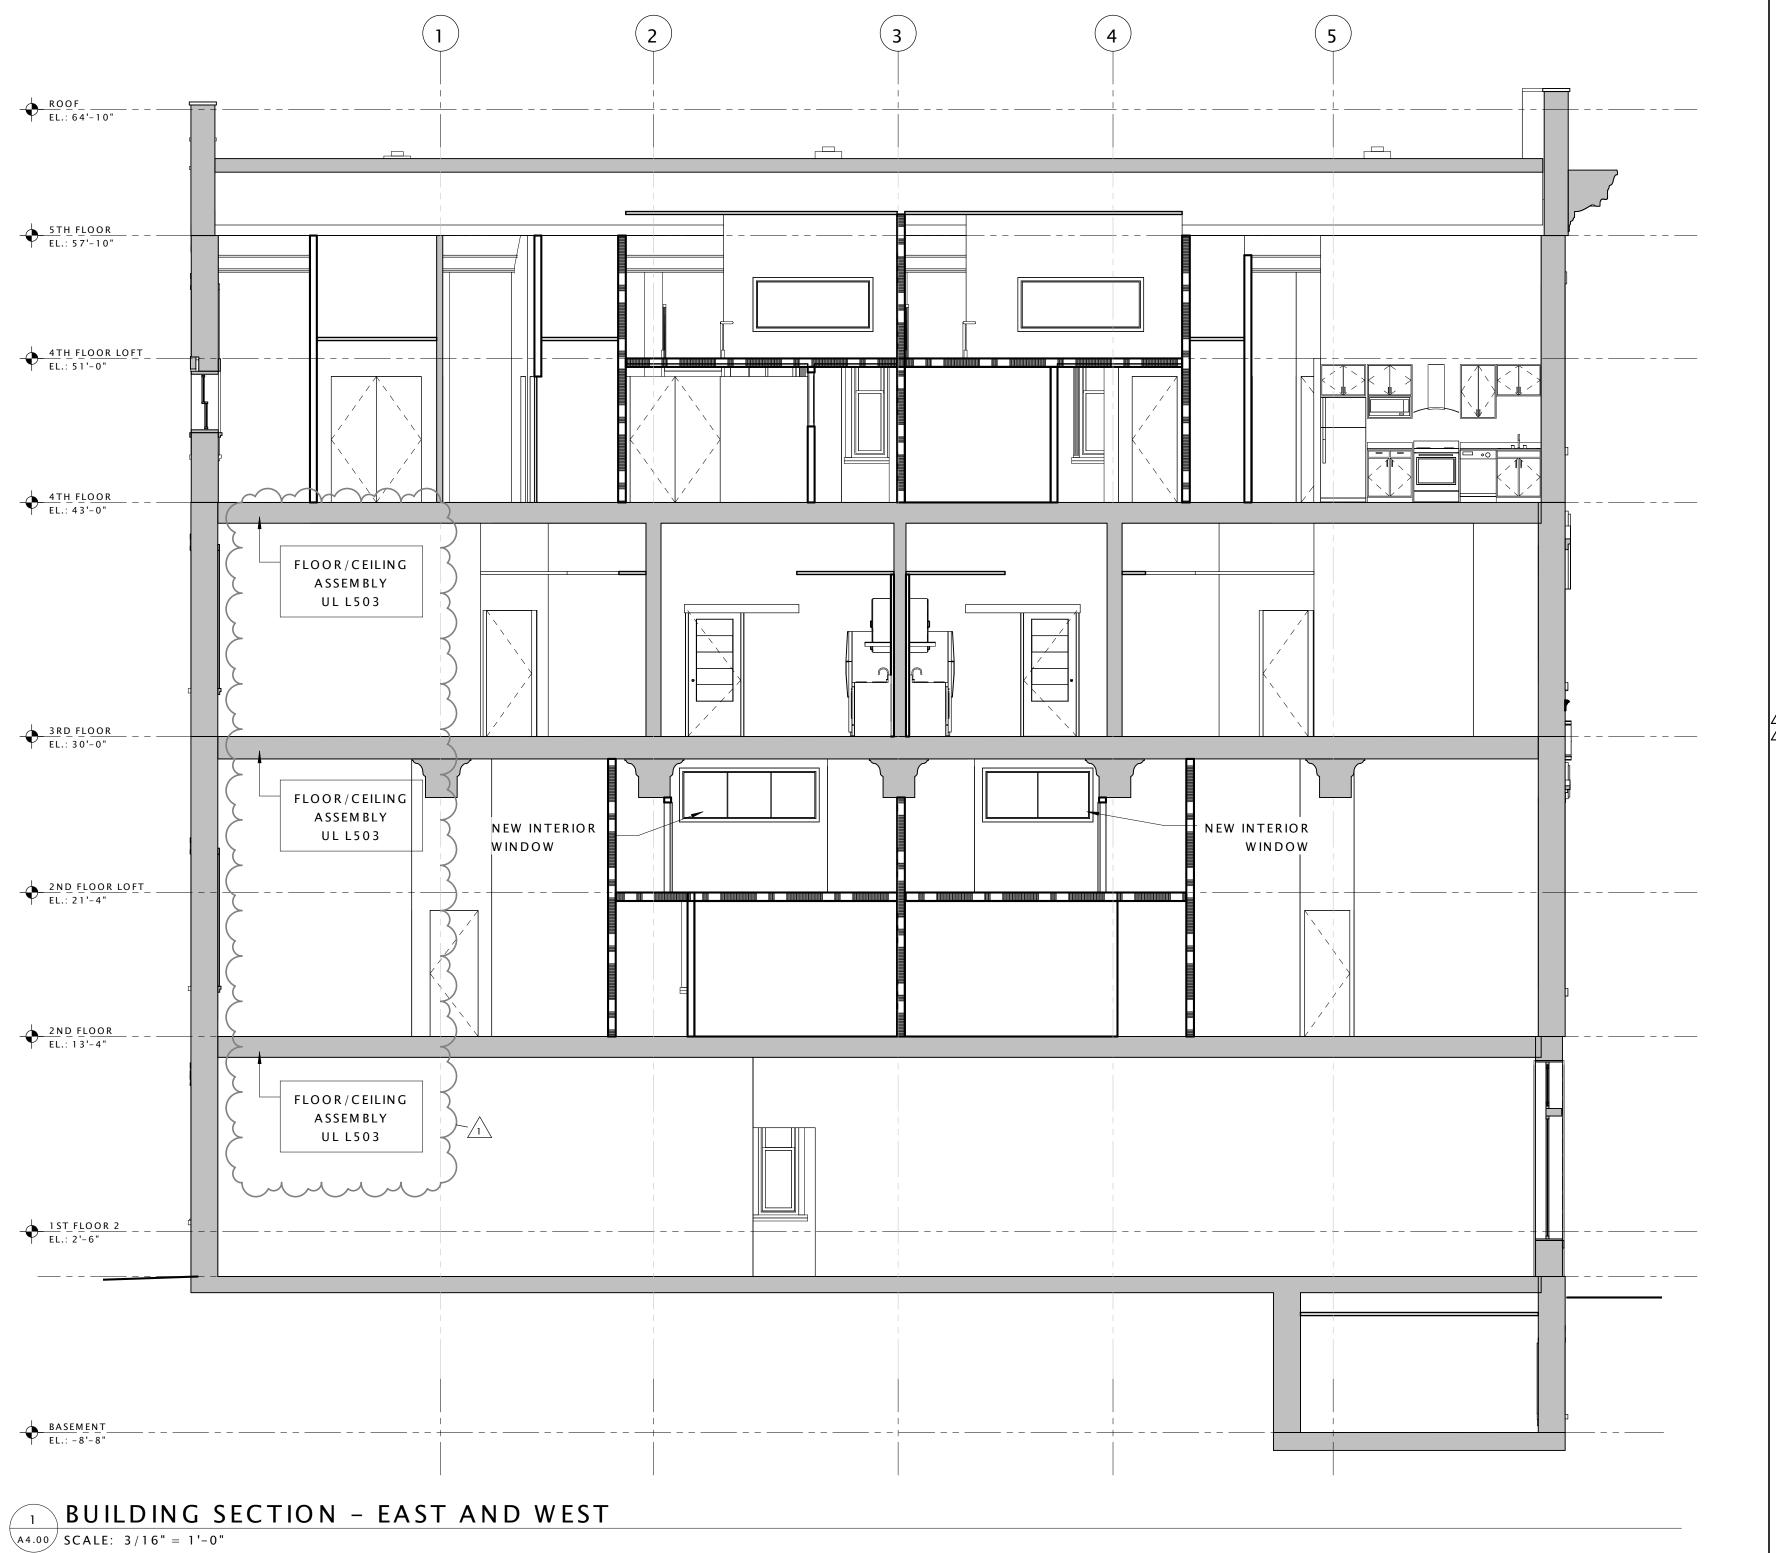


ommonweed the ARCHITECTS

LUKE BUILDIN

Date

DHR PART II SUBMISSION 10.26.16
PERMIT SET 01.18.17
DHR PART II AMENDMENT I 06.30.17
APERMIT SET RESPONSE 09.08.17
APERMIT SET RESPONSE 2 09.29.17

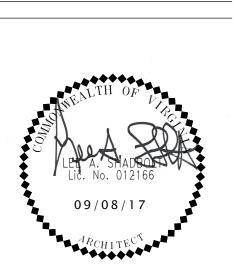

Drawing Title

BUILDING SECTIONS

TRUE PROJECT NORTH

A4.00

Comm No 1622.00


- 1. THIS IS A HISTORIC REHABILITATION TAX CREDIT PROJECT. ALL WORK MUST BE ACCORDANCE WITH THE SECRETARY OF THE INTERIOR'S STANDARDS FOR HISTORIC REHABILITATION.
- 2. DIMENSIONS NOTED AS 'ALIGN', 'HOLD', 'CLEAR', ARE TO TAKE PRECEDENCE OVER OTHER DIMENSIONS IN CASE OF DISCREPANCIES BETWEEN DRAWINGS AND ARE ALWAYS TO FINISH FACE. ALL OTHER DIMENSIONS ARE TO FACE OF STUD UNLESS NOTED OTHERWISE. CONTACT ARCHITECT FOR CLARIFICATION
- 3. DOORS SHALL BE LOCATED 4" FROM ADJACENT PARTITIONS (HINGE SIDE) UNLESS NOTED OTHERWISE.
- 4. ALL PARTITIONS ARE TO BE PARTITION TYPE 1 UNLESS NOTED OTHERWISE. REFER TO SHEET A0.01 FOR WALL TYPES.
- 5. ALL TRANSITIONS OF FLOORING SHALL OCCUR @ CENTER LINE OF DOOR OPENINGS UNLESS NOTED OTHERWISE.
- 6. USE 1/2" WATER RESISTANT GWB IN ALL BATHROOMS UNLESS NOTE OTHERWISE. USE CEMENT BACKER BOARD @ ALL TILE LOCATIONS
- 7. ALL AREAS THAT INDICATE NEW INSULATION MUST MEET CURRENT IECC STANDARDS.
- 8. REFER TO ELEVATIONS FOR EXISTING AND NEW WINDOW INFORMATION
- 9. PATCH AND REPAIR EXISTING HISTORIC PLASTER WHERE IT HAS BEEN PREVIOUSLY REMOVED OR WHERE DAMAGED. SEE NPS BRIEF FOR METHODOLOGY
- 10. INTERIOR DEPTH DIMENSION OF CLOSETS TO BE 2'- 0" MINIMUM
- 11. REPAIR AND RESTORE PLASTER AT ALL EXTERIOR WALLS, HISTORIC INTERIOR WALLS, AND AT THE FIRST AND THIRD FLOOR CEILING.
- 12. AVOID REFINISHING FLOORS IN HISTORIC AREAS, CLEAN LIGHTLY. SAND ONLY AS NECESSARY AND OIL FLOOR BOARDS INSTEAD


# CONSTRUCTION KEY NOTES - 🗴

- 1 EXISTING VAULT TO REMAIN
- 2 REPAIR AND PAINT EXISTING WAINSCOTING AT EXTERIOR WALLS AND HISTORIC PLASTER INTERIOR WALLS TYP. THROUGHOUT
- 3 REPAIR EXISTING WOOD JOISTS TO MAKE FLOOR STRUCTUALLY SOUND SEE STRUCTURAL
- 4 NEW CONCRETE STAIR AND LANDING AT EXISTING ENTRY SEE STRUCTURAL FOR
- DETAILS
- 5 REPAIR EXISTING CANOPY
- 6 NEW METAL GUARD RAIL AND HANDRAIL AT ENTRY
  7 RAISE EXISTING HISTORIC HANDRAIL TO CODE COMPLIANT HEIGHT
- 8 REPAIR AND PAINT EXISTING HISTORIC RAIL/GUARDRAIL
- 9 NEW LOFT FLOOR AT CONSTRUCTED OUT OF LIGHT GAGE FRAMING SEE STRUCTURAL
- FOR DETAILS

  10 NEW STAIR IN THIS LOCATION.
- 11 NEW INTERIOR WOOD WINDOW AT BEDROOM WALL
- 12 EXISTING HISTORIC WALL AND TRANSOM WINDOWS TO BE RESTORED AND PAINTED
- 13 EXISTING HISTORIC EXTERIOR STOREFRONT TO BE RESTORED SEE SPECIFICATIONS FOR ALLOWABLE RESTORATION METHODS
- 14 RESTORE AND REPAIR EXISTING DECORATIVE CORNICE
- 15 RESTORE EXISTING BUILT-IN GUTTER
- 16 INSTALL NEW ALUMINUM 4" DOWNSPUT
- 17 NEW MEMBRANE ROOF ON 1/2" COVER BOARD AND (2) LAYERS OF 2" POLYISO INSULATION
- 18 REPAIR AND PAINT EXISTING WOOD DENTAL MOLDING
- 19 EXISTING FIRE ESCAPE DOORS TO REMAIN AND BE FIXED IN PLACE SO THAT THEY ARE NOT OPERABLE. DOORS TO BE REPAIRED AND REPAINTED. EXISTING WIRE GLASS TO BE REPAIRED AS NECESSARY.
- 20 INSTALL NEW WOOD WINDOW IN EXISTING LOCATION
- 21 INSPECT EXISTING MASONRY AFTER REMOVAL OF INVASIVE VEGETATION. REPAINT AND REPAIR BRICK AND MORTAR. MATCH SURROUNDING MORTAR IN MATERIAL, COMPOSITION, COLOR, AGGREGATE, & HARDNESS.
- 22 INSTALL SALVAGED TIN CEILING. SEE REFLECTED CEILING PLANS FOR MORE DETAILS.

  23 EXISTING VALUET DOOR TO BE OPENED AND FIXED IN PLACE
- 23 EXISTING VAULT DOOR TO BE OPENED AND FIXED IN PLACE
  24 NEW WOOD WINDOW IN INDICATED LOCATION. WINDOW TO MATCH EXISTING
- ADJACENT WINDOWS IN TYPE AND PROFILE
- NEW ROOF ACCESS HATCH & LADDER SEE SHEET A2.05 FOR DETAILS
- 26 EXISTING INTERIOR STOREFRONT TO REAMIN
- 27 EXISTING HISTORIC TELLER PARTITIONS AND STOREFRONT TO REMAIN
- CLEAN AND POLISH EXISTING HISTORIC TILE FLOORS.EXISTING DOOR TO REMAIN AND FIXED IN PLACE SO THAT THEY ARE NOT OPERABLE
- 30 EXISTING WOOD DOORS TO BE REPAIRED, RECEIVE NEW HARDWARE, PAINTED, AND RESTORED TO WORKING ORDER SEE DOOR SCHEDULE FOR MORE INFORMATION
- 31 INSPECT EXISTING FLUE SHAFTS AND REPAIR BRICK AS NECESSARRY TO MAINTAIN A
- WATER TIGHT ASSEMBLY
  32 INSTALL NEW FLUE CAP
- 33 NEW DRYER VENT EXHAUST OPENING
- 34 REPAIR AND RESTORE EXISTING HARDWOOD FLOOR AS NECESSARY AND CREATE ONE HOUR FLOOR/CEILING ASSEMBLY SEE SPECIFICATIONS AND SHEET A0.01 FOR MORE INFORMATION

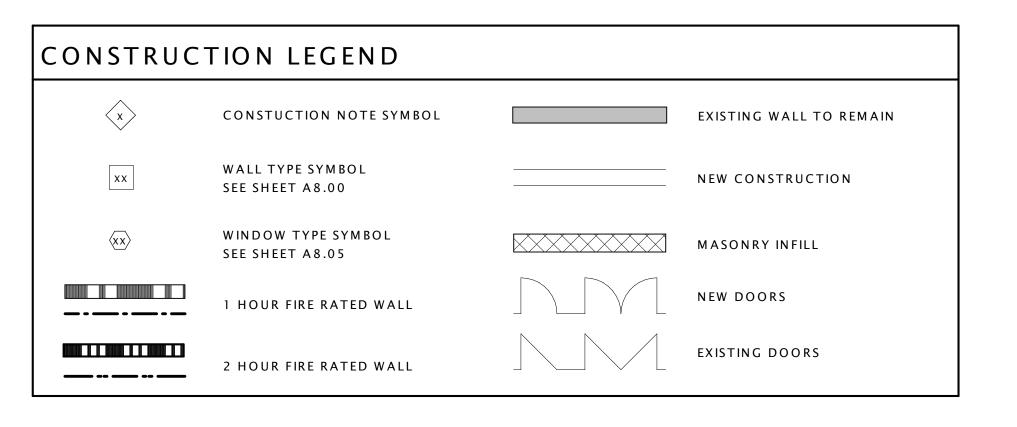

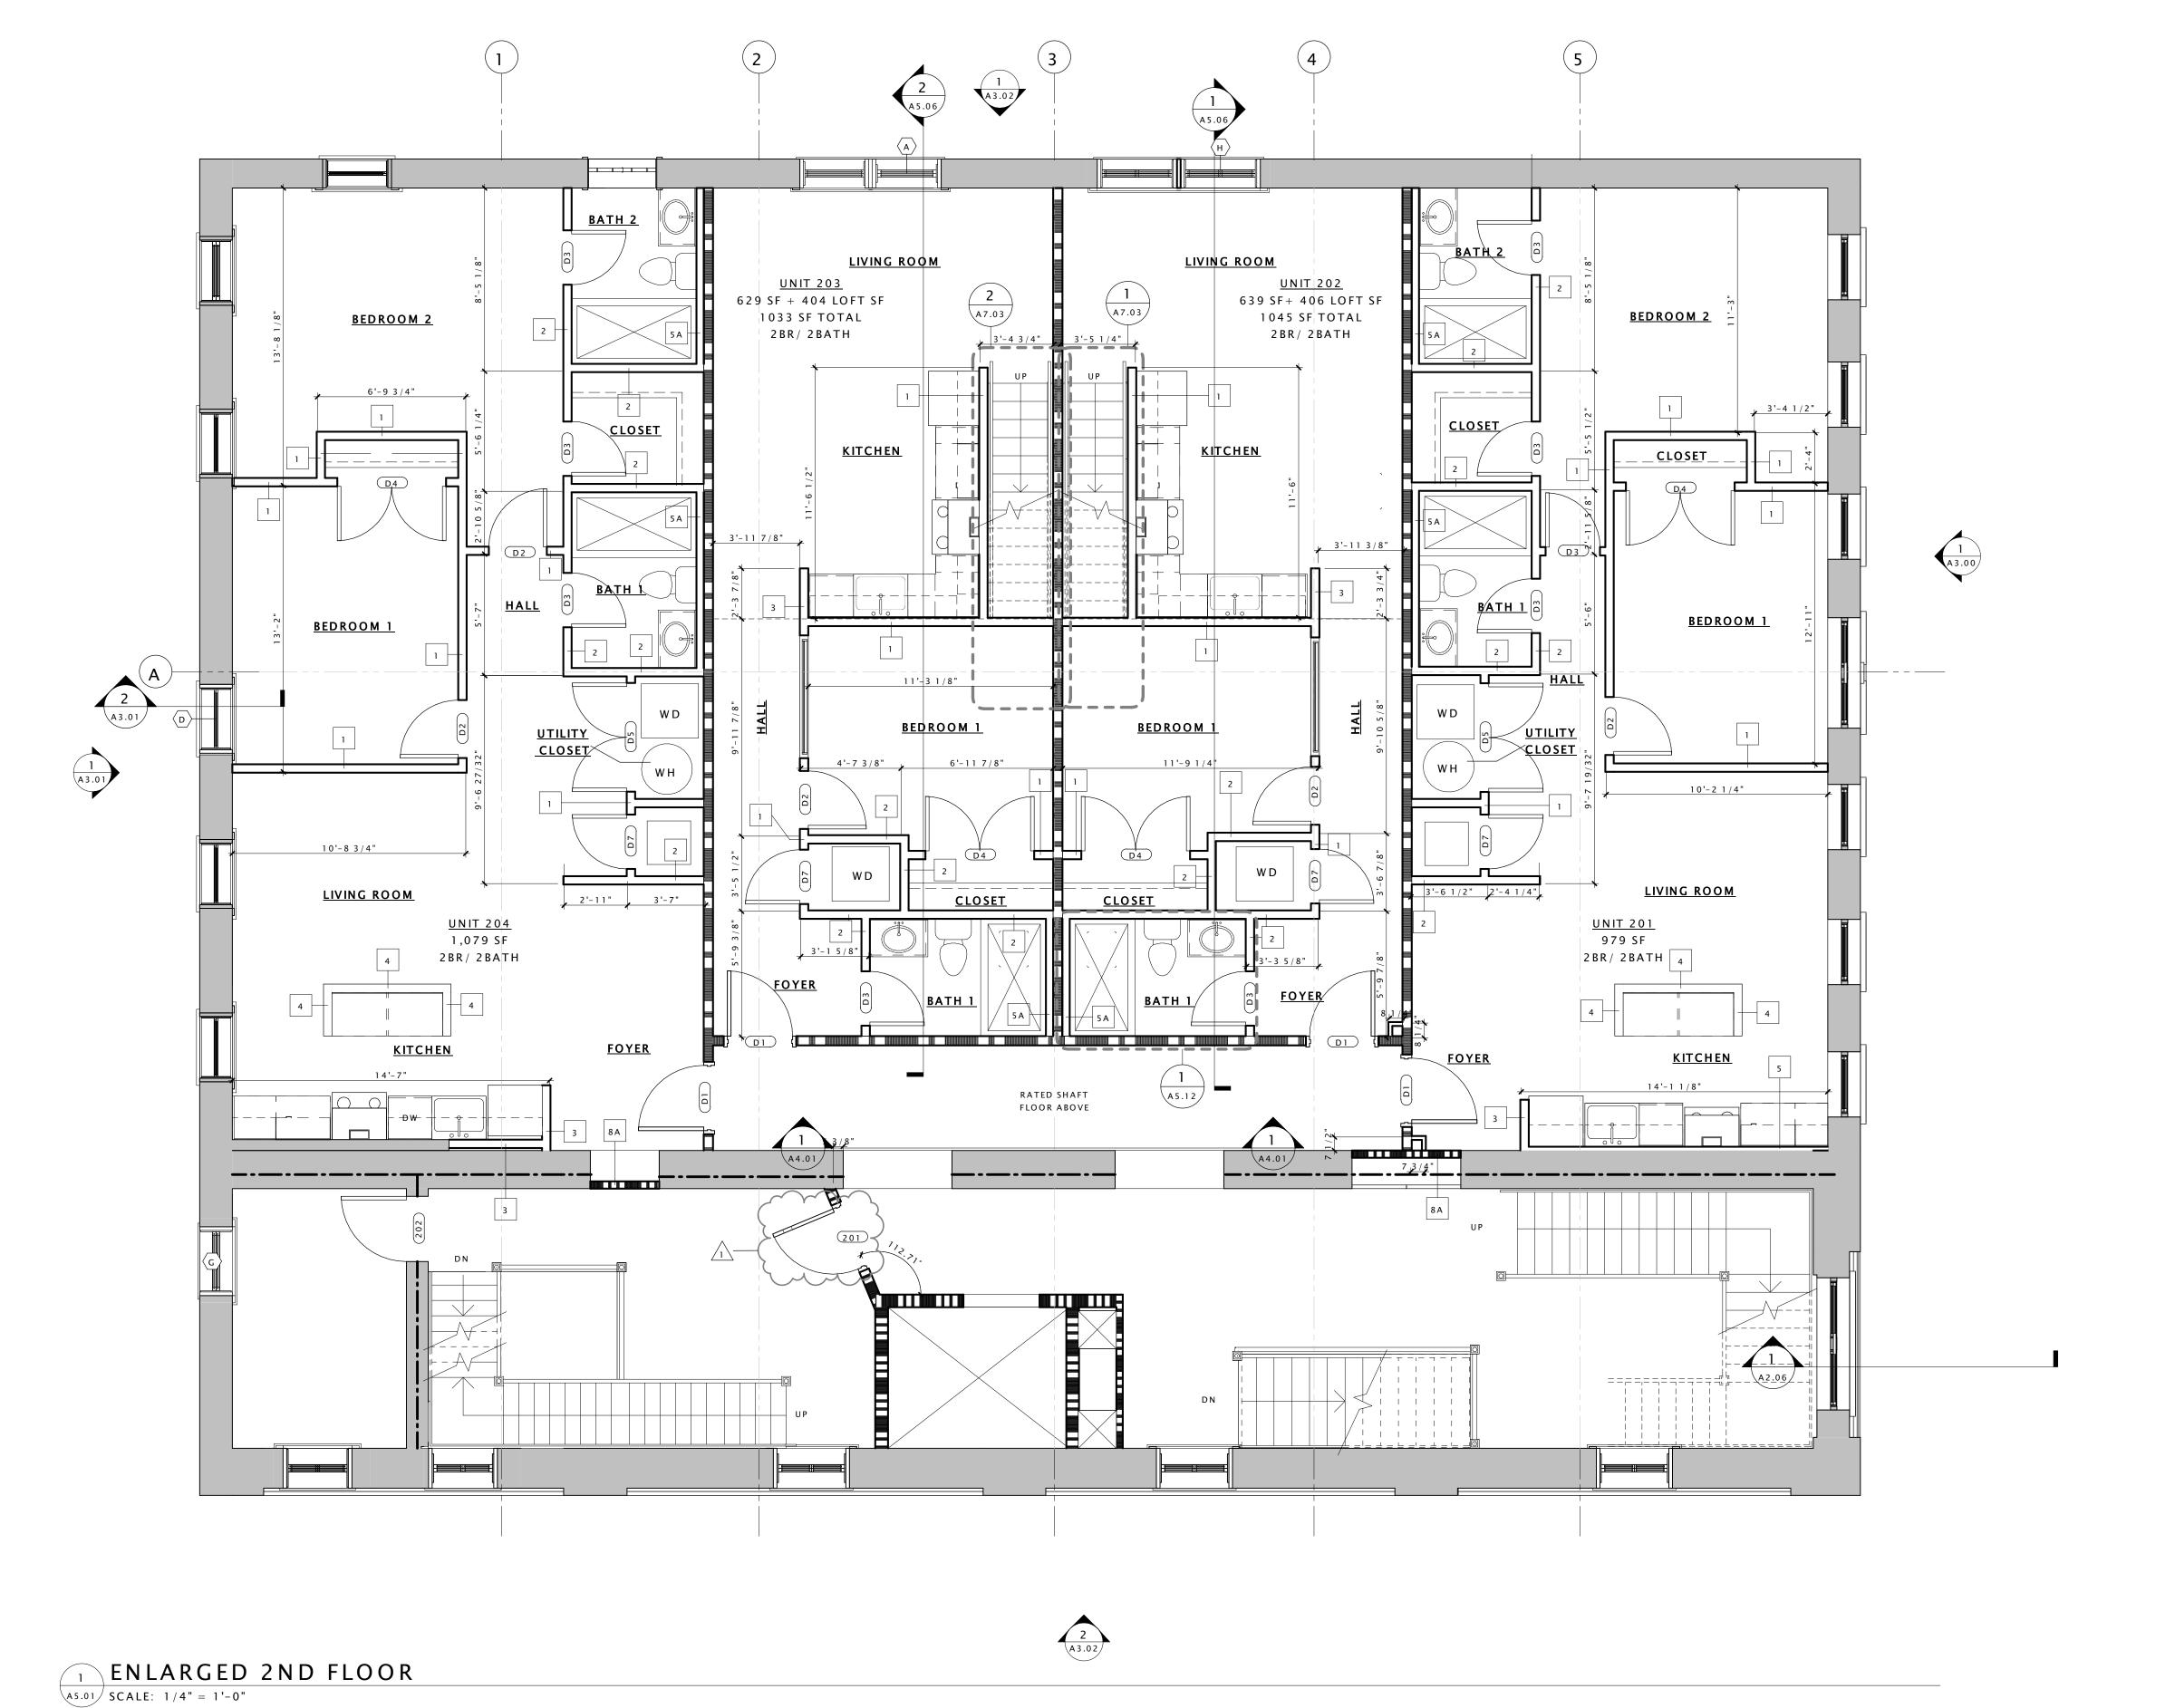



101 SHOCKOE SLIP, THIR
RICHMOND, VIRGINIA 2

S

0

Date

DHR PART II SUBMISSION 10.26.16

PERMIT SET 01.18.17

DHR PART II AMENDMENT I 06.30.17

PERMIT SET RESPONSE 09.08.17


PERMIT SET RESPONSE 2 09.29.17



Drawing Title

ENLARGED 2ND FLOOR PLAN


TRUE PROJECT
NORTH NORTH

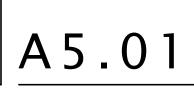


- 1. THIS IS A HISTORIC REHABILITATION TAX CREDIT PROJECT. ALL WORK MUST BE ACCORDANCE WITH THE SECRETARY OF THE INTERIOR'S STANDARDS FOR HISTORIC REHABILITATION.
- 2. DIMENSIONS NOTED AS 'ALIGN', 'HOLD', 'CLEAR', ARE TO TAKE PRECEDENCE OVER OTHER DIMENSIONS IN CASE OF DISCREPANCIES BETWEEN DRAWINGS AND ARE ALWAYS TO FINISH FACE. ALL OTHER DIMENSIONS ARE TO FACE OF STUD UNLESS NOTED OTHERWISE. CONTACT ARCHITECT FOR CLARIFICATION
- 3. DOORS SHALL BE LOCATED 4" FROM ADJACENT PARTITIONS (HINGE SIDE) UNLESS NOTED OTHERWISE.
- 4. ALL PARTITIONS ARE TO BE PARTITION TYPE 1 UNLESS NOTED OTHERWISE. REFER TO SHEET A0.01 FOR WALL TYPES.
- 5. ALL TRANSITIONS OF FLOORING SHALL OCCUR @ CENTER LINE OF DOOR OPENINGS UNLESS NOTED OTHERWISE.
- 6. USE 1/2" WATER RESISTANT GWB IN ALL BATHROOMS UNLESS NOTE OTHERWISE. USE CEMENT BACKER BOARD @ ALL TILE LOCATIONS
- 7. ALL AREAS THAT INDICATE NEW INSULATION MUST MEET CURRENT IECC STANDARDS.
- 8. REFER TO ELEVATIONS FOR EXISTING AND NEW WINDOW INFORMATION
- 9. PATCH AND REPAIR EXISTING HISTORIC PLASTER WHERE IT HAS BEEN PREVIOUSLY REMOVED OR WHERE DAMAGED. SEE NPS BRIEF FOR METHODOLOGY
- 10. INTERIOR DEPTH DIMENSION OF CLOSETS TO BE 2'- 0" MINIMUM
- 11. REPAIR AND RESTORE PLASTER AT ALL EXTERIOR WALLS, HISTORIC INTERIOR WALLS, AND AT THE FIRST AND THIRD FLOOR CEILING.
- 12. AVOID REFINISHING FLOORS IN HISTORIC AREAS, CLEAN LIGHTLY. SAND ONLY AS NECESSARY AND OIL FLOOR BOARDS INSTEAD

# CONSTRUCTION KEY NOTES X

- 1 EXISTING VAULT TO REMAIN
- 2 REPAIR AND PAINT EXISTING WAINSCOTING AT EXTERIOR WALLS AND HISTORIC PLASTER INTERIOR WALLS TYP. THROUGHOUT
- 3 REPAIR EXISTING WOOD JOISTS TO MAKE FLOOR STRUCTUALLY SOUND SEE
- 4 NEW CONCRETE STAIR AND LANDING AT EXISTING ENTRY SEE STRUCTURAL FOR
- DETAILS 5 REPAIR EXISTING CANOPY
- 6 NEW METAL GUARD RAIL AND HANDRAIL AT ENTRY
- 7 RAISE EXISTING HISTORIC HANDRAIL TO CODE COMPLIANT HEIGHT
- 8 REPAIR AND PAINT EXISTING HISTORIC RAIL/GUARDRAIL
- 9 NEW LOFT FLOOR AT CONSTRUCTED OUT OF LIGHT GAGE FRAMING SEE STRUCTURAL FOR DETAILS
- 10 NEW STAIR IN THIS LOCATION.
- 11 NEW INTERIOR WOOD WINDOW AT BEDROOM WALL
- 12 EXISTING HISTORIC WALL AND TRANSOM WINDOWS TO BE RESTORED AND PAINTED
- 13 EXISTING HISTORIC EXTERIOR STOREFRONT TO BE RESTORED SEE SPECIFICATIONS FOR ALLOWABLE RESTORATION METHODS
- 14 RESTORE AND REPAIR EXISTING DECORATIVE CORNICE
- 15 RESTORE EXISTING BUILT-IN GUTTER
- 16 INSTALL NEW ALUMINUM 4" DOWNSPUT
- 17 NEW MEMBRANE ROOF ON 1/2" COVER BOARD AND (2) LAYERS OF 2" POLYISO INSULATION
- 18 REPAIR AND PAINT EXISTING WOOD DENTAL MOLDING
- 19 EXISTING FIRE ESCAPE DOORS TO REMAIN AND BE FIXED IN PLACE SO THAT THEY ARE NOT OPERABLE. DOORS TO BE REPAIRED AND REPAINTED. EXISTING WIRE GLASS TO BE REPAIRED AS NECESSARY.
- 20 INSTALL NEW WOOD WINDOW IN EXISTING LOCATION
- 21 INSPECT EXISTING MASONRY AFTER REMOVAL OF INVASIVE VEGETATION. REPAINT AND REPAIR BRICK AND MORTAR. MATCH SURROUNDING MORTAR IN MATERIAL, COMPOSITION, COLOR, AGGREGATE, & HARDNESS.
- 22 INSTALL SALVAGED TIN CEILING. SEE REFLECTED CEILING PLANS FOR MORE DETAILS.
- 23 EXISTING VAULT DOOR TO BE OPENED AND FIXED IN PLACE 24 NEW WOOD WINDOW IN INDICATED LOCATION. WINDOW TO MATCH EXISTING
- ADJACENT WINDOWS IN TYPE AND PROFILE 25 NEW ROOF ACCESS HATCH & LADDER - SEE SHEET A2.05 FOR DETAILS
- 26 EXISTING INTERIOR STOREFRONT TO REAMIN
- 27 EXISTING HISTORIC TELLER PARTITIONS AND STOREFRONT TO REMAIN
- 28 CLEAN AND POLISH EXISTING HISTORIC TILE FLOORS.
- 29 EXISTING DOOR TO REMAIN AND FIXED IN PLACE SO THAT THEY ARE NOT OPERABLE 30 EXISTING WOOD DOORS TO BE REPAIRED, RECEIVE NEW HARDWARE, PAINTED, AND
- RESTORED TO WORKING ORDER SEE DOOR SCHEDULE FOR MORE INFORMATION
- 31 INSPECT EXISTING FLUE SHAFTS AND REPAIR BRICK AS NECESSARRY TO MAINTAIN A WATER TIGHT ASSEMBLY
- 32 INSTALL NEW FLUE CAP
- 33 NEW DRYER VENT EXHAUST OPENING
- 34 REPAIR AND RESTORE EXISTING HARDWOOD FLOOR AS NECESSARY AND CREATE ONE HOUR FLOOR/CEILING ASSEMBLY - SEE SPECIFICATIONS AND SHEET A0.01 FOR MORE INFORMATION

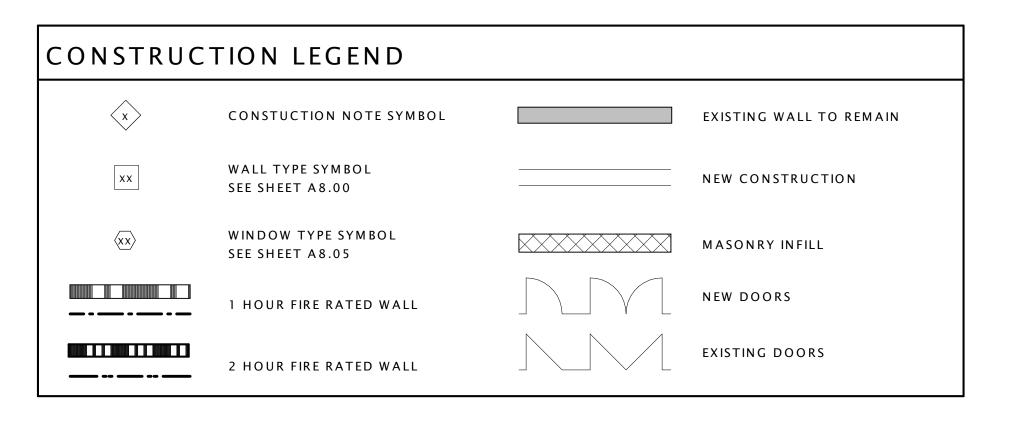

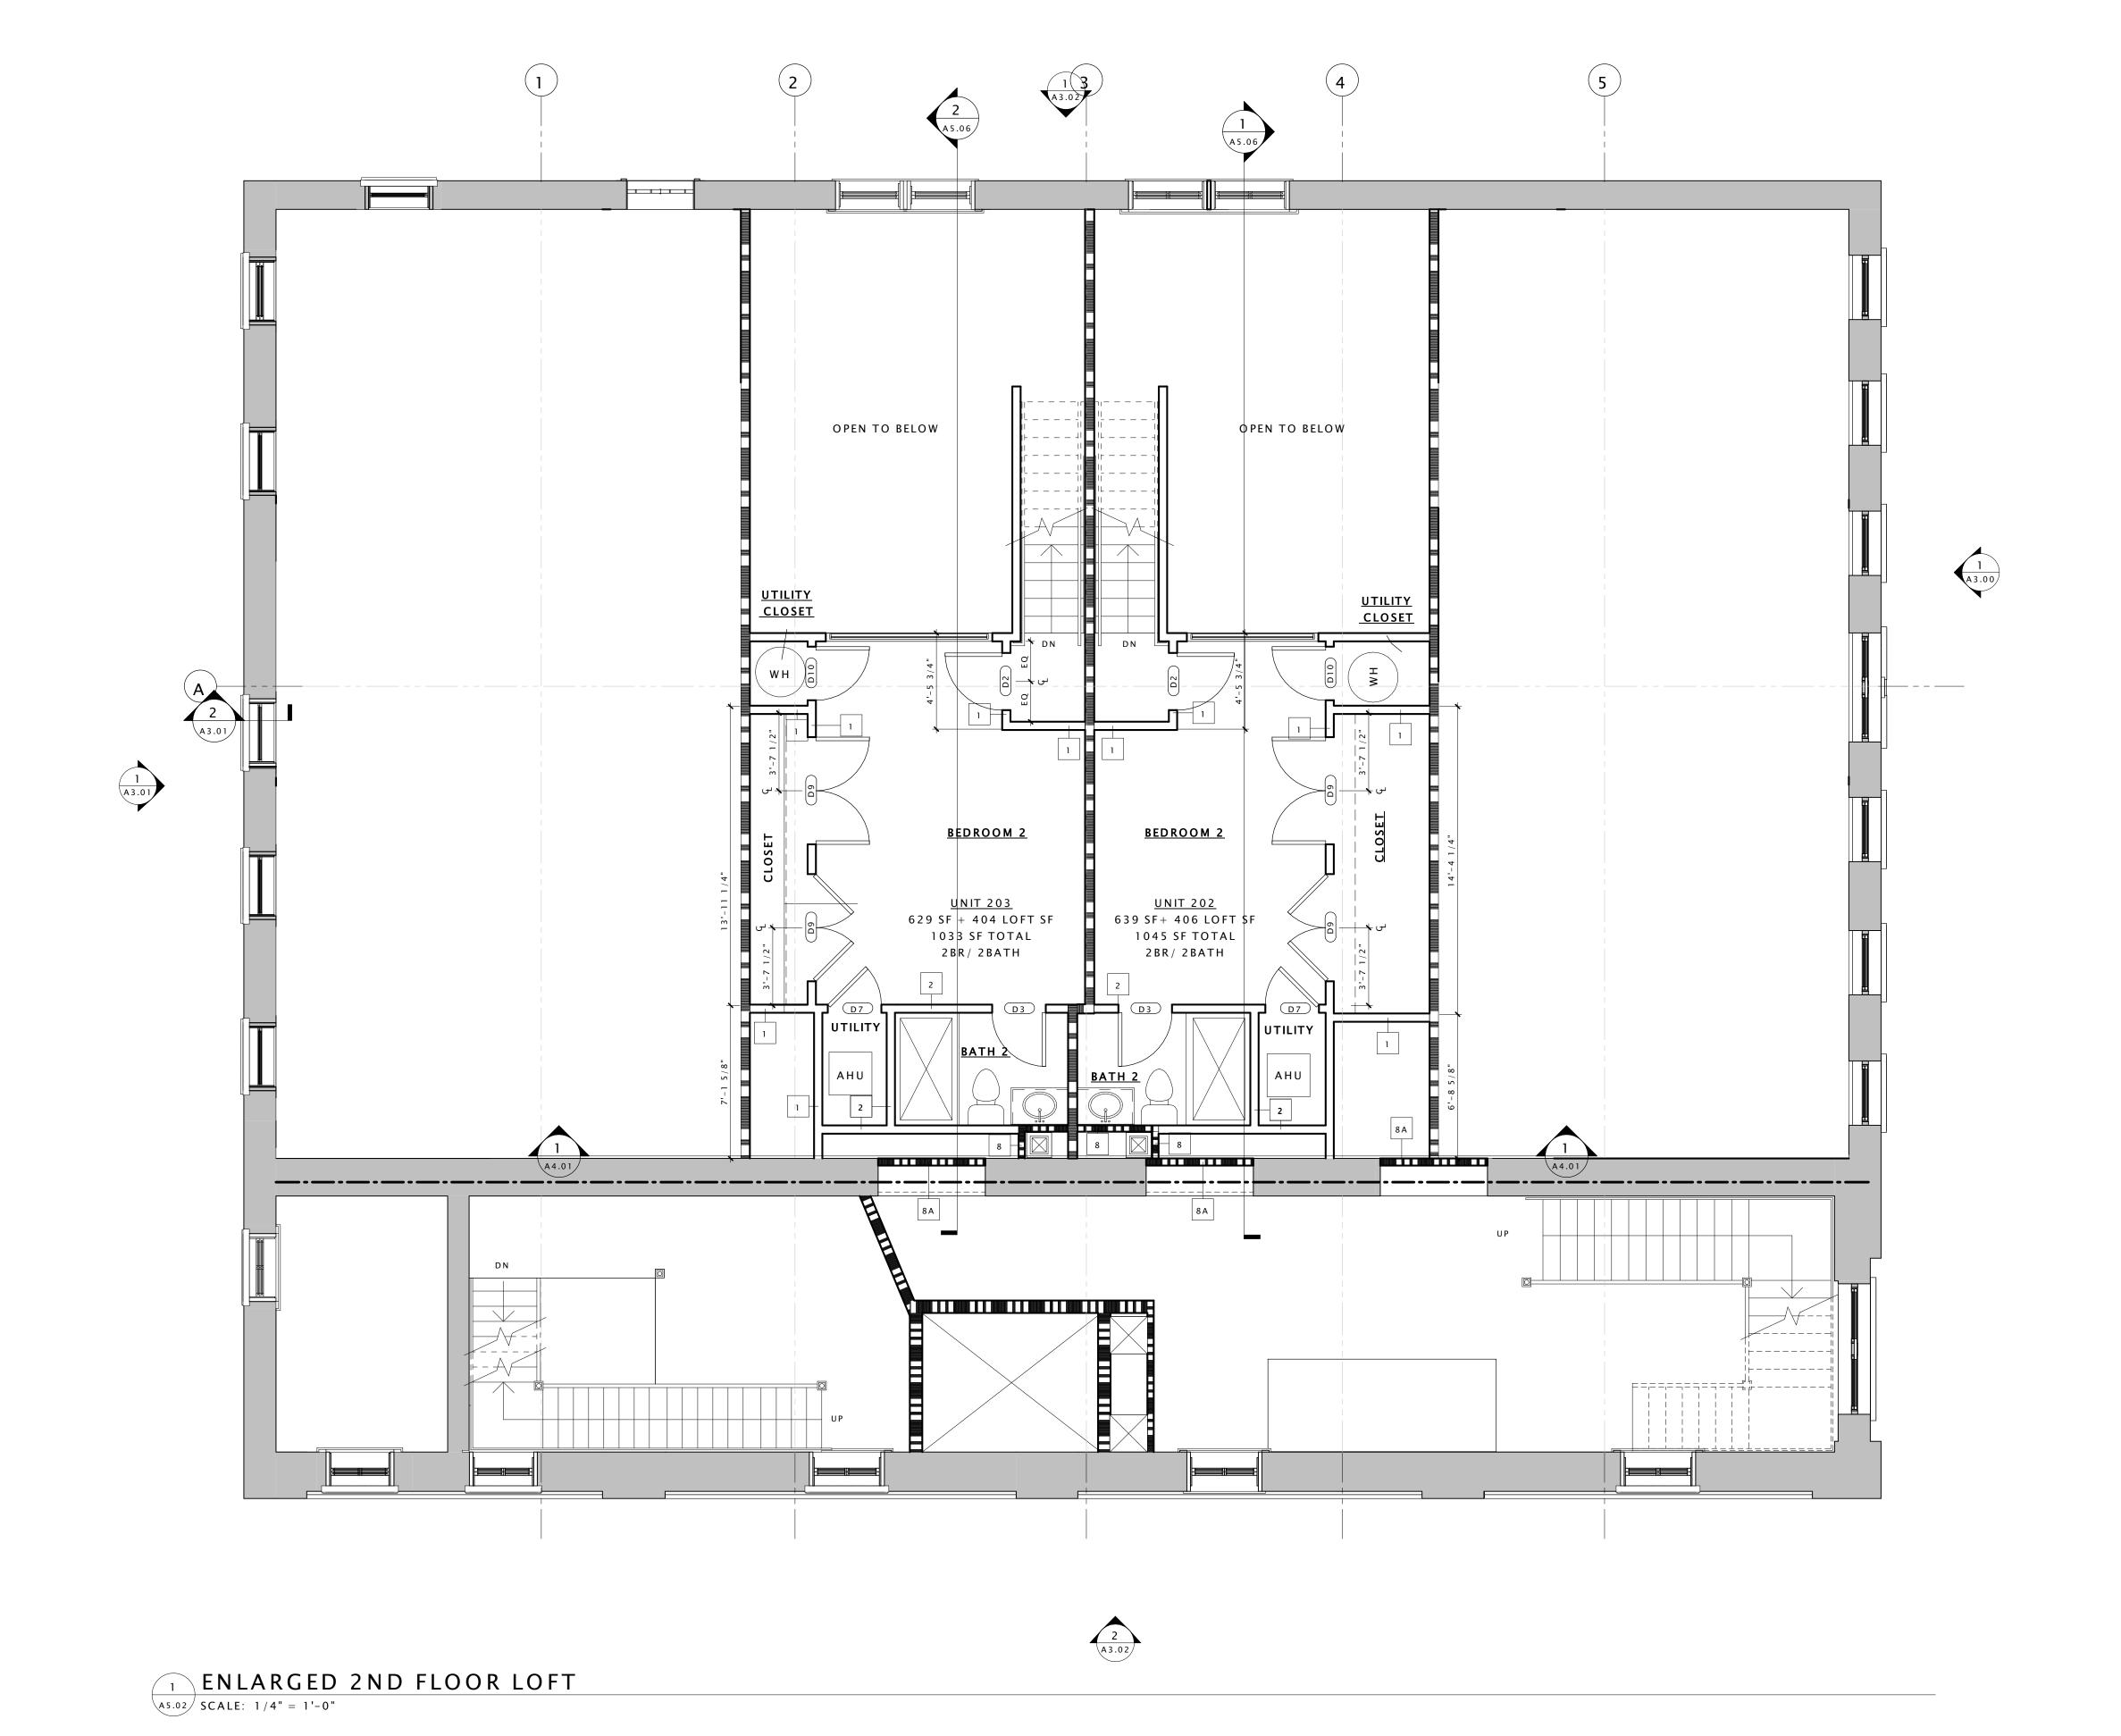



0

DHR PART II SUBMISSION 10.26.16 PERMIT SET DHR PART II AMENDMENT I PERMIT SET RESPONSE 09.08.17 PERMIT SET RESPONSE 2



Drawing Title


ENLARGED 2ND FLOOR LOFT PLAN



- 1. THIS IS A HISTORIC REHABILITATION TAX CREDIT PROJECT. ALL WORK MUST BE ACCORDANCE WITH THE SECRETARY OF THE INTERIOR'S STANDARDS FOR HISTORIC REHABILITATION.
- 2. DIMENSIONS NOTED AS 'ALIGN', 'HOLD', 'CLEAR', ARE TO TAKE PRECEDENCE OVER OTHER DIMENSIONS IN CASE OF DISCREPANCIES BETWEEN DRAWINGS AND ARE ALWAYS TO FINISH FACE. ALL OTHER DIMENSIONS ARE TO FACE OF STUD UNLESS NOTED OTHERWISE. CONTACT ARCHITECT FOR CLARIFICATION
- 3. DOORS SHALL BE LOCATED 4" FROM ADJACENT PARTITIONS (HINGE SIDE) UNLESS NOTED OTHERWISE.
- 4. ALL PARTITIONS ARE TO BE PARTITION TYPE 1 UNLESS NOTED OTHERWISE. REFER TO SHEET A0.01 FOR WALL TYPES.
- 5. ALL TRANSITIONS OF FLOORING SHALL OCCUR @ CENTER LINE OF DOOR OPENINGS UNLESS NOTED OTHERWISE.
- 6. USE 1/2" WATER RESISTANT GWB IN ALL BATHROOMS UNLESS NOTE OTHERWISE. USE CEMENT BACKER BOARD @ ALL TILE LOCATIONS
- 7. ALL AREAS THAT INDICATE NEW INSULATION MUST MEET CURRENT IECC STANDARDS.
- 8. REFER TO ELEVATIONS FOR EXISTING AND NEW WINDOW INFORMATION
- 9. PATCH AND REPAIR EXISTING HISTORIC PLASTER WHERE IT HAS BEEN PREVIOUSLY REMOVED OR WHERE DAMAGED. SEE NPS BRIEF FOR METHODOLOGY
- 10. INTERIOR DEPTH DIMENSION OF CLOSETS TO BE 2'- 0" MINIMUM
- 11. REPAIR AND RESTORE PLASTER AT ALL EXTERIOR WALLS, HISTORIC INTERIOR WALLS, AND AT THE FIRST AND THIRD FLOOR CEILING.
- 12. AVOID REFINISHING FLOORS IN HISTORIC AREAS, CLEAN LIGHTLY. SAND ONLY AS NECESSARY AND OIL FLOOR BOARDS INSTEAD


# CONSTRUCTION KEY NOTES- ×

- 1 EXISTING VAULT TO REMAIN
- 2 REPAIR AND PAINT EXISTING WAINSCOTING AT EXTERIOR WALLS AND HISTORIC PLASTER INTERIOR WALLS TYP. THROUGHOUT
- 3 REPAIR EXISTING WOOD JOISTS TO MAKE FLOOR STRUCTUALLY SOUND SEE
- STRUCTURAL
- 4 NEW CONCRETE STAIR AND LANDING AT EXISTING ENTRY SEE STRUCTURAL FOR DETAILS
- 5 REPAIR EXISTING CANOPY
- 6 NEW METAL GUARD RAIL AND HANDRAIL AT ENTRY
- 7 RAISE EXISTING HISTORIC HANDRAIL TO CODE COMPLIANT HEIGHT
- 8 REPAIR AND PAINT EXISTING HISTORIC RAIL/GUARDRAIL
- 9 NEW LOFT FLOOR AT CONSTRUCTED OUT OF LIGHT GAGE FRAMING SEE STRUCTURAL FOR DETAILS
- 10 NEW STAIR IN THIS LOCATION.
- 11 NEW INTERIOR WOOD WINDOW AT BEDROOM WALL
- 12 EXISTING HISTORIC WALL AND TRANSOM WINDOWS TO BE RESTORED AND PAINTED
- 13 EXISTING HISTORIC EXTERIOR STOREFRONT TO BE RESTORED SEE SPECIFICATIONS FOR ALLOWABLE RESTORATION METHODS
- 14 RESTORE AND REPAIR EXISTING DECORATIVE CORNICE
- 15 RESTORE EXISTING BUILT-IN GUTTER 16 INSTALL NEW ALUMINUM 4" DOWNSPUT
- 17 NEW MEMBRANE ROOF ON 1/2" COVER BOARD AND (2) LAYERS OF 2" POLYISO
- INSULATION 18 REPAIR AND PAINT EXISTING WOOD DENTAL MOLDING
- 19 EXISTING FIRE ESCAPE DOORS TO REMAIN AND BE FIXED IN PLACE SO THAT THEY ARE NOT OPERABLE. DOORS TO BE REPAIRED AND REPAINTED. EXISTING WIRE GLASS TO BE REPAIRED AS NECESSARY.
- 20 INSTALL NEW WOOD WINDOW IN EXISTING LOCATION
- 21 INSPECT EXISTING MASONRY AFTER REMOVAL OF INVASIVE VEGETATION. REPAINT AND REPAIR BRICK AND MORTAR. MATCH SURROUNDING MORTAR IN MATERIAL, COMPOSITION, COLOR, AGGREGATE, & HARDNESS.
- 22 INSTALL SALVAGED TIN CEILING. SEE REFLECTED CEILING PLANS FOR MORE DETAILS.
- 23 EXISTING VAULT DOOR TO BE OPENED AND FIXED IN PLACE
- 24 NEW WOOD WINDOW IN INDICATED LOCATION. WINDOW TO MATCH EXISTING ADJACENT WINDOWS IN TYPE AND PROFILE
- 25 NEW ROOF ACCESS HATCH & LADDER SEE SHEET A2.05 FOR DETAILS
- 26 EXISTING INTERIOR STOREFRONT TO REAMIN 27 EXISTING HISTORIC TELLER PARTITIONS AND STOREFRONT TO REMAIN
- 28 CLEAN AND POLISH EXISTING HISTORIC TILE FLOORS.
- 29 EXISTING DOOR TO REMAIN AND FIXED IN PLACE SO THAT THEY ARE NOT OPERABLE
- 30 EXISTING WOOD DOORS TO BE REPAIRED, RECEIVE NEW HARDWARE, PAINTED, AND RESTORED TO WORKING ORDER - SEE DOOR SCHEDULE FOR MORE INFORMATION
- 31 INSPECT EXISTING FLUE SHAFTS AND REPAIR BRICK AS NECESSARRY TO MAINTAIN A WATER TIGHT ASSEMBLY
- 32 INSTALL NEW FLUE CAP
- 33 NEW DRYER VENT EXHAUST OPENING
- 34 REPAIR AND RESTORE EXISTING HARDWOOD FLOOR AS NECESSARY AND CREATE ONE HOUR FLOOR/CEILING ASSEMBLY - SEE SPECIFICATIONS AND SHEET A0.01 FOR MORE INFORMATION

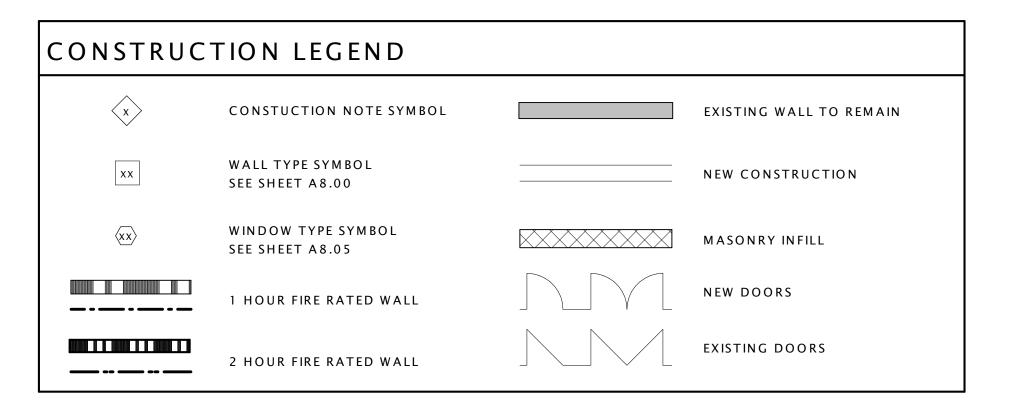

1 ENLARGED 3RD FLOOR

A5.03 SCALE: 1/4" = 1'-0"

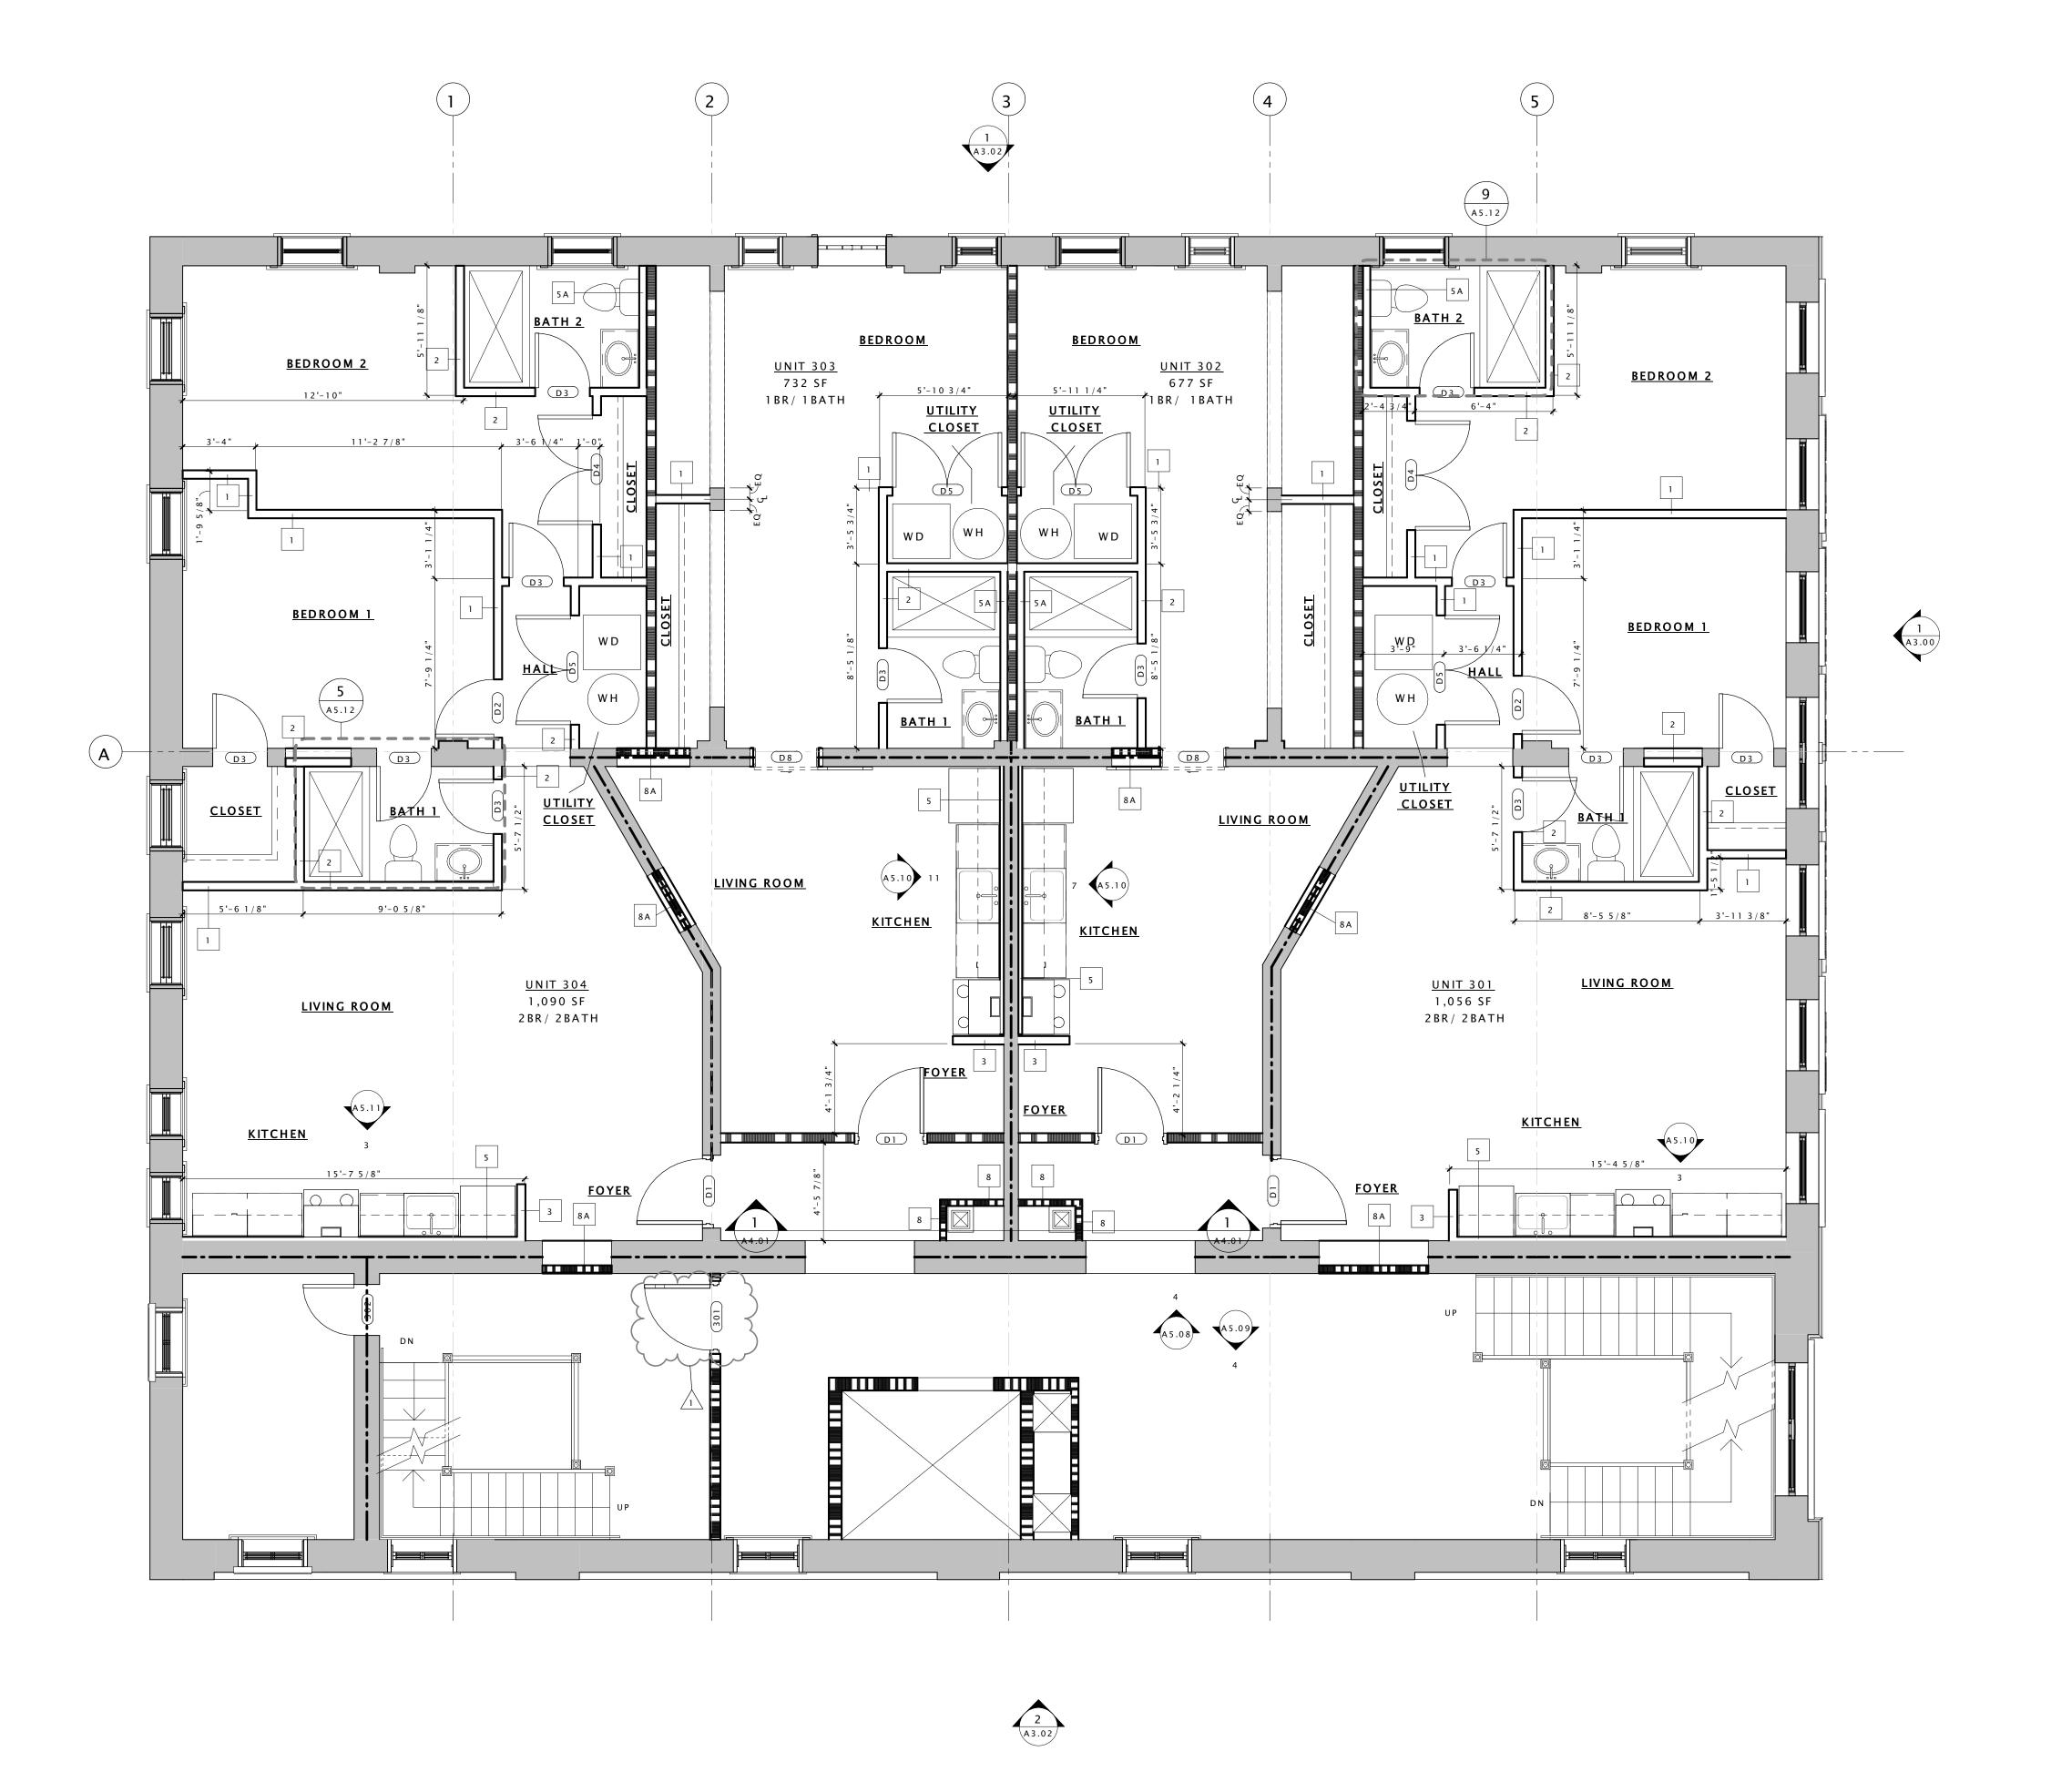



0

DHR PART II SUBMISSION 10.26.16 PERMIT SET DHR PART II AMENDMENT I APERMIT SET RESPONSE 09.08.17 PERMIT SET RESPONSE 2 09.29.17

S



Drawing Title

ENLARGED 3RD FLOOR PLAN




- 1. THIS IS A HISTORIC REHABILITATION TAX CREDIT PROJECT. ALL WORK MUST BE ACCORDANCE WITH THE SECRETARY OF THE INTERIOR'S STANDARDS FOR HISTORIC REHABILITATION.
- 2. DIMENSIONS NOTED AS 'ALIGN', 'HOLD', 'CLEAR', ARE TO TAKE PRECEDENCE OVER OTHER DIMENSIONS IN CASE OF DISCREPANCIES BETWEEN DRAWINGS AND ARE ALWAYS TO FINISH FACE. ALL OTHER DIMENSIONS ARE TO FACE OF STUD UNLESS NOTED OTHERWISE. CONTACT ARCHITECT FOR CLARIFICATION
- 3. DOORS SHALL BE LOCATED 4" FROM ADJACENT PARTITIONS (HINGE SIDE) UNLESS NOTED OTHERWISE.
- 4. ALL PARTITIONS ARE TO BE PARTITION TYPE 1 UNLESS NOTED OTHERWISE. REFER TO SHEET A0.01 FOR WALL TYPES.
- 5. ALL TRANSITIONS OF FLOORING SHALL OCCUR @ CENTER LINE OF DOOR OPENINGS UNLESS NOTED OTHERWISE.
- 6. USE 1/2" WATER RESISTANT GWB IN ALL BATHROOMS UNLESS NOTE OTHERWISE. USE CEMENT BACKER BOARD @ ALL TILE LOCATIONS
- 7. ALL AREAS THAT INDICATE NEW INSULATION MUST MEET CURRENT IECC STANDARDS.
- 8. REFER TO ELEVATIONS FOR EXISTING AND NEW WINDOW INFORMATION
- 9. PATCH AND REPAIR EXISTING HISTORIC PLASTER WHERE IT HAS BEEN PREVIOUSLY
- 10. INTERIOR DEPTH DIMENSION OF CLOSETS TO BE 2'- 0" MINIMUM


REMOVED OR WHERE DAMAGED. SEE NPS BRIEF FOR METHODOLOGY

- 11. REPAIR AND RESTORE PLASTER AT ALL EXTERIOR WALLS, HISTORIC INTERIOR WALLS, AND AT THE FIRST AND THIRD FLOOR CEILING.
- 12. AVOID REFINISHING FLOORS IN HISTORIC AREAS, CLEAN LIGHTLY. SAND ONLY AS NECESSARY AND OIL FLOOR BOARDS INSTEAD

# CONSTRUCTION KEY NOTES - 💉

- 1 EXISTING VAULT TO REMAIN
- 2 REPAIR AND PAINT EXISTING WAINSCOTING AT EXTERIOR WALLS AND HISTORIC PLASTER INTERIOR WALLS TYP. THROUGHOUT
- 3 REPAIR EXISTING WOOD JOISTS TO MAKE FLOOR STRUCTUALLY SOUND SEE
- 4 NEW CONCRETE STAIR AND LANDING AT EXISTING ENTRY SEE STRUCTURAL FOR
- 5 REPAIR EXISTING CANOPY
- 6 NEW METAL GUARD RAIL AND HANDRAIL AT ENTRY
- 7 RAISE EXISTING HISTORIC HANDRAIL TO CODE COMPLIANT HEIGHT
- 8 REPAIR AND PAINT EXISTING HISTORIC RAIL/GUARDRAIL
- 9 NEW LOFT FLOOR AT CONSTRUCTED OUT OF LIGHT GAGE FRAMING SEE STRUCTURAL FOR DETAILS
- 10 NEW STAIR IN THIS LOCATION.
- 11 NEW INTERIOR WOOD WINDOW AT BEDROOM WALL
- 12 EXISTING HISTORIC WALL AND TRANSOM WINDOWS TO BE RESTORED AND PAINTED
- 13 EXISTING HISTORIC EXTERIOR STOREFRONT TO BE RESTORED SEE SPECIFICATIONS FOR ALLOWABLE RESTORATION METHODS
- 14 RESTORE AND REPAIR EXISTING DECORATIVE CORNICE
- 15 RESTORE EXISTING BUILT-IN GUTTER
- 16 INSTALL NEW ALUMINUM 4" DOWNSPUT
- 17 NEW MEMBRANE ROOF ON 1/2" COVER BOARD AND (2) LAYERS OF 2" POLYISO INSULATION
- 18 REPAIR AND PAINT EXISTING WOOD DENTAL MOLDING
- 19 EXISTING FIRE ESCAPE DOORS TO REMAIN AND BE FIXED IN PLACE SO THAT THEY ARE NOT OPERABLE. DOORS TO BE REPAIRED AND REPAINTED. EXISTING WIRE GLASS TO BE REPAIRED AS NECESSARY.
- 20 INSTALL NEW WOOD WINDOW IN EXISTING LOCATION
- 21 INSPECT EXISTING MASONRY AFTER REMOVAL OF INVASIVE VEGETATION. REPAINT AND REPAIR BRICK AND MORTAR. MATCH SURROUNDING MORTAR IN MATERIAL, COMPOSITION, COLOR, AGGREGATE, & HARDNESS.
- 22 INSTALL SALVAGED TIN CEILING. SEE REFLECTED CEILING PLANS FOR MORE DETAILS.
- 23 EXISTING VAULT DOOR TO BE OPENED AND FIXED IN PLACE
- 24 NEW WOOD WINDOW IN INDICATED LOCATION. WINDOW TO MATCH EXISTING ADJACENT WINDOWS IN TYPE AND PROFILE
- 25 NEW ROOF ACCESS HATCH & LADDER SEE SHEET A2.05 FOR DETAILS 26 EXISTING INTERIOR STOREFRONT TO REAMIN
- 27 EXISTING HISTORIC TELLER PARTITIONS AND STOREFRONT TO REMAIN 28 CLEAN AND POLISH EXISTING HISTORIC TILE FLOORS.
- 29 EXISTING DOOR TO REMAIN AND FIXED IN PLACE SO THAT THEY ARE NOT OPERABLE
- 30 EXISTING WOOD DOORS TO BE REPAIRED, RECEIVE NEW HARDWARE, PAINTED, AND RESTORED TO WORKING ORDER - SEE DOOR SCHEDULE FOR MORE INFORMATION
- 31 INSPECT EXISTING FLUE SHAFTS AND REPAIR BRICK AS NECESSARRY TO MAINTAIN A WATER TIGHT ASSEMBLY
- 32 INSTALL NEW FLUE CAP
- 33 NEW DRYER VENT EXHAUST OPENING
- 34 REPAIR AND RESTORE EXISTING HARDWOOD FLOOR AS NECESSARY AND CREATE ONE HOUR FLOOR/CEILING ASSEMBLY - SEE SPECIFICATIONS AND SHEET A0.01 FOR MORE INFORMATION

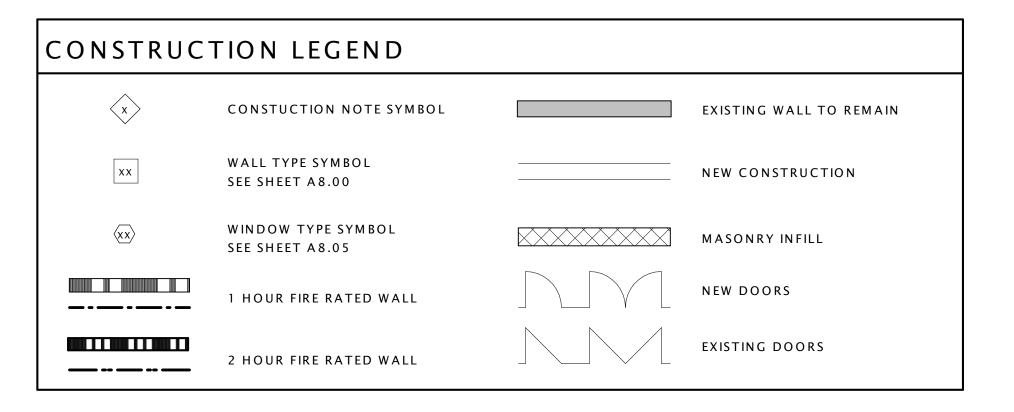

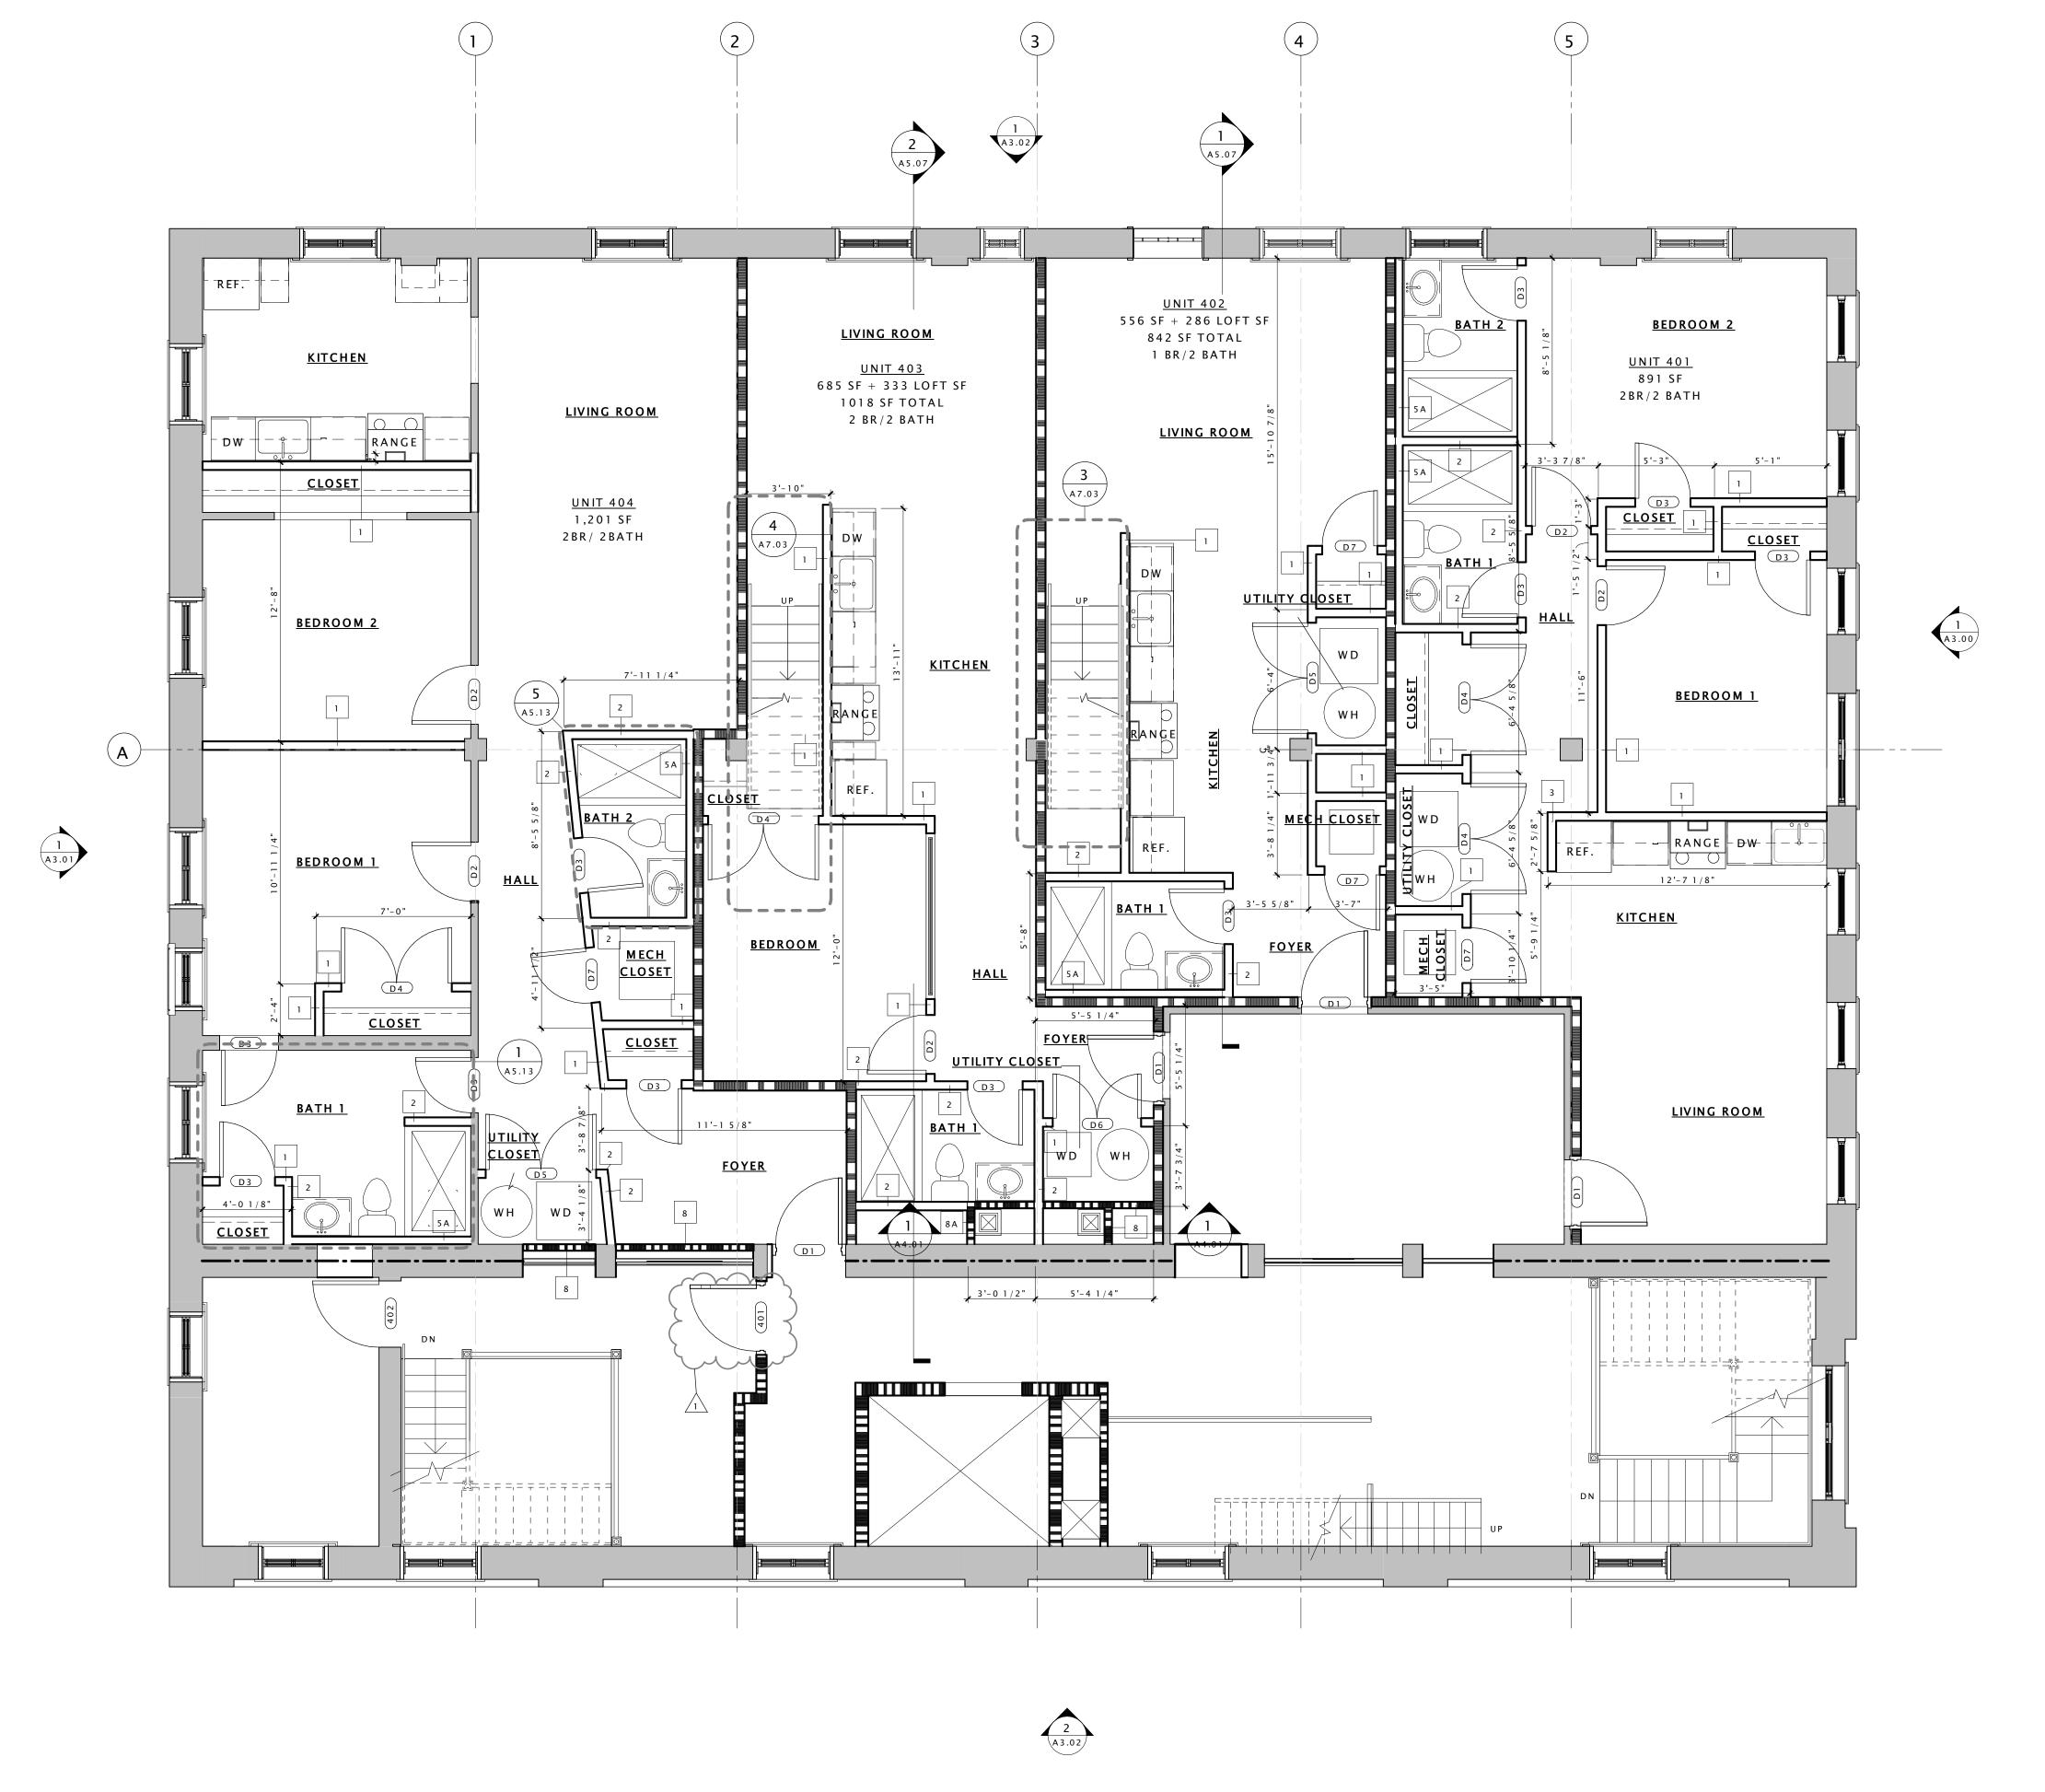



S

0

DHR PART II SUBMISSION 10.26.16 PERMIT SET DHR PART II AMENDMENT I PERMIT SET RESPONSE 09.08.17 PERMIT SET RESPONSE 2 09.29.17



Drawing Title

ENLARGED 4TH FLOOR PLAN

TRUE NORTH


ENLARGED 4TH FLOOR


A5.04 SCALE: 1/4" = 1'-0"

- 1. THIS IS A HISTORIC REHABILITATION TAX CREDIT PROJECT. ALL WORK MUST BE ACCORDANCE WITH THE SECRETARY OF THE INTERIOR'S STANDARDS FOR HISTORIC REHABILITATION.
- 2. DIMENSIONS NOTED AS 'ALIGN', 'HOLD', 'CLEAR', ARE TO TAKE PRECEDENCE OVER OTHER DIMENSIONS IN CASE OF DISCREPANCIES BETWEEN DRAWINGS AND ARE ALWAYS TO FINISH FACE. ALL OTHER DIMENSIONS ARE TO FACE OF STUD UNLESS NOTED OTHERWISE. CONTACT ARCHITECT FOR CLARIFICATION
- 3. DOORS SHALL BE LOCATED 4" FROM ADJACENT PARTITIONS (HINGE SIDE) UNLESS NOTED
- 4. ALL PARTITIONS ARE TO BE PARTITION TYPE 1 UNLESS NOTED OTHERWISE. REFER TO SHEET A0.01 FOR WALL TYPES.
- 5. ALL TRANSITIONS OF FLOORING SHALL OCCUR @ CENTER LINE OF DOOR OPENINGS UNLESS NOTED OTHERWISE.
- 6. USE 1/2" WATER RESISTANT GWB IN ALL BATHROOMS UNLESS NOTE OTHERWISE. USE CEMENT BACKER BOARD @ ALL TILE LOCATIONS
- 7. ALL AREAS THAT INDICATE NEW INSULATION MUST MEET CURRENT IECC STANDARDS.
- 8. REFER TO ELEVATIONS FOR EXISTING AND NEW WINDOW INFORMATION
- 9. PATCH AND REPAIR EXISTING HISTORIC PLASTER WHERE IT HAS BEEN PREVIOUSLY REMOVED OR WHERE DAMAGED. SEE NPS BRIEF FOR METHODOLOGY
- 10. INTERIOR DEPTH DIMENSION OF CLOSETS TO BE 2'- 0" MINIMUM
- 11. REPAIR AND RESTORE PLASTER AT ALL EXTERIOR WALLS, HISTORIC INTERIOR WALLS, AND AT THE FIRST AND THIRD FLOOR CEILING.
- 12. AVOID REFINISHING FLOORS IN HISTORIC AREAS, CLEAN LIGHTLY. SAND ONLY AS NECESSARY AND OIL FLOOR BOARDS INSTEAD

# CONSTRUCTION KEY NOTES

- 1 EXISTING VAULT TO REMAIN
- 2 REPAIR AND PAINT EXISTING WAINSCOTING AT EXTERIOR WALLS AND HISTORIC PLASTER INTERIOR WALLS TYP. THROUGHOUT
- 3 REPAIR EXISTING WOOD JOISTS TO MAKE FLOOR STRUCTUALLY SOUND SEE STRUCTURAL
- 4 NEW CONCRETE STAIR AND LANDING AT EXISTING ENTRY SEE STRUCTURAL FOR
- 5 REPAIR EXISTING CANOPY
- 6 NEW METAL GUARD RAIL AND HANDRAIL AT ENTRY
- 7 RAISE EXISTING HISTORIC HANDRAIL TO CODE COMPLIANT HEIGHT
- 8 REPAIR AND PAINT EXISTING HISTORIC RAIL/GUARDRAIL
- 9 NEW LOFT FLOOR AT CONSTRUCTED OUT OF LIGHT GAGE FRAMING SEE STRUCTURAL FOR DETAILS
- 10 NEW STAIR IN THIS LOCATION.
- 11 NEW INTERIOR WOOD WINDOW AT BEDROOM WALL
- 12 EXISTING HISTORIC WALL AND TRANSOM WINDOWS TO BE RESTORED AND PAINTED
- 13 EXISTING HISTORIC EXTERIOR STOREFRONT TO BE RESTORED SEE SPECIFICATIONS FOR ALLOWABLE RESTORATION METHODS
- 14 RESTORE AND REPAIR EXISTING DECORATIVE CORNICE
- 15 RESTORE EXISTING BUILT-IN GUTTER
- 16 INSTALL NEW ALUMINUM 4" DOWNSPUT
- 17 NEW MEMBRANE ROOF ON 1/2" COVER BOARD AND (2) LAYERS OF 2" POLYISO INSULATION
- 18 REPAIR AND PAINT EXISTING WOOD DENTAL MOLDING
- 19 EXISTING FIRE ESCAPE DOORS TO REMAIN AND BE FIXED IN PLACE SO THAT THEY ARE NOT OPERABLE. DOORS TO BE REPAIRED AND REPAINTED. EXISTING WIRE GLASS TO BE REPAIRED AS NECESSARY.
- 20 INSTALL NEW WOOD WINDOW IN EXISTING LOCATION
- 21 INSPECT EXISTING MASONRY AFTER REMOVAL OF INVASIVE VEGETATION. REPAINT AND REPAIR BRICK AND MORTAR. MATCH SURROUNDING MORTAR IN MATERIAL, COMPOSITION, COLOR, AGGREGATE, & HARDNESS.
- 22 INSTALL SALVAGED TIN CEILING. SEE REFLECTED CEILING PLANS FOR MORE DETAILS. 23 EXISTING VAULT DOOR TO BE OPENED AND FIXED IN PLACE
- 24 NEW WOOD WINDOW IN INDICATED LOCATION. WINDOW TO MATCH EXISTING
- ADJACENT WINDOWS IN TYPE AND PROFILE 25 NEW ROOF ACCESS HATCH & LADDER - SEE SHEET A2.05 FOR DETAILS
- 26 EXISTING INTERIOR STOREFRONT TO REAMIN
- 27 EXISTING HISTORIC TELLER PARTITIONS AND STOREFRONT TO REMAIN
- 28 CLEAN AND POLISH EXISTING HISTORIC TILE FLOORS.
- 29 EXISTING DOOR TO REMAIN AND FIXED IN PLACE SO THAT THEY ARE NOT OPERABLE
- 30 EXISTING WOOD DOORS TO BE REPAIRED, RECEIVE NEW HARDWARE, PAINTED, AND RESTORED TO WORKING ORDER - SEE DOOR SCHEDULE FOR MORE INFORMATION
- 31 INSPECT EXISTING FLUE SHAFTS AND REPAIR BRICK AS NECESSARRY TO MAINTAIN A WATER TIGHT ASSEMBLY
- 32 INSTALL NEW FLUE CAP 33 NEW DRYER VENT EXHAUST OPENING
- 34 REPAIR AND RESTORE EXISTING HARDWOOD FLOOR AS NECESSARY AND CREATE ONE HOUR FLOOR/CEILING ASSEMBLY - SEE SPECIFICATIONS AND SHEET A0.01 FOR MORE INFORMATION

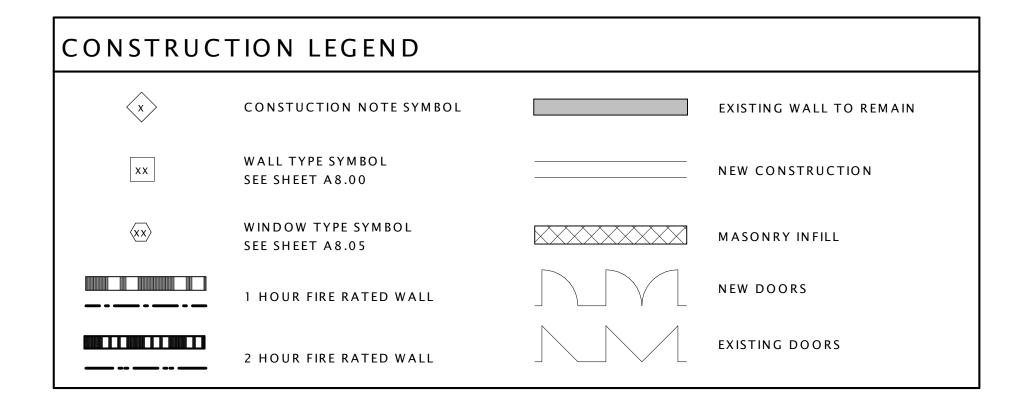


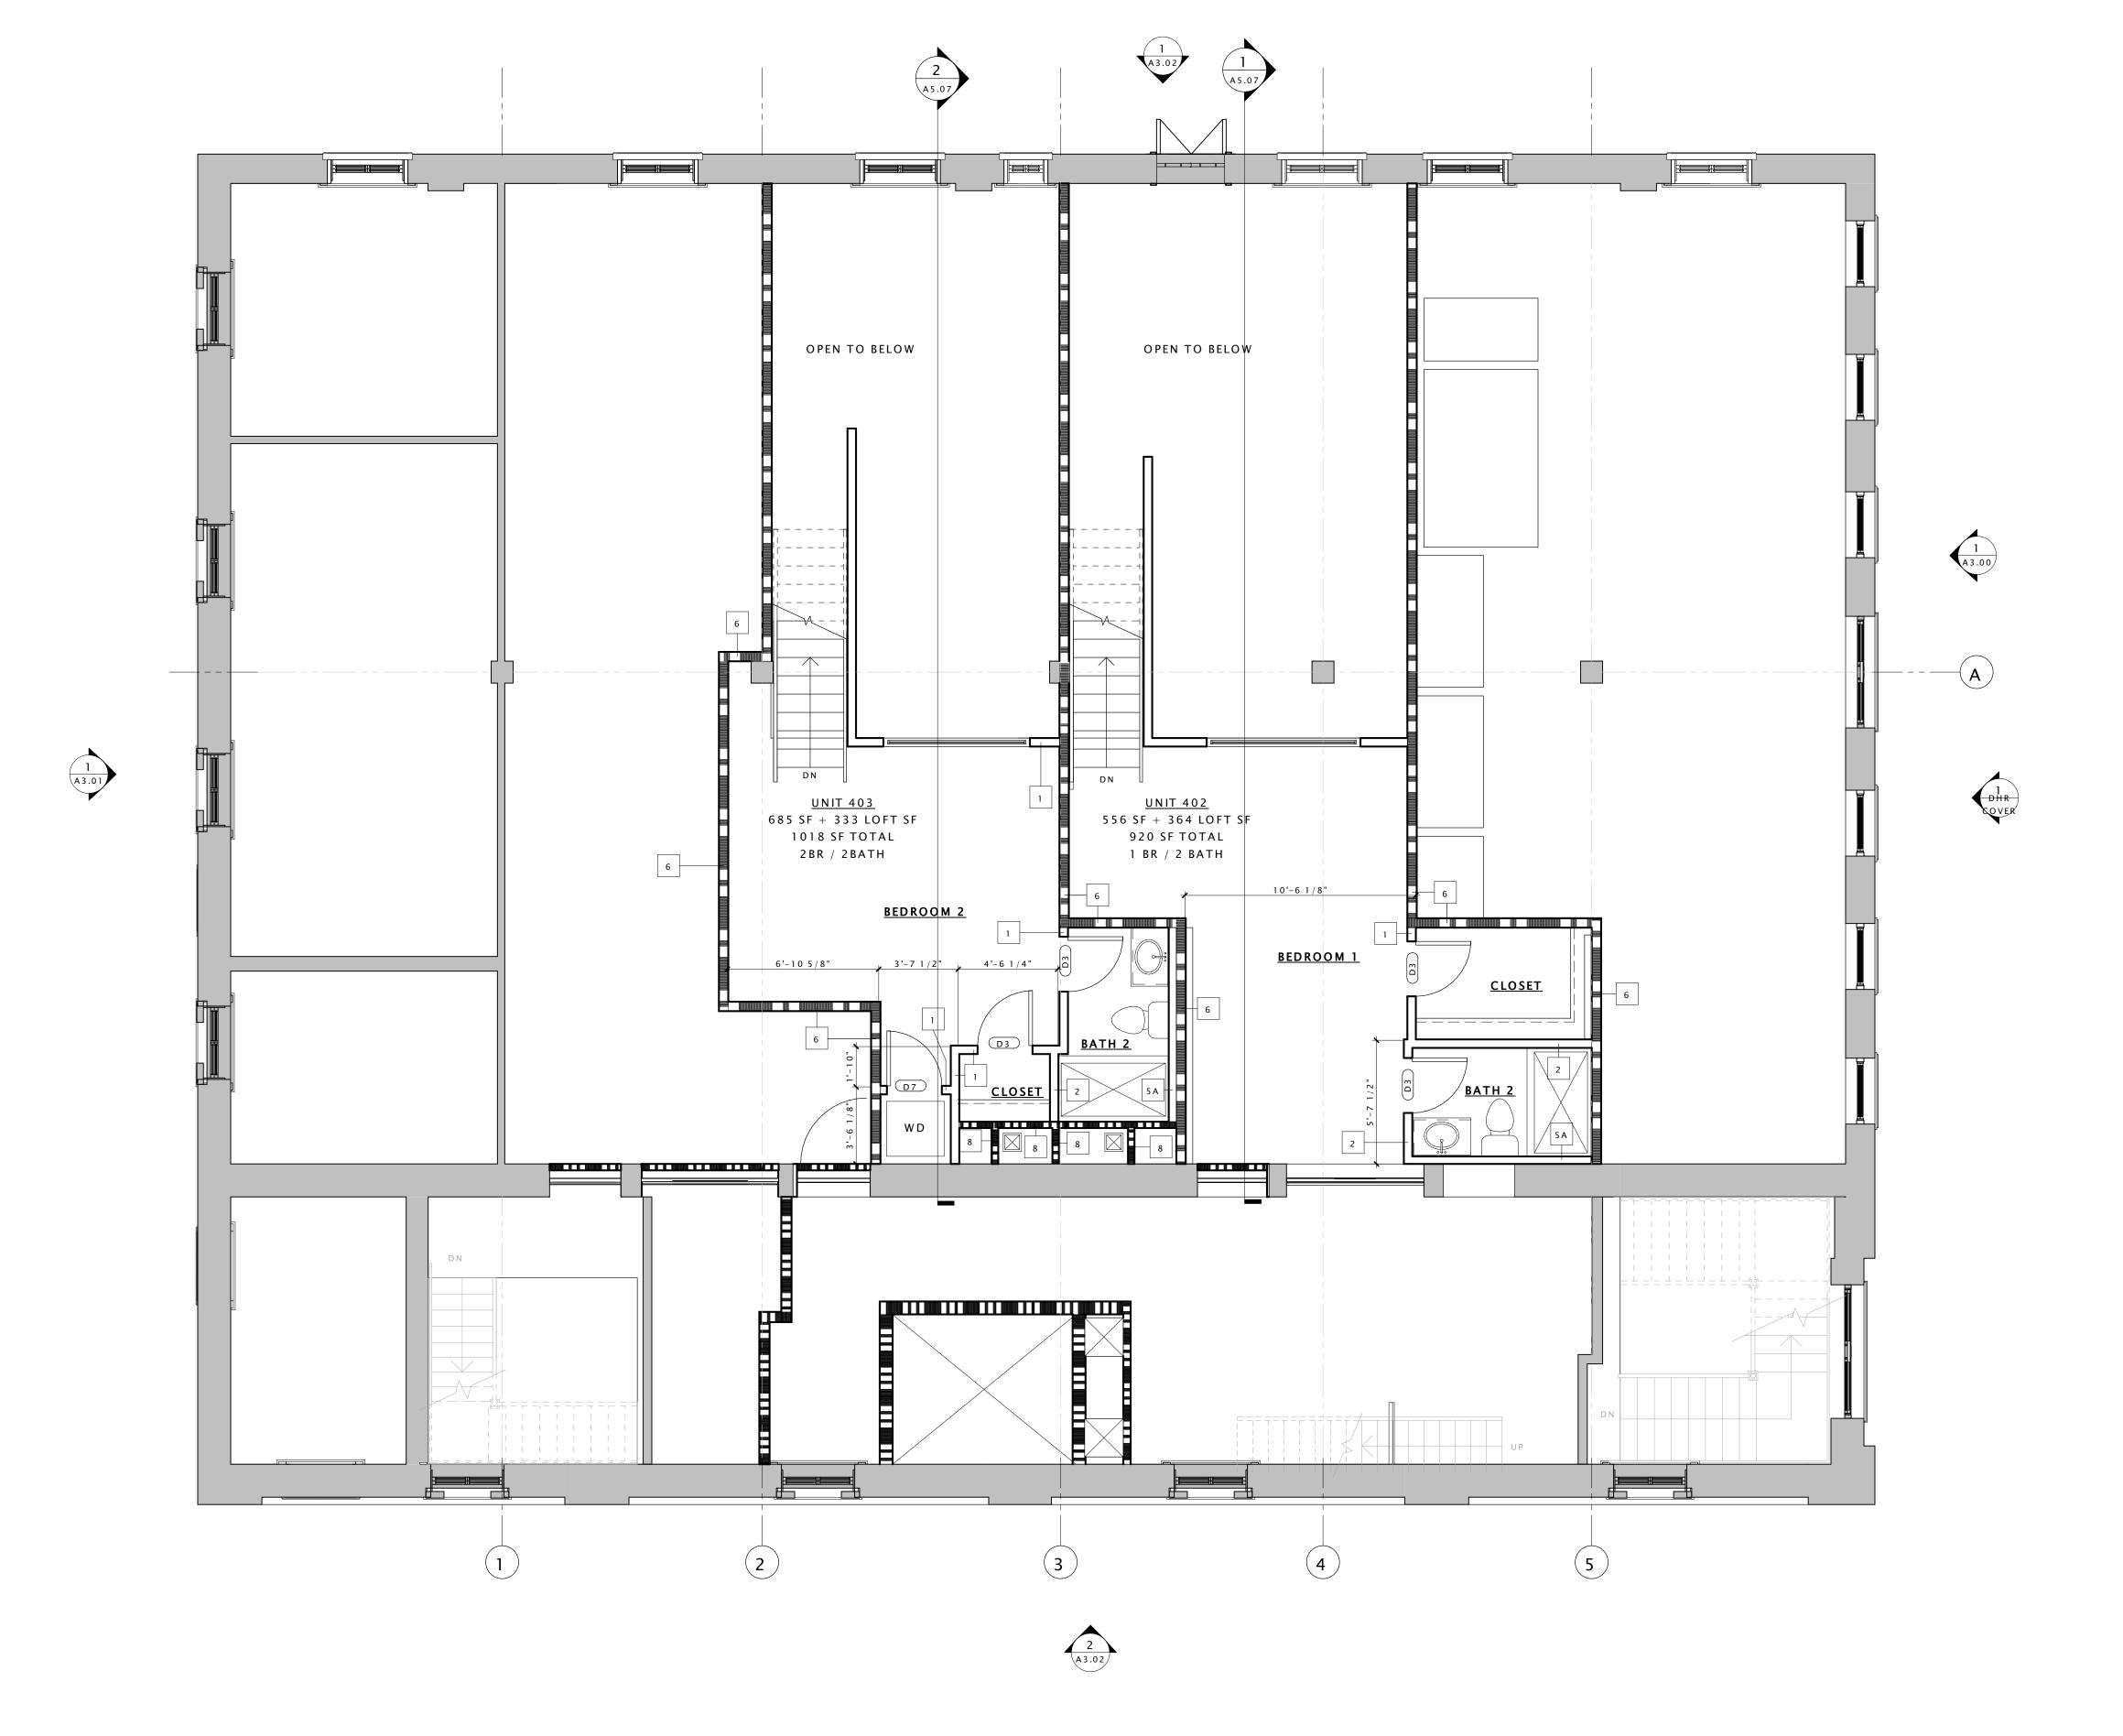



S

0

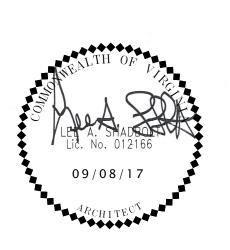

Drawing Title

ENLARGED 4TH FLOOR LOFT PLAN