

# COMMISSION OF ARCHITECTURAL REVIEW APPLICATION / CERTIFICATE OF APPROPRIATENESS

VA	23223	
	Rehabilitation	Demolition
	New Construction (Concer	otual Review required)
	Conceptual Review	Final Review
	<b>APPLICANT</b> (if	other than owner)
	Name	
	Company	
	Company Mailing Address	
	Mailing Address	
	Mailing Address	
		<ul> <li>New Construction (Conception)</li> <li>Conceptual Review</li> <li>APPLICANT (if</li> </ul>

#### ACKNOWLEDGEMENT OF RESPONSIBILITY

**Requirements:** A complete application includes all applicable information requested on checklists to provide a complete and accurate description of existing and proposed conditions. Preliminary review meeting or site visit with staff may be necessary to process the application. Owner contact information and signature is required. Late or incomplete applications will not be considered.

**Zoning Requirements:** Prior to CAR review, it is the responsibility of the applicant to determine if zoning approval is required and application materials should be prepared in compliance with zoning.

**Compliance:** If granted, you agree to comply with all conditions of the COA. Revisions to approved work require staff review and may require a new application and CAR approval. Failure to comply with the COA may result in project delays or legal action. The COA is valid for one (1) year and may be extended for an additional year, upon written request.

	ECE VED				
(Space below for staff use only)	0.0017				
Application received:	MAR 0 2 2017				
Date/Time		Complete	🗌 Yes	🗆 No	
Ву					
					Created 7/2016



# **CERTIFICATE OF APPROPRIATENESS**

## NEW CONSTRUCTION CHECKLIST

## <u>Well in advance</u> of the COA application deadline contact staff to discuss your project, and if necessary, to make an appointment to meet with staff for a project consultation in the office or on site.

Complete all applicable sections and submit with the COA application form. Staff can assist you in determining what items are required for your scope of work. An incomplete application may cause delays in processing or may be deferred to the next agenda. Application materials <u>must</u> clearly represent current and proposed conditions. Refer to Standards for New Construction outlined in Section 30.930.7(c) of the City Code, as well as, the *Richmond Old and Historic Districts Handbook and Design Review Guidelines*.

# PROPERTY ADDRESS: 2900 E. Leigh Street

#### NEW BUILDING TYPE DRAWINGS (refer to required drawing guidelines) □ single-family residence floor plans □ multi-family residence elevations (all sides) □ commercial building roof plan □ mixed use building □ list of windows and doors, including size, material, design □ institutional building context drawing showing adjacent buildings □ garage perspective □ accessory structure site plan □ other legal plat of survey

#### WRITTEN DESCRIPTION

describe new structure including levels, foundation, siding, windows, doors, roof and details

state how the *Richmond Old and Historic Districts Handbook and Design Review Guidelines* informed the proposed work, site specific pages and sections of the *Guidelines* that apply

material description; attach specification sheets if necessary

PHOTOGRAPHS place on 8 1/2 x 11 page, label photos with description and location (refer to photograph guidelines)

site as seen from street, from front and corners, include neighboring properties

#### DETAILED DESCRIPTION OF PROPOSED WORK

The proposed single family detached home shall be located on the vacant lots of 2900-2902 East Leigh Street in Richmond's historic Church Hill North Neighborhood. As stated in the handbook, the goal of this design is that it shall be compatible with surroundings structures, while still representing the modern time in which it will be constructed. Given that it is a corner lot, we, the homeowners and architects, shall consider not only the neighbors on North 29th Street and East Leigh Street, but also the buildings at the other three corners. These three corners were studied and have greatly influenced the design of the proposed home. It is our goal to construct a new home on the vacant lot that references materials, features, proportions and massing of the surrounding historic homes.

#### SITING

According to page 44 of the Old & Historic Districts of Richmond, Virginia: Handbook and Design Review Guidelines, "New residential infill construction should respect the prevailing front and side yard setback patterns of the surrounding block." The home is planned to align with the front yard setbacks of the other homes on East Leigh Street. The Handbook also suggests that, "New buildings should face the most prominent street bordering the site." The proposed home will face East Leigh Street.

#### FORM

The Handbook states that, "New construction should use a building form compatible with that found elsewhere in the historic district." The massing, size, symmetry, proportions, projections and roof shapes follow that of other homes in the historic neighborhood. The windows, the front door and the porch on the prominent street follow the same size and proportions of the neighbors on East Leigh Street. The proposed gabled roof design is compatible with the neighbors on North 29th Street and East Leigh Street.

#### HEIGHT, WIDTH, PROPORTION + MASSING

According to page 45 of the Handbook, "New residential construction should respect the typical height of surrounding residential buildings." The height of the proposed building does not exceed that of surrounding homes and commercial buildings. The front facade shall respect the neighbors on East Leigh Street with the cornice height closely aligning to the existing structures.

#### MATERIALS + COLORS

The Handbook states that, "Materials used in new residential construction should be visually compatible with original materials used throughout the district." The materials proposed include a metal roof as well as Hardie board siding and panels. The metal railing will read as the same size as historic railings, but the material choice will reflect the present day construction. The Handbook also suggests that, "When rooftop railings are required for seating areas or for safe access to mechanical equipment, the railings should be as unobtrusive as possible, in order to minimize their appearance and visual impact on the surrounding district." The rooftop railing is tucked in the northeast corner of the lot; therefore the appearance is minimal from East Leigh Street. The proposed color is gray, such as Roycroft Mist Gray or Classic French Gray. Many of the surrounding buildings are beige and blue.

#### CORNER PROPERTIES

The massing of the proposed residence references other corner properties in the neighborhood. The material will be the same for both the primary and secondary elevations. Where the rear massing is set back, the material and color shall vary from the main body, such as other homes in the district. Both the height of the home and the height of the foundation relate to neighboring properties. Windows on both elevations are aligned vertically. The elements of a side entrance and a side porch also contribute to the architecture of the secondary elevation.

### DOORS + WINDOWS

The Handbook states that, "The size, proportion, and spacing patterns of doors and window openings on free standing, new construction should be compatible with patterns established within the district." The windows and doors of the proposed home are compatible with those of the other homes on East Leigh Street.

### PORCHES + PORCH DETAILS

According to page 46 of the Handbook, "New porch railing designs, compatible with the overall design of the building, will also be considered," and, "Porch roofs are encouraged to utilize standingor flat-lock metal seam roofs that are hand-seamed, or closely approximate hand-seaming." The porch railing shall be constructed of either cable wiring or metal horizontal railing, thus reflecting the contemporary design in the time period it is constructed. The design is intended to be visually unobtrusive such as the metal railing of the neighboring houses.

### **RESIDENTIAL OUTBUILDINGS**

The shed shall be constructed with the same siding materials of the main residence and shall be located at the rear of the property and away from the street side of North 29th Street to emphasize its secondary nature. The roof shall be low sloping metal or shingles that slope away from the street.

#### FENCES + WALLS

The privacy fence at the rear of the house shall reflect the scale of the surrounding houses. It shall not be taller than 6' and be constructed of vertical posts with horizontal wood boards with a natural finish appropriate for the neighborhood.

neighborhood examples | street views of block | part one




view of east leigh street | proposed home next to tan home on far left



view of north 29th street | proposed home across alley next to gray home on far right

## neighborhood examples | street views of block | part two

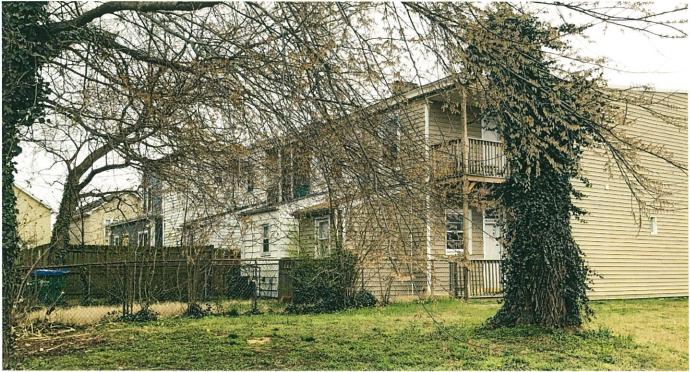

view of north 29th street | alley behind east leigh street



view of north 29th street | across the street from proposed home

neighborhood examples | study of corner residences



521 north 29th street | corner residence due south of proposed home



600 north 29th street | corner commerical space due west of proposed home

## neighborhood examples | gable roof designs | part one



522 north 29th street | corner commerical space southwest of proposed home



635 north 27th street | gable facing m street

neighborhood examples | gable roof designs | part two



2901 m street | gable facing north 29th street



617 north 29th street



510 north 29th street

617 north 26th street


## neighborhood examples



2400 east leigh street | corner mixed use space with metal railings and roof access




2600 cedar street | material study

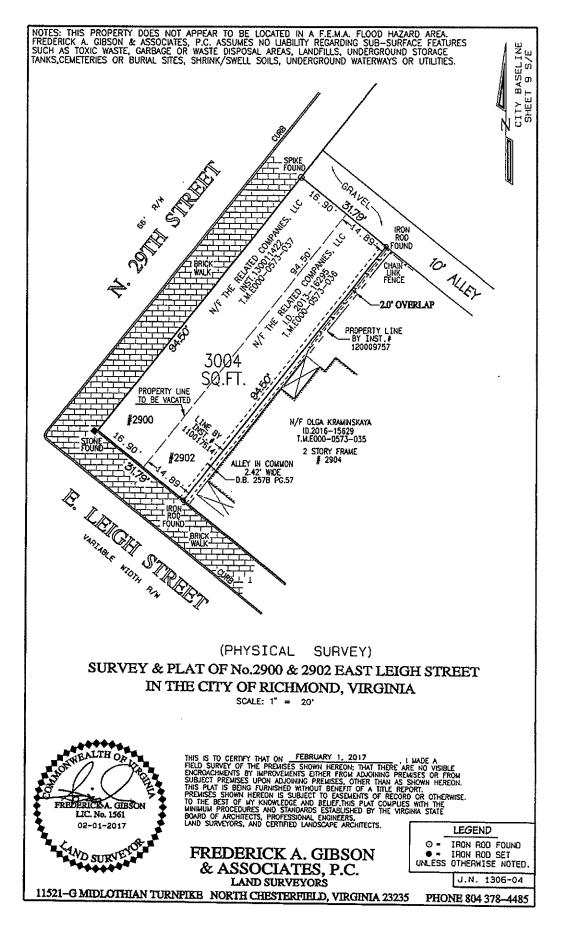





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2900 E. LEIGH STREET, RICHMOND, VA 23223



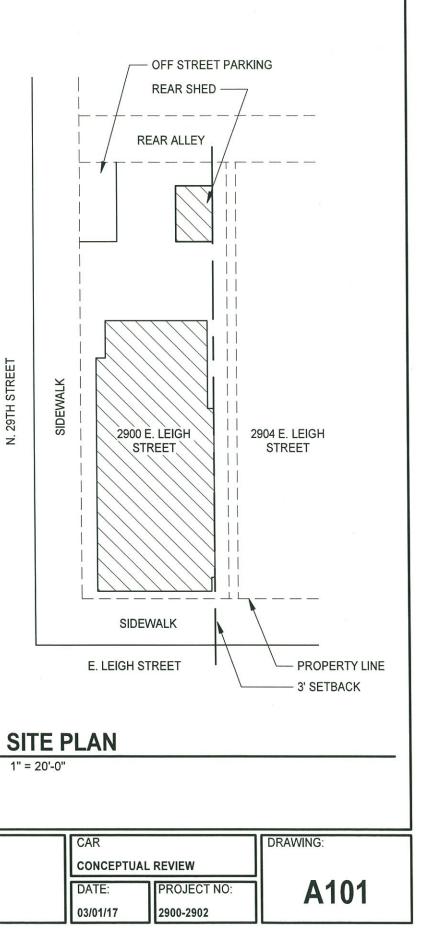

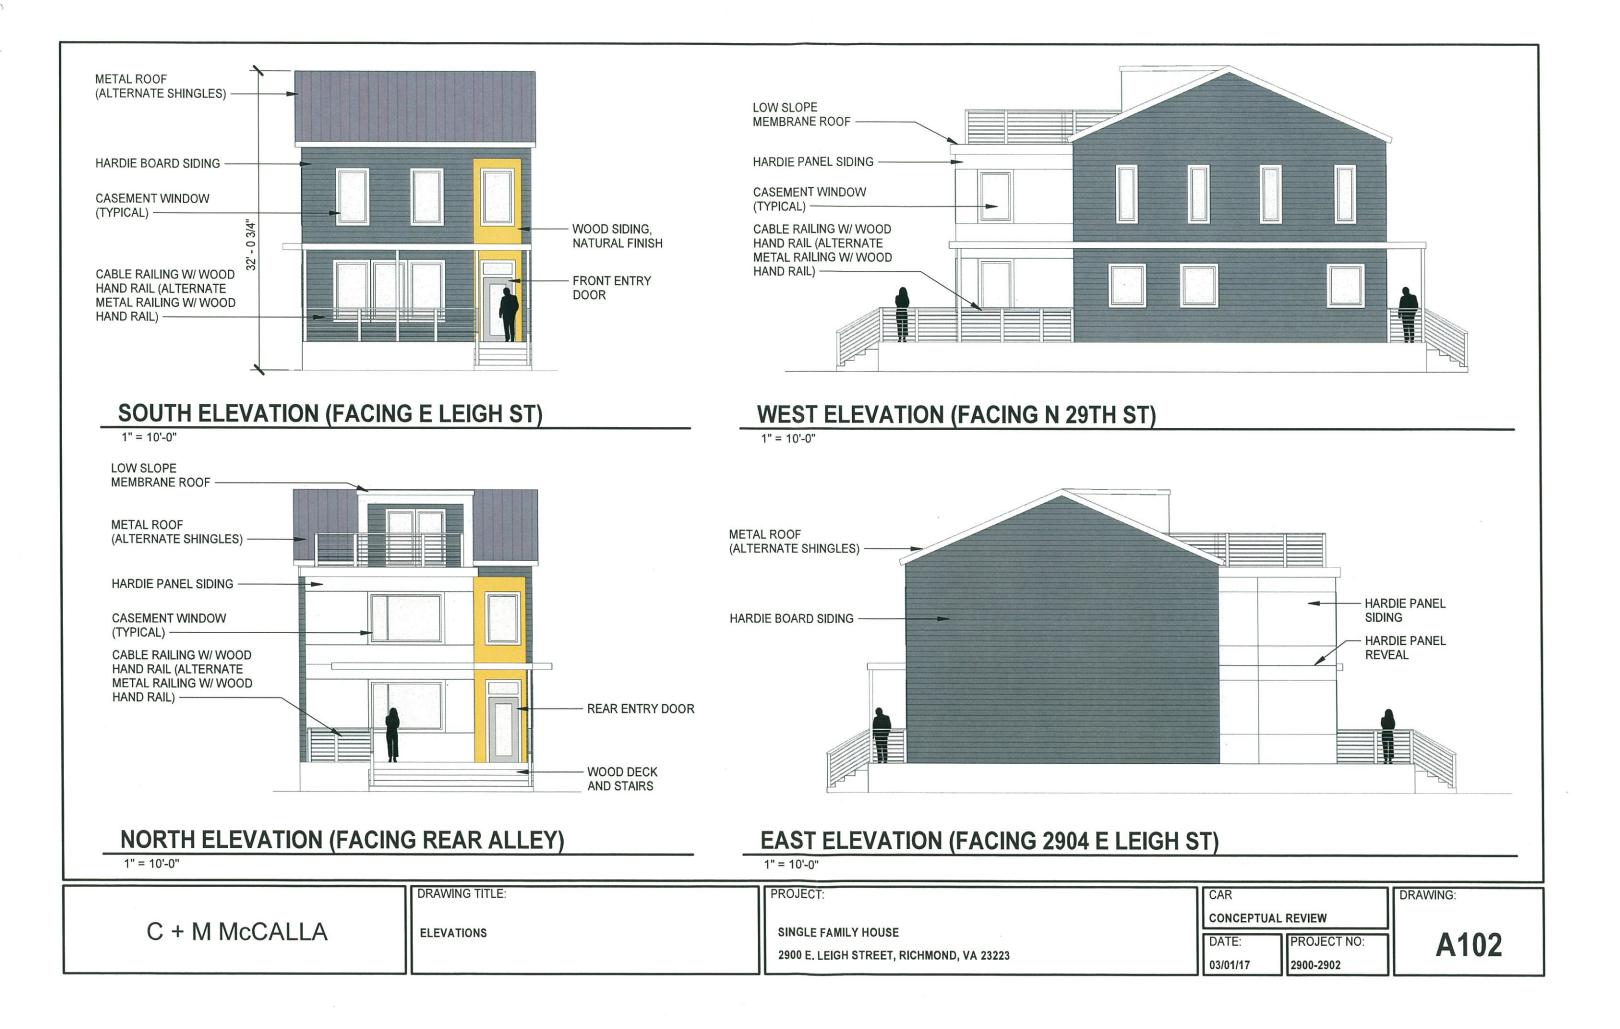
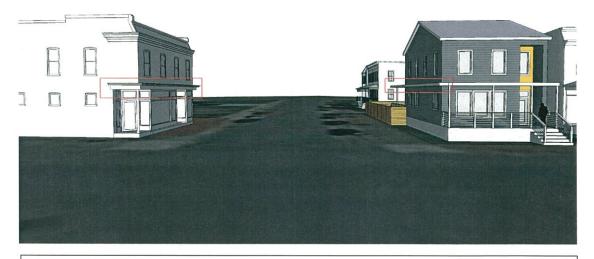
#### VIEW NORTH ON N 29TH STREET

HORIZONTAL ELEMENTS INCORPORATED ON N 29TH STREET ELEVATION INSPIRED BY COMMERCIAL BUILDING ACROSS THE STREET. VISUALLY ESTABLISHES ENTRANCE INTO N 29TH STREET BLOCK. RESPECTS THE TYPICAL HEIGHT OF SURROUNDING AND NEARBY BUILDINGS.





VIEW OF NORTHWEST CORNER ON N 29TH STREET REAR ELEMENT OF HOUSE SET BACK FROM N 29TH STREET INSPIRED BY HISTORICAL DESIGNS OF THE DISTRICT. REAR YARD INCLUDES PRIVACY FENCE WITH HORIZONTAL WOOD AND A SMALL SHED WITH A LOW SLOPE METAL ROOF.



## C + M McCALLA


DRAWING TITLE:

PERSPECTIVE IMAGES

PROJECT:


SINGLE FAMILY HOUSE

2900 E. LEIGH STREET, RICHMOND, VA 23223

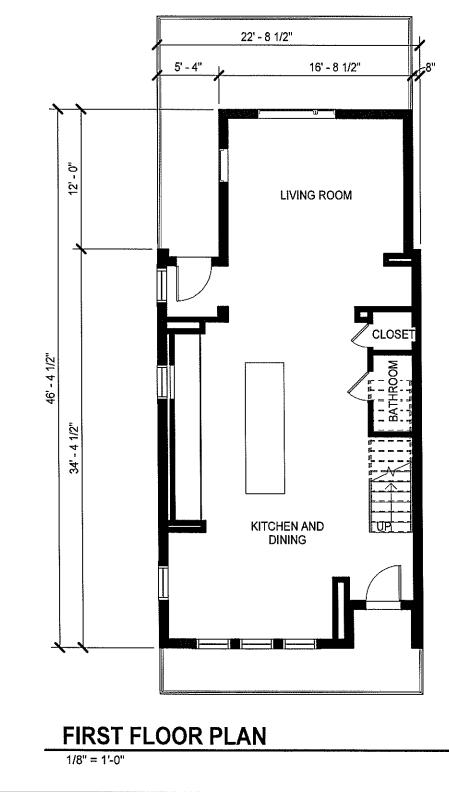

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## SECOND FLOOR PLAN 1/8" = 1'-0"

	DRAWING TITLE:	PROJECT:
C + M McCALLA	FLOOR PLANS	SINGLE FAMILY HOUSE
		2900 E. LEIGH STREET, RICHMOND, VA 23223

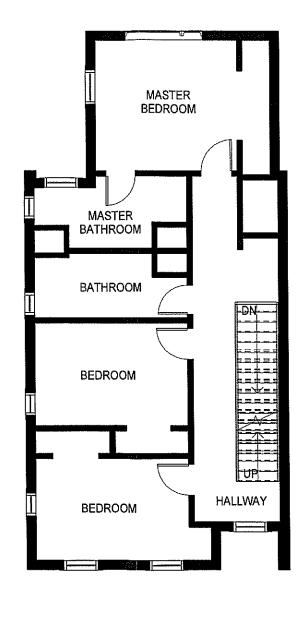