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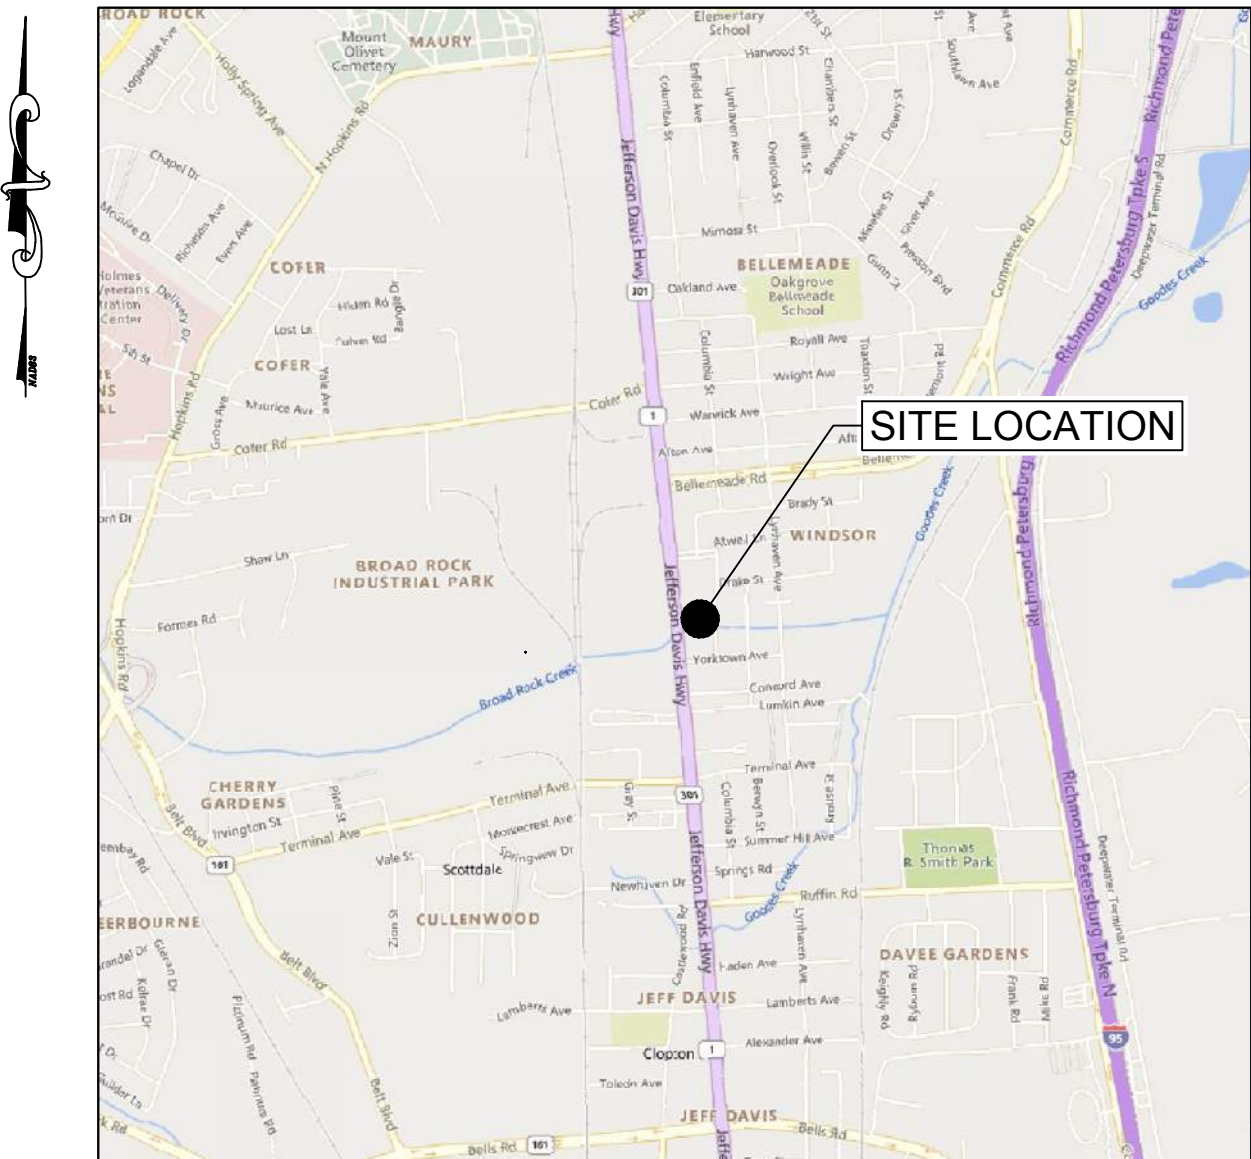
CITY OF RICHMOND FIRE STATION 21

2505 RICHMOND HIGHWAY

BROAD ROCK DISTRICT

CITY OF RICHMOND, VIRGINIA

Sheet List Table	
Sheet Number	Sheet Title
C0.00	COVER SHEET
C1.00	EXISTING CONDITIONS PLAN
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C4.00	SITE LAYOUT PLAN
C4.10	SITE NOTES & DETAILS
C7.00	UTILITY PLAN
C7.20	UTILITY NOTES & DETAILS
C7.21	UTILITY NOTES & DETAILS
L1.00	LANDSCAPE LAYOUT AND MATERIALS PLAN AND NOTES AND DETAILS
L1.01	MATERIALS NOTES AND DETAILS
L2.00	PHOTOMETRIC PLAN



VICINITY MAP

SCALE: 1" = 2,000'

PROJECT SUMMARY

ADDRESSES:	2505 RICHMOND HIGHWAY
PARCEL ID's:	S0080275005
ZONING:	B-3 - Business (General Business)
SETBACK REQUIREMENTS:	FRONT YARD - 0 FT SIDE YARD - 0 FT REAR YARD - 20 FT <sup>1</sup> BASED ON CITY OF RICHMOND ZONING ORDINANCE <i>Sec. 30-438.3</i>
DISTRICT:	BROAD ROCK
EXISTING USE:	FIRE STATION
EXISTING CONDITIONS:	CITY OF RICHMOND UTILITY MAPS; CITY OF RICHMOND GIS; ALTA/NSPS SURVEY BY TIMMONS GROUPED DATED MAY 13, 2015
DATUM:	HORIZONTAL DATUM: (NAD83) VIRGINIA STATE PLANE COORDINATE SYSTEM SOUTHZONE (1983)
PROPOSED USE:	FIRE STATION
COMBINED SITE / LOT AREA:	0.505 ACRES (21,990 SQ.FT.)
AREA TO BE DISTURBED:	0.505 ACRES
BUILDING HEIGHT   TOTAL GROSS FLOOR AREA:	3 FLOORS   TOTAL GROSS FLOOR AREA = ±17,897 SQ.FT.
USABLE OPEN SPACE:	USABLE OPEN SPACE RATIO = [USABLE OPEN SPACE] / [DWELLING USE AREA] <sup>1</sup> A USABLE OPEN SPACE RATIO OF NOT LESS THAN 0.25 SHALL BE PROVIDED USABLE OPEN SPACE RATIO = [4,437 SQ.FT.] / [10,836 SQ.FT.] = <b>0.41</b> <sup>1</sup> BASED ON CITY OF RICHMOND ZONING ORDINANCE <i>Sec. 30-438.1.1</i>

LANDSCAPE  
**TIMMONS GROUP**  
1001 Boulders Pkwy, Suite 300  
Richmond, VA 23225  
CONTACT: Scott Wiley, PLA, ASLA  
TELEPHONE: 804.200.6424  
EMAIL: scott.wiley@timmons.com

ARCHITECT  
**RRMM ARCHITECTS**  
1317 Executive Blvd, Suite 200  
Chesapeake, VA 23320  
CONTACT: Brian Wolf, LEED AP BD+C  
TELEPHONE: 757.213.6341  
EMAIL: bwolf@rrmm.com

CIVIL ENGINEER  
**TIMMONS GROUP**  
1001 Boulders Pkwy, Suite 300  
Richmond, VA 23225  
CONTACT: Amelia Wehunt, PE  
TELEPHONE: 804.200.6544  
EMAIL: amelia.wehunt@timmons.com

UDC FINAL REVIEW  
SUBMITTAL

NOT FOR CONSTRUCTION

PLAN SET DATE - 07/19/2023

THIS DRAWING PREPARED AT THE  
**CORPORATE OFFICE**  
1001 Boulders Parkway, Suite 300 | Richmond, VA 23225  
TEL 804.200.6500 FAX 804.560.1016 www.timmons.com

YOUR VISION ACHIEVED THROUGH OURS.

REVISION DESCRIPTION

DATE	
07/19/2023	

DRAWN BY  
K. UNDERBERG

DESIGNED BY  
C. NELSON

CHECKED BY  
A. WEHUNT

SCALE  
1" = 2000'

City of Richmond: New Fire Station #21

**TIMMONS GROUP**

CITY OF RICHMOND FIRE STATION 21  
BROAD ROCK DISTRICT - CITY OF RICHMOND - VIRGINIA  
COVER SHEET


JOB NO.  
60040

SHEET NO.  
C0.00

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LEGEND

- Deciduous Tree
- Drainage Grate Inlet
- Drainage Manhole
- Electric Box
- Electric Guy Wire
- Electric Light Pole
- Natural Gas Meter
- Natural Gas Valve
- Sanitary Sewer Manhole
- Sign
- Utility Pole
- Water Fire Hydrant
- Water Meter
- Water Valve
- Water Vault
- Monitoring Well
- Telephone Manhole
- Roof Drain / Downspout
- Bollard
- Telephone Pedestal
- Electric Meter
- Flag Pole
- Cleanout
- Utility Manhole

- Underground Natural Gas Line
- Underground Water Line
- Underground Communication Line
- Underground Power Line
- Underground Unknown Utility Line or Signal

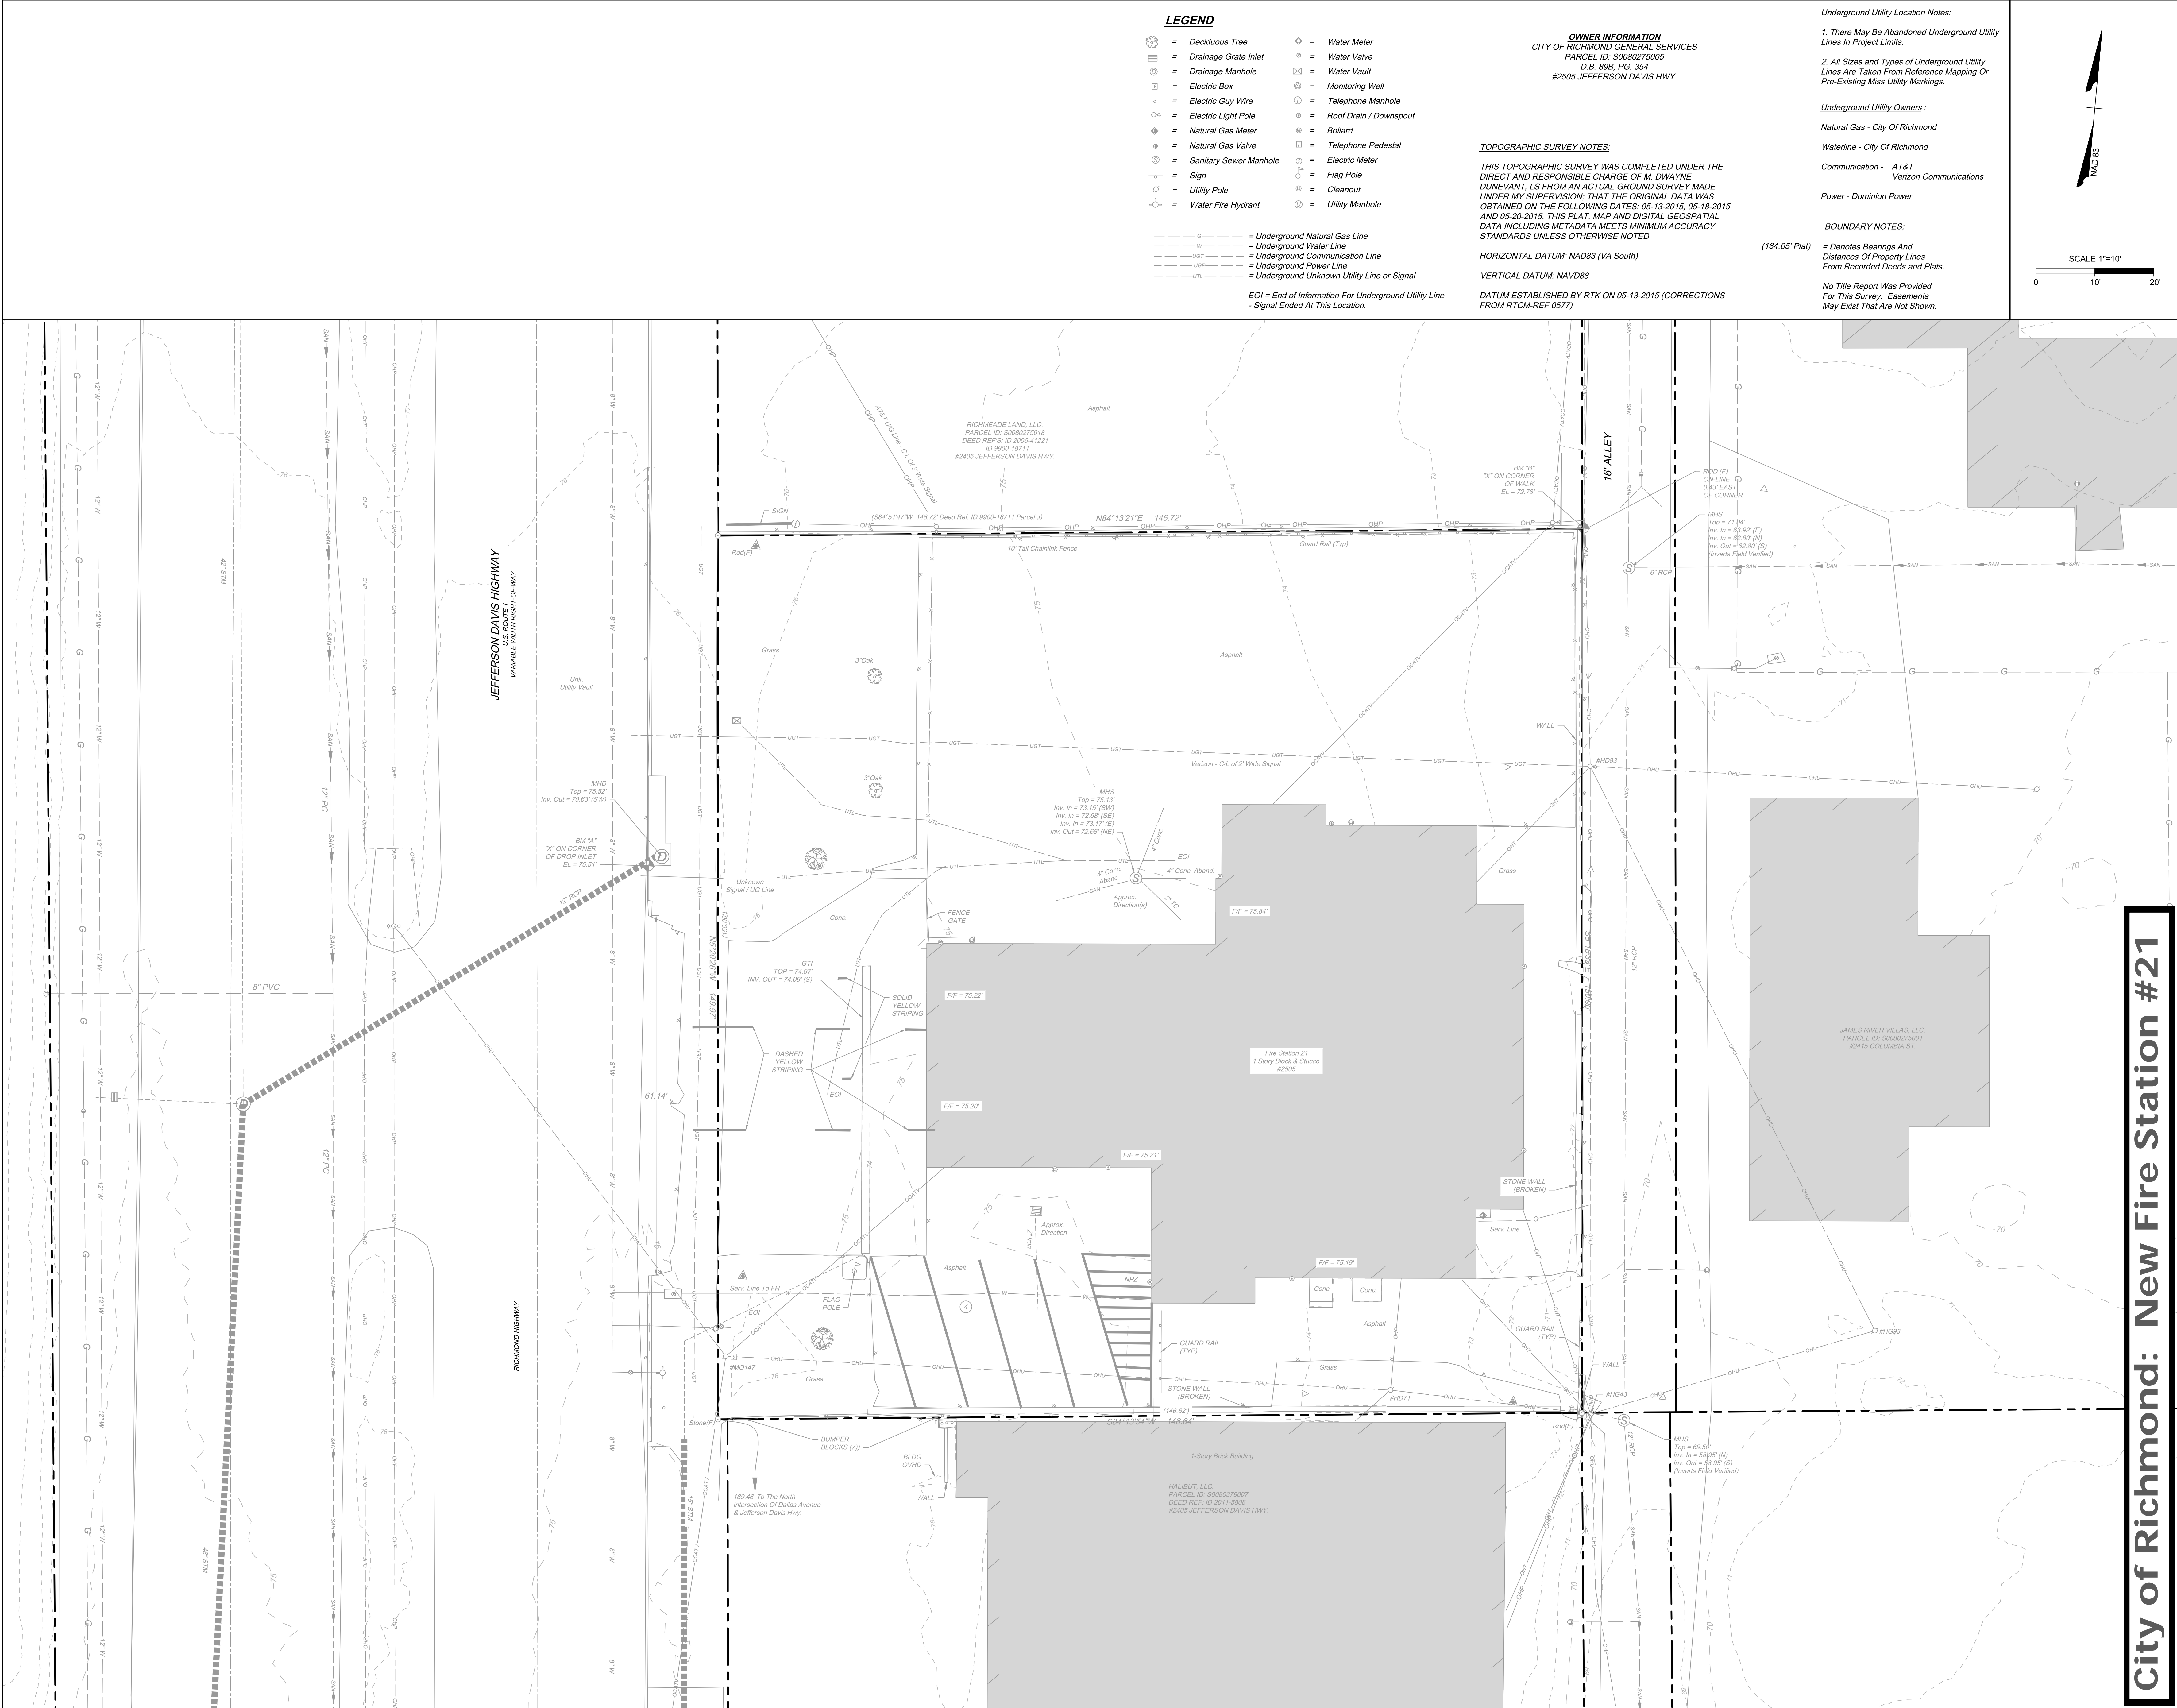EOI = End of Information For Underground Utility Line  
Signal Ended At This Location.

OWNER INFORMATION  
CITY OF RICHMOND GENERAL SERVICES  
PARCEL ID: S0080275005  
D.B. 898, PG. 354  
#2505 JEFFERSON DAVIS HWY.

TOPOGRAPHIC SURVEY NOTES:

THIS TOPOGRAPHIC SURVEY WAS COMPLETED UNDER THE DIRECT AND RESPONSIBLE CHARGE OF M. DWAYNE DUNEANT, LS FROM AN ACTUAL GROUND SURVEY MADE UNDER MY SUPERVISION. THAT THE ORIGINAL DATA WAS OBTAINED ON THE FOLLOWING DATES: 05-13-2015, 05-18-2015 AND 05-20-2015. THIS PLAT, MAP AND DIGITAL GEOSPATIAL DATA INCLUDING METADATA MEETS MINIMUM ACCURACY STANDARDS UNLESS OTHERWISE NOTED.

HORIZONTAL DATUM: NAD83 (VA South)

VERTICAL DATUM: NAVD88

DATUM ESTABLISHED BY RTK ON 05-13-2015 (CORRECTIONS FROM RTCM-REF 0577)

Underground Utility Location Notes:

- There May Be Abandoned Underground Utility Lines In Project Limits.
- All Sizes and Types of Underground Utility Lines Are Taken From Reference Mapping Or Pre-Existing Miss Utility Markings.

Underground Utility Owners:


- Natural Gas - City Of Richmond
- Waterline - City Of Richmond
- Communication - AT&T Verizon Communications
- Power - Dominion Power

BOUNDARY NOTES:

= Denotes Bearings And Distances Of Property Lines From Recorded Deeds and Plats.

No Title Report Was Provided For This Survey. Easements May Exist That Are Not Shown.

SCALE 1"=10'

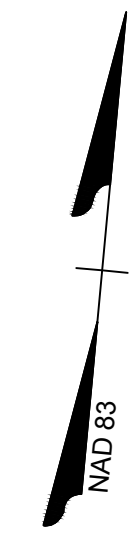

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REVISION DESCRIPTION

DATE

DATE  
07/19/2023

DRAWN BY  
K. UNDERBERG

DESIGNED BY  
C. NELSON

CHECKED BY  
A. WEHUNT

SCALE  
1" = 10'

CITY OF RICHMOND FIRE STATION 21  
BROAD ROCK DISTRICT - CITY OF RICHMOND - VIRGINIA  
EXISTING CONDITIONS PLAN

JOB NO.  
60040



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C1.00

City of Richmond: New Fire Station #21

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**PLAN SET DATE - 07/19/2023**

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DATE	REVISION DESCRIPTION

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K. UNDERBERG
DESIGNED BY C. NELSON
CHECKED BY A. WEHUNT
SCALE 1" = 10'

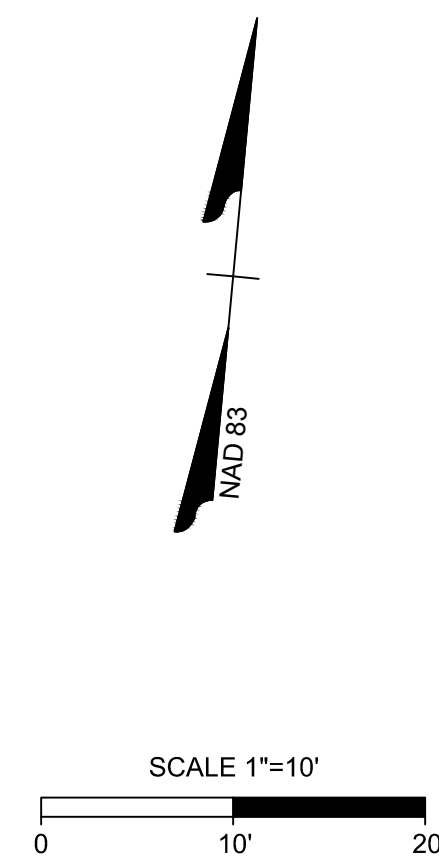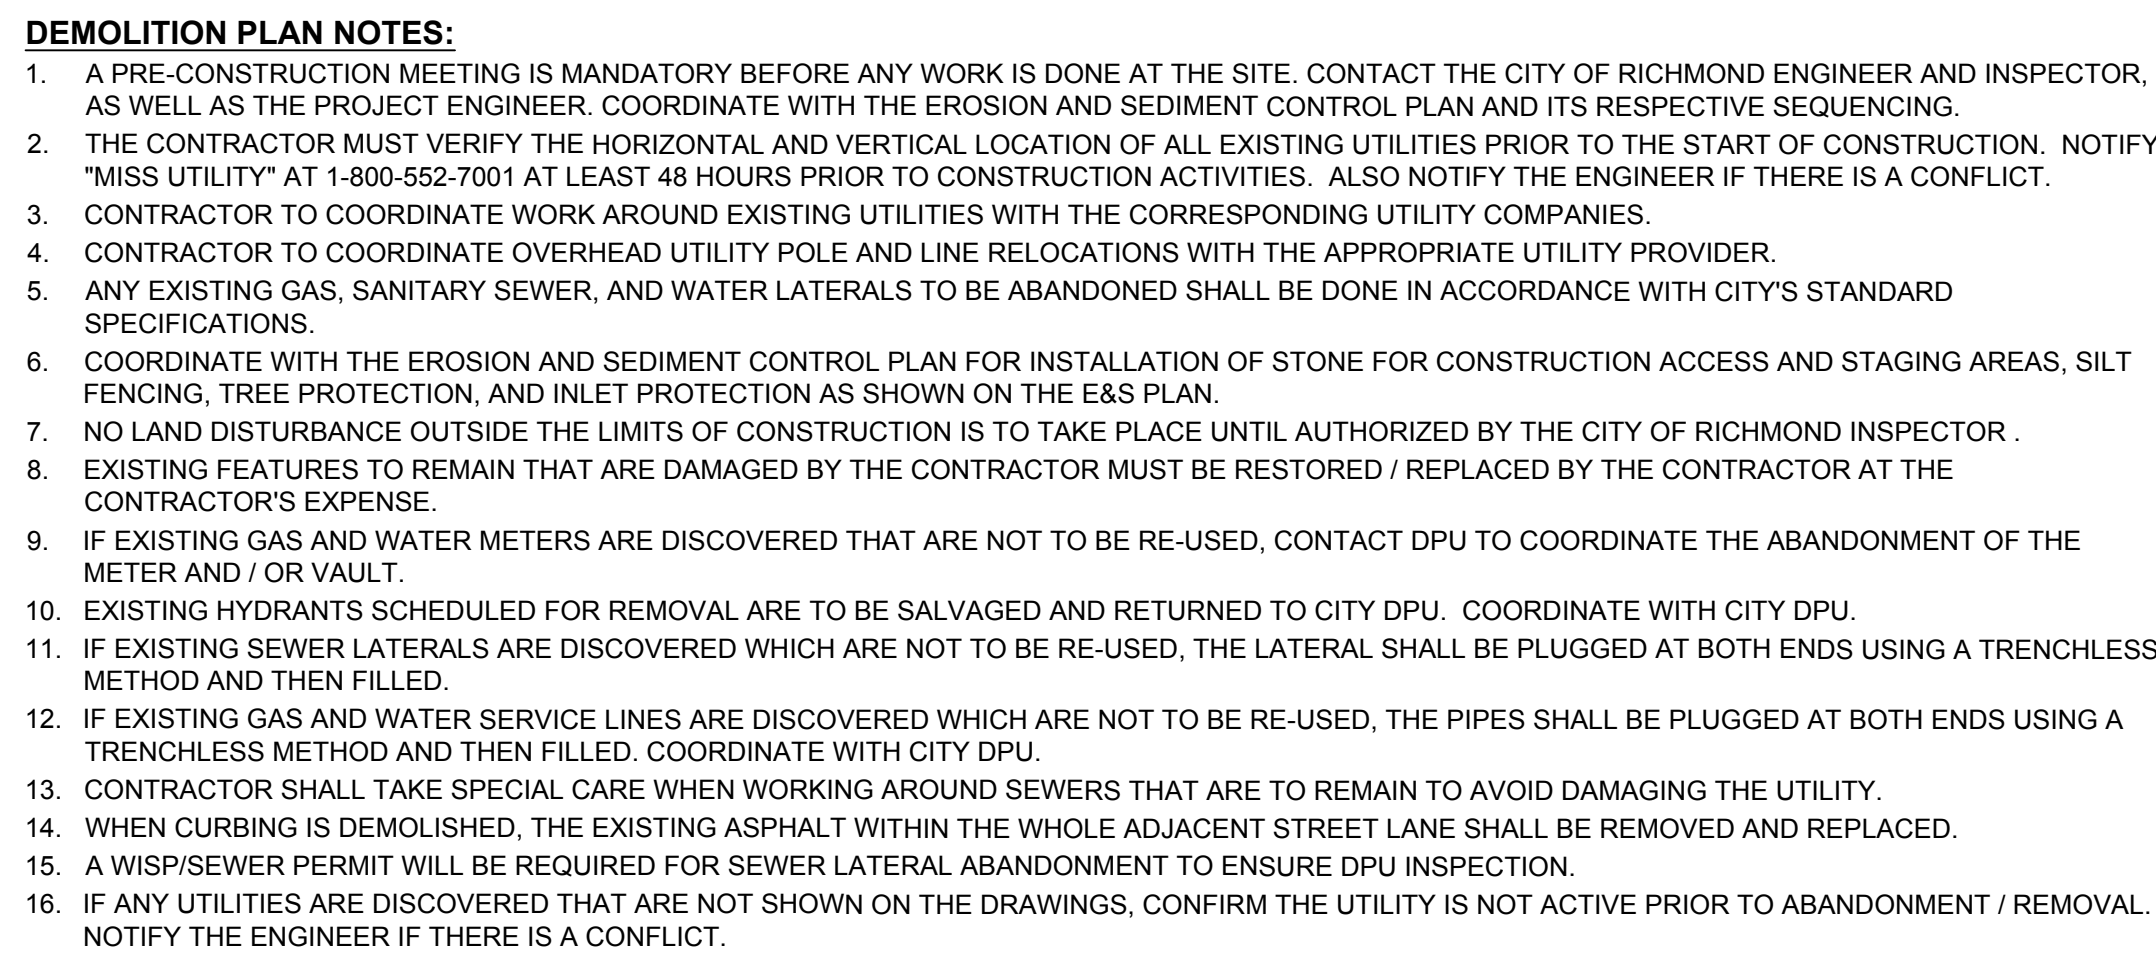
**CITY OF RICHMOND FIRE STATION 21**  
BROAD ROCK DISTRICT - CITY OF RICHMOND - VIRGINIA  
**DEMOLITION PLAN**

JOB NO.  
**60040**


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STANDARD REQUIREMENTS FOR  
REPAVING UTILITY REPAIRS

1. Street cuts in City right away are required to follow the following steps to repair all patches in accordance with the following requirements and as shown in attachment PAV-2, PAV-2-A, PAV-2- B, and PAV-2-C for the following utility cuts: water/wastewater/sewer/gas/communication & electrical trenches.

- a. All sides shall be saw cut to neat straight line and an approved tack coat shall be applied at a rate of 0.1 gallon per square yard before placing the plant mix.
- b. PAV-2 requirements are as follows (See Attached).
- Install PB-1 Pipe Bedding No 25, 26, or 57 stone per VDOT standard or an approved equal.
- Backfill remaining trench with Type 1, Size 21-A or 21-B stone compacted to 95% theoretical maximum density (Standard Proctor).

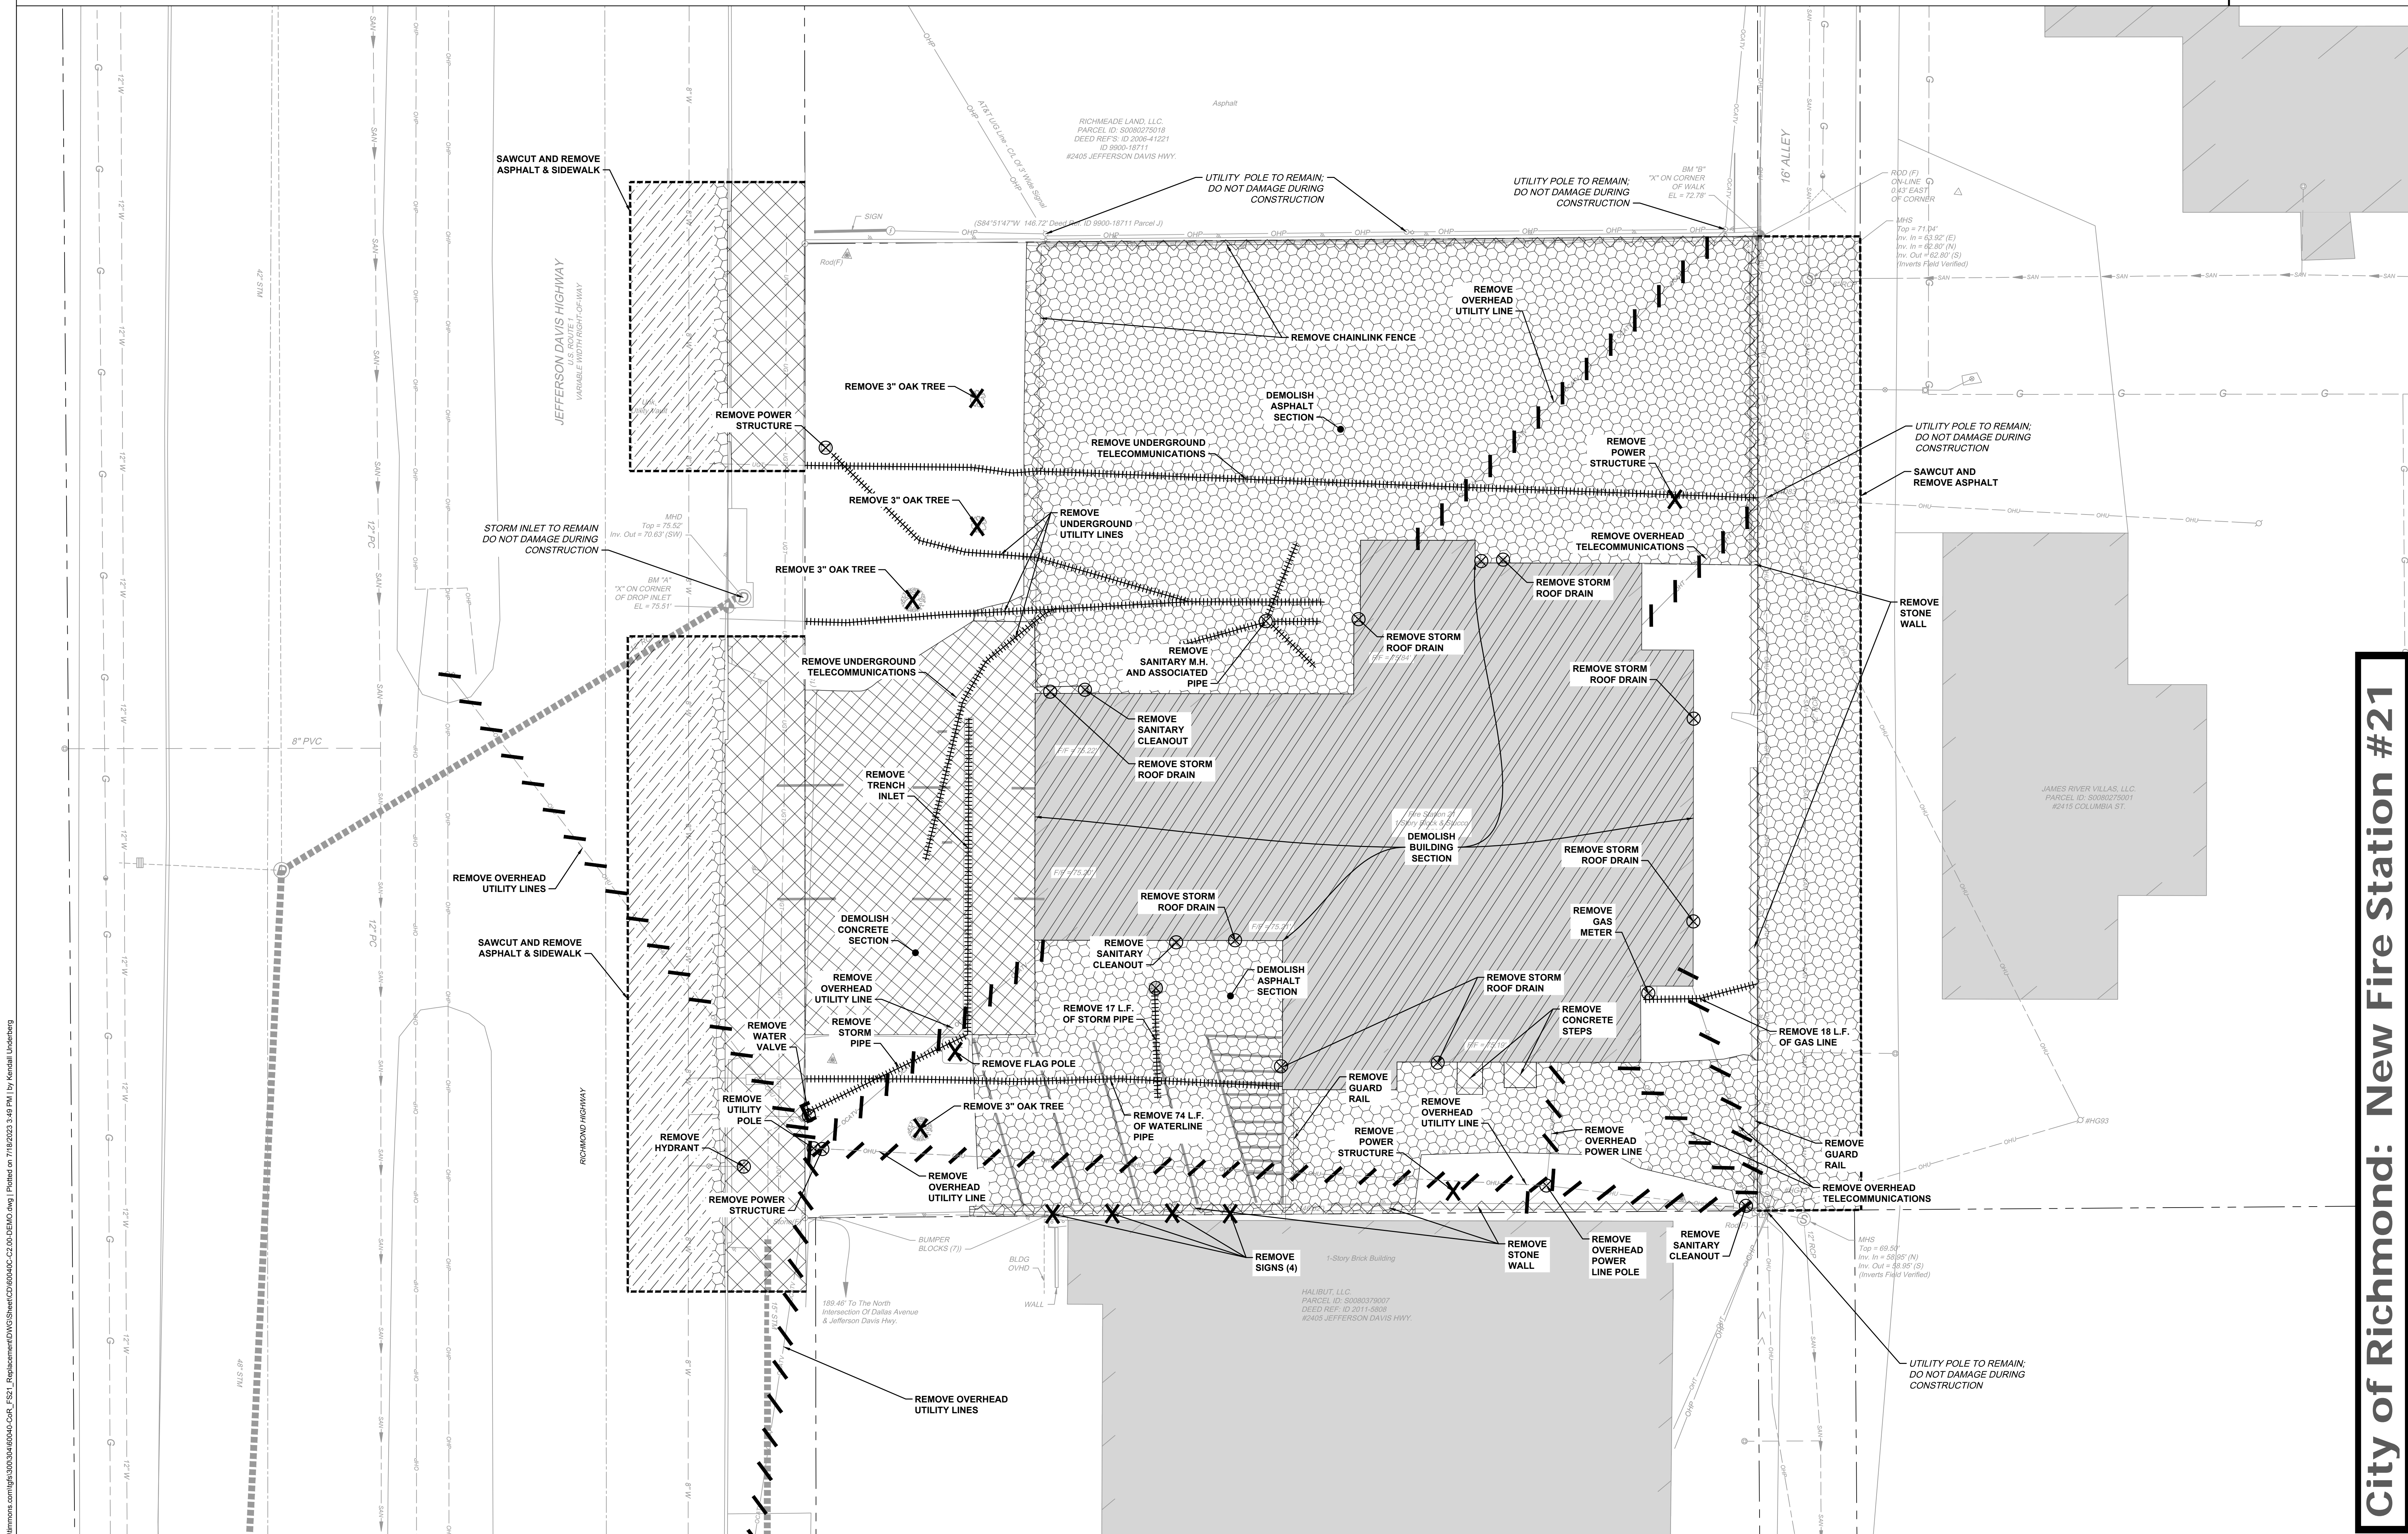• Eight (8") inches BM-25 minimum or install per typical road section if greater, with a minimum of a one (1) foot bench on each side of trench. The 21-A stone sub-base shall be installed from the bottom of the repair to within 10" of final restoration. If an existing road surface has less than two (2") inches with no sub-base, the standard for restoring the roadway shall apply to all city streets.

• For Transverse Cuts, for Arterial Street mill two (2) inches in depth from center line of trench twenty five (25) feet in both directions and overlay area with two (2) inches of SM-9.5D type asphalt to match existing cross section. For Local and Collector Streets mill a total of fifteen (15') feet with the trench located in the middle of the milled area.

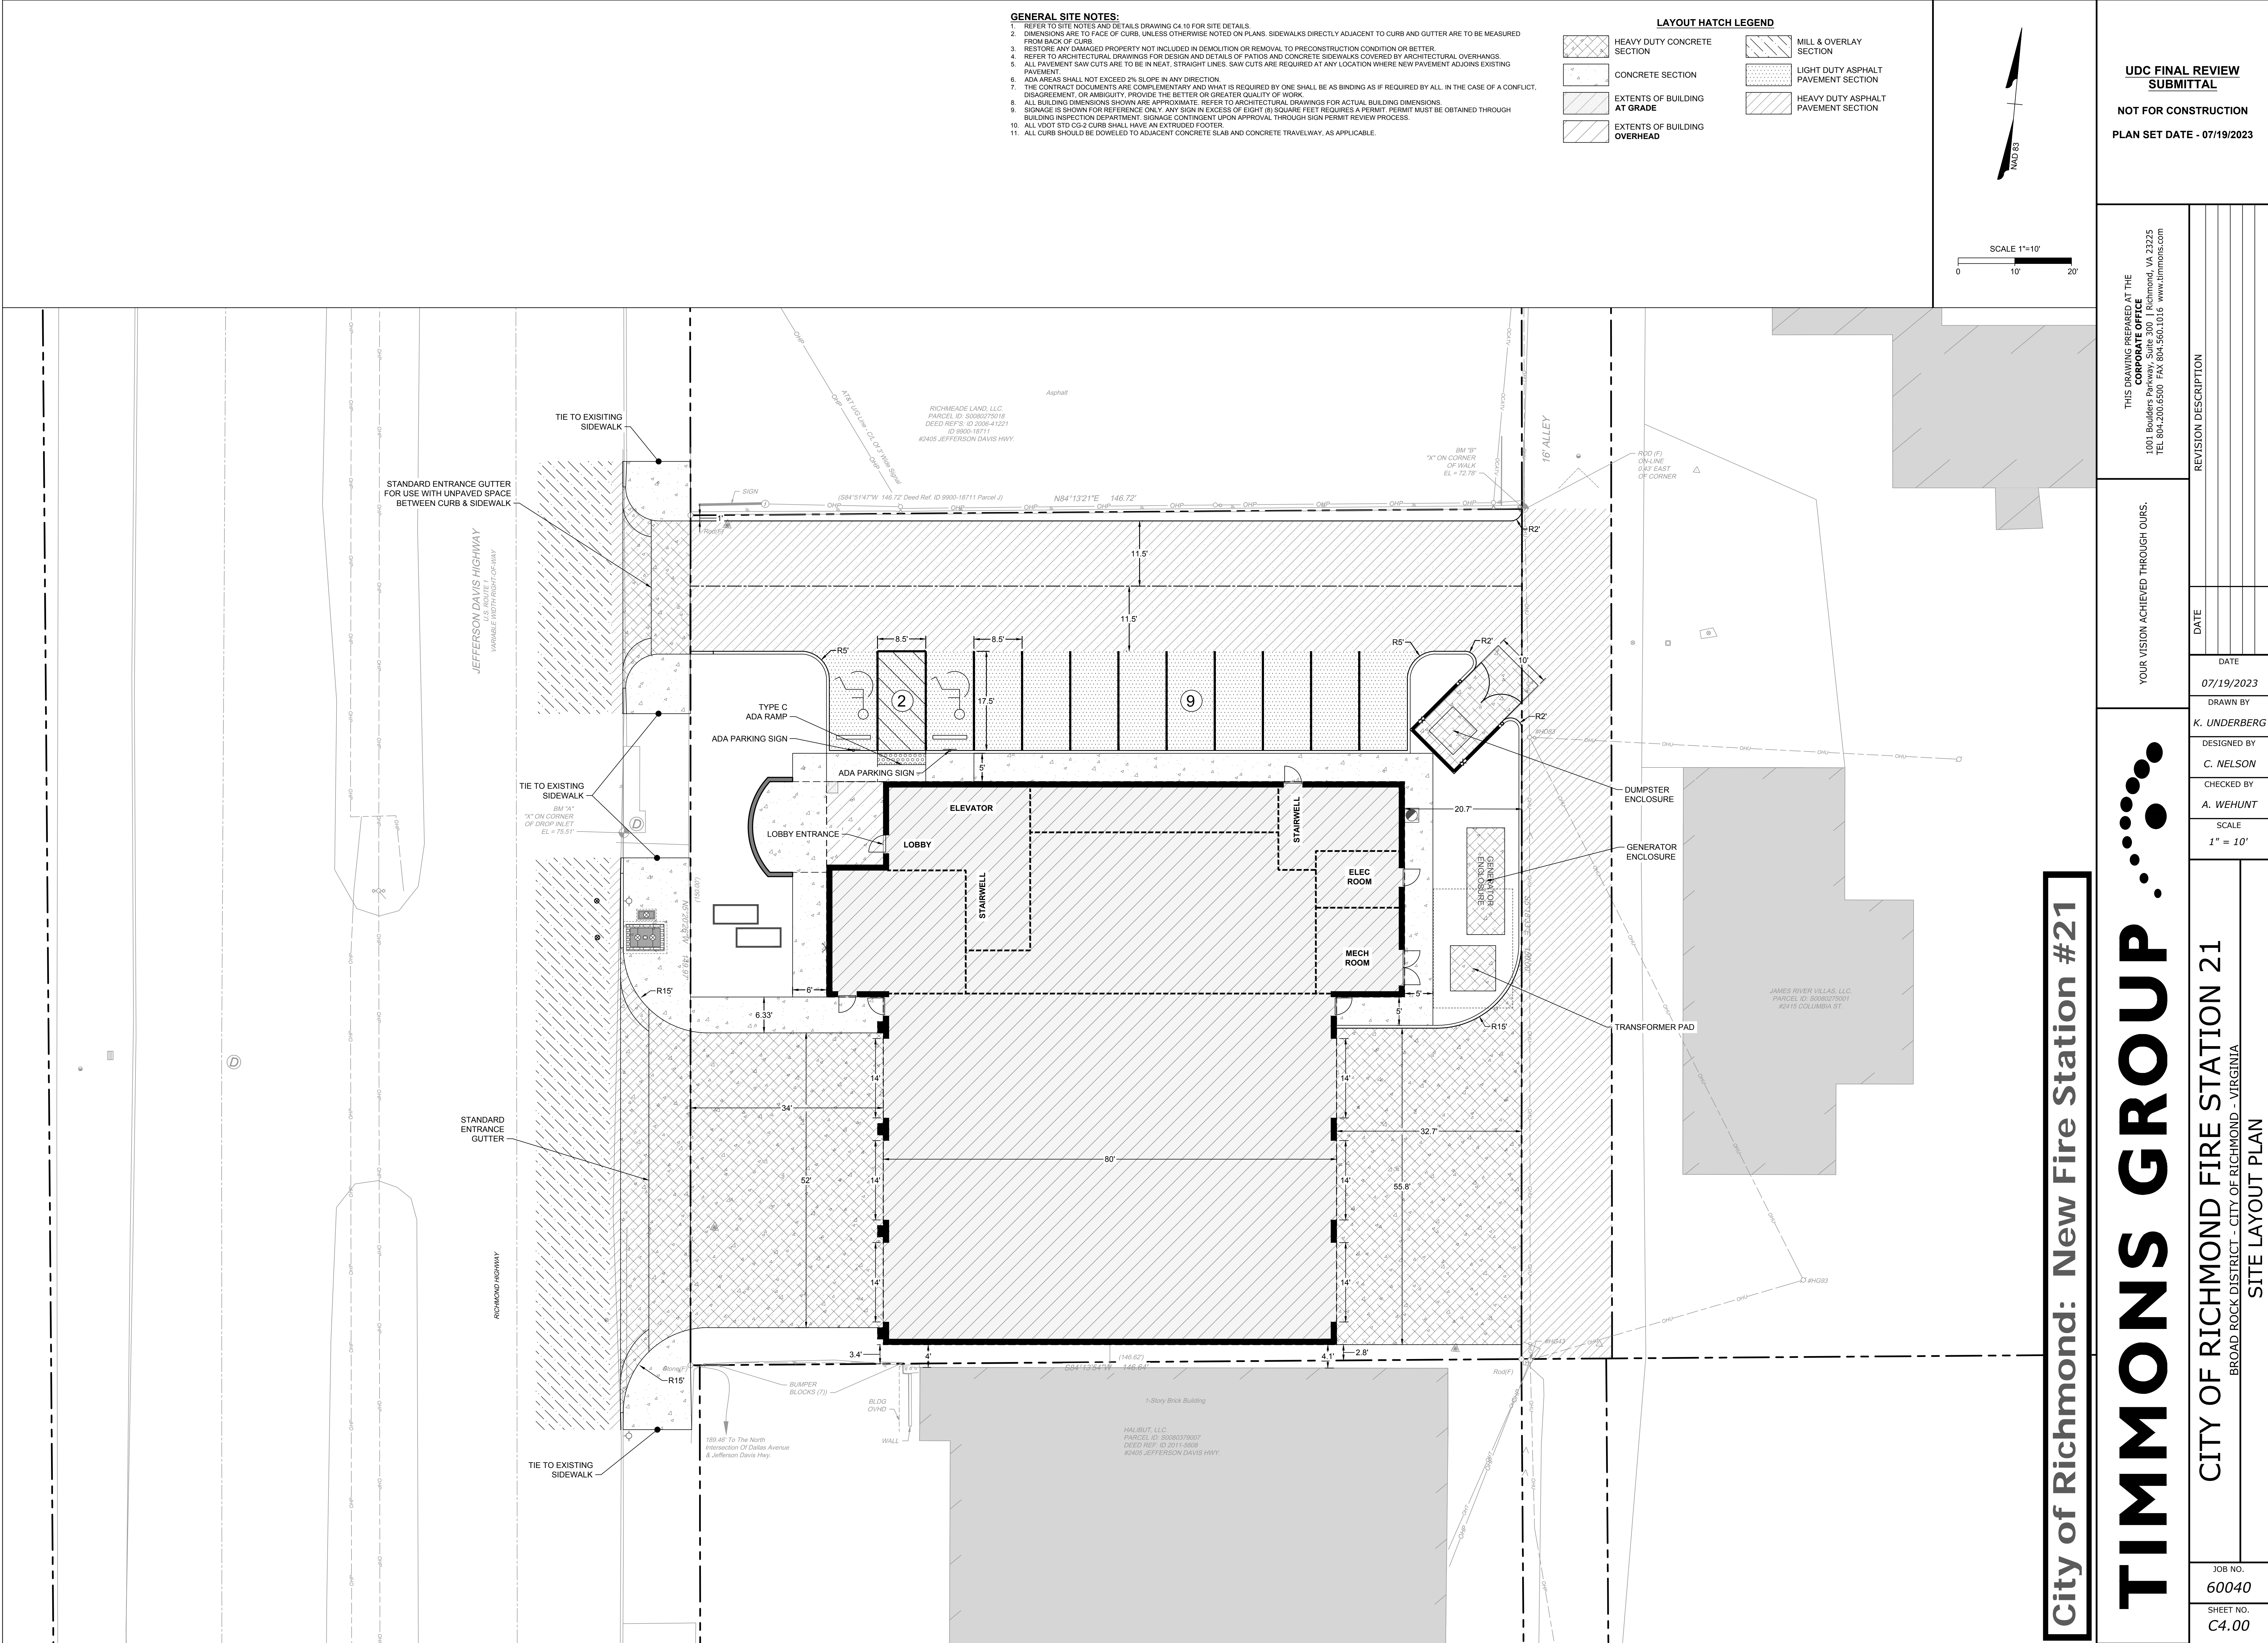• The 25' in both directions of the trench for Arterial Streets and the fifteen (15') feet for Local and Collector Streets allows the City to create a smooth transition along the roadway. The 5000 ADT (Average Daily Traffic) is a VDOT standard for their roadways and 25% of the City of Richmond roadways meet these VDOT standards. This requirement shall apply to all of City of Richmond roadways to insure a smooth riding surface.

• In the event of multiple cuts and the distance between milled areas being twenty (20') feet or less, this area is to be included with restoration of the utility repair.

• For Longitudinal Cuts, mill two (2) inches in depth from edge of pavement or edge of travel lane to center line of roadway and overlay with two (2) inches of SM-9.5D for the entire length of cut. (This is referencing the travel lane that the cut was made in)

• When Longitudinal cuts are within two (2) feet of center line of roadway, entire roadway will be milled two (2) inches in depth from edge of pavement to edge of pavement or from edge of travel lane to edge of travel lane for the entire length of cut and overlay with two (2) inches of SM-9.5D. (This is referencing the travel lane the cut was made in.)

• In the event when the 2" milling is performed to create the smooth transition on the existing roadway and the roadway has insufficient asphalt depth. The segment with insufficient asphalt depth will be milled a total of (4") four inches and install (2.5") two and half inches of BM-25 asphalt and (1 1/2") one and half inches of SM-9.5D asphalt. This would apply to all insufficient areas including all transverse cuts and longitudinal cuts

• Attachment 1A : Shows in detail what is to be expected for the repair of Transverse Utility Cuts and Longitudinal Utility Cuts

All asphalt repairs will be checked with a twelve (12) foot straight edge to assure a smooth transition from existing pavement to new pavement.

c. All backfilling, compacting, and inspection reporting shall comply with the SOP labeled Backfill and Compaction of Utility Trenches within the Public Right of Way.

d. The responsible party for any street cuts in City right away will be responsible for any depression greater than (1/4") that occurs within the one (1) to three (3) year of completion of patching. Correction shall consist of milling and replacing two (2") inches of surface course mix (SM) for the entire area of repair. In the event any depression is greater than one and half inches, the failure will be evaluated by the Paving Engineer for the proper repair.

(The City streets that have documented compaction testing performed would have the one-year warranty period requirement, and the City streets without documented compaction test would require a three-year warranty period)

If the depression occurs, the entire area will have to be repaired and repaved to provide a smooth riding surface.

e. Replacement of all asphalt shall be rolled where possible, with a vibratory roller having a manufacturer's rating of five (5) ton and rolled until the aggregate is keyed into the blumen. Where rolling is not possible, a mechanical tamp will be used. If the application of the bituminous layer is delayed for adverse weather conditions, the contractor shall provide and maintain a base course that is acceptable to the City of Richmond, Department of Public Works, until such time as the appropriate pavement patch can be applied and completion of the installation of the gas, water, sewer, electric, and communication lines. Contractor shall restore pavement in the manner prescribed within 10 calendar days, weather permitting.

f. When final two (2) inch layer of SM-9.5D is to be placed on roadway which has been milled, the contractor shall use a bituminous paver with electronically controlled screed to insure a smooth riding surface. Once final surface is installed, the grade will be checked with a twelve (12) foot straight edge on the finished paved surface. When grade is out of tolerance one quarter (1/4) of an inch or more, the final surface will be corrected to meet Department of Public Works' Paving and Restoration Standards for all underground utility cuts.

g. Final compaction of the top two (2) inches of SM-9.5 D will be performed using a five (5) ton vibratory roller at a minimum.

h. All damages to existing road(s) caused by the responsible party will be restored to the satisfaction of the City of Richmond's Paving Engineer.

i. Permitting shall notify the City of Richmond, DPW Inspector, a minimum of 72 hours prior to open cutting any streets in the City of Richmond. (This does not apply to emergency repairs. Department of Public Works needs to be notified within 24 hours of the location of all emergency utility repairs)

j. At no time shall the contractor park equipment to protect the excavation. Protection of an excavation is either by backfilling the hole or the use of steel plates.













k. All Excavations or Open Cuts shall comply with OSHA Technical Manual, Chapter 2, Titled Excavations: Hazard Recognition in Trenching and Shoring.

2. Cuts for manhole adjustments:

- a. Minimum cut for Manhole Casting adjustment will be a five (5) foot by five (5) foot cut and adjust manhole to +/- one quarter (1/4) inch of final pavement grade.
- Eight (6) inches BM-25 minimum or install per typical road section if greater, with a minimum of a one (1) foot bench on each side of trench with two (2) inches of SM material to meet existing final grade. Once final course is installed, grade will be checked with a twelve foot straight edge for smoothness. (The 1 foot bench is referencing milling around the street cut one (1") foot on the outside edge of the street cut to prevent the infiltration of water at the joint)

3. Cuts for valve boxes

- a. Minimum cut for Valve Box adjustment will be a three (3) foot by three (3) foot cut and adjust valve box to +/- one quarter (1/4) inch of final pavement grade.
- Six (6) inches BM-25 minimum or install per typical road section if greater, with a minimum of a one (1) foot bench on each side of trench with two (2) inches of SM material to meet existing final grade. Once final course is installed, grade will be checked with a twelve foot straight edge for smoothness.

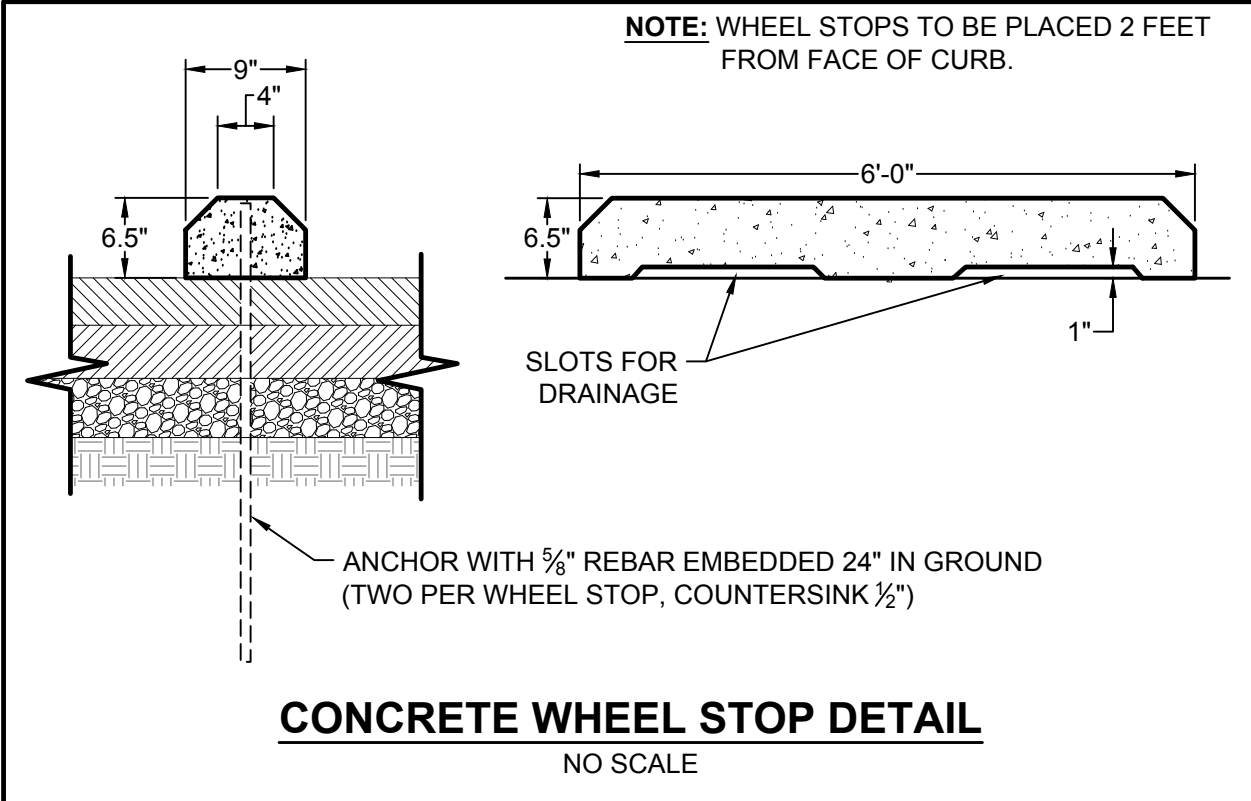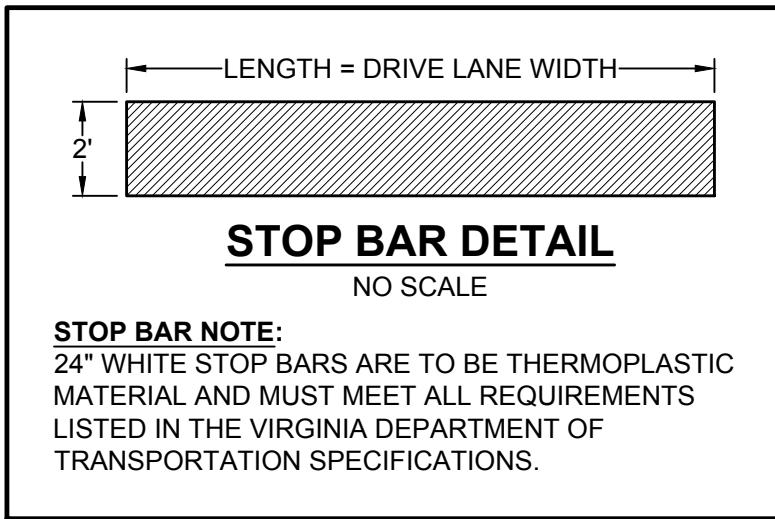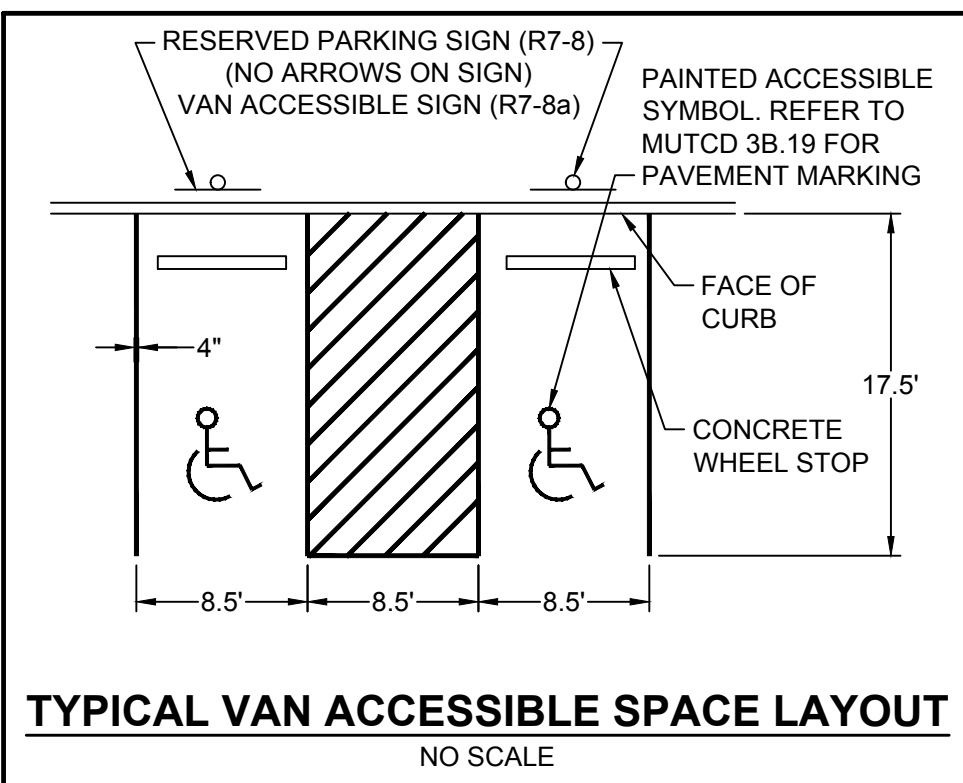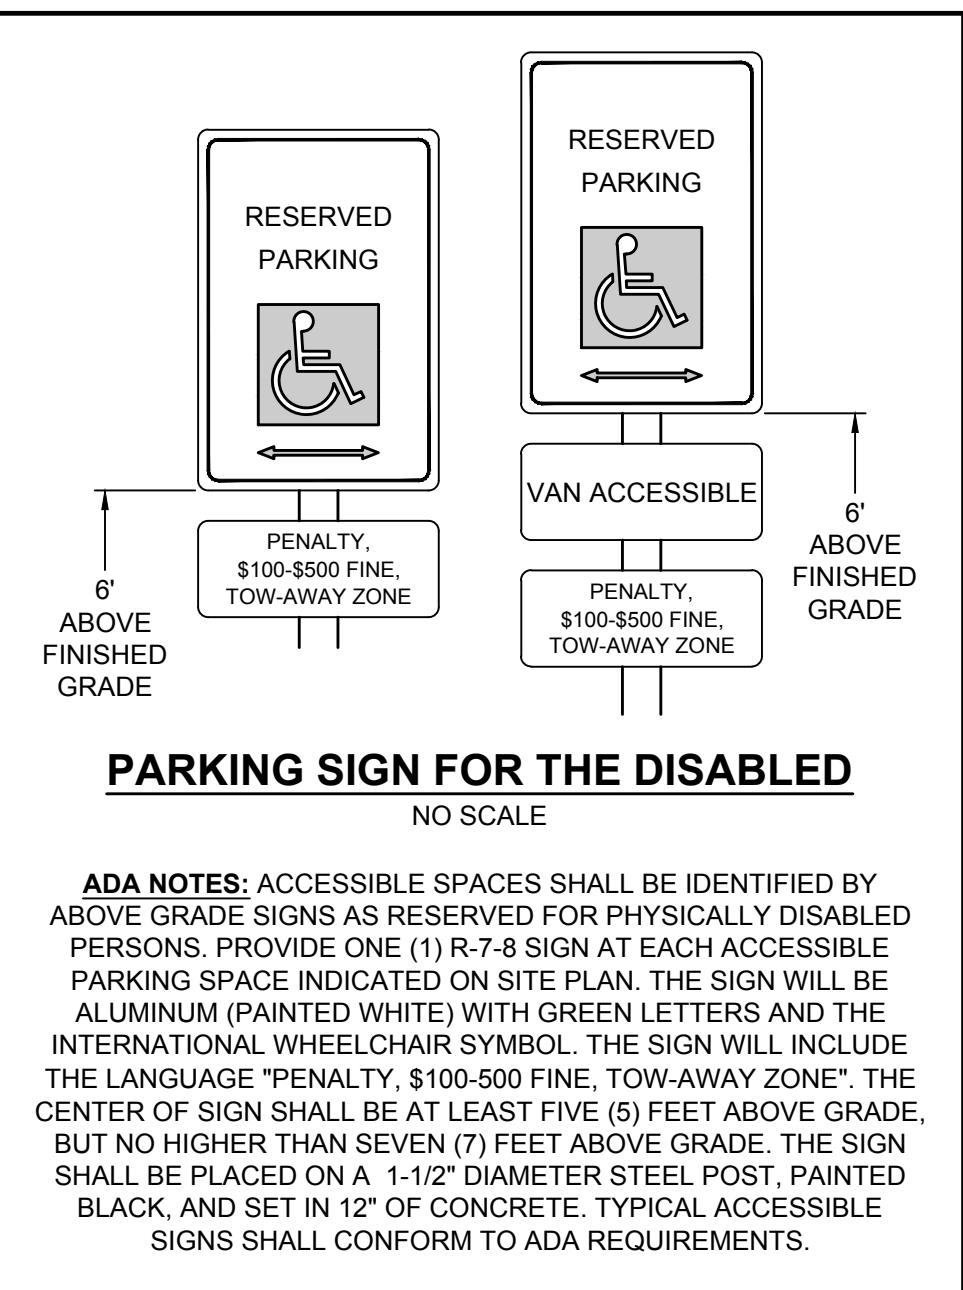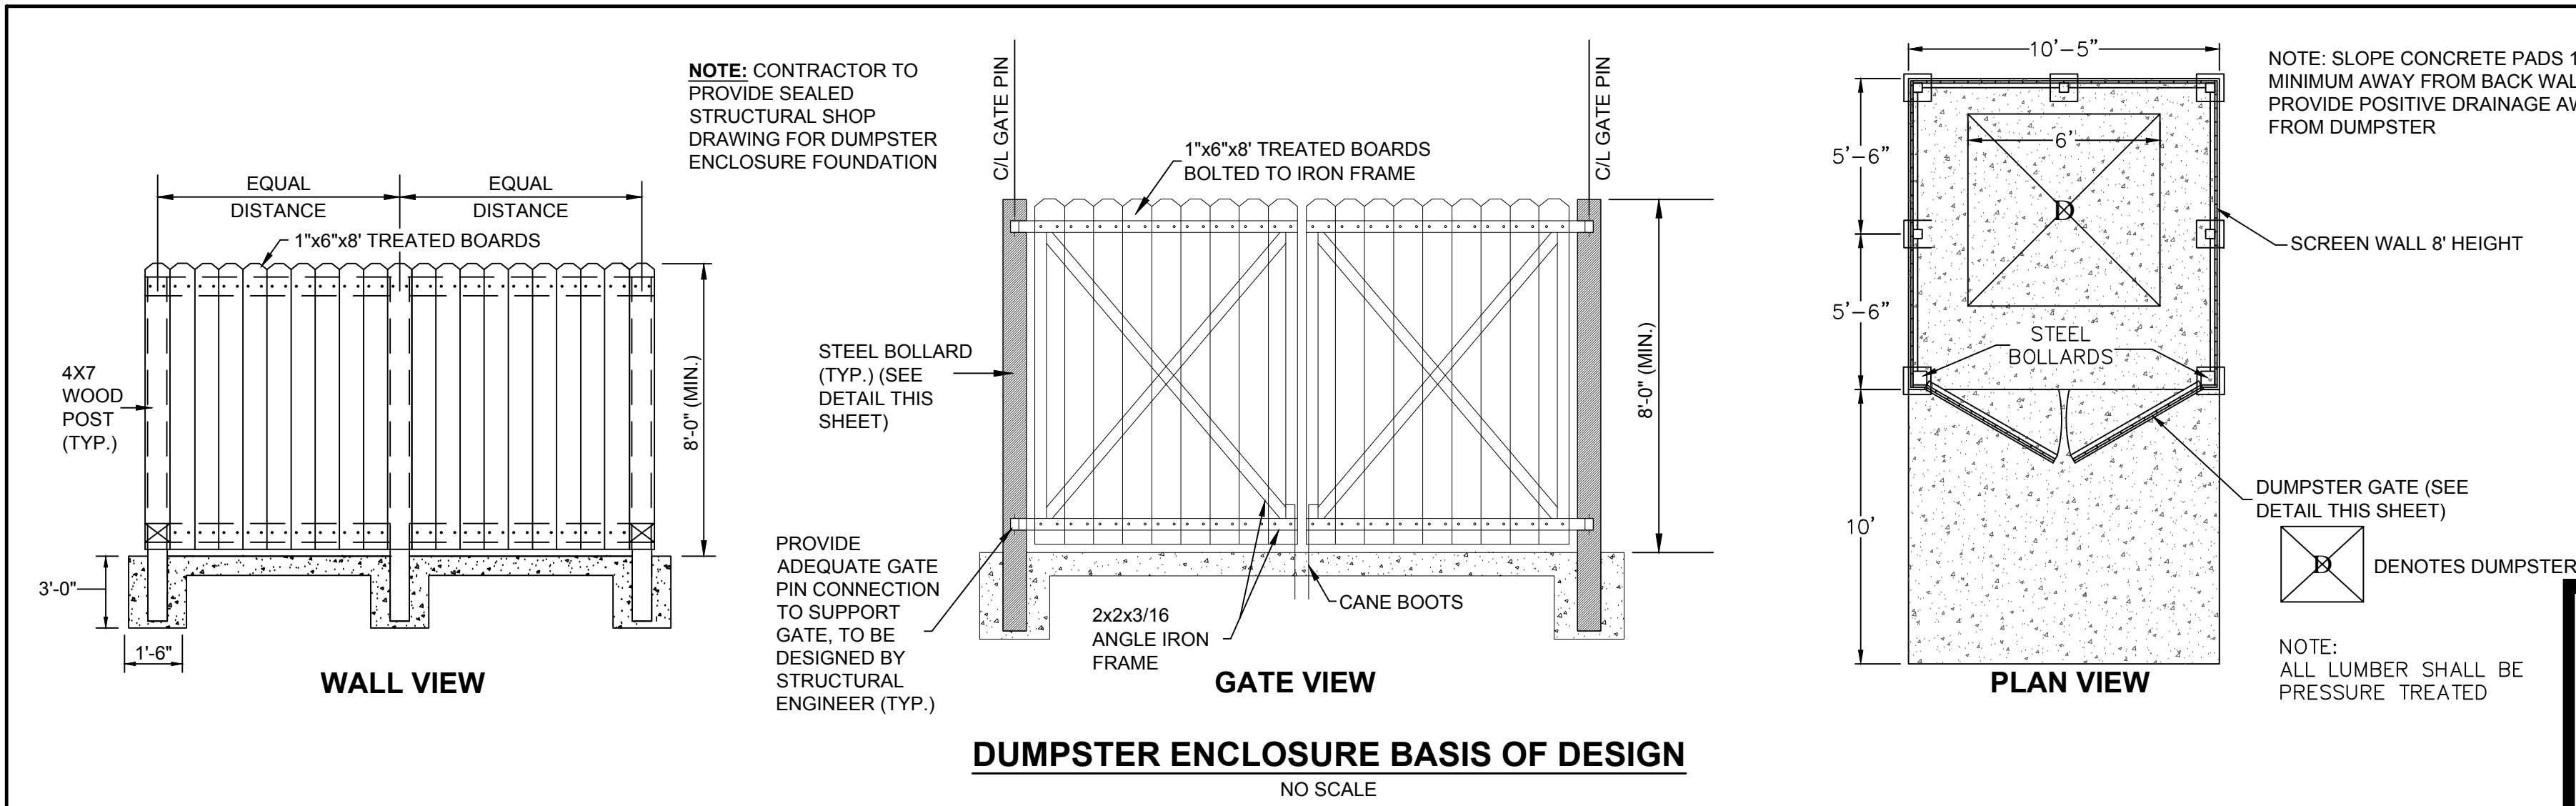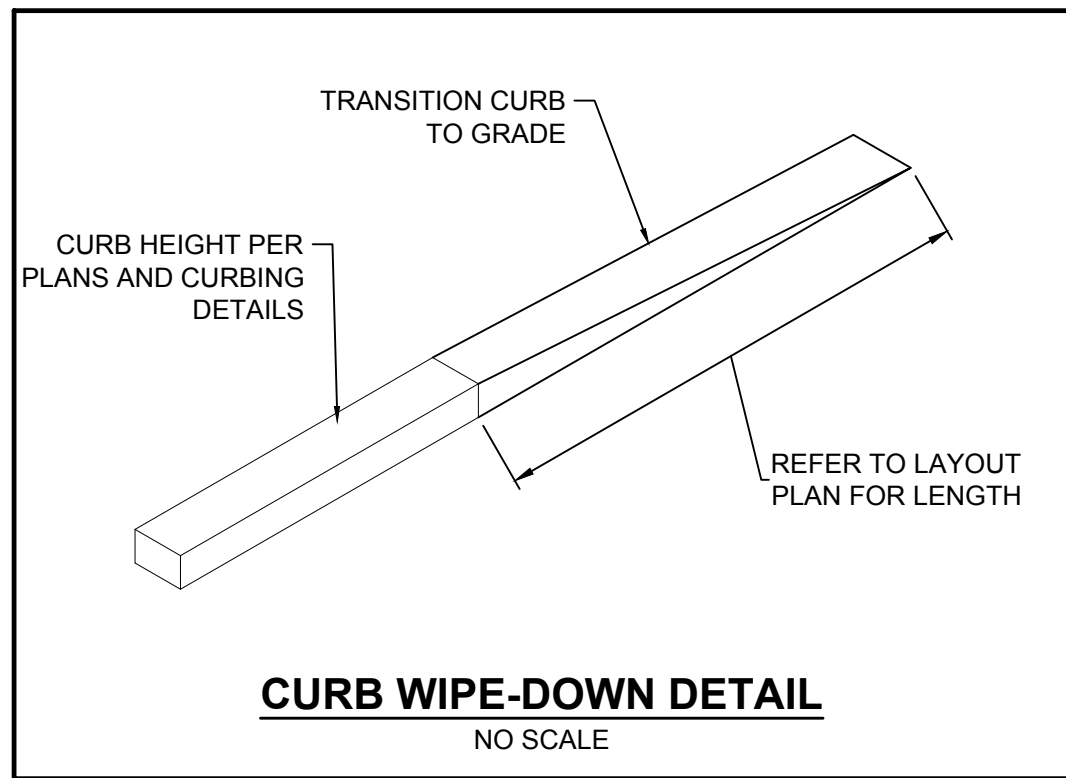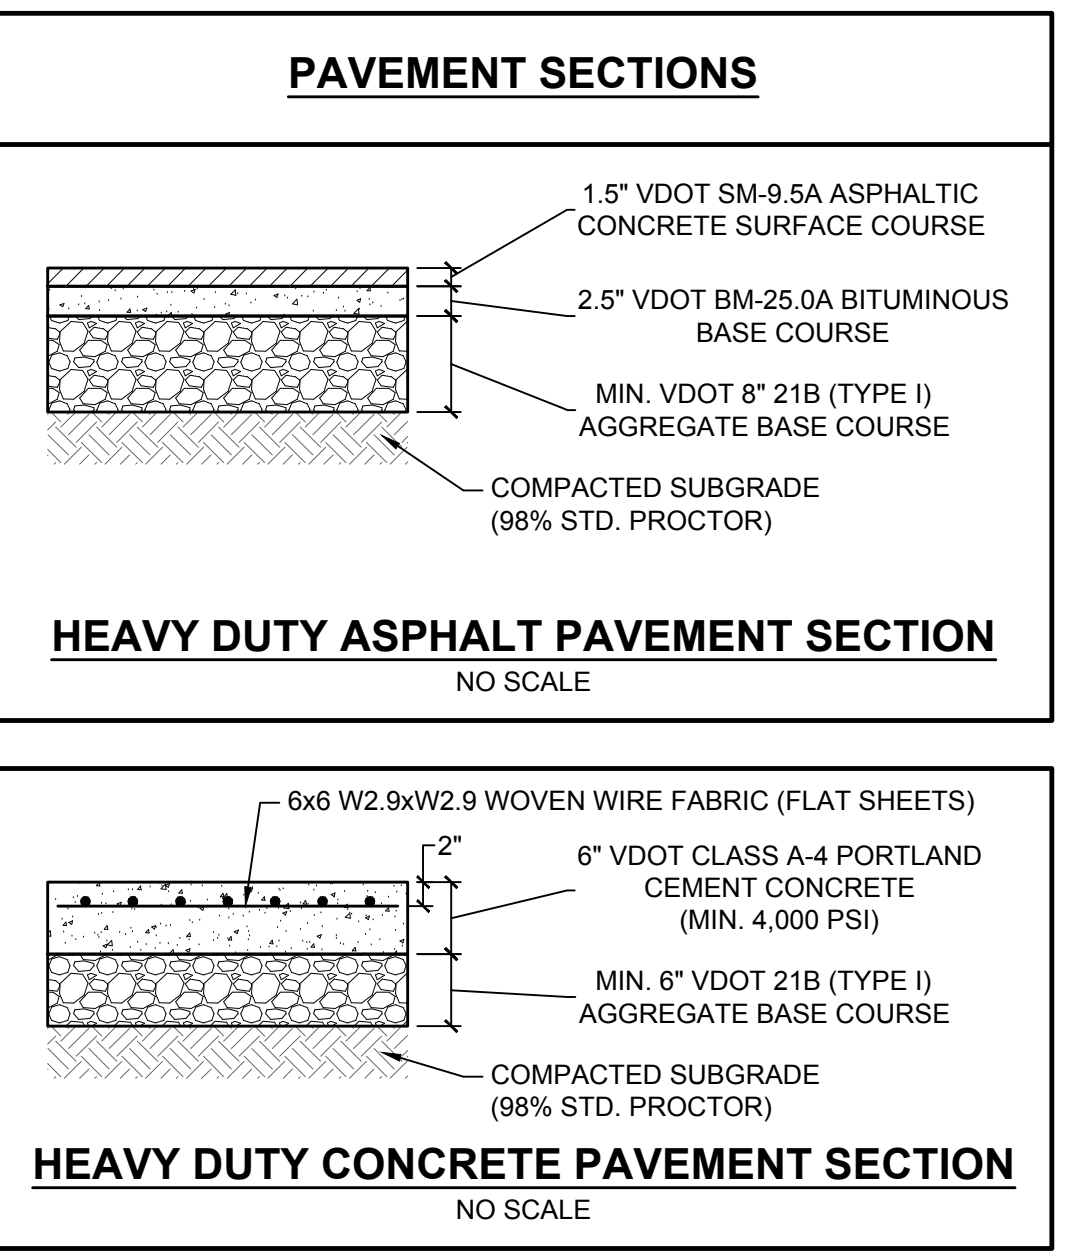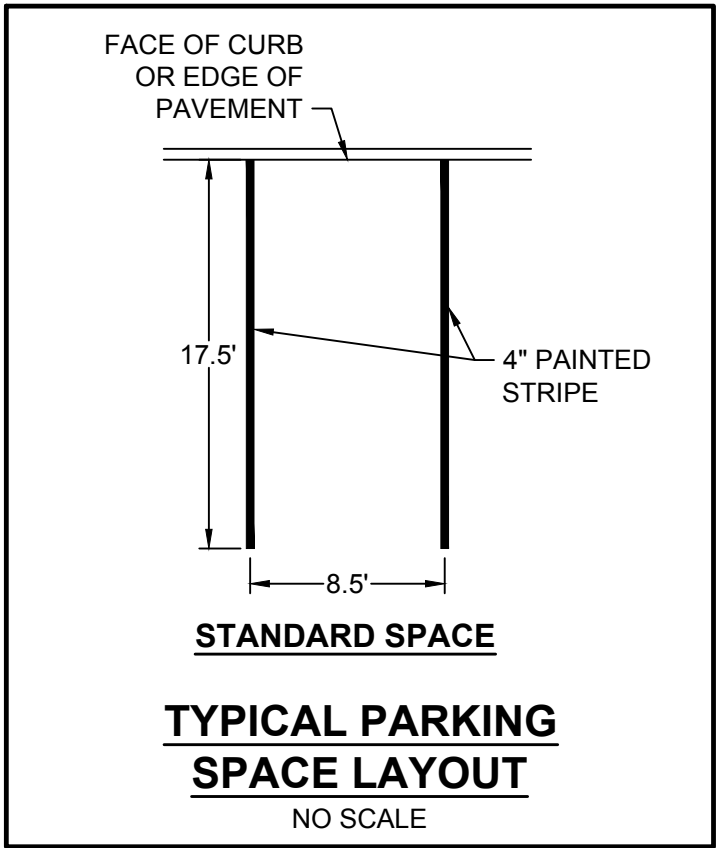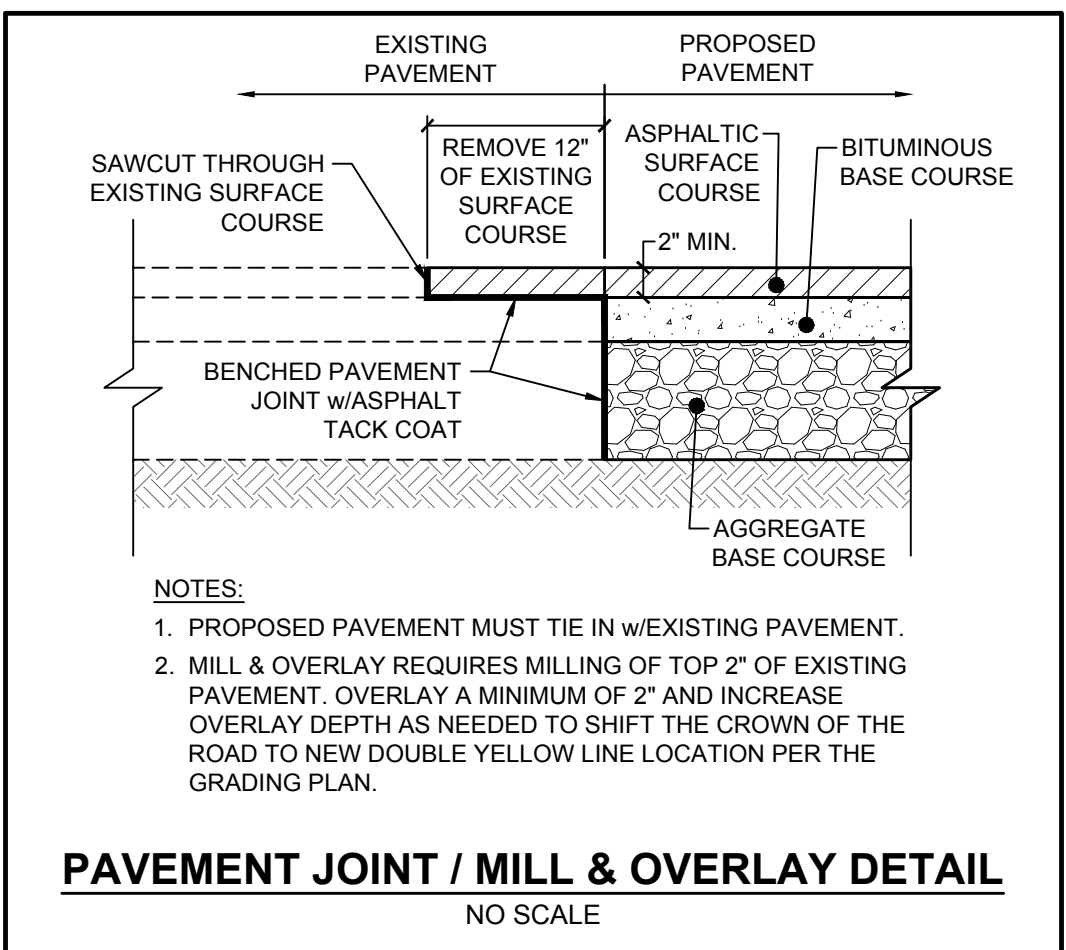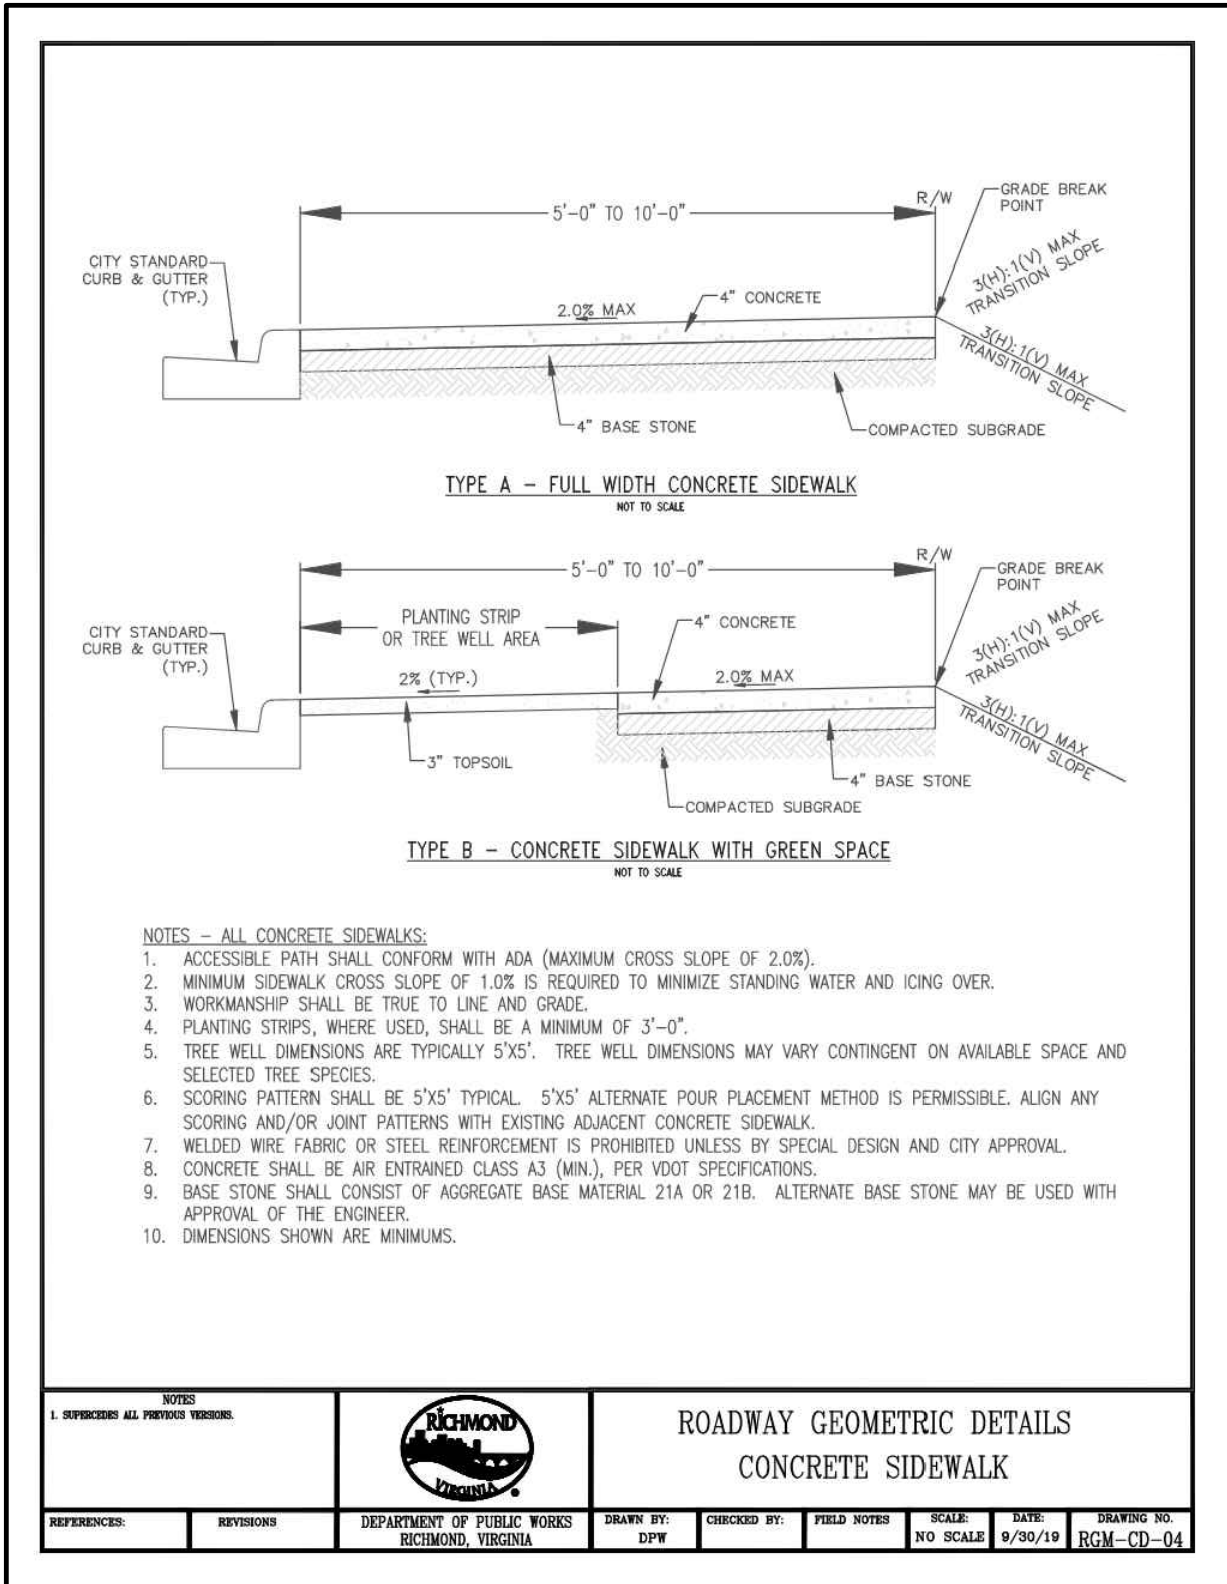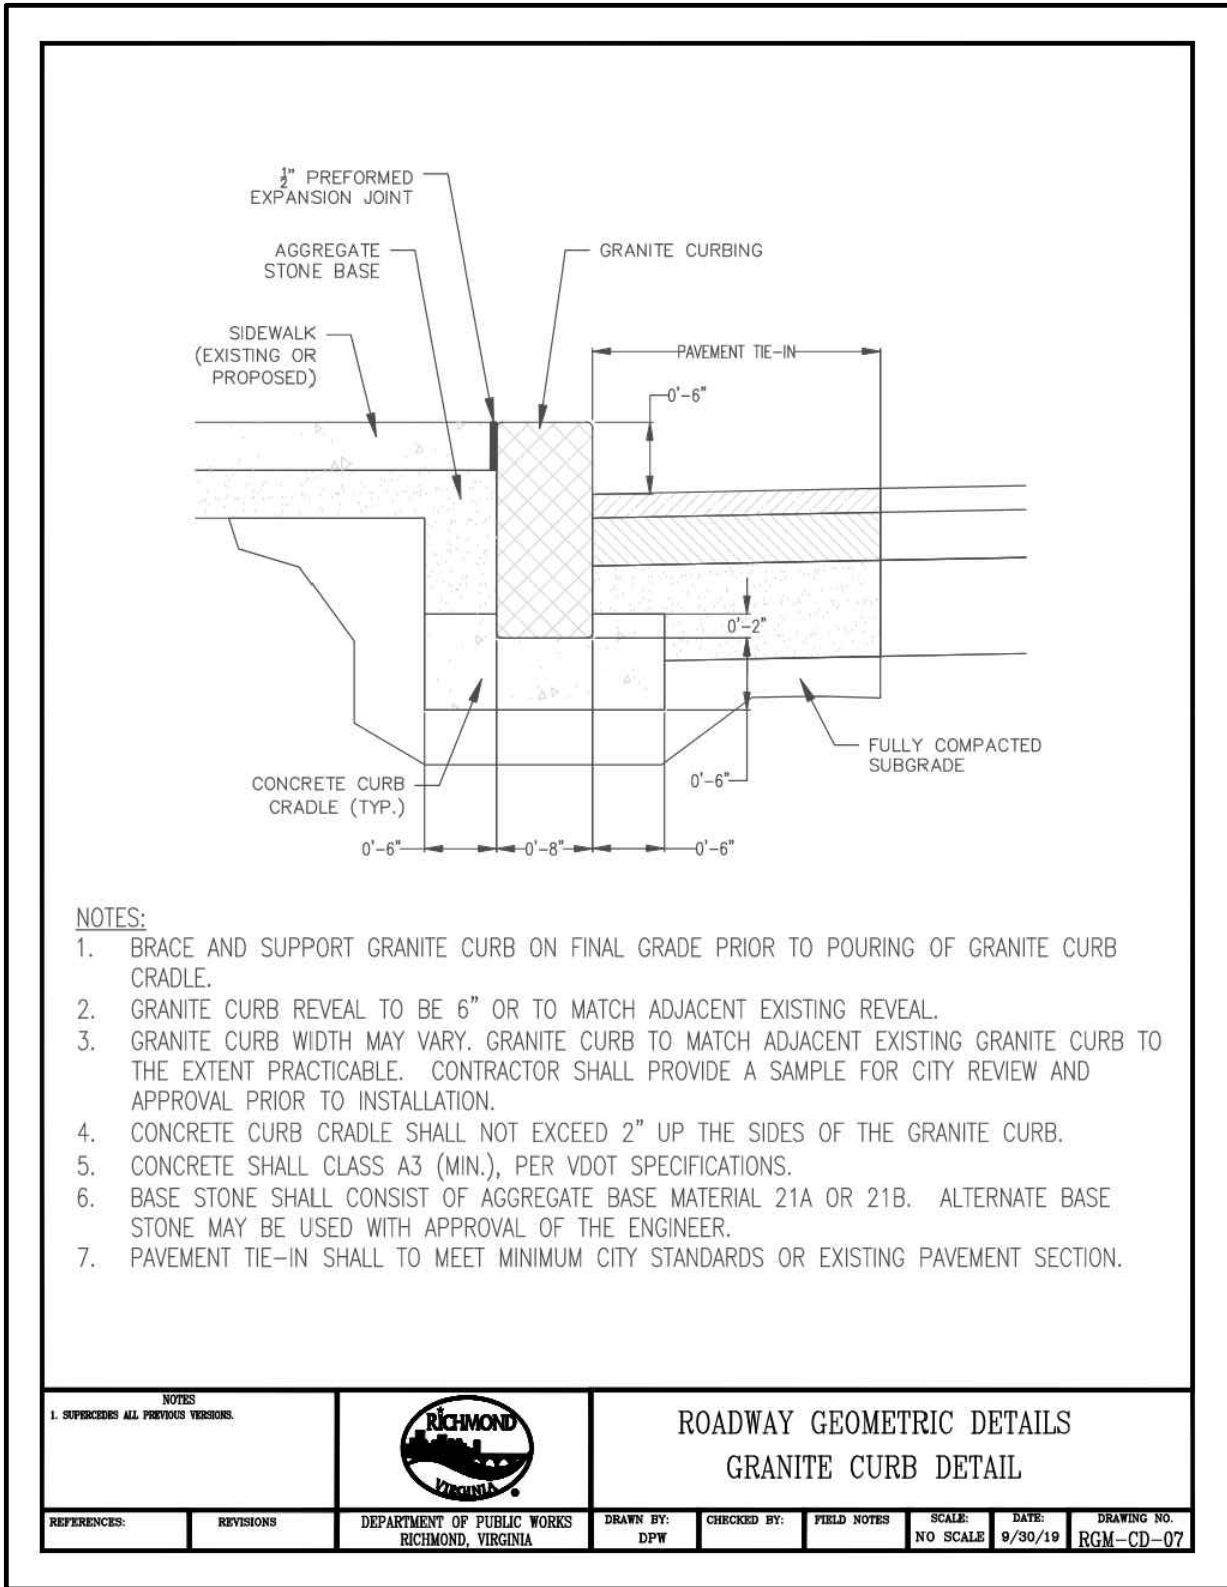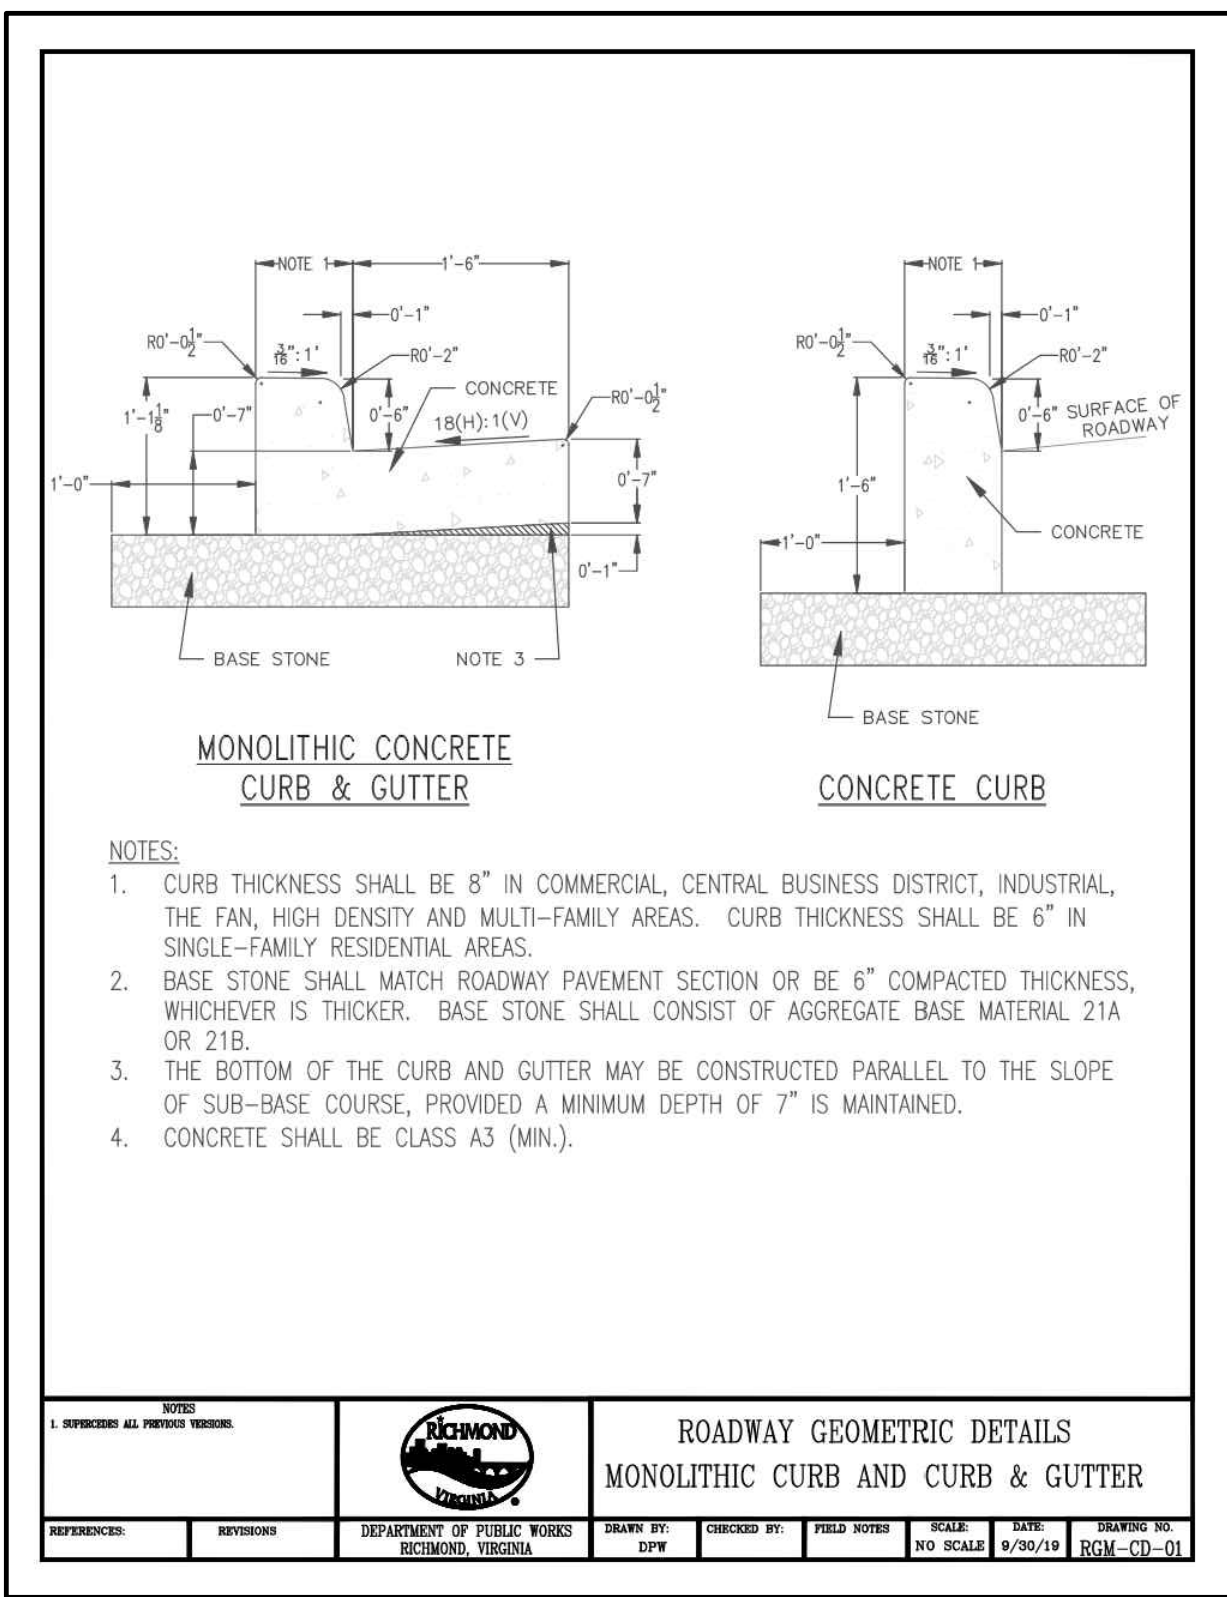

City of Richmond: New Fire Station #21

TIMMONS GROUP

CITY OF RICHMOND FIRE STATION 21

BROAD ROCK DISTRICT - CITY OF RICHMOND - VIRGINIA

SITE NOTES & DETAILS

JOB NO.  
60040

SHEET NO.  
C4.10

UDC FINAL REVIEW  
SUBMITTAL

NOT FOR CONSTRUCTION

PAN SET DATE - 07/19/2023

YOUR VISION ACHIEVED THROUGH OURS.

DATE

DATE

07/19/2023

DRAWN BY

K. UNDERBERG

DESIGNED BY

C. NELSON

CHECKED BY

A. WEHUNT

SCALE

N.T.S

REVISION DESCRIPTION

DATE

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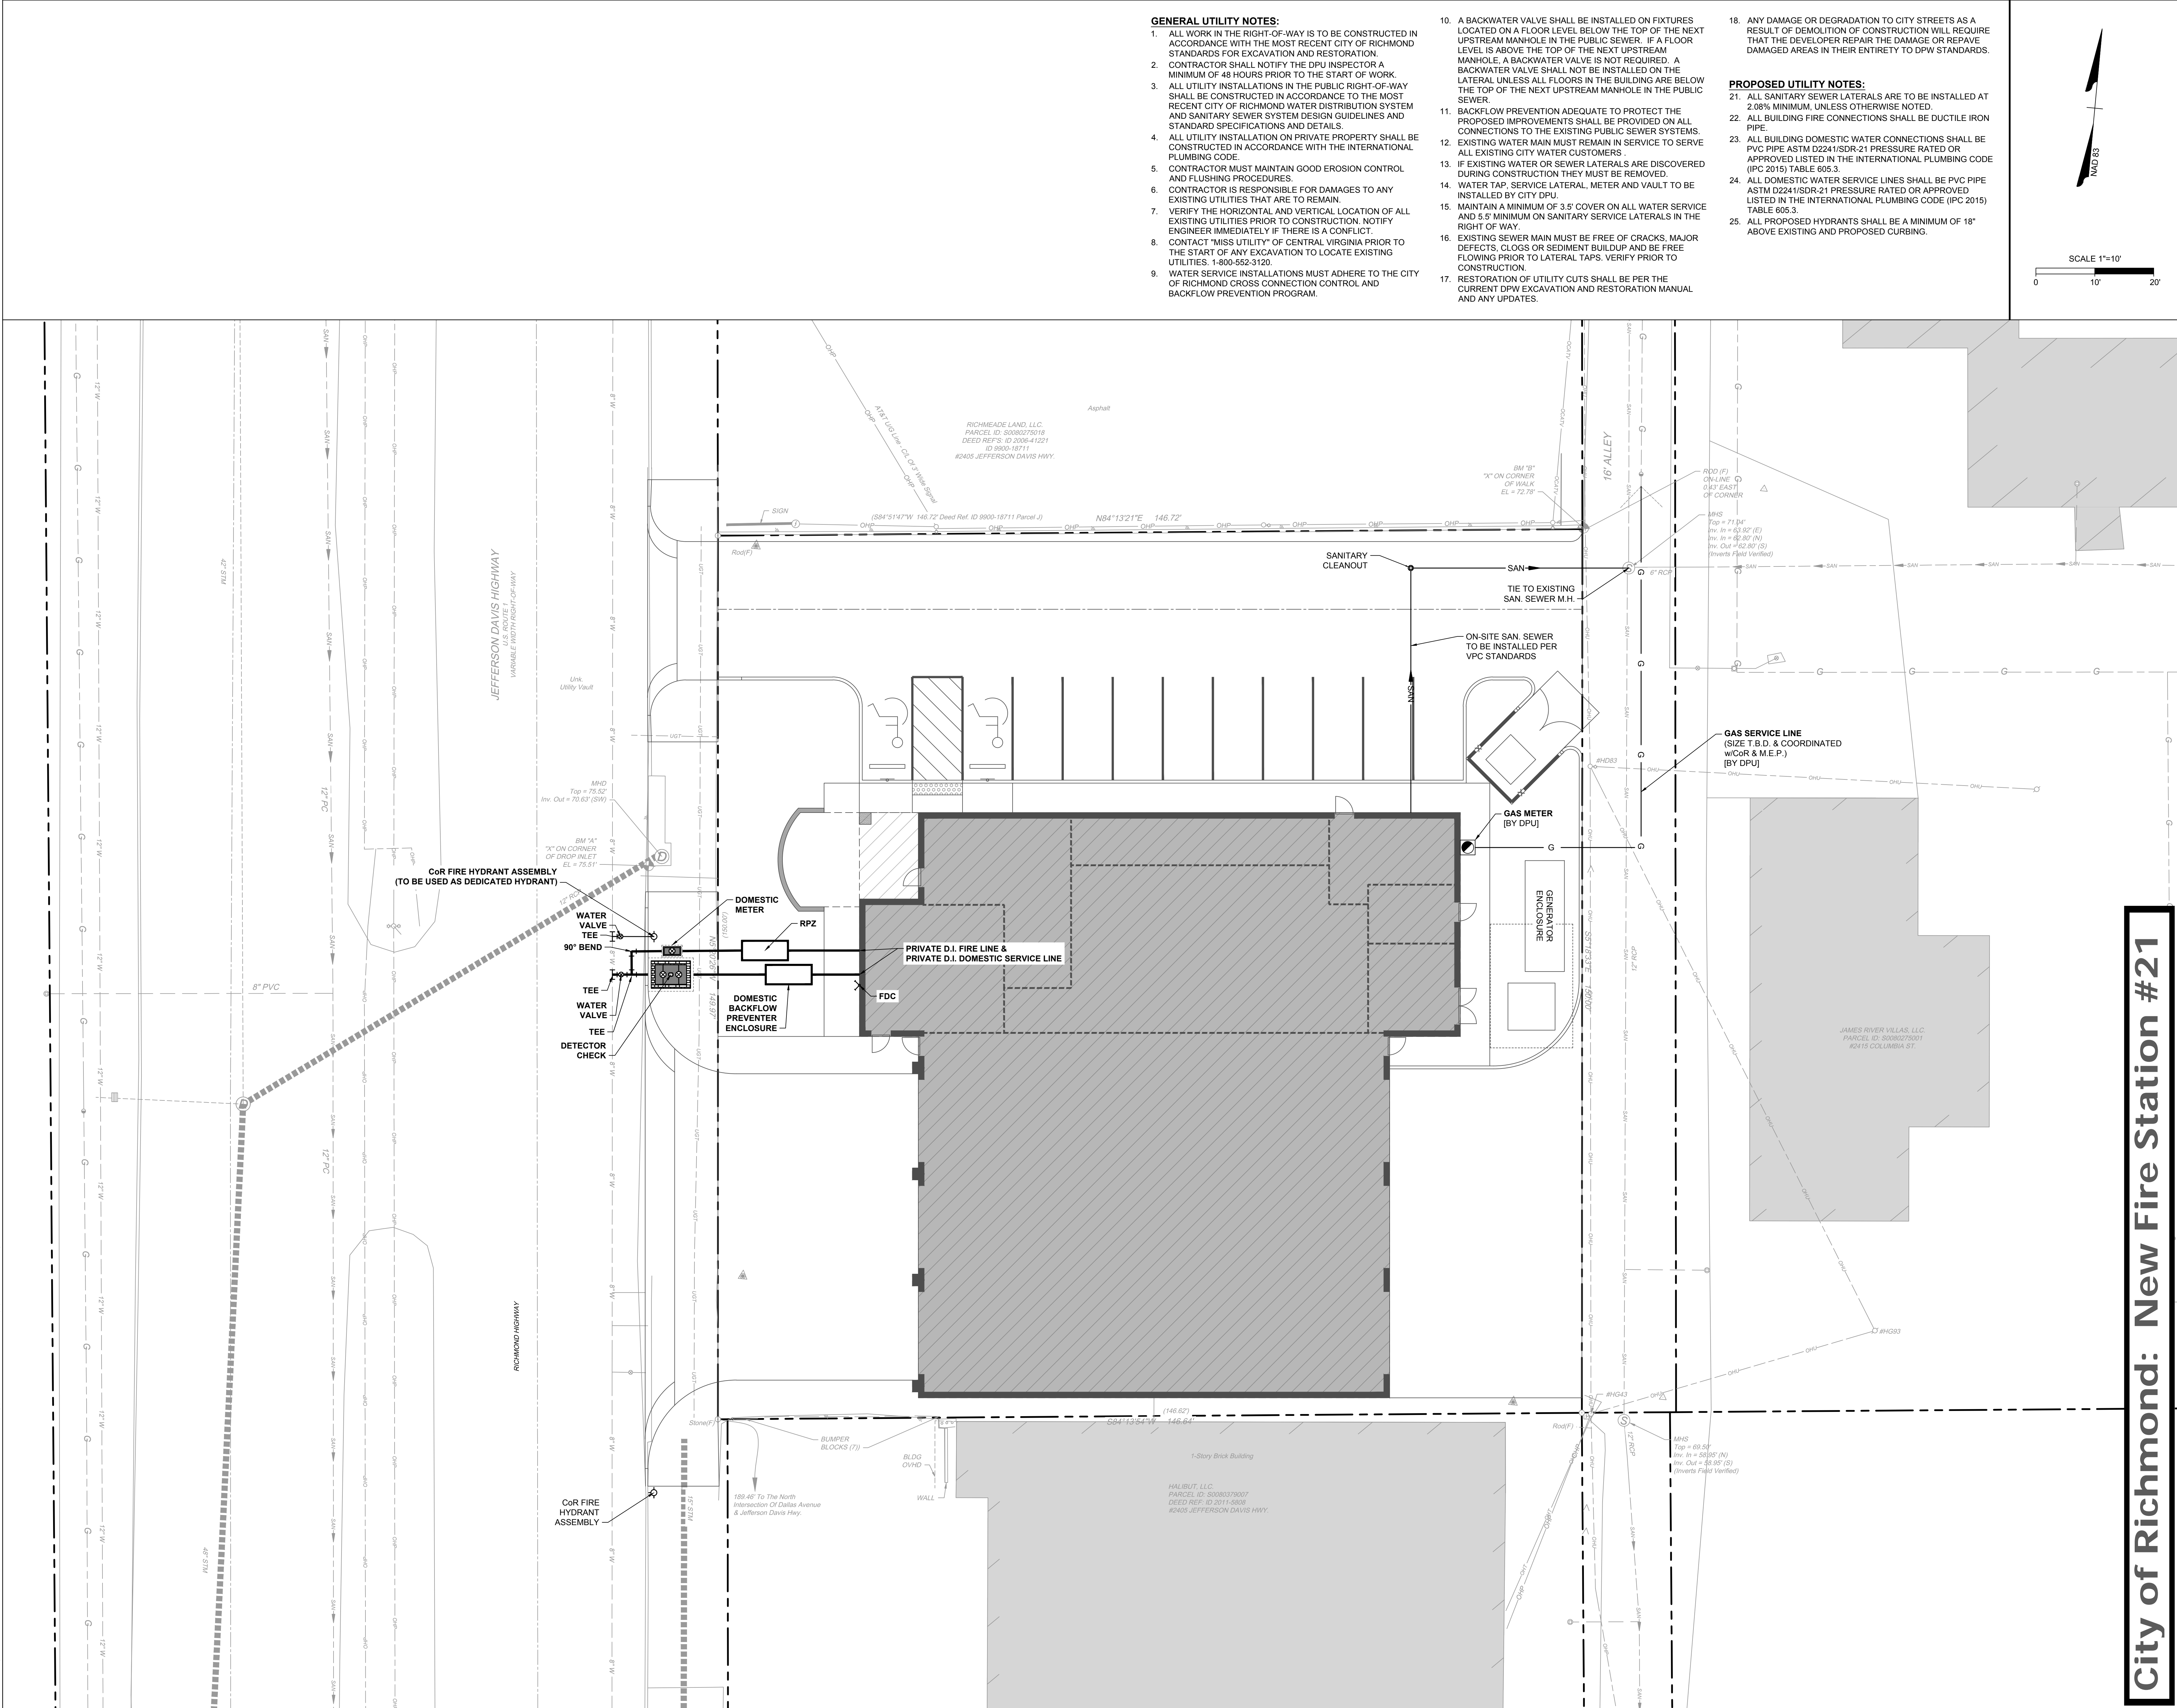
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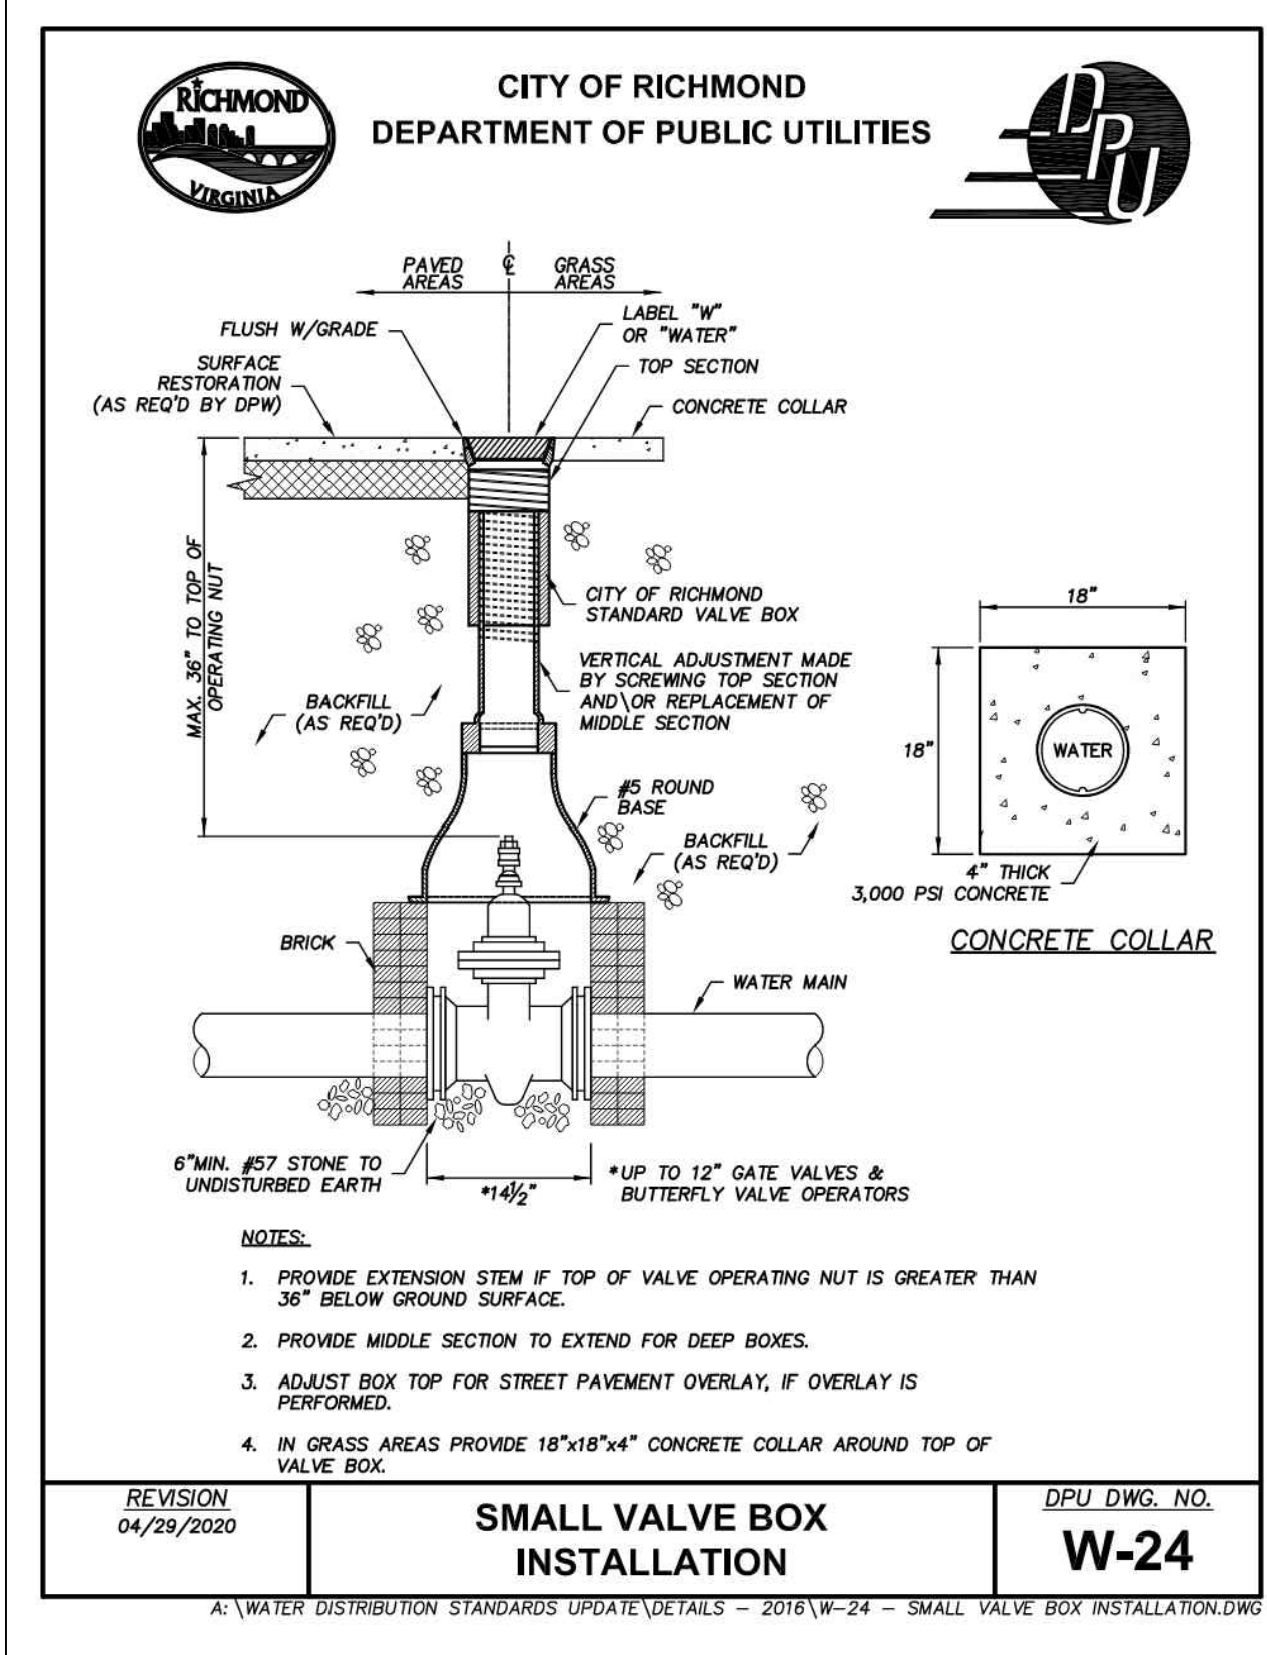
REVISION DESCRIPTION

DATE









# CITY OF RICHMOND DEPARTMENT OF PUBLIC UTILITIES

<b>HORIZ. BENDS</b>	
PIPE DIAMETER	RESTRAINED LENGTH EACH BRANCH
3" OR 4"	1" <sup>1</sup> / <sub>2</sub> , 2' <sup>1</sup> / <sub>2</sub> , 4'
6"	3', 6', 11', 27'
8"	4', 7', 15', 35'
12"	5', 10', 21', 50'
16"	7', 13', 27', 70'
24"	10', 16', 42', 91'

<b>VERT. BENDS (DOWN)</b>	
PIPE DIAMETER	RESTRAINED LENGTH EACH BRANCH
3" OR 4"	1" <sup>1</sup> / <sub>2</sub> , 2' <sup>1</sup> / <sub>2</sub> , 4'
6"	3', 17', 36', 58'
8"	4', 23', 47', 113'
12"	16', 32', 67', 161'
16"	21', 42', 87', 209'
24"	30', 60', 125', 301'

NOTES:

- RESTRAINT JOINT LENGTHS BASED ON THE FOLLOWING CONDITIONS:  
(LAYING CONDITION BASED ON DRY ST. TRENCH & PIPE BEDDING DETAIL;  
TYPE S) LAYING CONDITION, 15° S.

SOL. DESIGNATION: CSDH-GRAIN  
DEPTH OF COVER: 12.5 FT.  
DESIGN PRESSURE: 200 PSI  
SAFETY FACTOR: 1.5

- RESTRAINT JOINT LENGTH SHALL BE VERIFIED BY A LICENSED ENGINEER BASED ON SPECIFIC PROJECT CONDITIONS.

- FOR PIPE 30" DIAMETER AND GREATER OR A MATERIAL OTHER THAN DUCTILE IRON, RESTRAINT JOINT LENGTHS SHALL BE MADE ON A PRODUCT SPECIFIC BASIS.

- LIMITS OF JOINT RESTRAINT SHALL BE SHOWN IN PROFILE FOR ALL PROPOSED WATER MAIN PROJECTS.

THE MINIMUM RESTRAINT LENGTH BASED ON A DEAD END CONFIGURATION ASSUMING EACH BRANCH HAS A VALVE END TO THE FITTING.

- & IF SUFFICIENT PIPE LENGTH IS NOT AVAILABLE FOR JOINT RESTRAINT, THRUST STOPPING MUST BE PROVIDED.

<b>DEAD ENDS</b>	
PIPE DIAMETER	RESTRAINED LENGTH
3" OR 4"	42"
6"	59"
8"	79"
12"	113"
16"	147"
24"	213"

<b>VERT. BENDS (UP)</b>	
PIPE DIAMETER	RESTRAINED LENGTH EACH BRANCH
3" OR 4"	4", 8", 10"
6"	3', 6', 11', 27"
8"	4', 7', 15', 35"
12"	5', 10', 21', 50"
16"	7', 13', 27', 64"
24"	9', 16', 38', 91"

<b>REDUCERS</b>	
PIPE DIAMETER	RESTRAINED LENGTH
LARGE END	SMALL END
12"	3"
16"	3"
16"	3" OR 4"
16"	6"
16"	12"
24"	3" OR 4"
24"	6"
24"	12"
24"	16"
24"	18"
24"	12"
24"	16"


<b>RESTRAINT LENGTH ALONG LARGER PIPE</b>	
16"	3" OR 4"
16"	6"
16"	12"
24"	3" OR 4"
24"	6"
24"	12"
24"	16"
24"	18"
24"	12"
24"	16"

<b>TEES, WYES, CROSSES</b>	
BRANCH DIAMETER	RESTRAINED LENGTH EACH BRANCH
3" OR 4"	42"
6"	59"
8"	79"
12"	113"
16"	147"
24"	213"

<b>REVISION</b>	
DATE	DESCRIPTION
04/02/20	

JOINT RESTRAINT TABLES

DPU DWG. NO.  
**W-10**

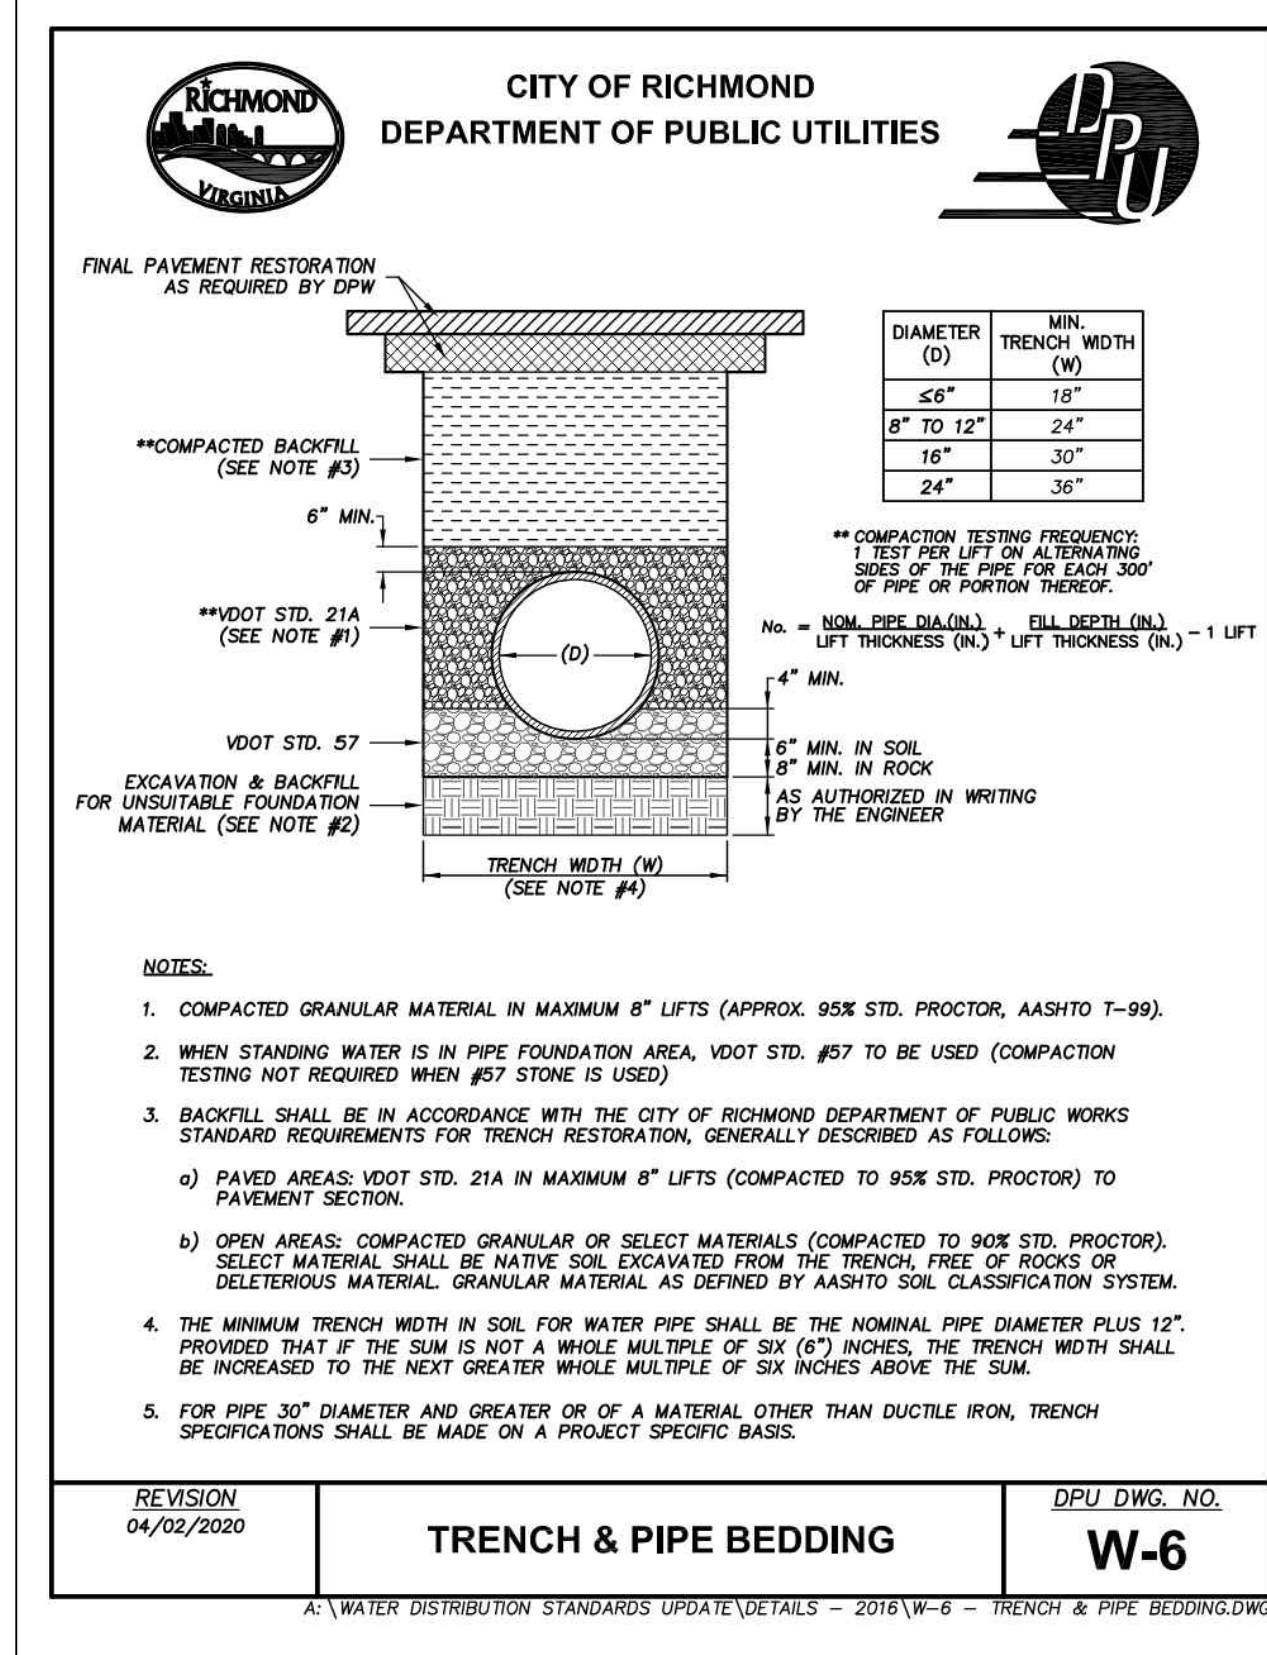

# CITY OF RICHMOND DEPARTMENT OF PUBLIC UTILITIES

- ALL WATER CONSTRUCTION AND MATERIALS SHALL BE IN ACCORDANCE WITH THE CITY OF RICHMOND WATER DISTRIBUTION SYSTEM DESIGN GUIDELINES AND STANDARD SPECIFICATIONS AND DETAILS.
- THE CONTRACTOR IS RESPONSIBLE FOR OBTAINING ALL REQUIRED PERMITS FOR THE WORK. WATER UTILITY PERMITS WILL BE ISSUED BY THE DEPARTMENT OF PUBLIC UTILITIES DEVELOPMENT SERVICES OFFICE LOCATED IN ROOM 115 IN CITY HALL.
- ONCE ALL PERMITS AND FEES HAVE BEEN SUBMITTED AND APPROVED THROUGH THE DPU DEVELOPMENT SERVICES DEPARTMENT, THE CONTRACTOR SHALL CONTACT THE DPU CONSTRUCTION INSPECTOR AT (804) 446-8337 TO SCHEDULE A PRE-CONSTRUCTION MEETING AT LEAST 72 HOURS PRIOR TO BEGINNING ANY WATER RELATED CONSTRUCTION ACTIVITY.
- FINAL ACCEPTANCE OF THE WATER UTILITY IMPROVEMENTS BY THE CITY OF RICHMOND DEPARTMENT OF PUBLIC UTILITY SHALL NOT BE UNTIL 48 HOURS AFTER ALL WORK SHOWN ON THE APPROVED UTILITY PLANS IS COMPLETE, INCLUDING ALL PIPELINE WORK, PAVING, GRADING, AND ANY NECESSARY ACCESSORIES.
- THE CONTRACTOR MUST PROVIDE AS-BUILTS WITH REQUESTS INFORMATION DEFINING THE HORIZONTAL AND VERTICAL LOCATION OF ALL PROPOSED MAINS, SERVICES, AND APPURTENANCES WITH THE TO RIGHT-WAY. ANY IMPROVEMENT LINES, OR ALTERNATE OBJECTS AS NEEDED TO LOCATE THE MAINS IN THE FIELD. THE IMPROVEMENTS WILL NOT BE ACCEPTED UNTIL THE AS-BUILT INFORMATION HAS BEEN REVIEWED AND ACCEPTED BY THE CITY WATER UTILITY INSPECTOR.
- THE CONTRACTOR SHALL NOT OPERATE ANY EXISTING VALVES AND MUST REQUEST VALVE OPERATION BY CITY FORCES NO LESS THAN 48 HOURS IN ADVANCE OF ANY PLANNED WORK.
- UNLESS OTHERWISE NOTED ON THE PLANS, THE MINIMUM COVER FOR WATER MAINS IS 42 INCHES.
- WATER FOR USE BY THE CONTRACTOR FROM A PUBLIC WATER MAIN OR HYDRANT WITHIN THE CITY OF RICHMOND SHALL REQUIRE A CITY ISSUED PORTABLE WATER MAIN BACKFLOW DEVICE. THE CONTRACTOR SHOULD CONTACT THE UTILITY CROSS CONNECTION SPECIALIST LOCATED AT 400 JEFFERSON DAVIS HIGHWAY (RM 143), TUESDAY THROUGH FRIDAY (9 A.M. TO 11 A.M.) TO MAKE AN APPLICATION. THE CONTRACTOR MAY CALL (804) 446-8002 FOR ANY QUESTIONS RELATED TO THIS PROGRAM.
- ALL WATER PIPE USED WITHIN THE CITY'S DISTRIBUTION SYSTEM SHALL BE DUCTILE-IRON, EXCEPT THE REQUIREMENTS FOR THE FOLLOWING:
  - FOR ALL TEST RIGS WITHIN MECHANICAL AND ELECTRICAL WORK AREAS, PUSH-ON JOINTS. THE PIPE SHALL BE ASPHALTIC COAT OUTSIDE AND CEMENT-NEUTRAL INSIDE. COAT-ON INSIDE SHALL BE 10 MILS. COAT-ON OUTSIDE SHALL BE 10 MILS. MINIMUM LENGTHS OF 10 FT. AND 20 FEET SHALL BE MAINTAINED WITH JOINTS. MATERIALS ALL PIPE MUST MEET THE MINIMUM THICKNESS CLASS AS LISTED BELOW.


DIAMETER (IN.)	MIN. THICKNESS CLASS
3	54
4	54
6	54
8	54
12 & LARGER	51

DPU DESIGN NO.

**W-4**

## GENERAL WATER CONSTRUCTION NOTES

A: WATER DISTRIBUTION STANDARDS UPDATE DETAILS – 2016 W-4 – GENERAL CONSTRUCTION NOTES.DWG

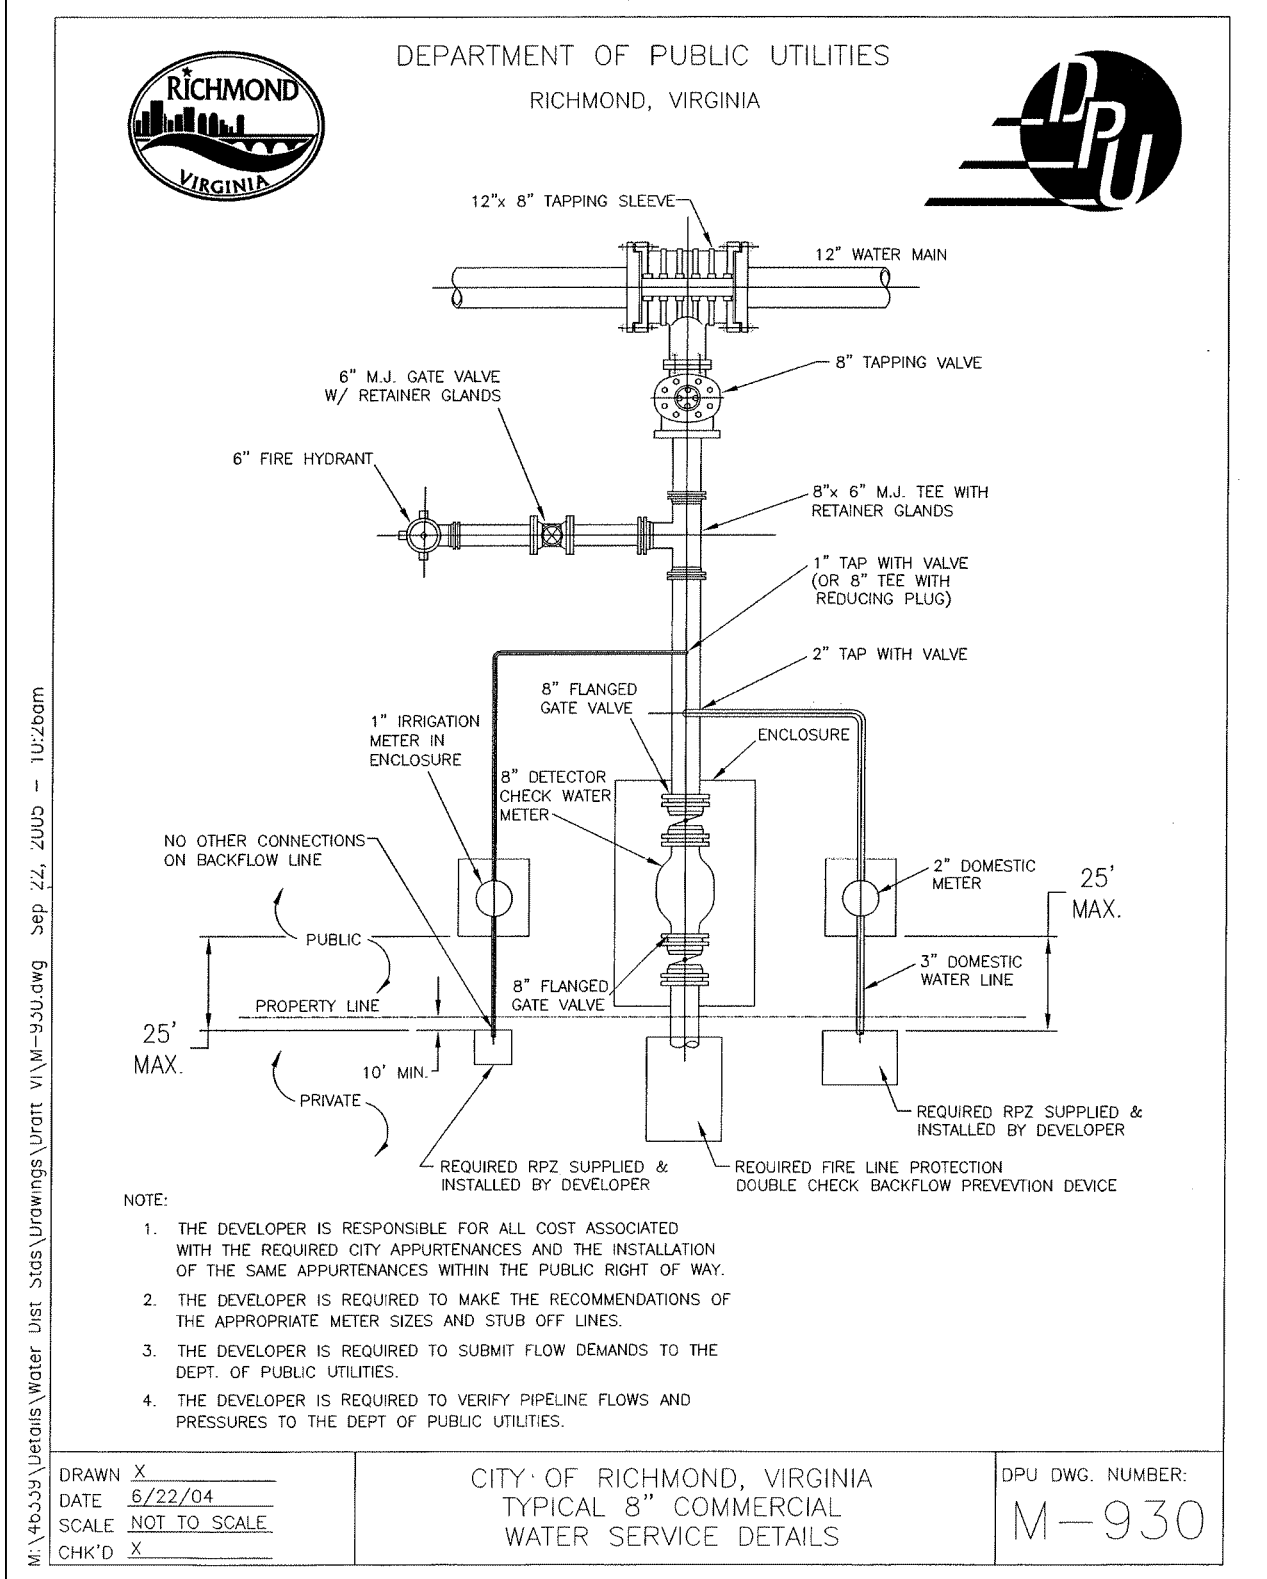

CITY OF RICHMOND DEPARTMENT OF PUBLIC UTILITIES TYPICAL INSTALLATION PROCEDURES		
<p>1. REFER TO ALL APPLICABLE CODES AND MANUALS DURING DESIGN.</p> <p>2. THE BFP ASSEMBLY'S SHUTOFF VALVES SHALL BE THE ONES APPROVED BY THE MANUFACTURER FOR THAT BFP ASSEMBLY.</p> <p>3. SUBMIT PLANS SEALED AND SIGNED BY A PROFESSIONAL ENGINEER TO CROSS CONNECTION DEPT.</p> <p>4. APPLY FOR A PLUMBING PERMIT FROM BUILDING INSPECTIONS OFFICE.</p> <p>5. APPLY FOR A WATER SERVICE PERMIT FROM DPU DEVELOPMENT OFFICE.</p> <p>6. INSTALL PIPING AND BACKFLOW PREVENTER, INCLUDING TEST COCKS ADAPTERS – (4) STRAIGHT HOSE ADAPTER FITTINGS, 1/4" S.A.E. 45° FLARE TUBE X 1/4" NPT, FOR CONNECTION TO TEST DEVICE. BACKFLOW PREVENTION DEVICES WILL BE INSTALLED OUTSIDE (OR INSIDE OF A BUILDING WITH APPROVAL OF THE CROSS CONNECTION SPECIALIST). REFER TO PLANS FOR TYPICAL INSTALLATION DETAILS. NO TAP-INS WILL BE PERMITTED FOR ANY PURPOSE UPSTREAM OF THE BACKFLOW PREVENTION DEVICE.</p> <p>7. CALL CROSS CONNECTION CONTROL SPECIALIST FOR INSPECTION OF THE BACKFLOW PREVENTER. INSPECTION AND APPROVAL IS REQUIRED BEFORE ANY METER WILL BE INSTALLED. [804-646-8544]</p> <p>8. CALL PLUMBING INSPECTOR FOR INSPECTION OF ALL PIPING AND PLUMBING WORK DOWNSTREAM OF THE METER. CALL MECHANICAL INSPECTOR FOR INSPECTION OF ALL WORK DOWNSTREAM OF THE DETECTOR CHECK METER.</p>		
DATE APR. 2006		DWG. NO. RP2-IP
REVISIONS SEP. 2014		
TYPICAL INSTALLATION PROCEDURES		

