



04 Transverse Section - Steel Beams.

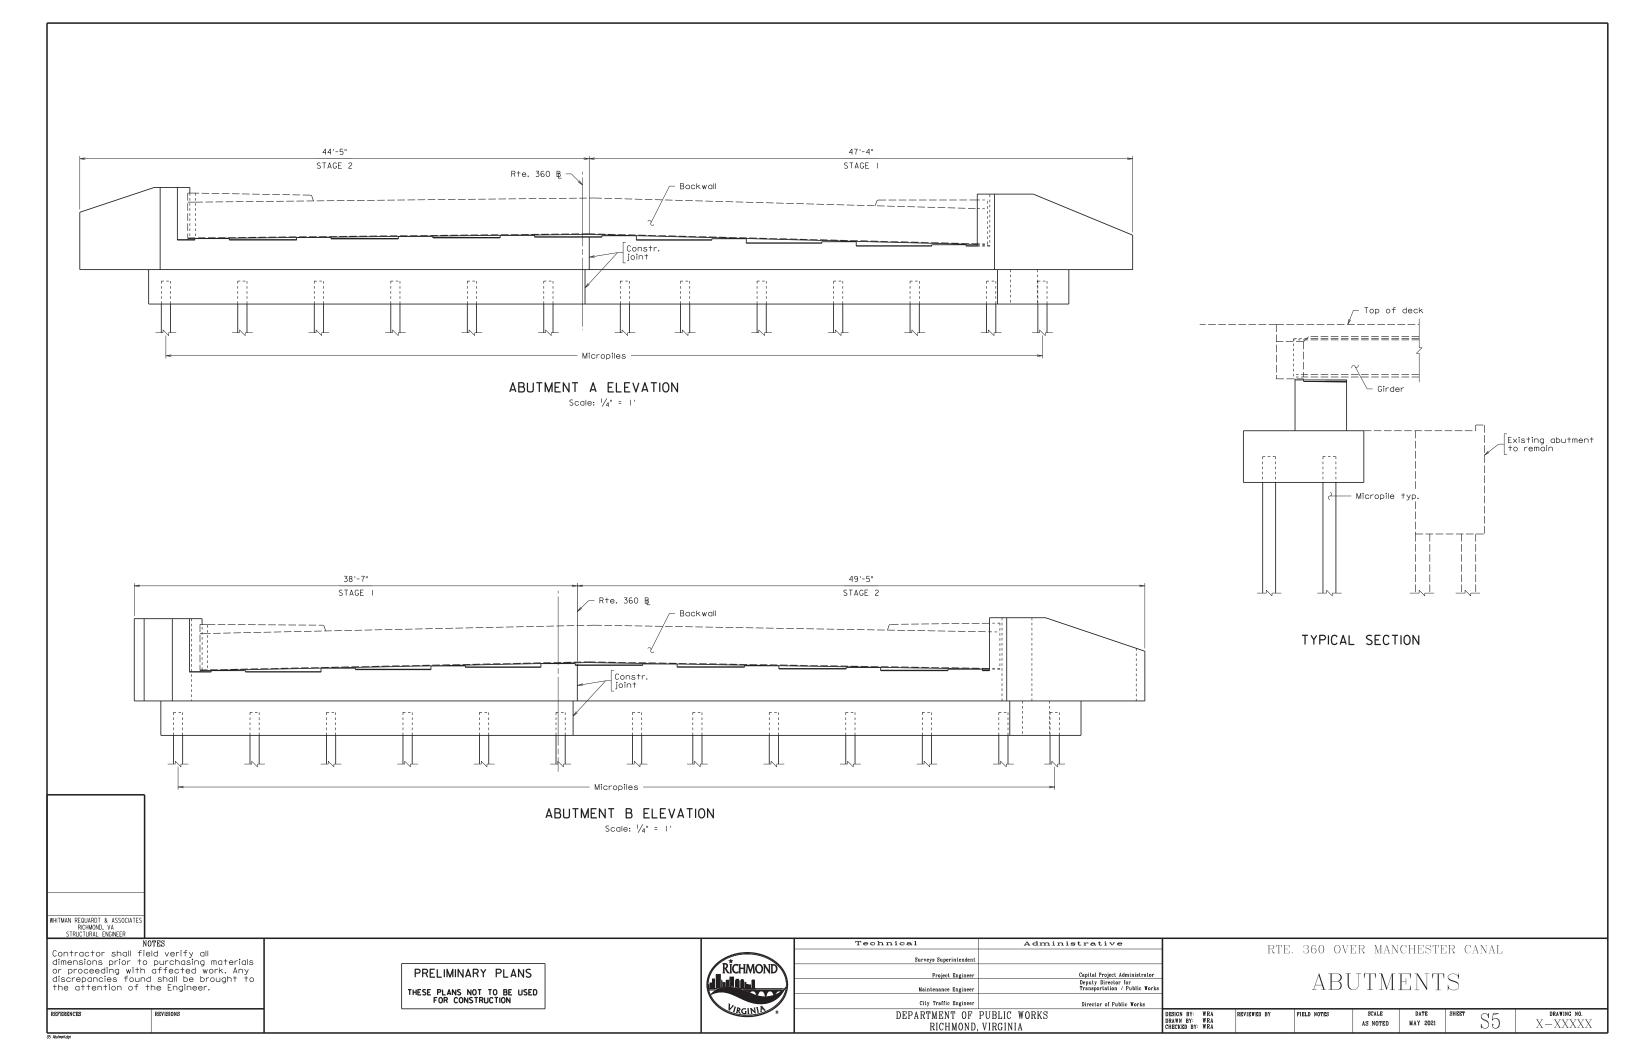

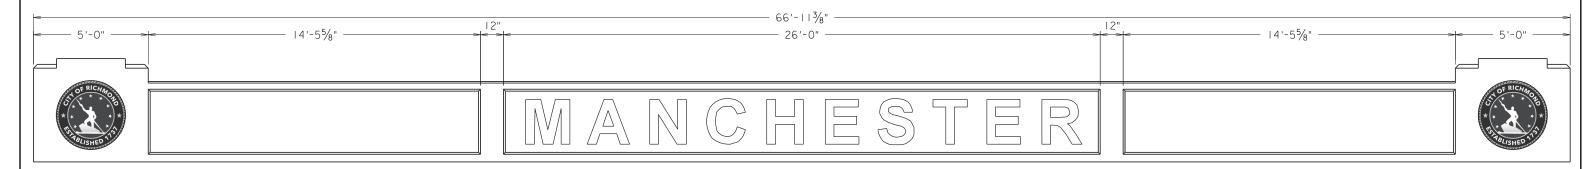

#### **ELEVATION**

Scale: 1/2" = 1'


# From Virtual Public Engagement (APR 2022):

End Treatment (City Seal) = 7

End Treatment (Alt #1) = 1


End Treatment (Alt #2) = 0

No Responses = 10

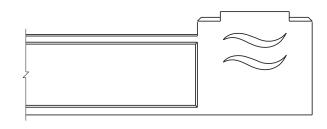

### END ALTERNATIVE #1

Scale: 1/2" = 1'

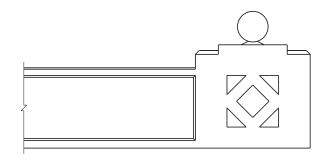

END ALTERNATIVE #2

Scale: 1/2" = 1'

WHITMAN REQUARDT & ASSOCIATE: RICHMOND, VA STRUCTURAL ENGINEER

NUTES

Contractor shall field verify all dimensions prior to purchasing materials or proceeding with affected work. Any discrepancies found shall be brought to the attention of the Engineer.

REPERENCES REVISIONS

PRELIMINARY PLANS
THESE PLANS NOT TO BE USED FOR CONSTRUCTION



Technical	Administrative	
Surveys Superintendent		
Project Engineer	Capital Project Administrator	
Maintenance Engineer	Deputy Director for Transportation / Public Works	1
City Traffic Engineer	Director of Public Works	1
DEPARTMENT OF	PUBLIC WORKS	DESIGN DRAWN
RICHMOND,	VIRGINIA	CHECK

RTE. 360 OVER MANCHESTER CANAL

CONCRETE BARRIER

DESIGN BY: WRA CHECKED BY: WRA CHECKED BY FIELD NOTES SCALE DATE SHEET S6 DRAWING NO.

AS NOTED MAY 2021 S6 X—XXXXX

STATION 11+50.94 TO STATION 13+00.55 STATION 13+62.83 TO STATION 14+97.96

FINAL TYPICAL SECTION TO BE COORDINATED WITH UPC 111703 AND POWER PLANT DEVELOPMENT

## PRIVATE AND COMMERCIAL ENTRANCES

NOT TO SCALE

TYPE I Crusher Run Aggr.

000000

6" Crusher Run Aggr. 25 or 26

TYPE III Asphalt

Asphalt Conc. Type SM-9.5A @ 220 Lbs. per S.Y. 4" Aggr. Base Mat'l. Ty. I No. 21B

Concrete

TYPE II

Concrete Entrance Pavement 7" HES 4" Aggr. Base Mat'l. Ty. I No. 21B


TYPE N

Asphalt Commercial

Asphalt Conc. Type SM-9.5A @ 165 Lbs. per S.Y. 4" Asphalt Conc. Base Course BM-25.0A 6" Aggr. Base Mat'l. Ty. I

The type of entrance (I, II, III, IV) to be constructed will be determined by the existing condition at the time of construction.

#### MANCHESTER ROAD

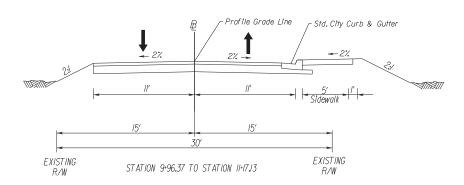

30% PLANS

THESE PLANS ARE UNFINISHED AND UNAPPROVED AND ARE NOT TO BE USED FOR ANY TYPE OF CONSTRUCTION OR THE ACQUISITION OF RIGHT OF WAY.

Administrative Brick Sidewa.
Castings Water Valve
Water Meter
Gas Drip
Gas Valve
Telephone Manhole
Blectric Manhole
C Curb Cut Re-Property owners correct as of RÎCHMOND 3. Ordinance Number City Traffic Engine Decorative Light Conduit Conduit (Conc. Encased) DESIGN BY: GGK DRAWN BY: AD CHECKED BY: MSV DEPARTMENT OF PUBLIC WORKS RICHMOND, VIRGINIA

RTE. 360 OVER MANCHESTER CANAL TYPICAL SECTIONS

1"-25' MAY 2021

X - XXXXX



Figure 1 - View from Floodwall

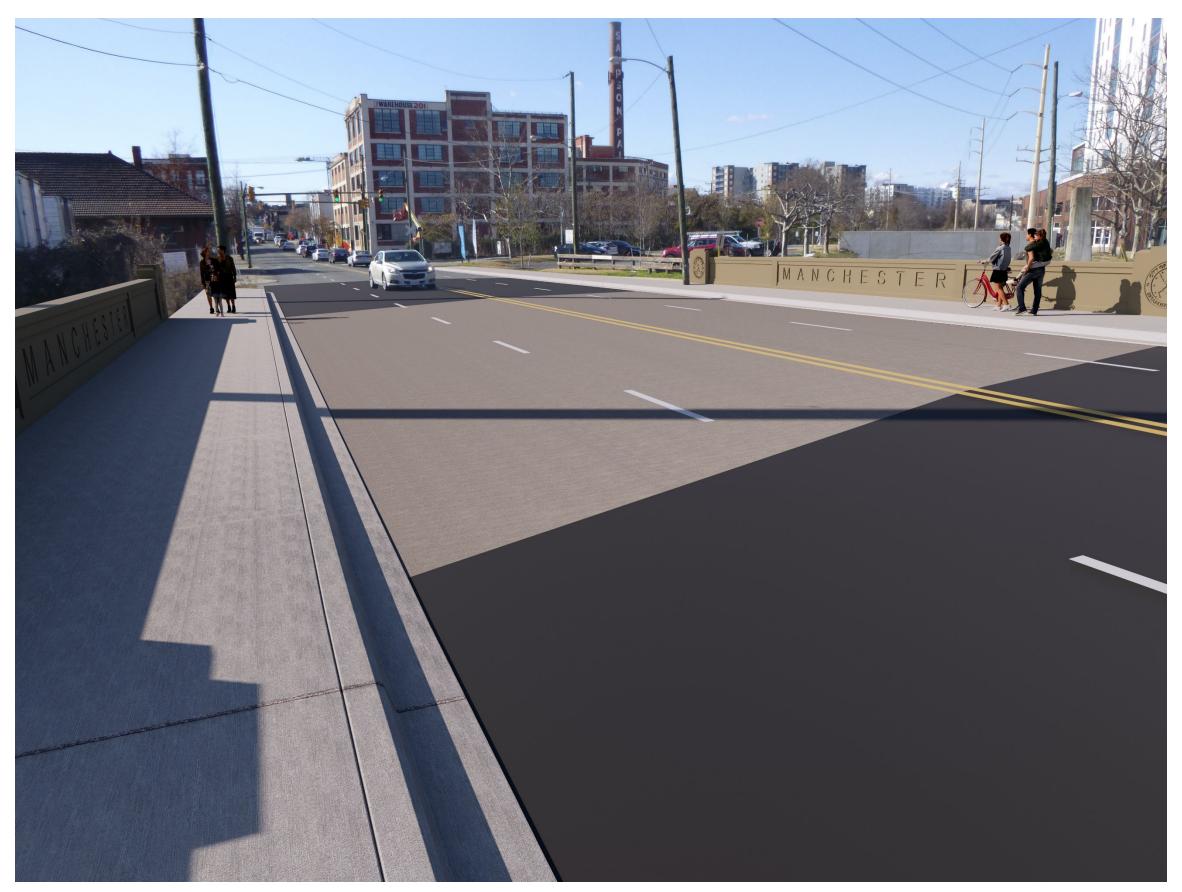


Figure 2 - View from Street level