

GENERAL NOTES

1.

OWNER/DEVELOPER:

PARK TILDEN, LLC

2756 E. BRIGSTOCK RD

MIDLOTHIAN, VA 23113

ATTN: ROBERT ENGLANDER

EMAIL: BOB@CATHFORDCONSULTING.COM

PHONE: 804.405.8787
2.

ENGINEER:

SEKIV SOLUTIONS

14207 POND CHASE PLACE

MIDLOTHIAN, VA 23113

ATTN: KEITH STANLEY

EMAIL: KSTANLEY@SEKIVSOLUTIONS.COM

PHONE: 804.363.0394
3.

PROPERTY ADDRESS:

3301 & 3303 PARK AVENUE

RICHMOND, VA 23221
4.

PROPERTY ZONING:

R-6 - SINGLE FAMILY ATTACHED RESIDENTIAL
5.

MAP REFERENCE NUMBER:

W0001518016 & W0001518017
6.

PROJECT SUMMARY:

THE PROJECT WILL CONSIST OF THE CONSTRUCTION OF A 4-UNIT SINGLE FAMILY ATTACHED DEVELOPMENT WITH A IN GARAGE PARKING
7.

EXISTING USE:

SINGLE FAMILY
8.

PROPOSED USE:

SINGLE FAMILY ATTACHED DWELLINGS
9.

ACREAGE:

TOTAL PARCEL ACREAGE: 0.16± ACRES

DISTURBED ACREAGE: 0.16± ACRES
10.

BUILDINGS:

4 - SINGLE FAMILY ATTACHED DWELLINGS

SQUARE FOOTAGE: TBD BY BUILDING PERMIT

HEIGHT: 45± FEET
11.

PARKING:

SINGLE FAMILY ATTACHED:

1 SPACE PER DWELLING UNIT

4 SPACES REQUIRED

TOTAL PROVIDED:


8 SPACES WITHIN RESIDENTIAL UNITS

BICYCLE PARKING

WITHIN RESIDENTIAL UNITS

PARK & TILDEN ROW HOUSES  
SPECIAL USE PERMIT PLAN

CITY OF RICHMOND, VIRGINIA

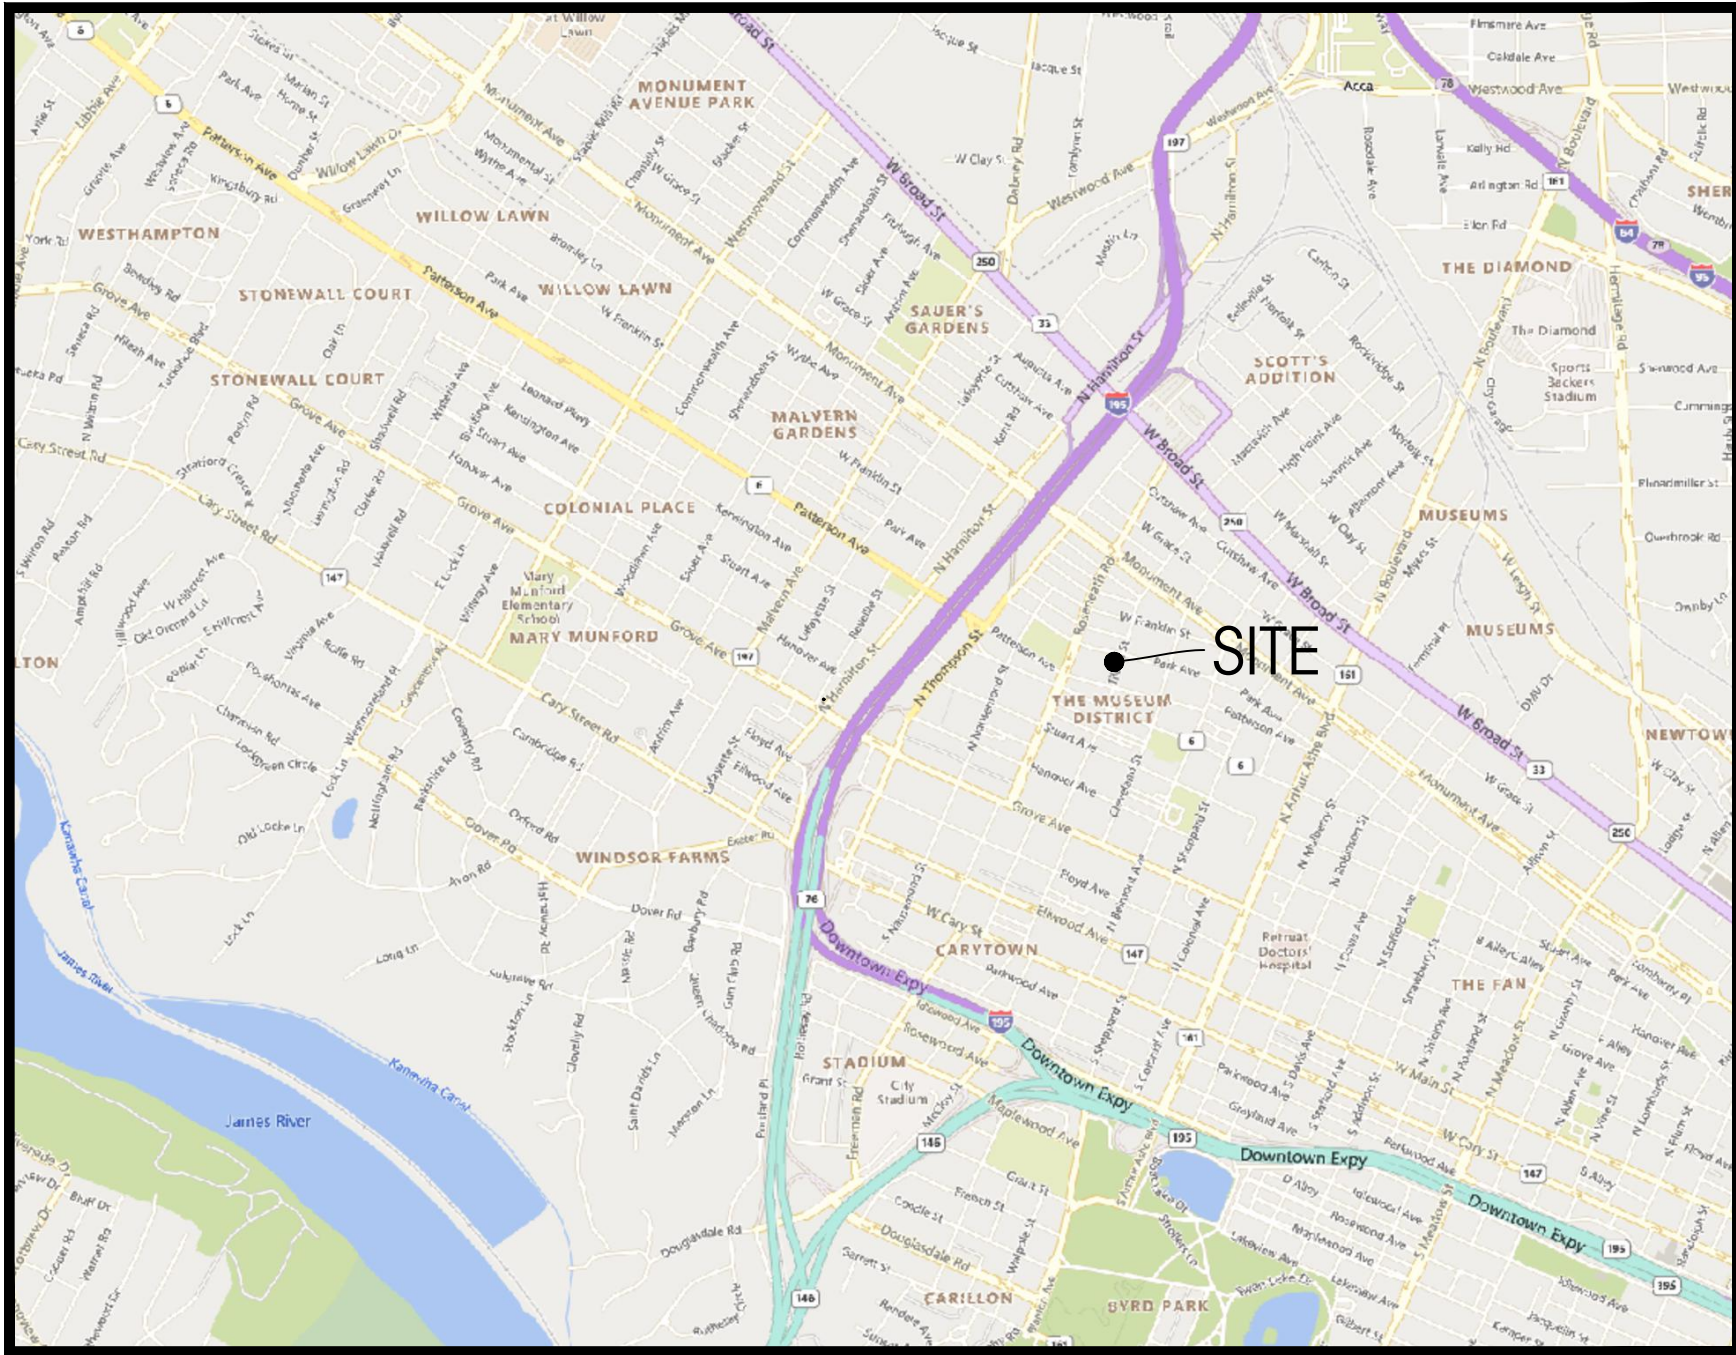


VICINITY MAP  
SCALE: 1" = 2000'

SOUTH ZONE (NAD83)

Sheet List Table	
Sheet Number	Sheet Title
C-001	COVER SHEET
C-101	EXISTING CONDITIONS AND DEMOLITION PLAN
C-102	LAYOUT AND UTILITY PLAN

REQUIRED PERMITS  
BUILDING PERMIT  
UTILITIES PERMIT  
LAND DISTURBANCE PERMIT  
TRADE PERMITS  
WORK IN STREET PERMIT

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TELEPHONE NO. 804.938.8864 | www.sekivsolutions.com

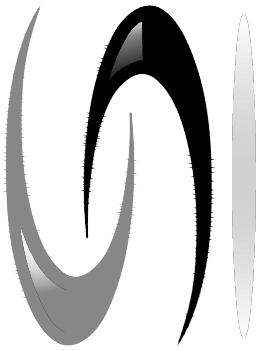

DATE : DECEMBER 17, 2021

REVISION BLOCK	
DATE	DESCRIPTION
MAR. 29, 2022	PER CITY COMMENT
SEPT. 1, 2022	PER CITY COMMENT
SEPT. 22, 2022	PER CITY PC RECOMMENDATION
NOV. 1, 2022	PER CITY PC RECOMMENDATION

Robert P. Englander Jr.  
CathFord Consulting, LLC  
2756 E. Bridgestock Rd.  
Midlothian, VA 23113  
804.405.8787  
bob@cathfordconsulting.com

**PARK & TILDEN  
ROW HOUSES**  
CITY OF RICHMOND, VA

COVER SHEET

SHEET NO.

C-001


PROJECT MANAGER : K. STANLEY

PROJECT NO. : 10548


SCALE : AS SHOWN

QUALITY ASSURANCE : S. OWENS



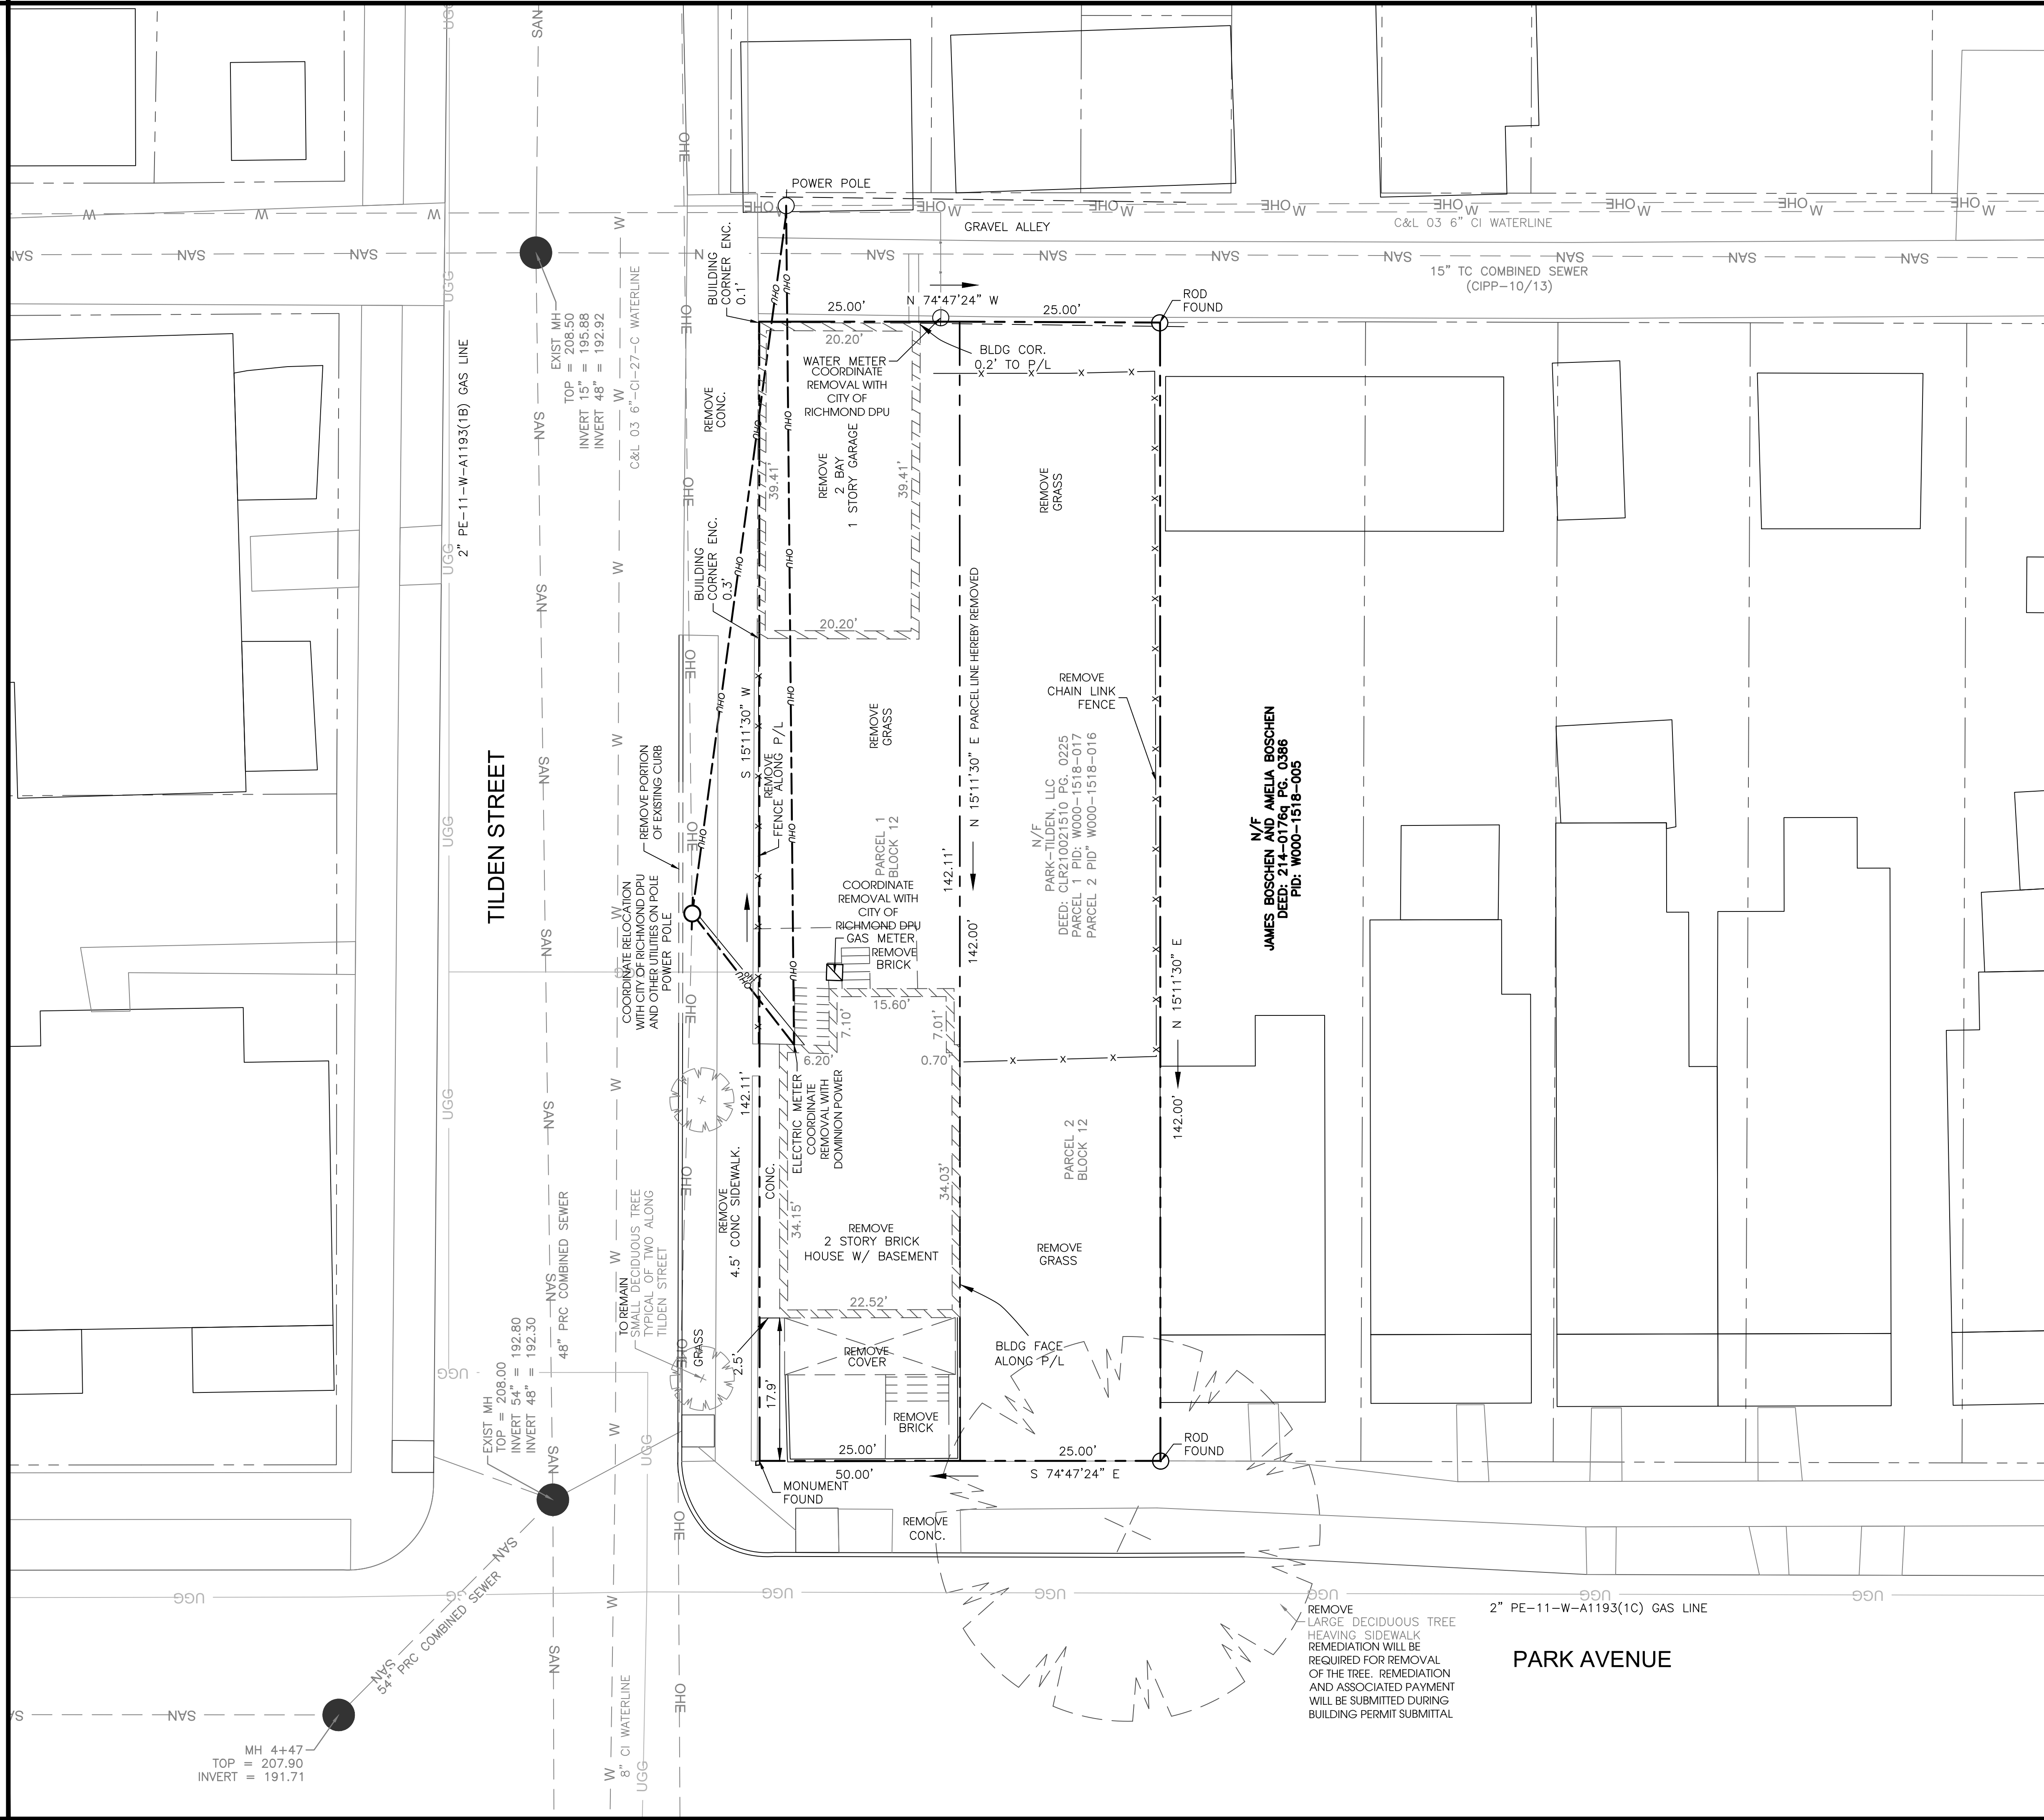

- DEMOLITION AND E&S NOTES:**
1. A PRE-CONSTRUCTION CONFERENCE IS MANDATORY BEFORE ANY WORK IS DONE AT THE SITE. ARRANGE A MEETING WITH THE CONTRACTOR, OWNER, ENGINEER AND THE CITY INSPECTOR (OR AUTHORIZED REPRESENTATIVE). THE OWNER MUST GIVE THE CITY INSPECTOR 72 HOURS NOTIFICATION TO SCHEDULE AN ON-SITE PRE-CONSTRUCTION MEETING.
  2. POST PERMITS ON SITE.
  3. AT THE TIME OF THE PRE-CONSTRUCTION MEETING, TWO STANDARD SIGNS MUST BE INSTALLED ON EACH SIDE OF THE CONSTRUCTION ACCESS. THESE SIGNS MAY BE INSTALLED ON TRIPOD DEVICES AND SHOULD STATE EITHER "CONSTRUCTION ENTRANCE AHEAD" OR "TRUCKS ENTERING HIGHWAY".
  4. INSTALL CONSTRUCTION ENTRANCE AND SILT FENCE AS SHOWN ON THE EROSION AND SEDIMENT CONTROL PLAN.
  5. DISTURB ONLY THE PORTION OF THE SITE NEEDED TO INSTALL PERIMETER EROSION CONTROL DEVICES IN ACCORDANCE WITH REGULATIONS IN THE VA E&S HANDBOOK. DISTURBANCE OUTSIDE OF THE PRELIMINARY LIMITS OF DISTURBANCE IS NOT ALLOWED UNTIL ALL PERIMETER MEASURES ARE INSTALLED, FUNCTIONING, AND INSPECTED.
  6. THE CONTRACTOR IS TO COORDINATE WITH THE OWNER AND ALL UTILITY PROVIDERS INCLUDING BUT NOT LIMITED TO CITY OF RICHMOND DEPARTMENT OF PUBLIC UTILITIES (GAS, SEWER AND WATER), DOMINION ENERGY, AND CABLE, DATA, AND TELEPHONE PROVIDERS TO DISCONNECT ALL UTILITY SERVICES AT THE PROJECT SITE. ALL UTILITY DISCONNECTS ARE TO BE IN CONFORMANCE WITH CITY OF RICHMOND AND UTILITY PROVIDER STANDARDS.
  7. BEGIN BUILDING DEMOLITION.
  8. BEGIN REMOVAL OF ANY RETAINING WALLS AND STAIRS. CONTRACTOR SHALL TRANSITION GRADE BACK AT A MAXIMUM 2H:1V TO TIE INTO EXISTING GROUND AND IMMEDIATELY STABILIZE SLOPE WITH TEMPORARY SEEDING IN ACCORDANCE WITH THE VIRGINIA EROSION AND SEDIMENT CONTROL HANDBOOK.
  9. PLAN SHOWS APPROXIMATE LOCATION OF SANITARY SEWER LATERALS. MISS UTILITY DID NOT LOCATE AND SITE SURVEYS COULD NOT LOCATE ANY EVIDENCE OF LATERAL NOR FIND ANY CLEANOUTS. IF LATERAL(S) ARE FOUND, REMOVE EXISTING SANITARY SEWER LATERALS UP TO THE PROPERTY LINE, CUT AND CAP AT PROPERTY LINE, AND AT MAIN IN ACCORDANCE WITH CITY OF RICHMOND DEPARTMENT OF PUBLIC UTILITY STANDARDS. CUTTING AND CAPPING THE SEWER LATERALS AT THE MAIN WILL BE PERFORMED BY THE CONTRACTOR VIA WORK IN STREET PERMIT WITH PUBLIC UTILITIES INSPECTIONS.
  10. PLAN SHOWS LOCATION OF WATER SERVICE WITH 8" METER PER SURVEY. REMOVE EXISTING WATER SERVICE LINES UP TO THE PROPERTY LINE, CUT AND CAP AT PROPERTY LINE. COORDINATE WITH THE CITY OF RICHMOND FOR ABANDONMENT AT THE MAIN. REMOVAL OF THE METER BOX AND CAPPING AT THE MAIN WILL BE PERFORMED BY THE CITY OF RICHMOND. CONTACT PUBLIC UTILITIES AT 804.646.8298/8337 TO COORDINATE THIS WORK.
  11. DUST PRODUCING OPERATIONS SHALL BE WETTED DOWN TO THE EXTENT NECESSARY TO CONTROL THE DUST.
  12. THE CONTRACTOR SHALL PROVIDE AND MAINTAIN EROSION CONTROL MEASURES AT ALL TIMES THROUGHOUT THE DURATION OF THE PROJECT TO PREVENT THE TRANSPORTATION OF ERODED MATERIAL OUTSIDE OF THE CONSTRUCTION LIMITS. TEMPORARY EROSION CONTROL MEASURES SHALL BE EMPLOYED UNTIL SUCH TIME AS THE PERMANENT EROSION CONTROL MEASURES HAVE BECOME ESTABLISHED. ENSURE THAT POSITIVE DRAINAGE IS MAINTAINED AND ALL DRAINAGE IS DIVERTED TO THE PERIMETER EROSION CONTROL MEASURES. ALL EROSION CONTROL MEASURES SHALL BE IN ACCORDANCE WITH THE MINIMUM STANDARDS SET FORTH IN THE LATEST EDITION OF THE VIRGINIA EROSION AND SEDIMENT CONTROL HANDBOOK.
  13. THE PLAN PROVIDED HEREIN IS THE ATTEMPT TO IDENTIFY ALL THE ELEMENTS REQUIRED FOR THE CONSTRUCTION OF THE DEVELOPMENT. HOWEVER, ELEMENTS NOT IDENTIFIED ON THE FIELD SURVEY OR ON RECORD DATA MAY BE ON SITE. IT IS THE CONTRACTOR'S RESPONSIBILITY TO FAMILIARIZE THEMSELVES WITH THE SITE AND DEMOLISH ALL ITEMS NECESSARY FOR THE CONSTRUCTION OF THE PROJECT. DEMOLITION SHALL INCLUDE COMPLETE BUILDING DEMOLITION INCLUDING BUT NOT LIMITED TO: UTILITY SERVICES, FOOTINGS AND FOUNDATIONS, EXTERIOR IMPROVEMENTS SUCH AS SCREEN WALLS AND FENCING, STORAGE RACKS, DEBRIS, TRASH, AND CONSTRUCTION REMNANTS. SITE IS TO BE LEFT CLEAN AND FREE OF CONSTRUCTION ACTIVITY OPERATIONS, VOIDS WHERE BUILDINGS WERE REMOVED ARE TO BE SEEDED BY CONTRACTOR TO ESTABLISH A NON-EROSIVE GROUND COVER CONDITION.

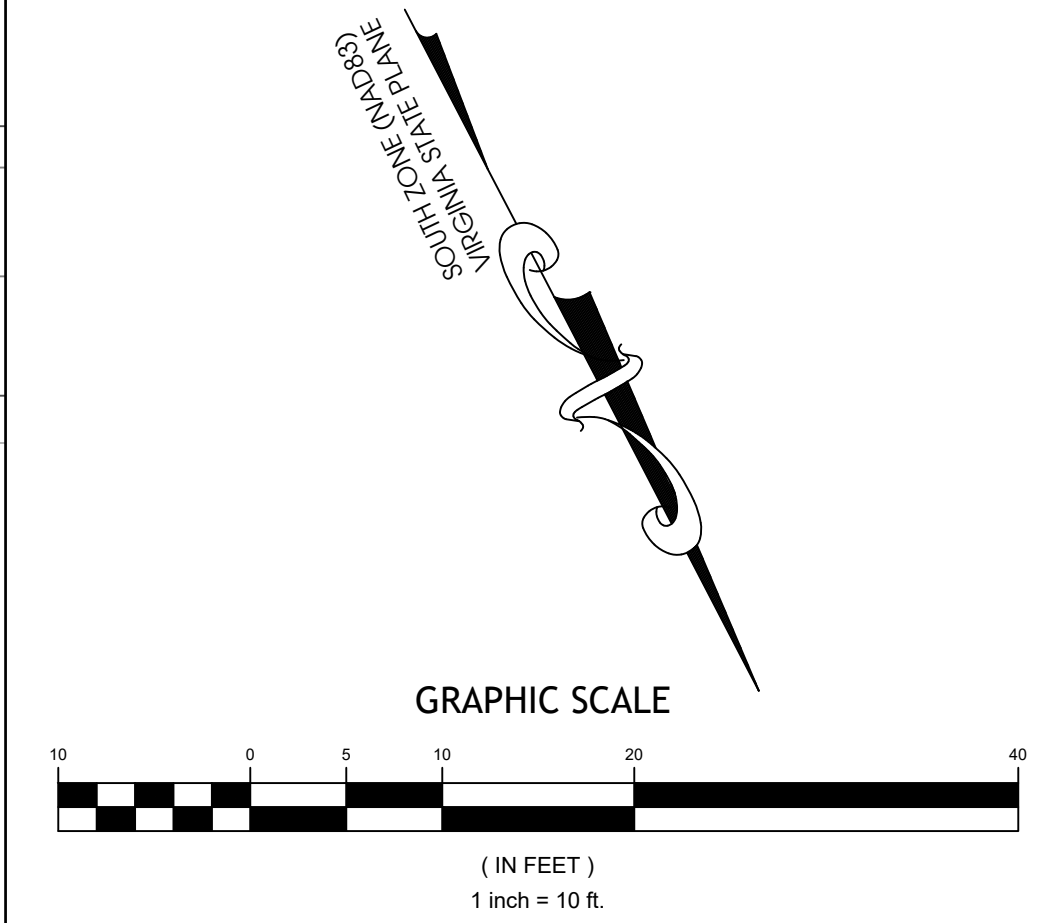

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**COMMONWEALTH OF VIRGINIA**  
Keith Stanley  
KEITH D. STANLEY  
Lic. No. 045811  
2022-11-01  
PROFESSIONAL ENGINEER

REVISION BLOCK	
DATE	DESCRIPTION
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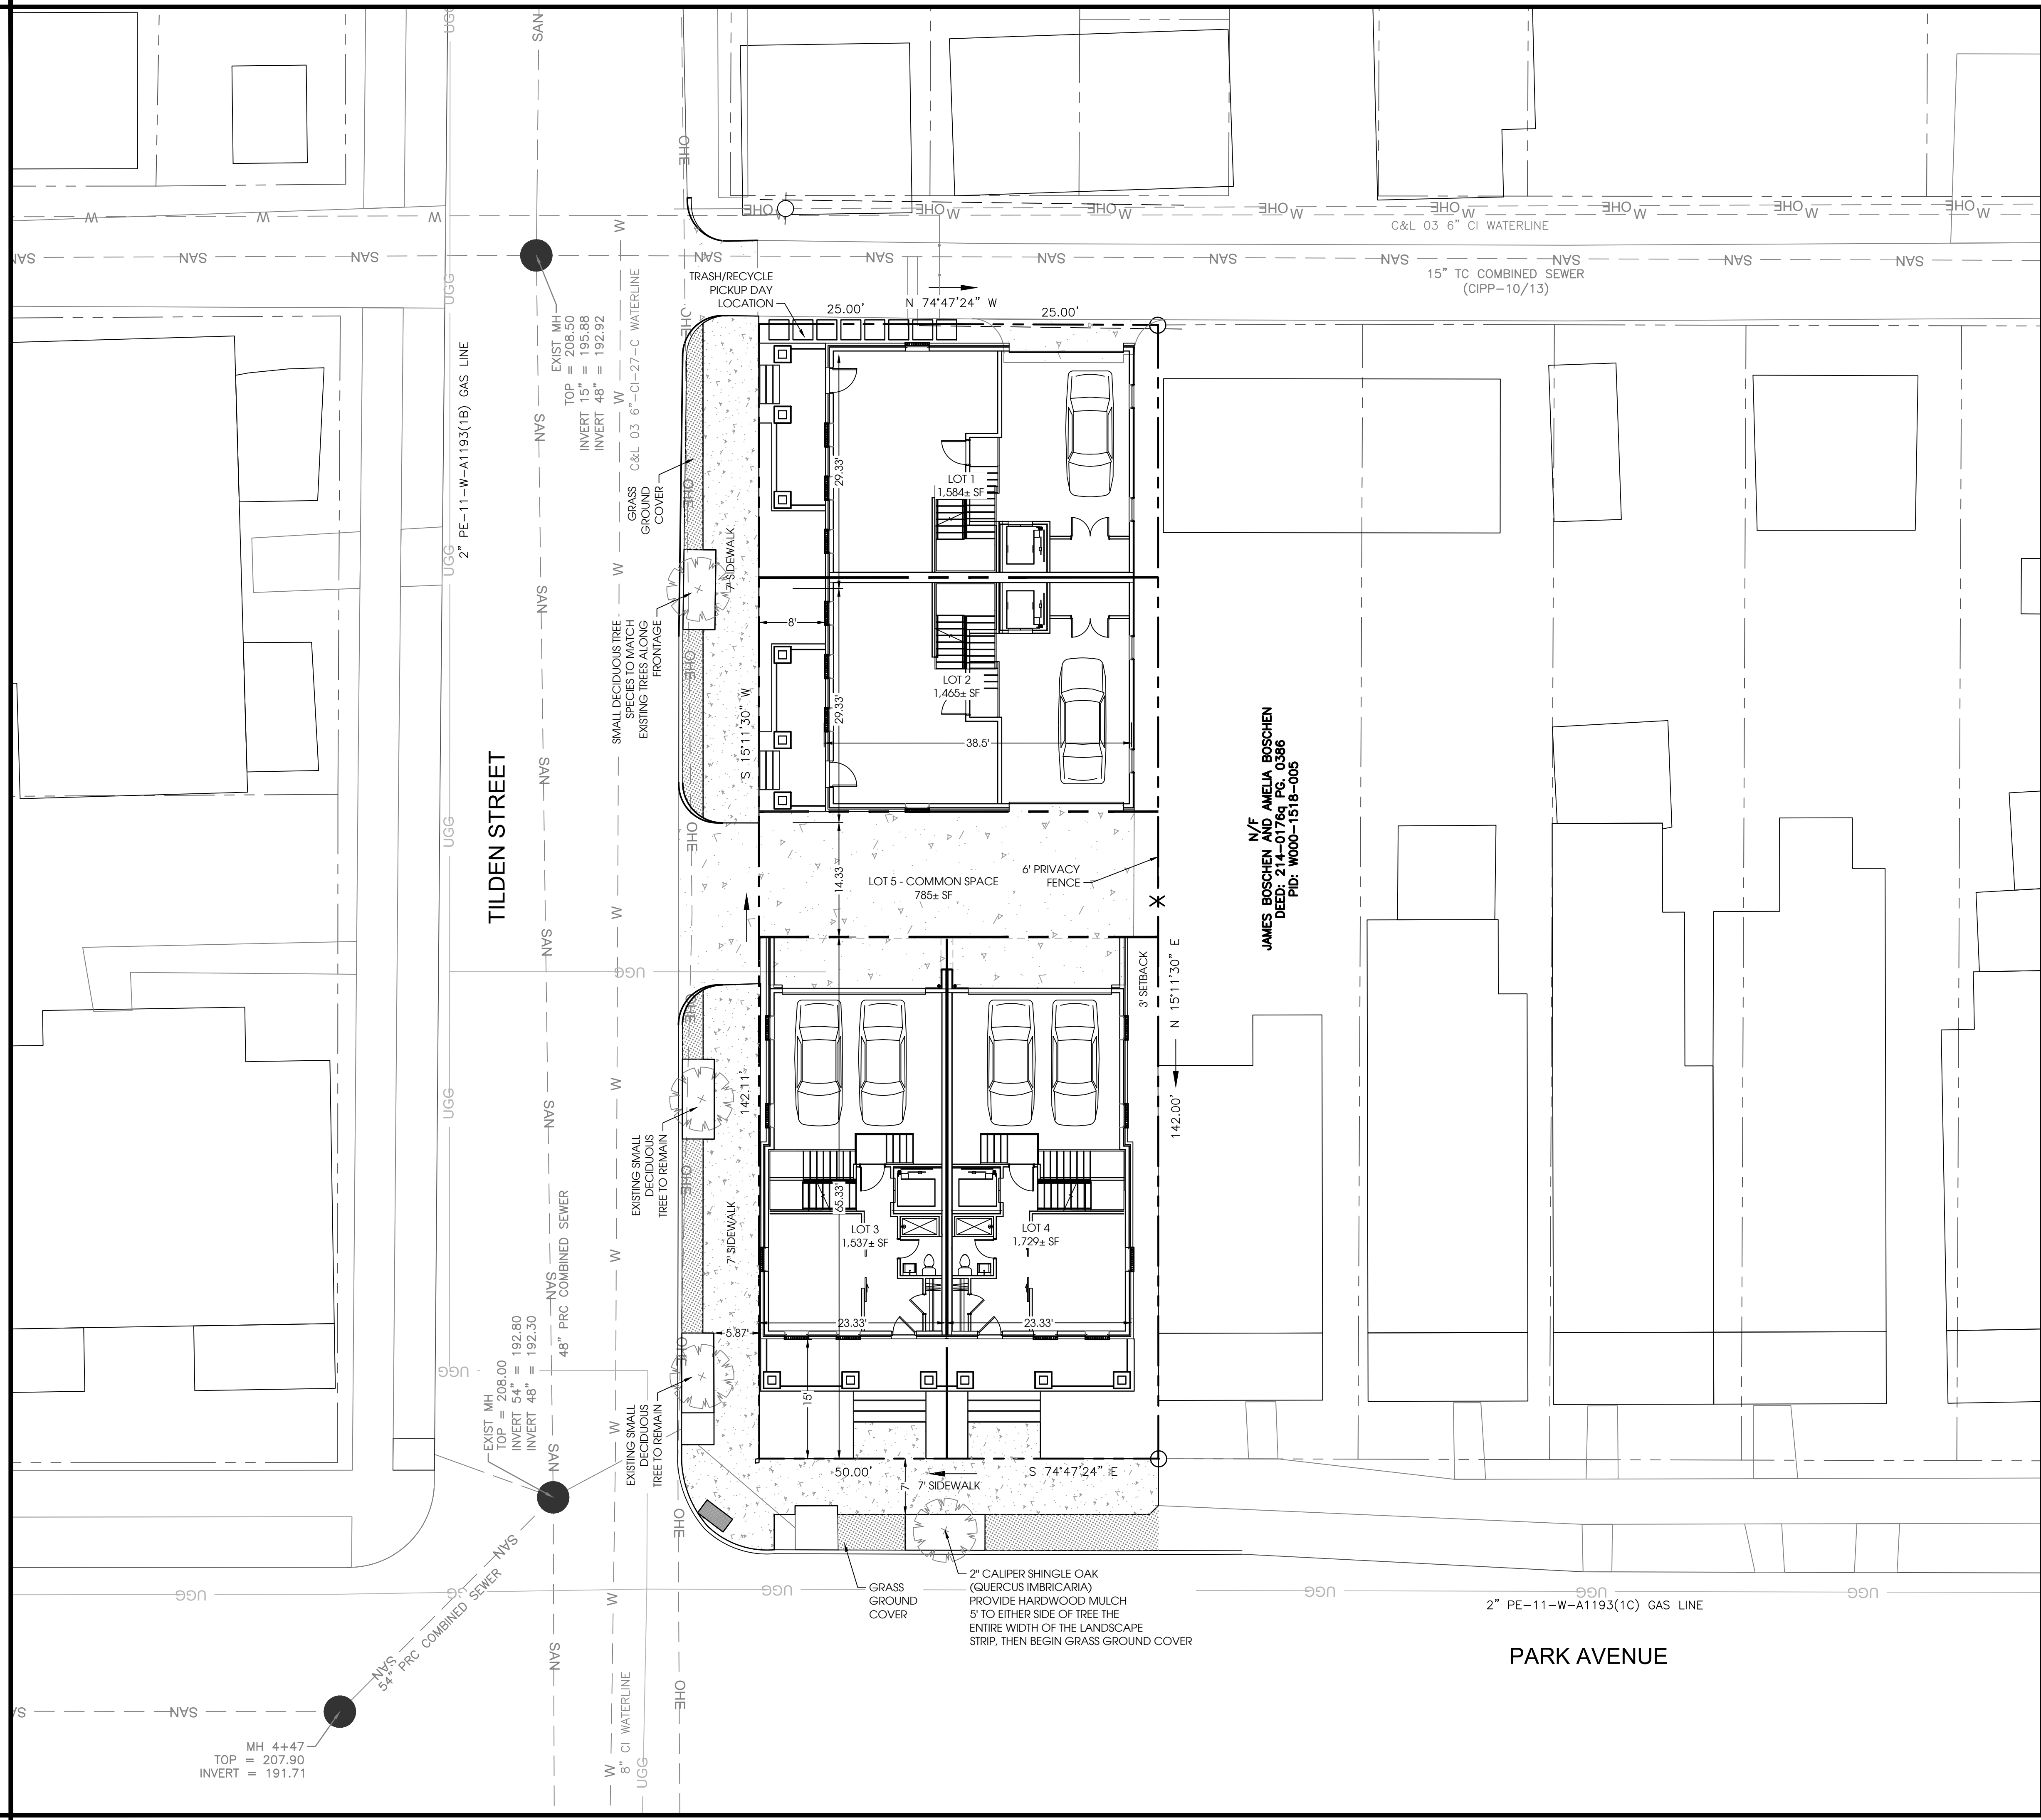
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**PARK & TILDEN  
ROW HOUSES**  
CITY OF RICHMOND, VA

**EXISTING  
CONDITIONS AND  
DEMOLITION PLAN**


SHEET NO.  
**C-101**

SCALE : AS SHOWN  
PROJECT NO. : 10548  
PROJECT MANAGER : K. STANLEY  
QUALITY ASSURANCE : S. OWENS



- NOTES**
1. BUILDING DIMENSIONS AND LOT SIZES ARE APPROXIMATE. DIMENSIONS MAY VARY AT TIME OF BUILDING PERMIT AND SUBDIVISION SUBMISSION
  2. WATER AND SEWER CONNECTION(S) WILL BE MADE IN TILDEN STREET AND BE DESIGNED IN ACCORDANCE WITH CITY OF RICHMOND DEPARTMENT OF PUBLIC UTILITIES STANDARDS
  3. REMEDIATION WILL BE REQUIRED FOR ALL TREES REMOVED WITHIN THE RIGHT OF WAY AT THE TIME OF BUILDING PERMIT SUBMISSION.
  4. NO AREA LIGHTING IS PROPOSED, ADJACENT STREET LIGHT PROVIDE ADEQUATE LIGHTING. POST LIGHTS MAY BE INSTALLED IN FRONT OF INDIVIDUAL UNITS AT TIME OF BUILDING PERMIT.
  5. BIKE STORAGE WILL BE WITHIN INDIVIDUAL UNITS
  6. WASTE/RECYCLING CONTAINER STORAGE WILL BE PROVIDED WITHIN GARAGE OF INDIVIDUAL UNITS AND PLACED IN ALLEY FOR PICK-UP
  7. ENTIRE SIDEWALK ALONG PROJECT FRONTAGE IS TO BE REPAIRED AND REPLACED TO SUPPORT STREETSCAPE.

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SCALE : AS SHOWN PROJECT NO. : 10548 PROJECT MANAGER : K. STANLEY QUALITY ASSURANCE : S. OWENS
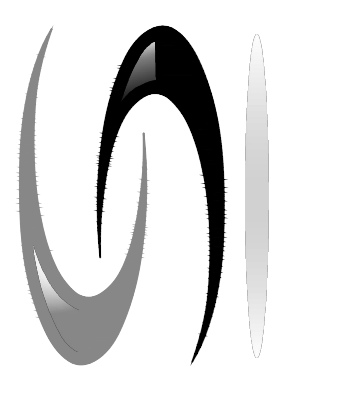
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**PARK & TILDEN  
ROW HOUSES**  
CITY OF RICHMOND, VA

**LAYOUT AND  
UTILITY PLAN**

SHEET NO.  
**C-102**





PERSPECTIVES

10.28.2022

PARK & TILDEN ROWHOUSES | NEW CONSTRUCTION

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PERSPECTIVES

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PERSPECTIVES


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PERSPECTIVES

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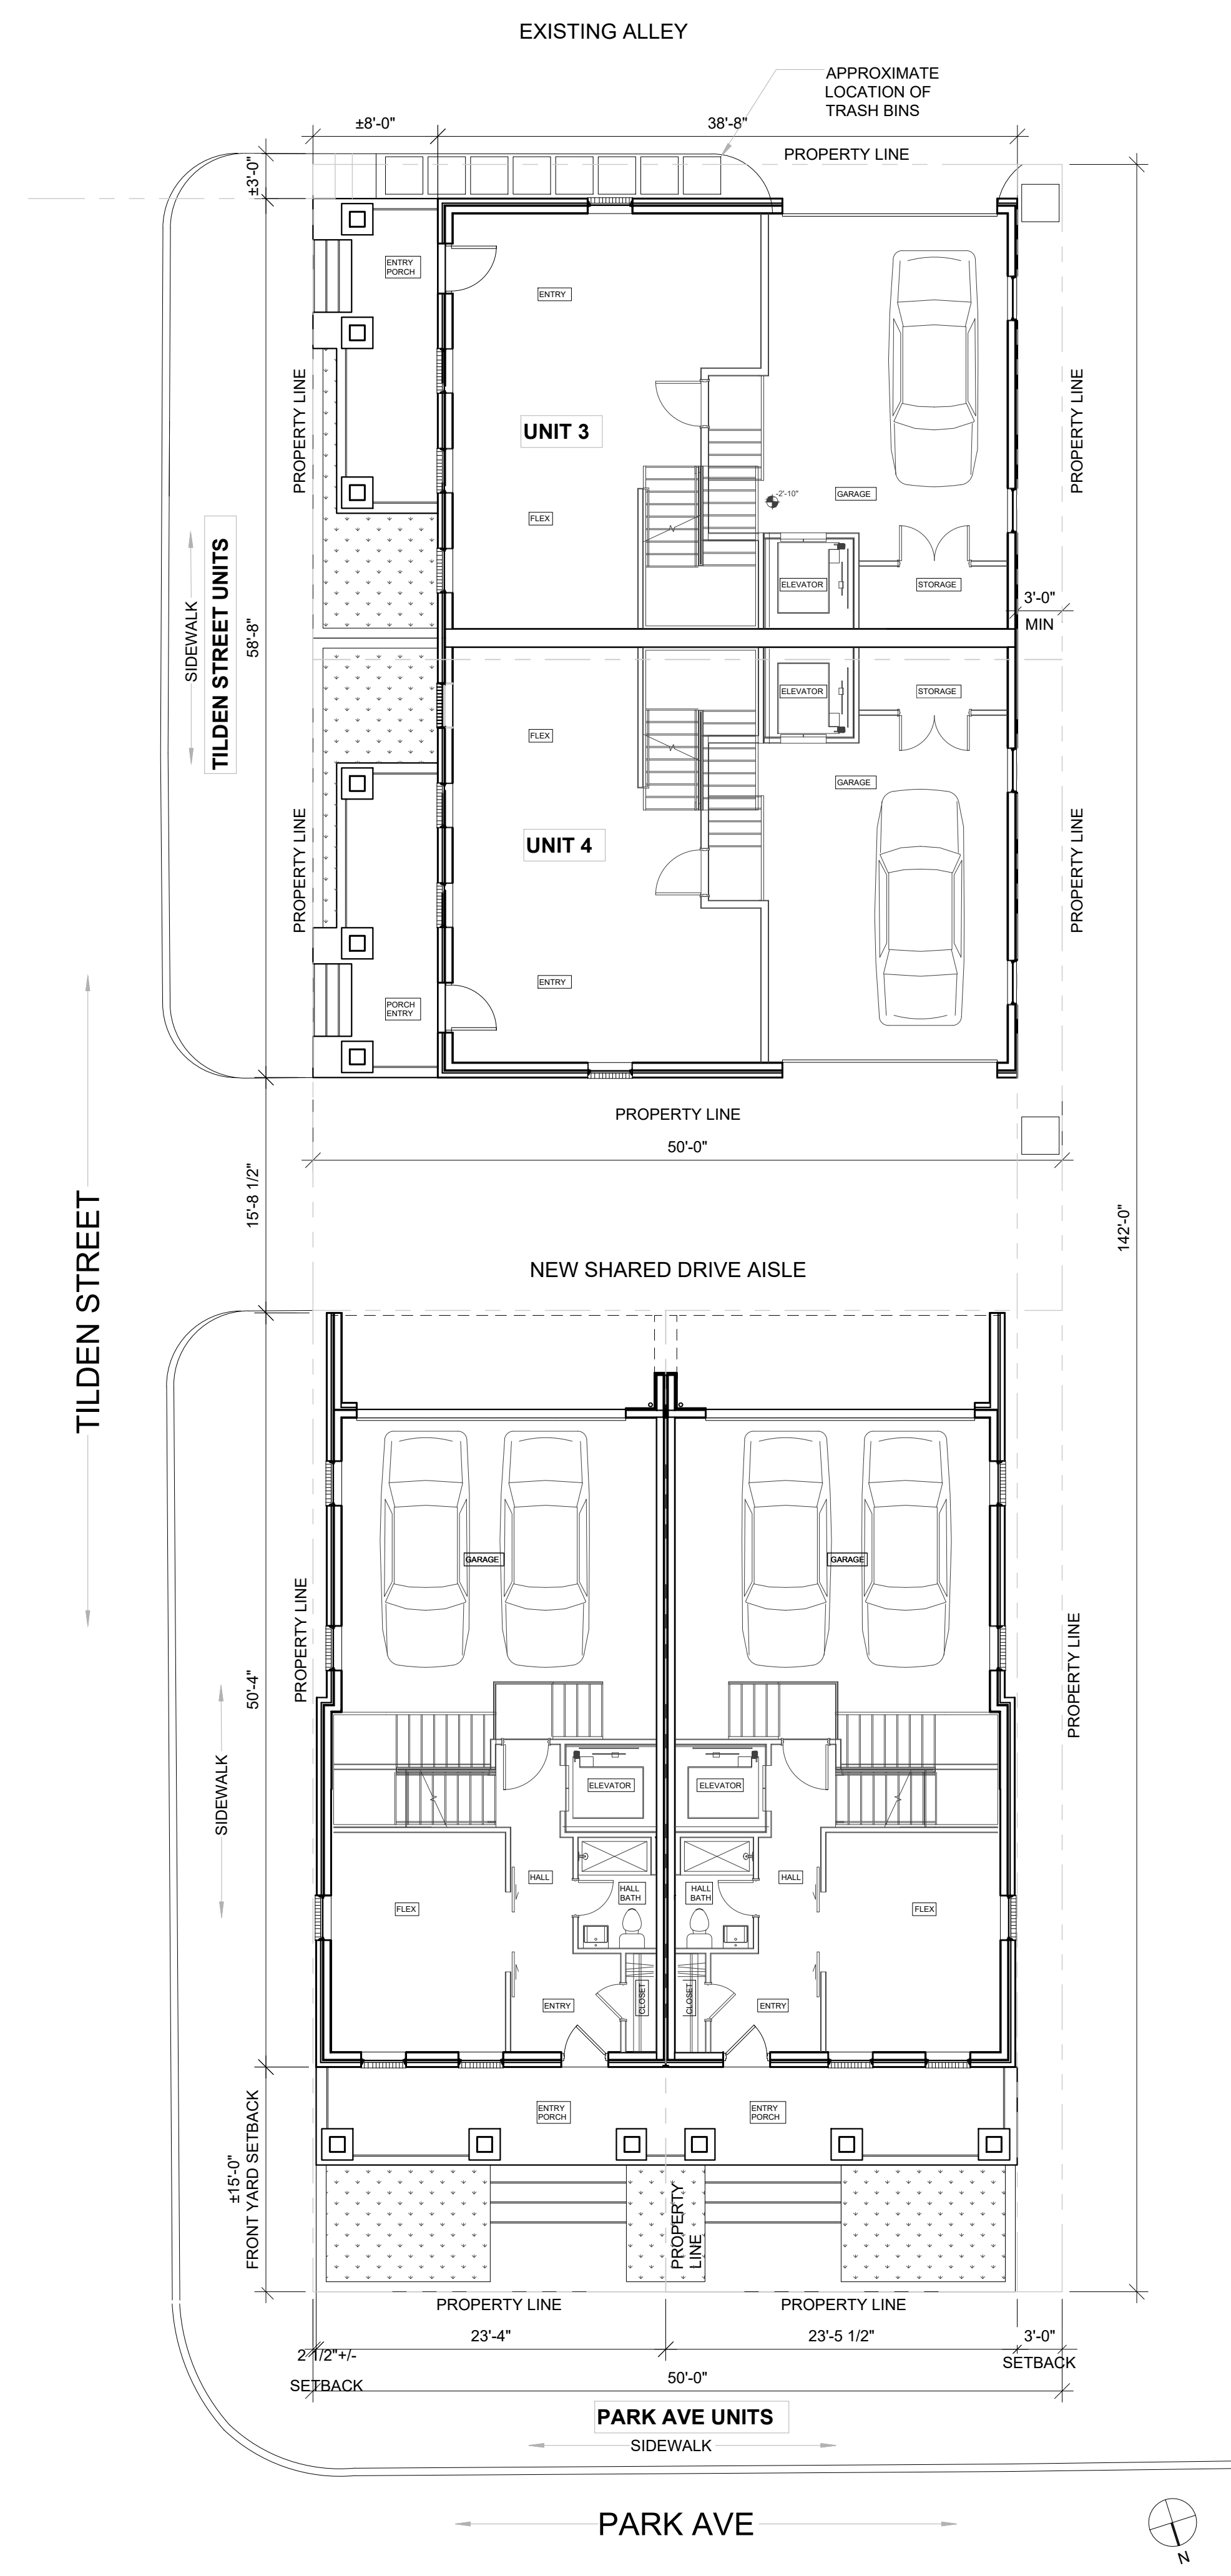
CONTEXT ELEVATION

10.28.2022

PARK & TILDEN ROWHOUSES | NEW CONSTRUCTION




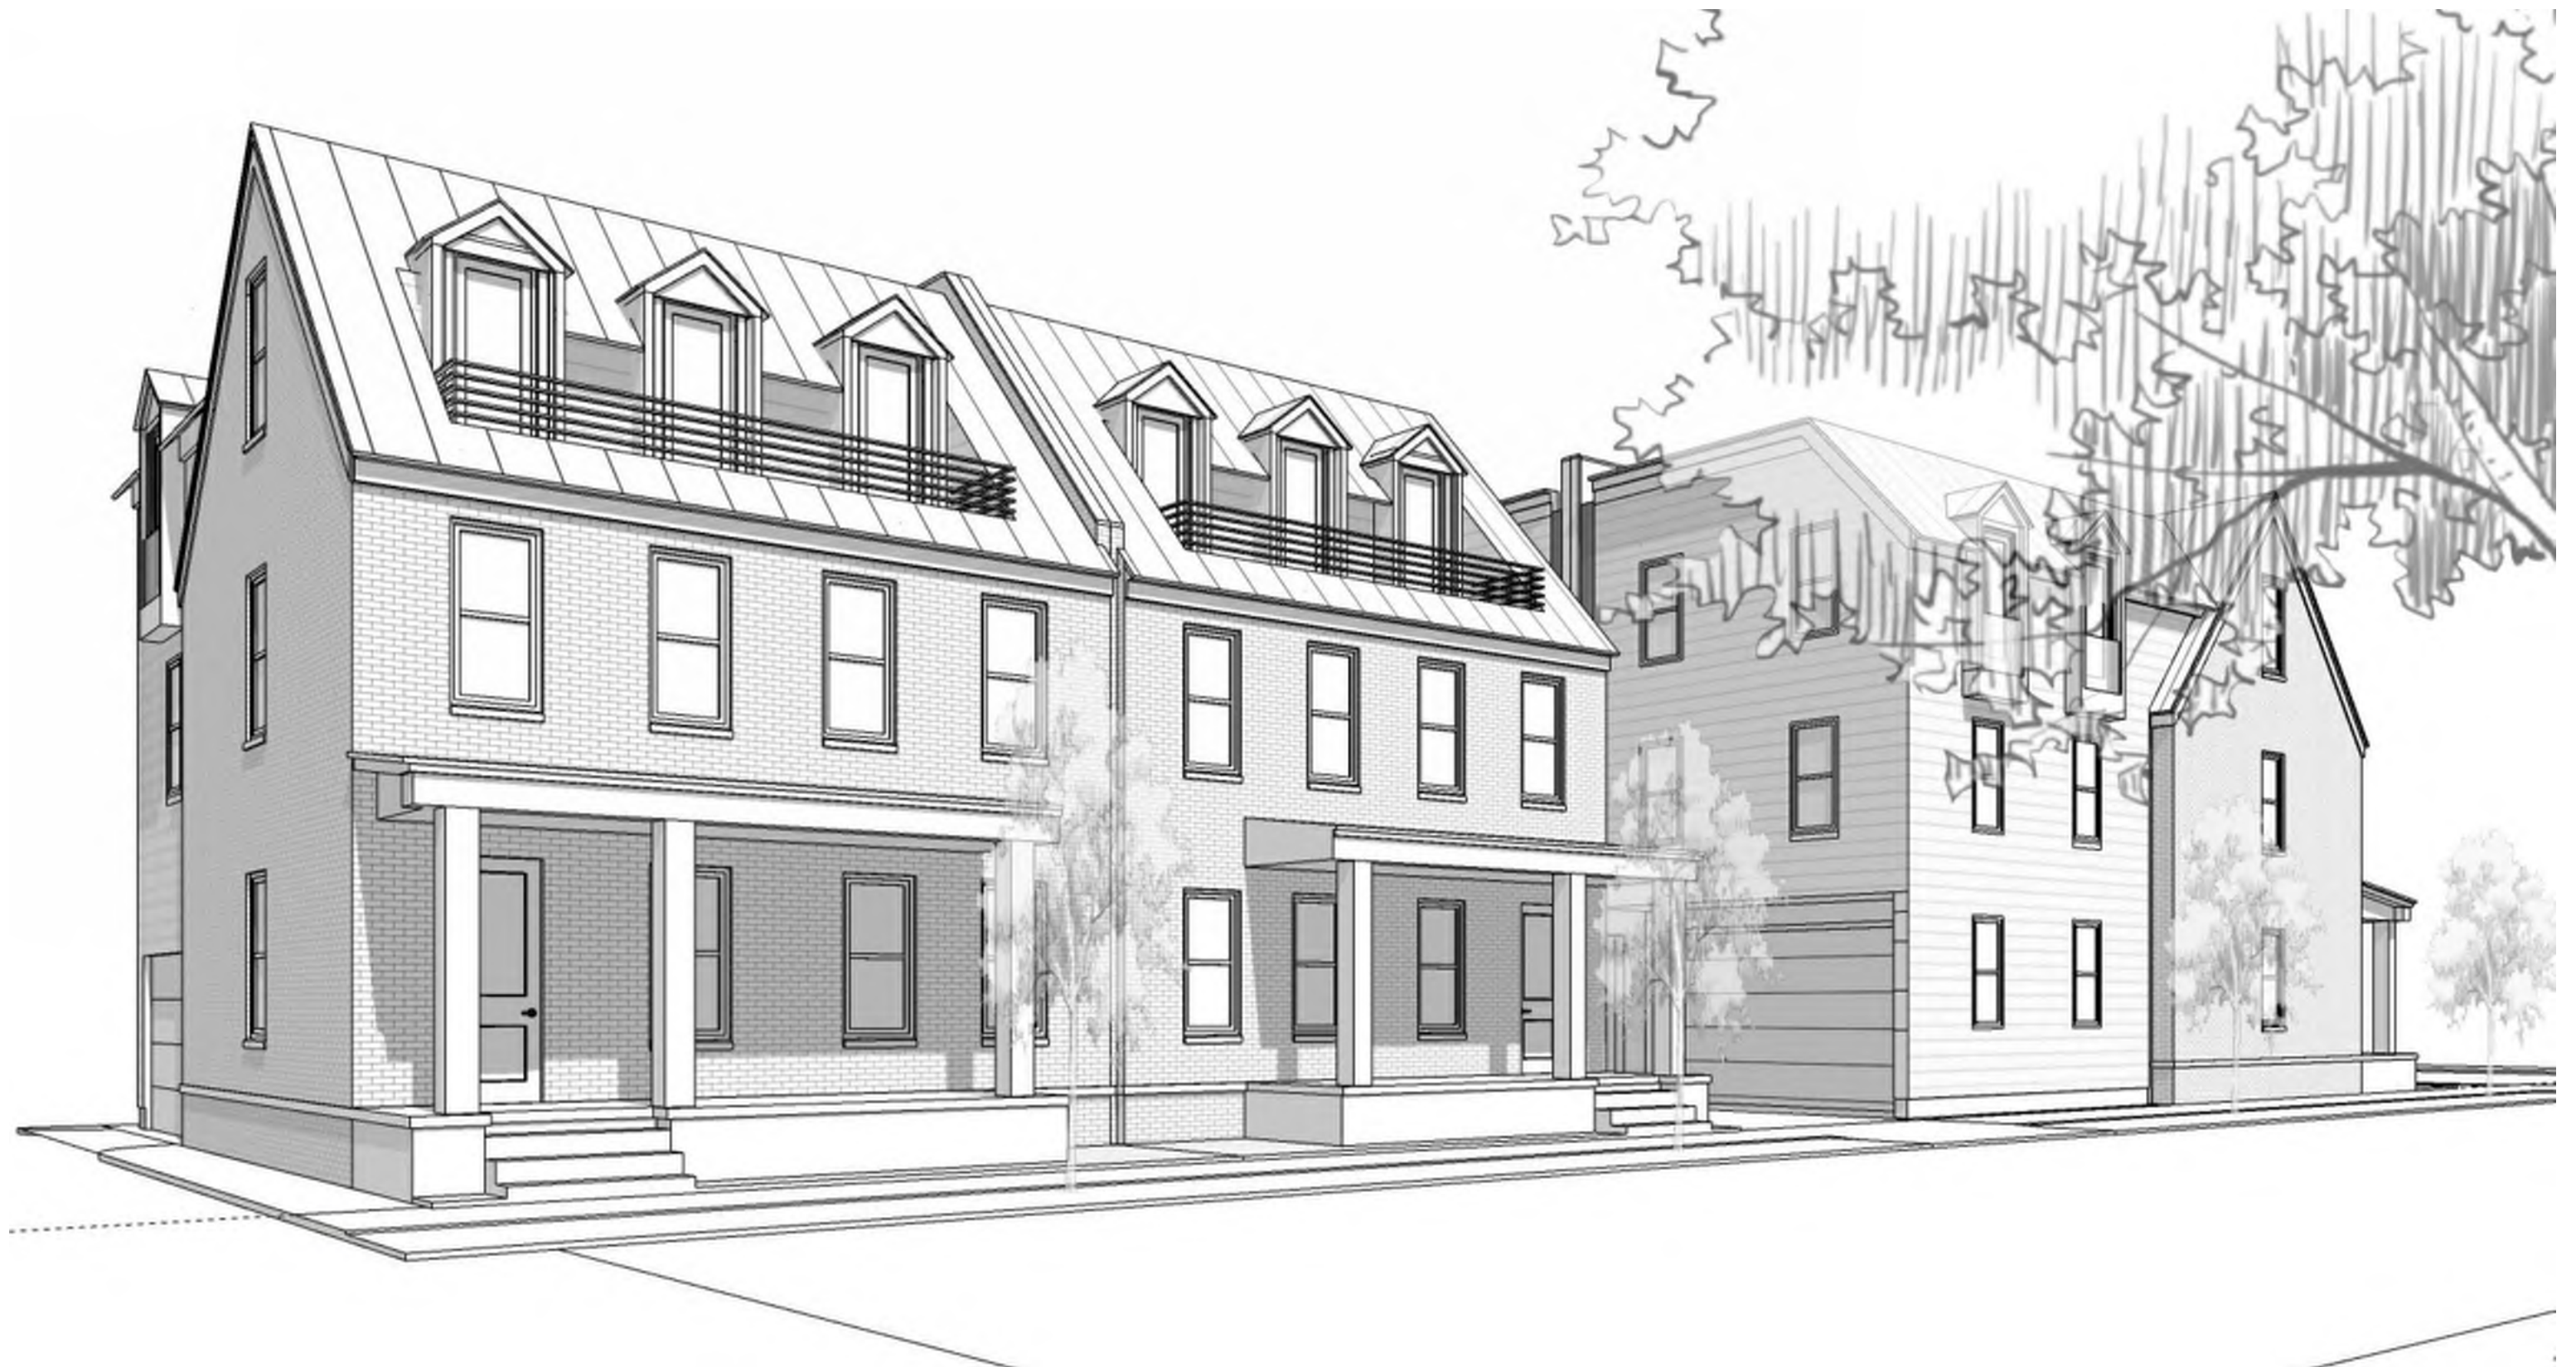



ARCHITECTURAL SITE PLAN


1/8" = 10'

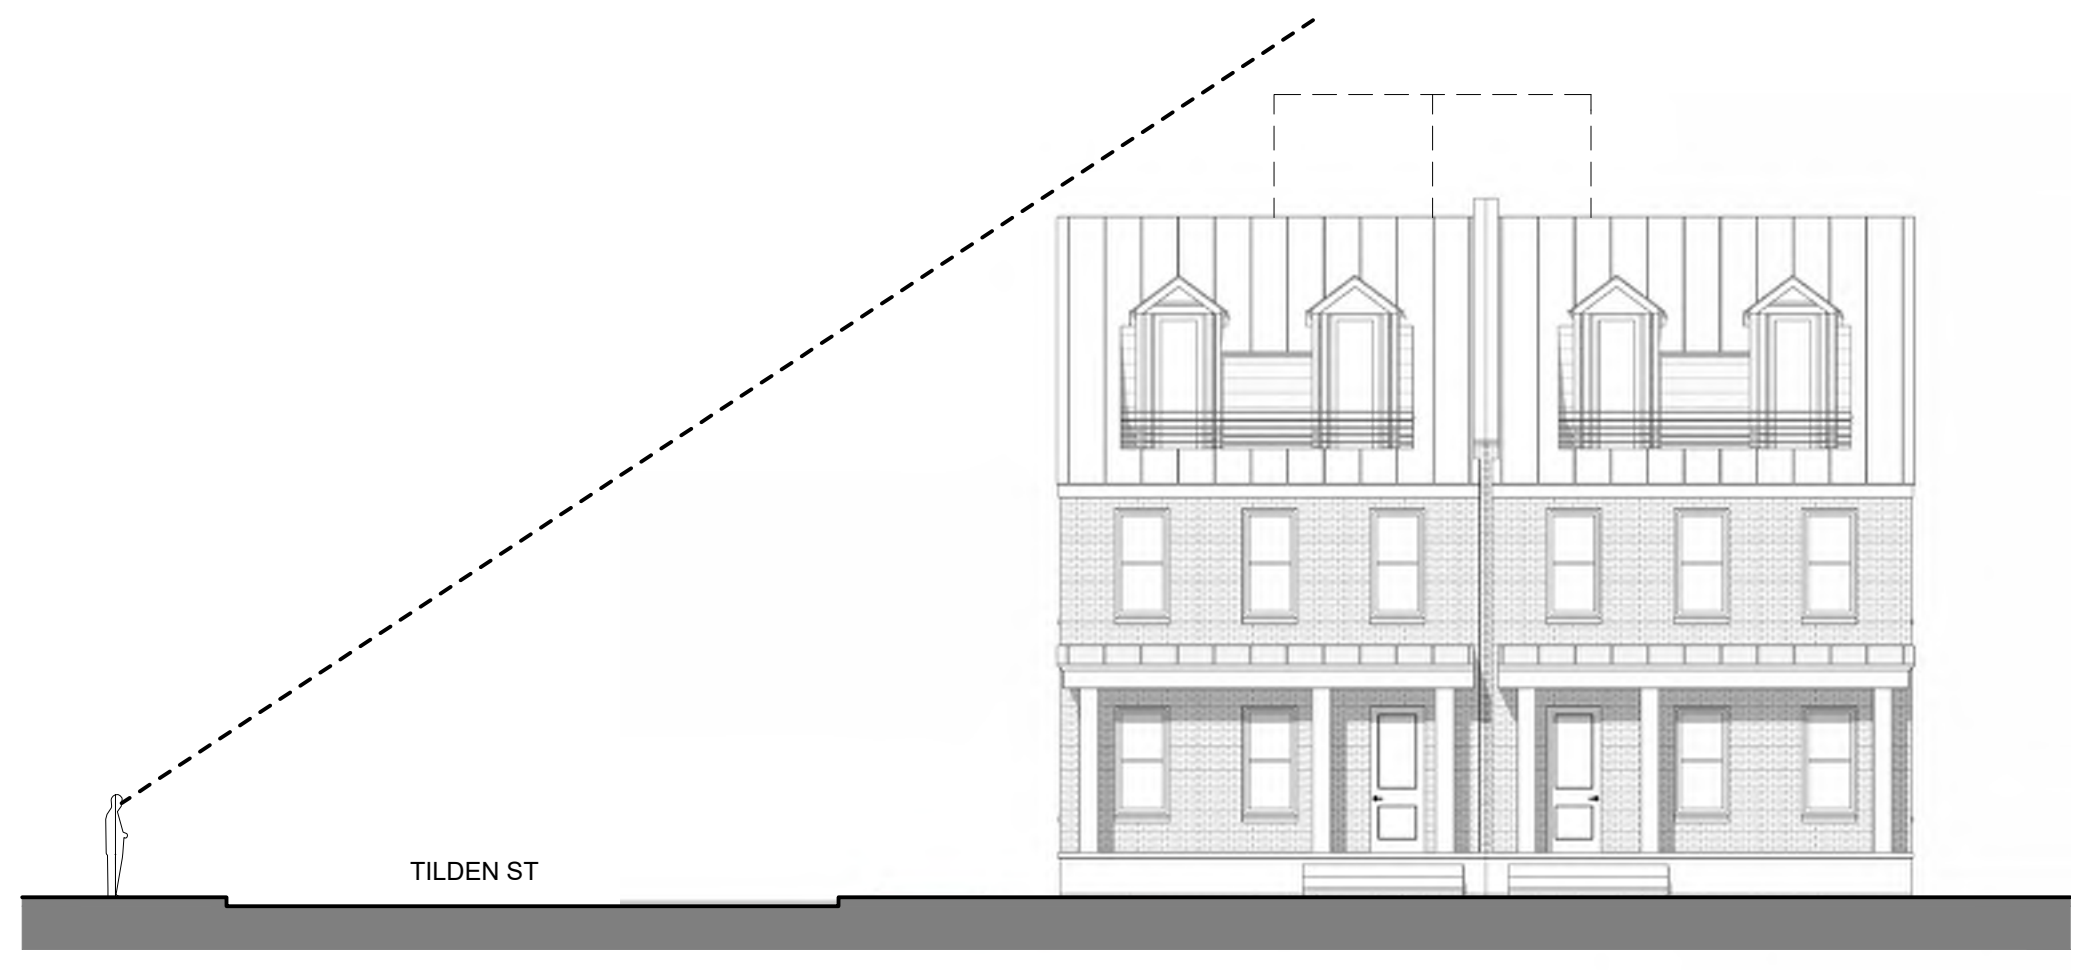

NORTH ELEVATION - PARK - SITE LINE

3/32" = 1'-0"


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EAST ELEVATION - PARK C - SITE LINE

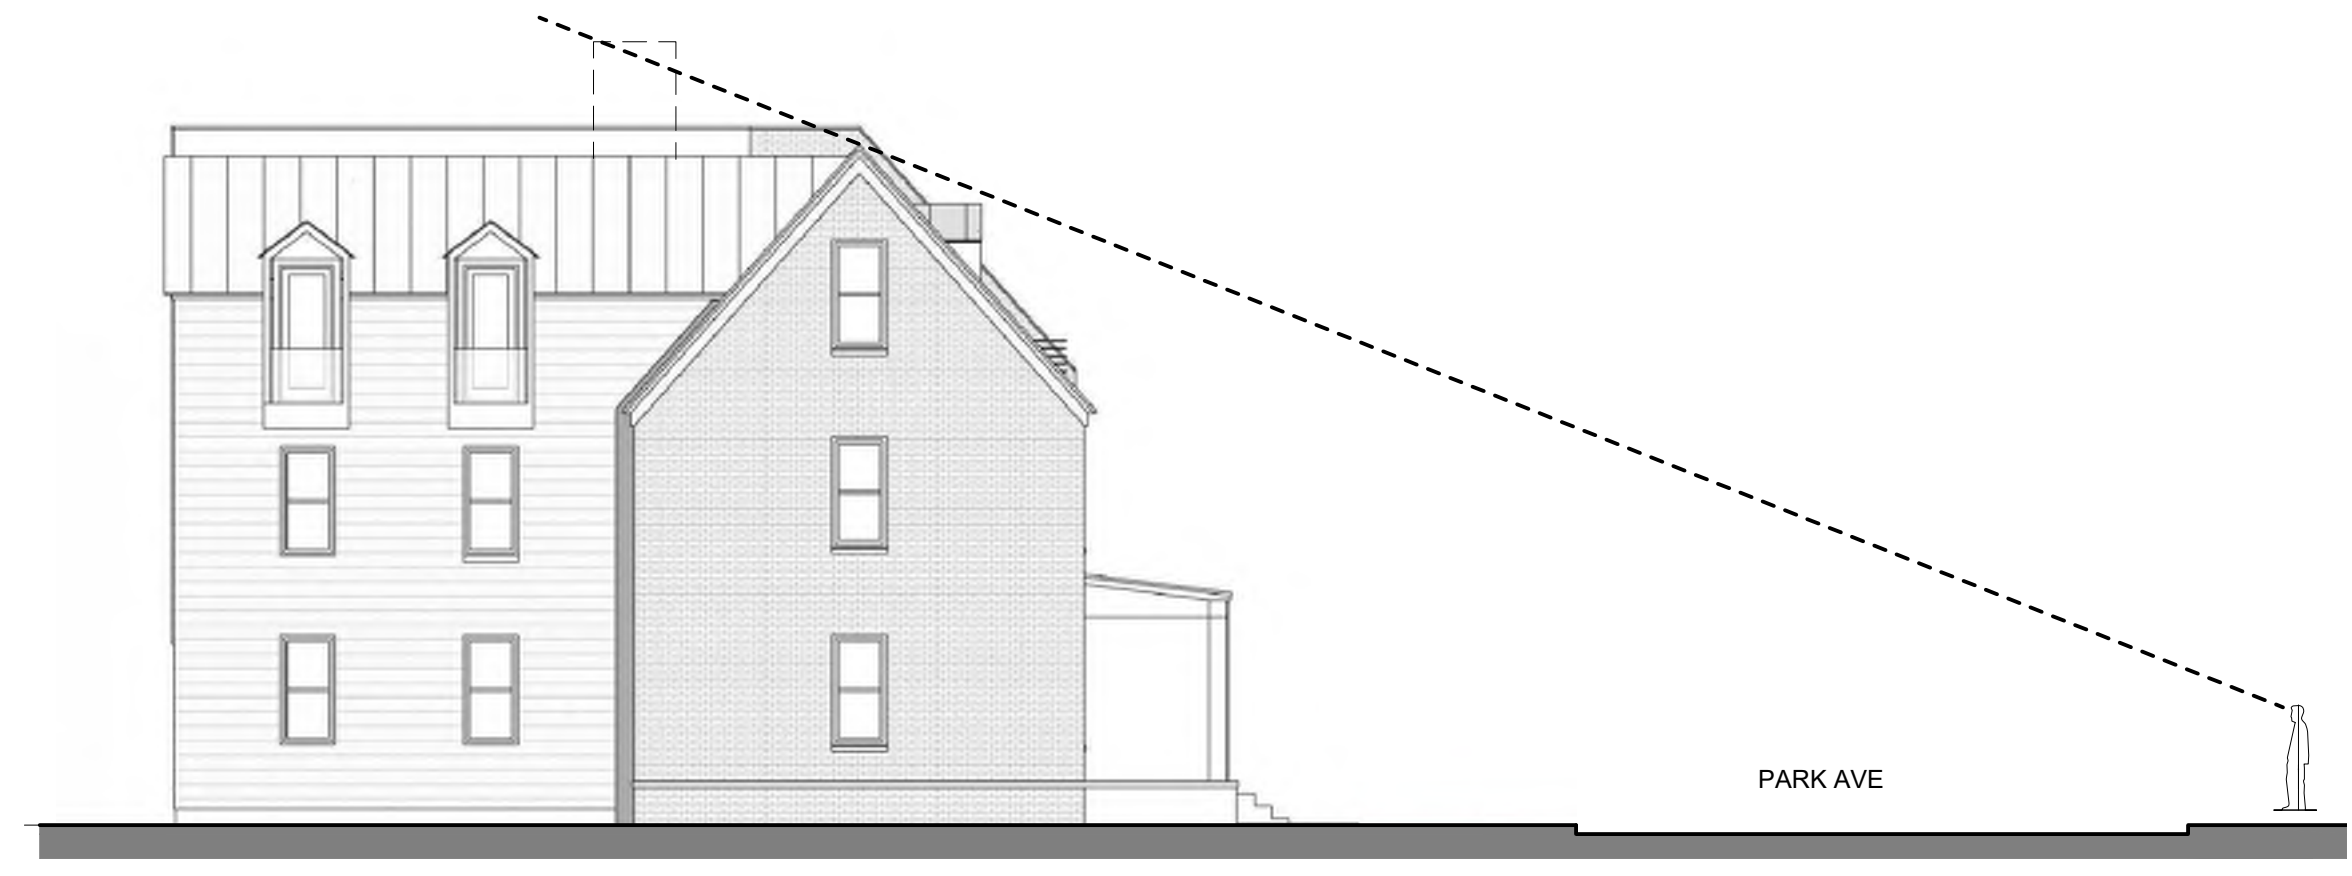3/32" = 1'-0"

3




NORTH ELEVATION - TILDEN - SITE LINE

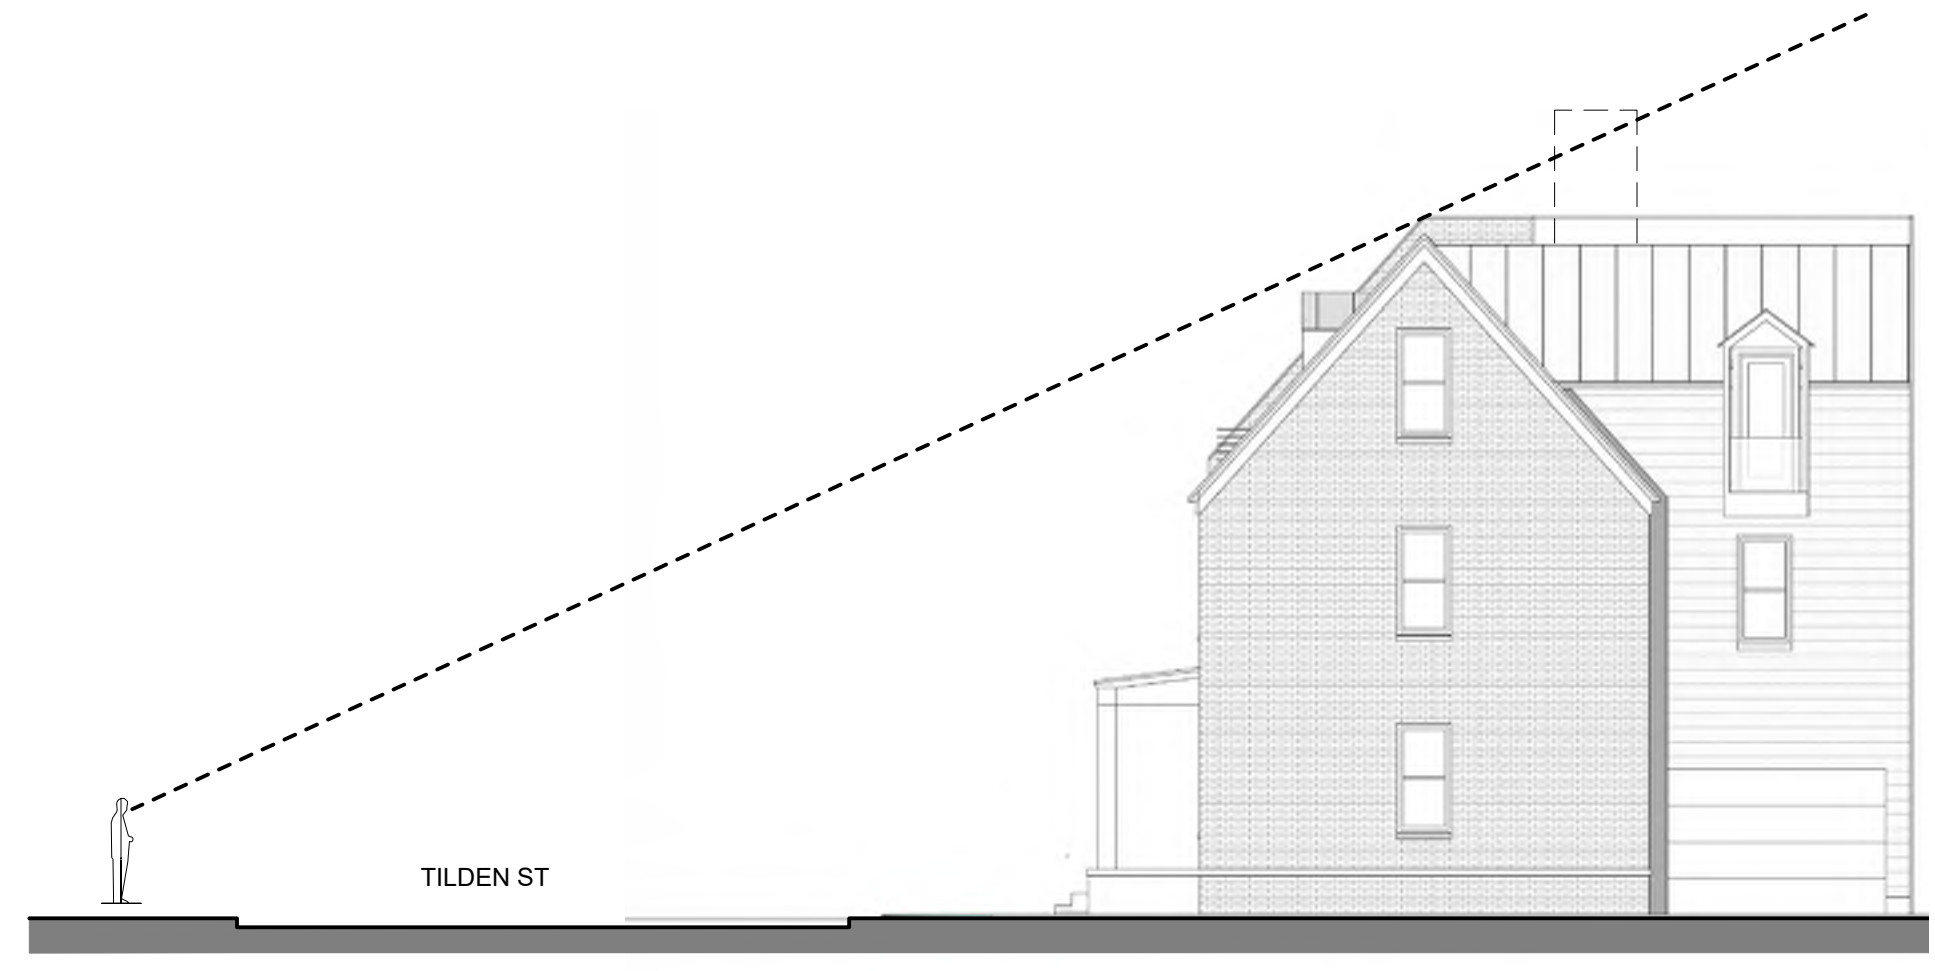3/32" = 1'-0"


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LEVEL 2 - CONSTRUCTION PLAN - PARK  
1/4" = 1'-0"


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LEVEL 1 - CONSTRUCTION PLAN - PARK  
1/4" = 1'-0"

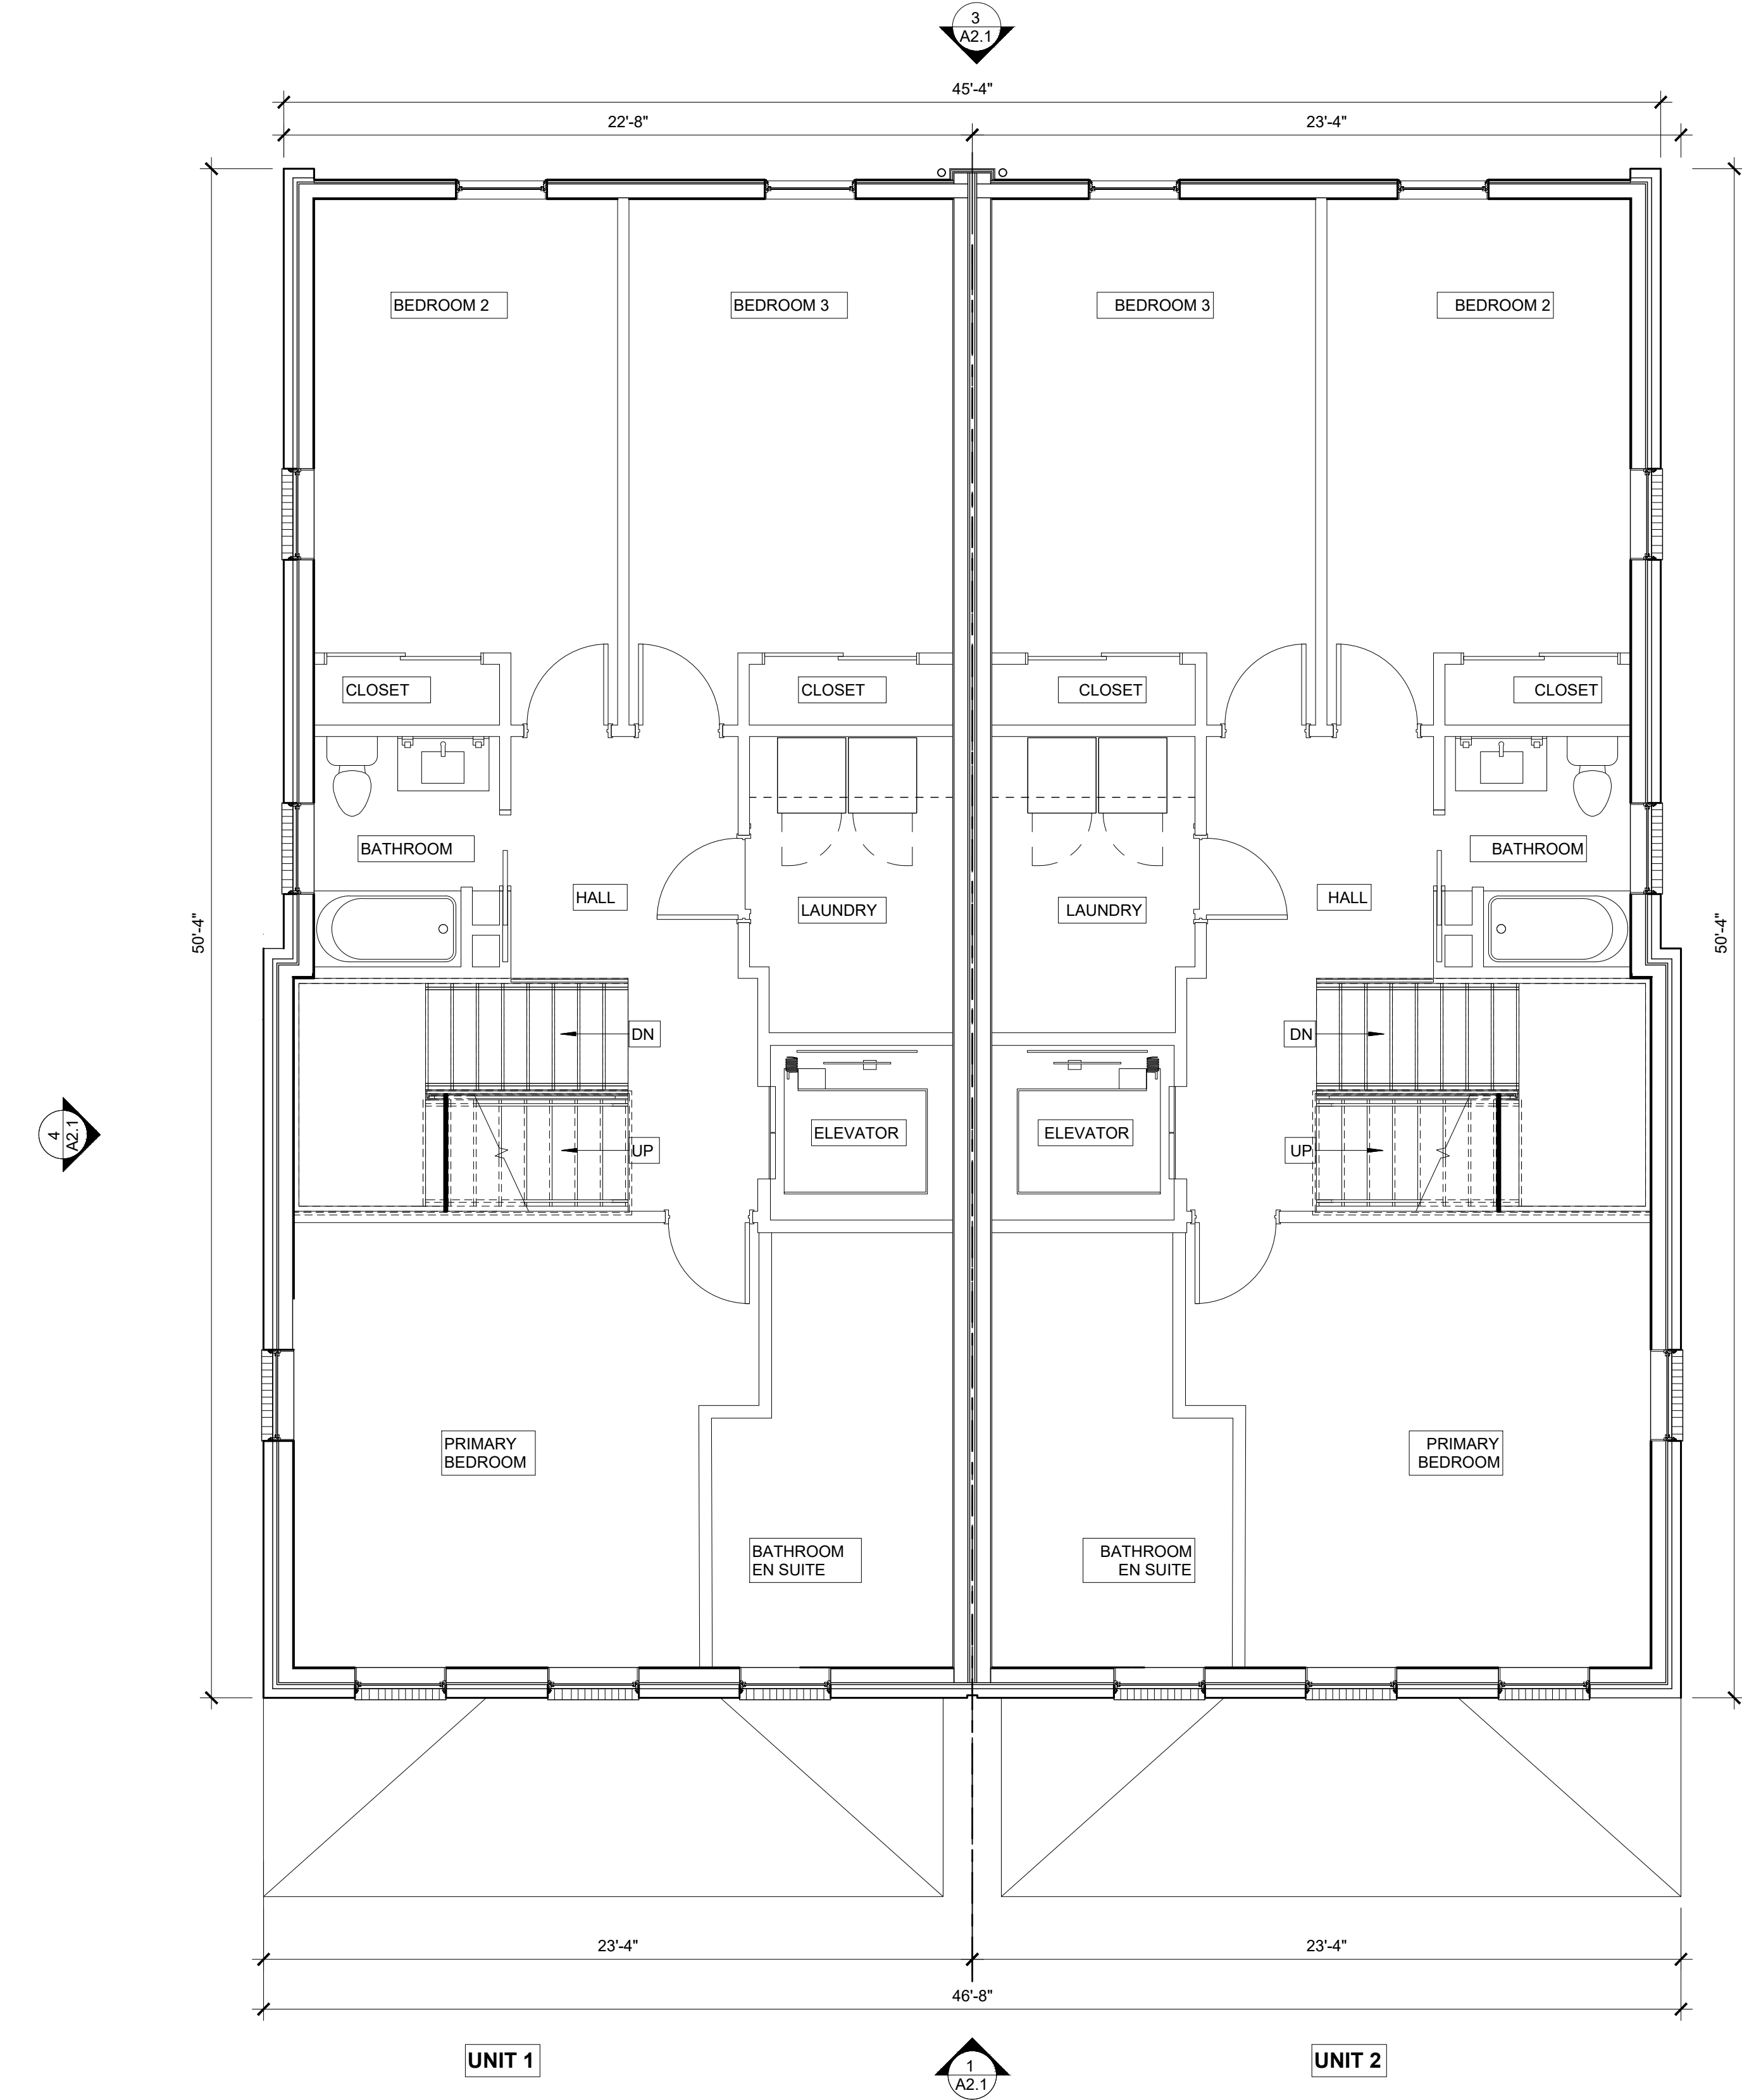
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ROOF PLAN - PARK

1/4" = 1'-0"

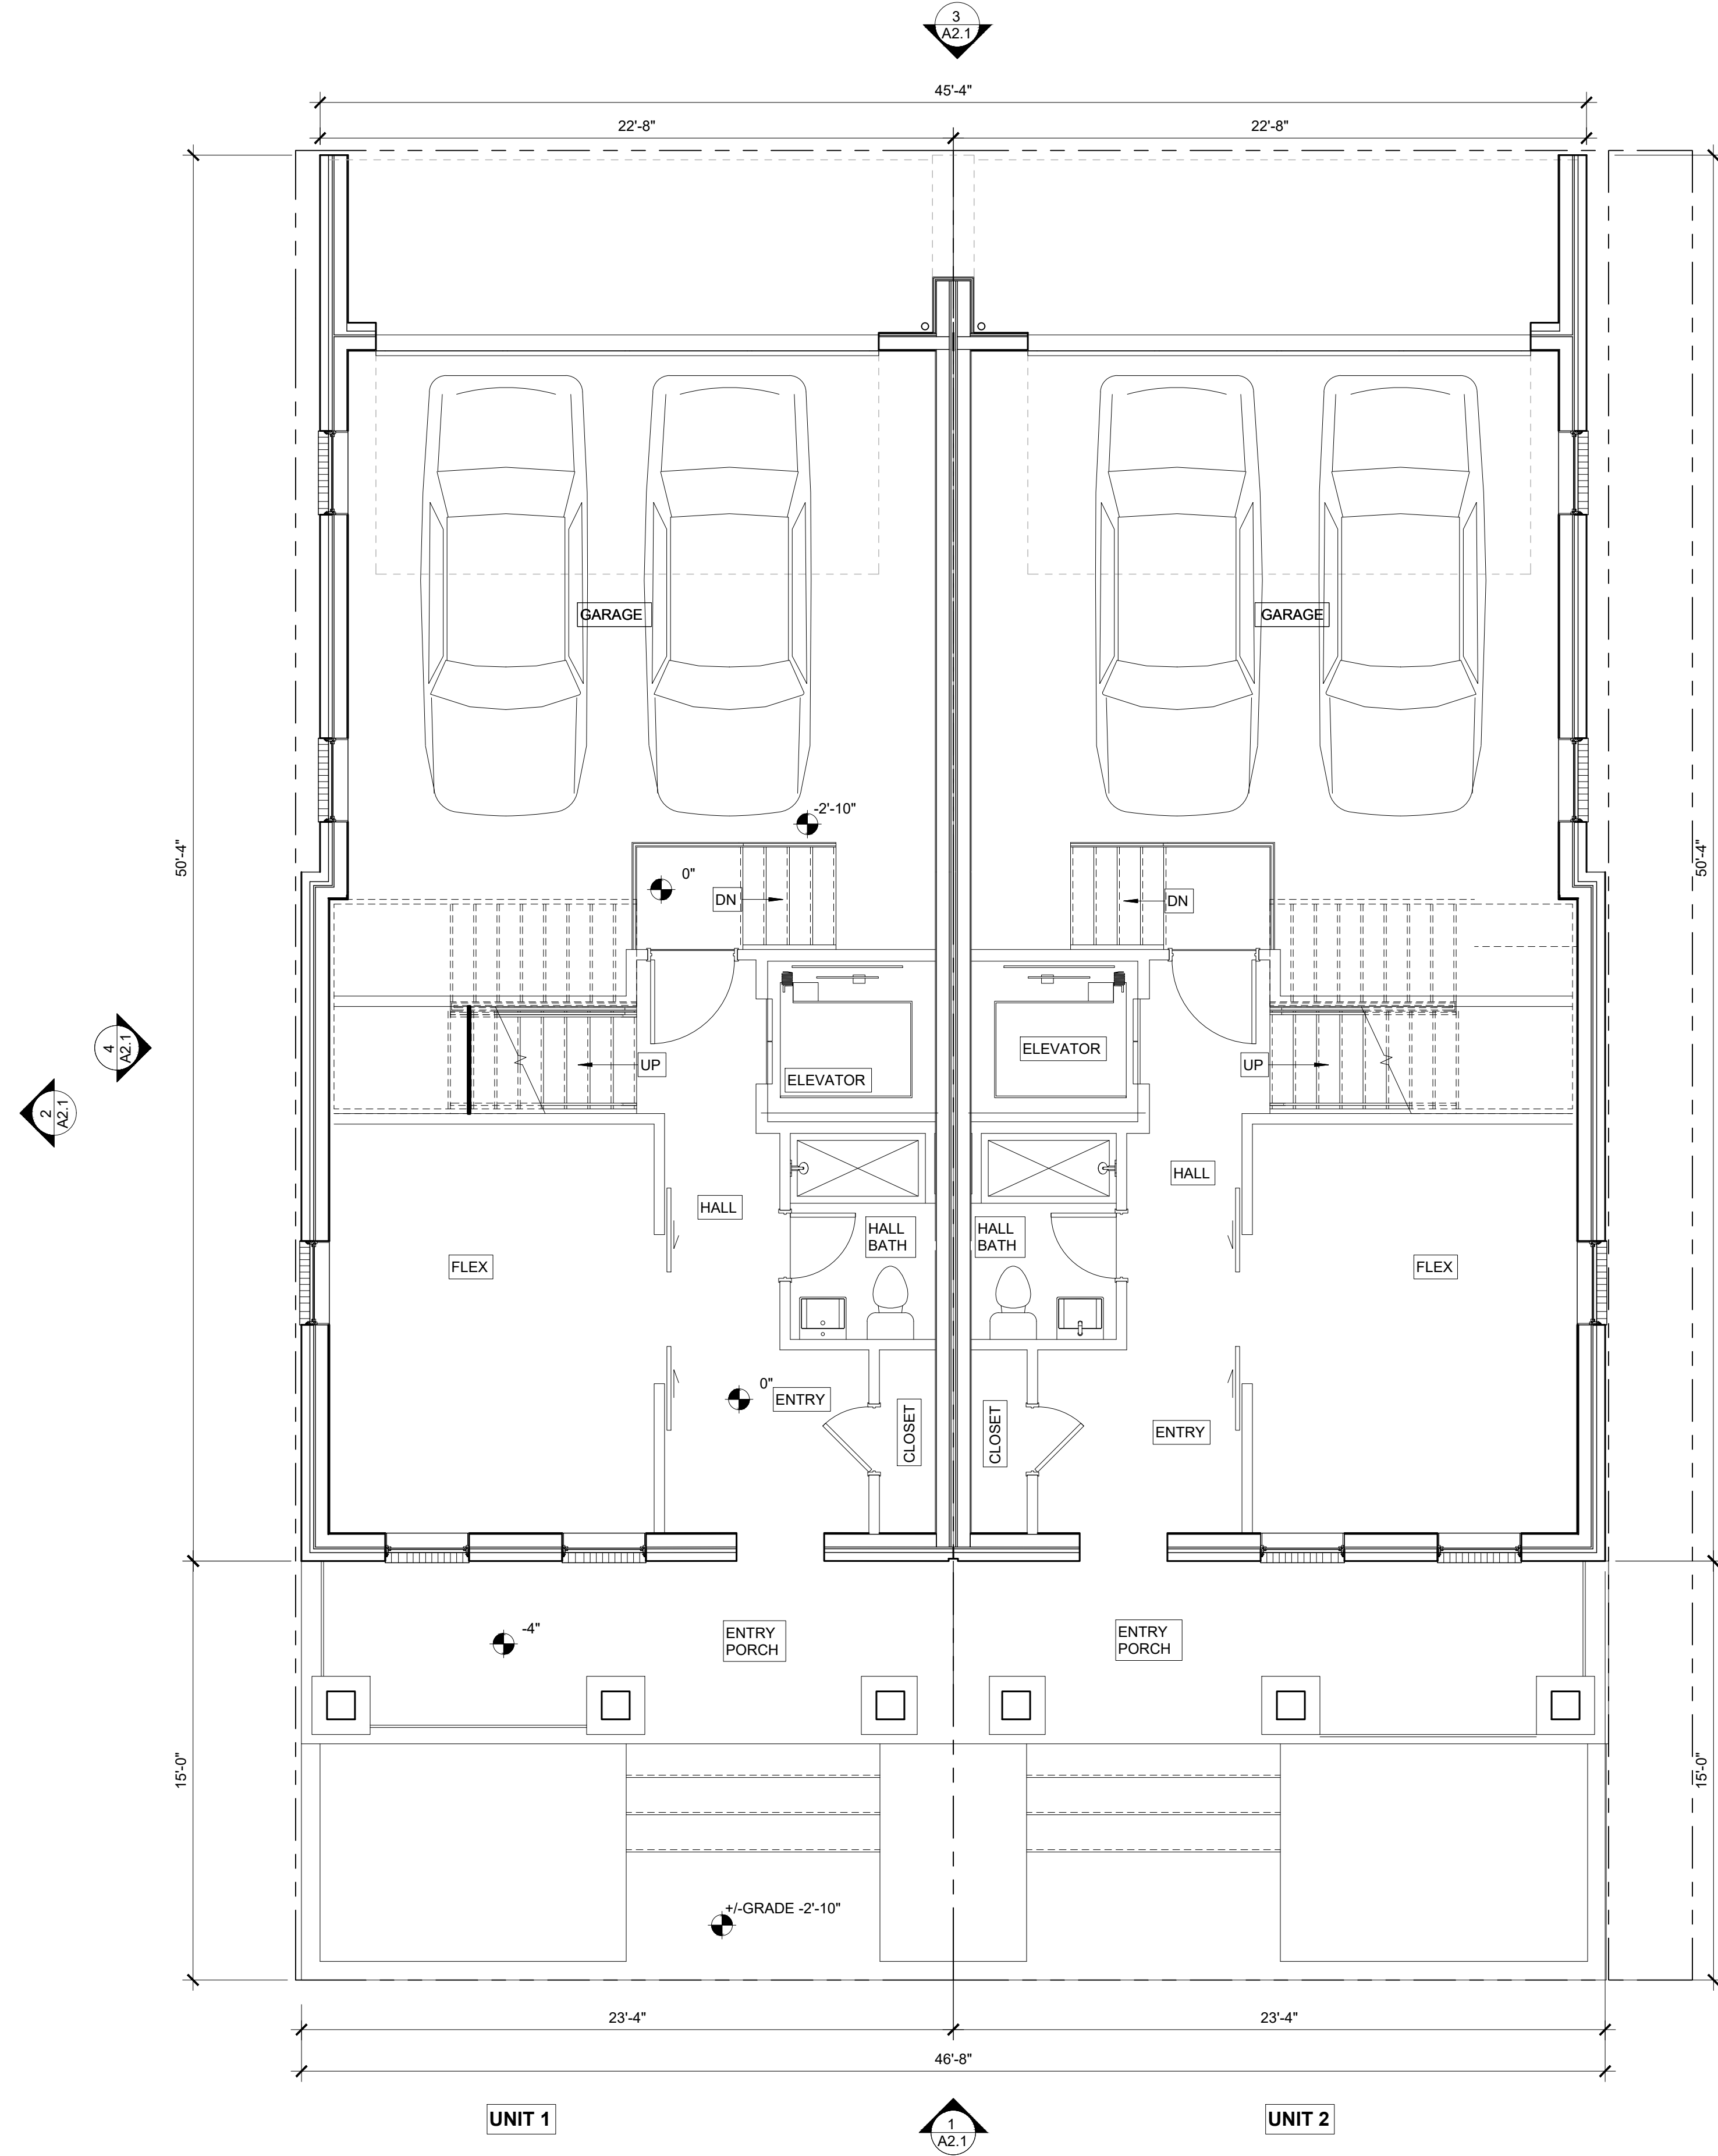

LEVEL 3 - CONSTRUCTION PLAN - PARK

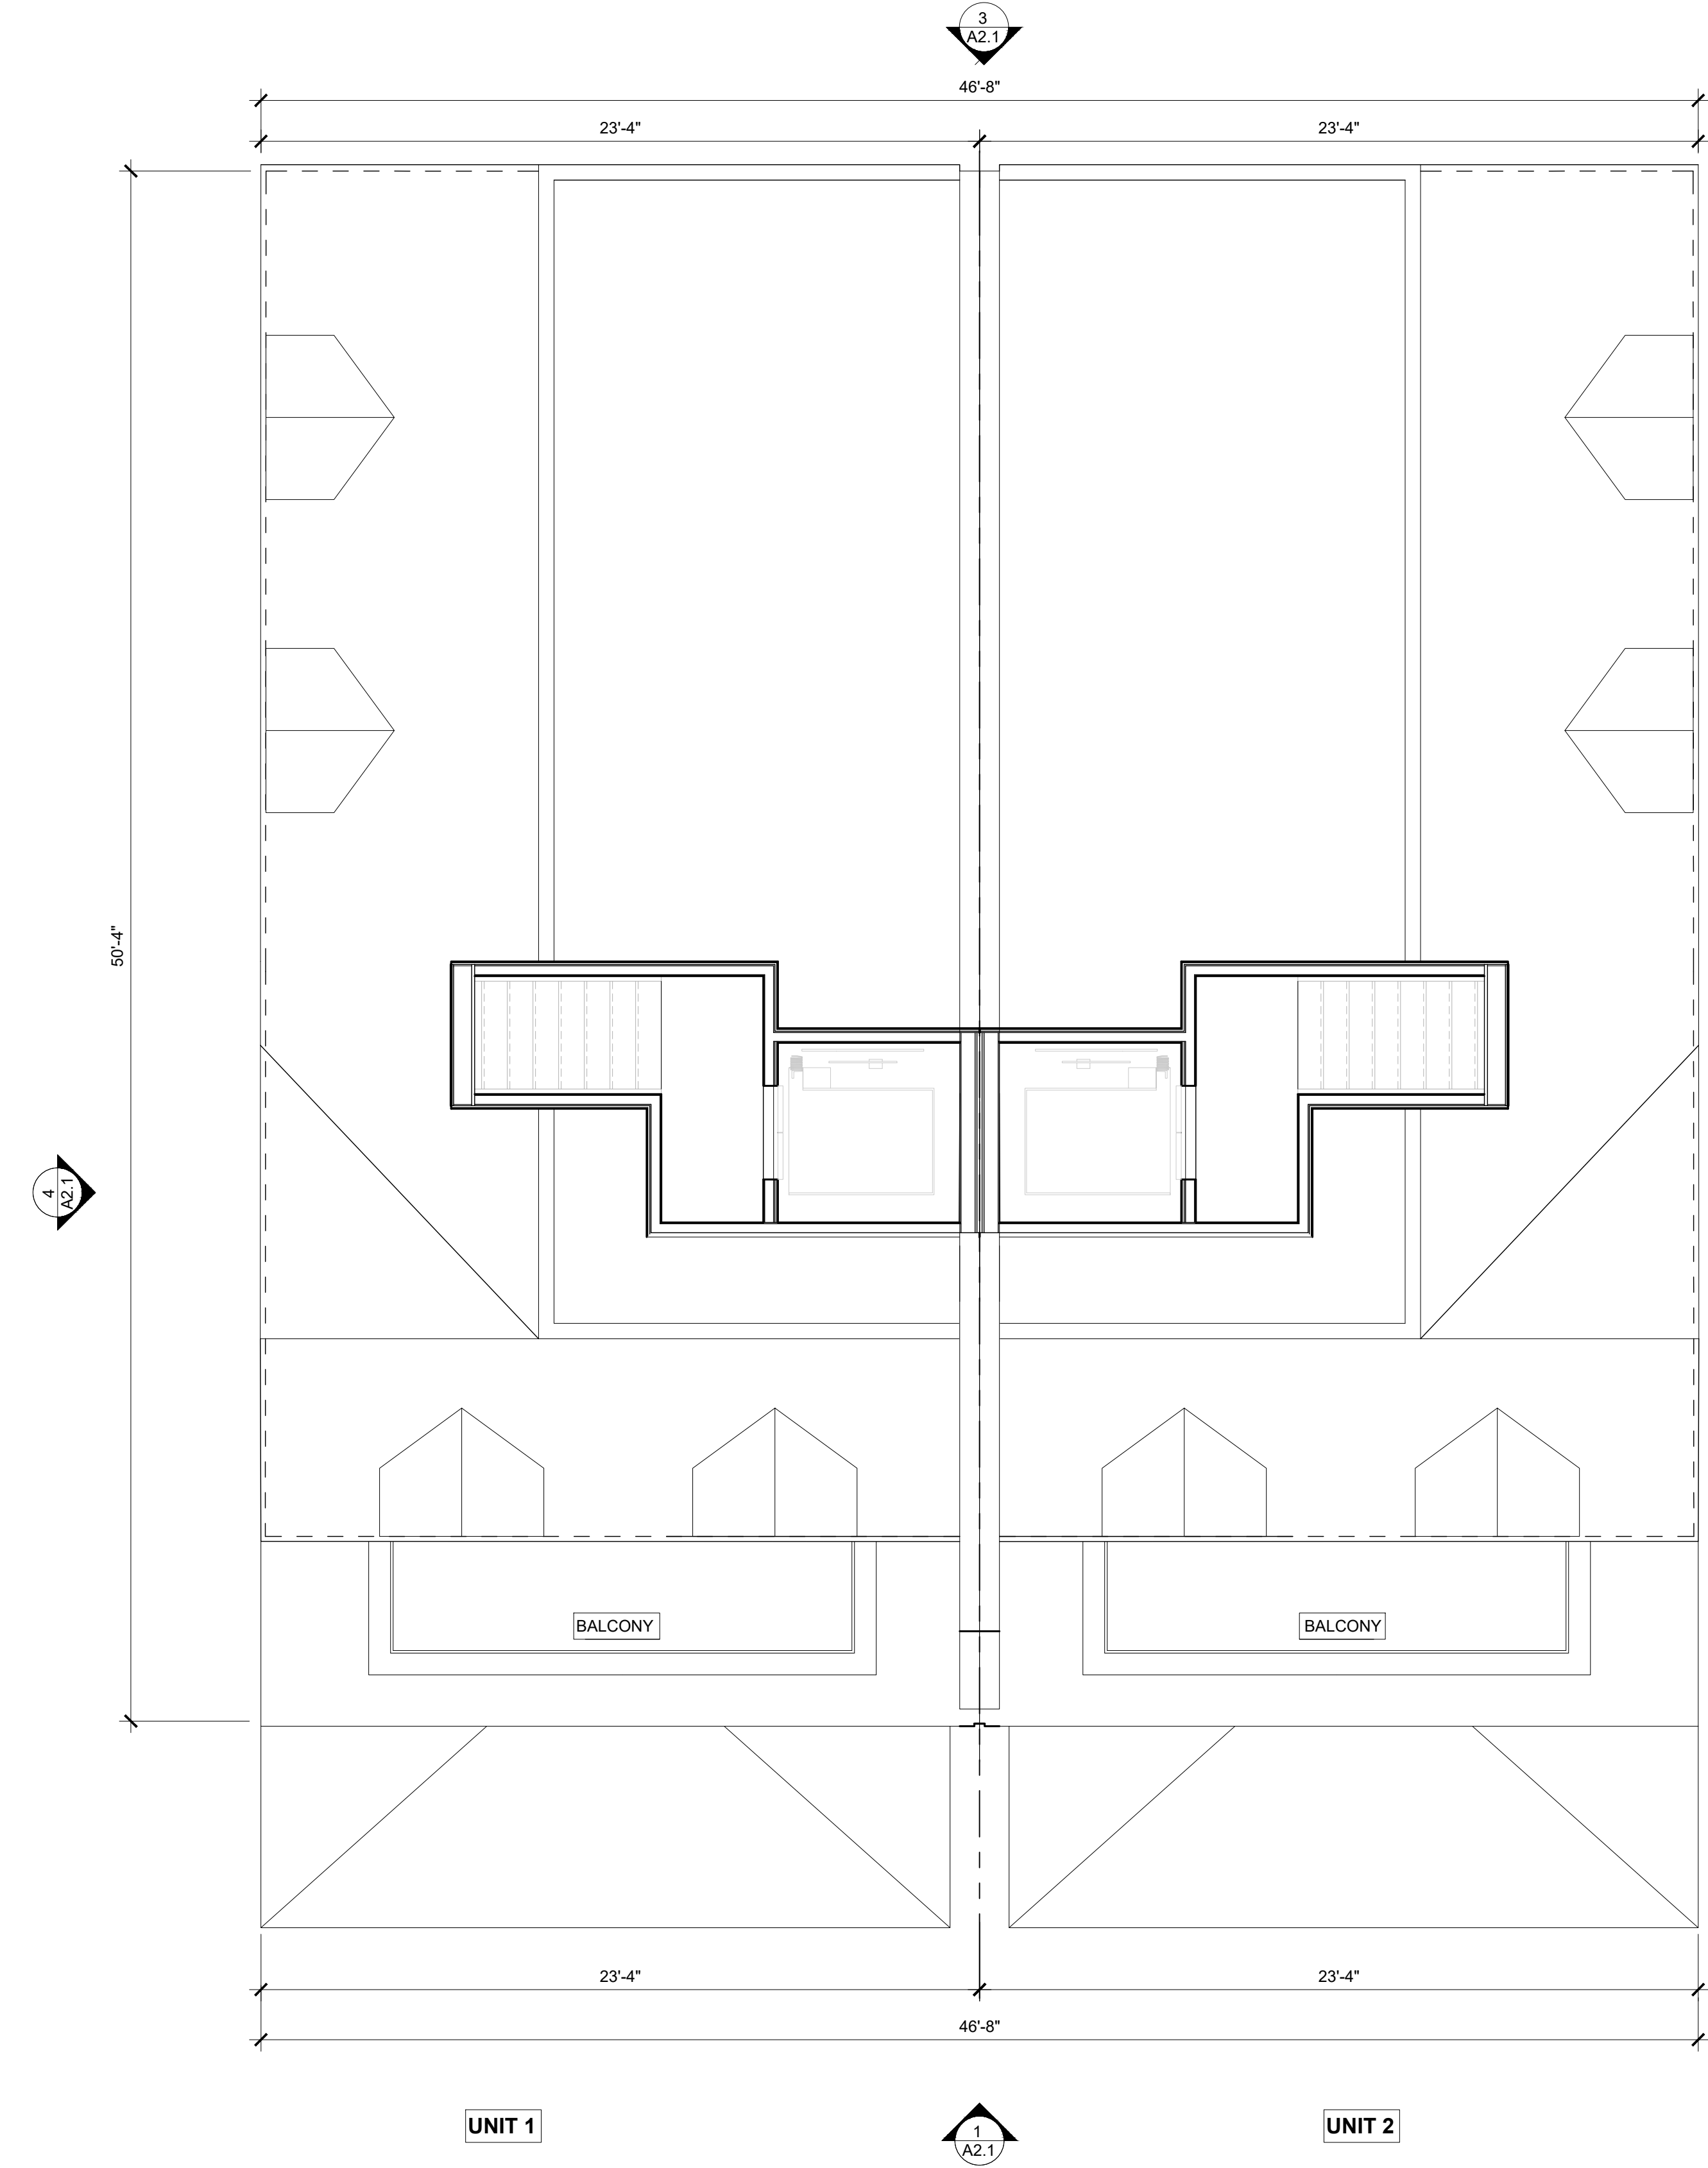1/4" = 1'-0"

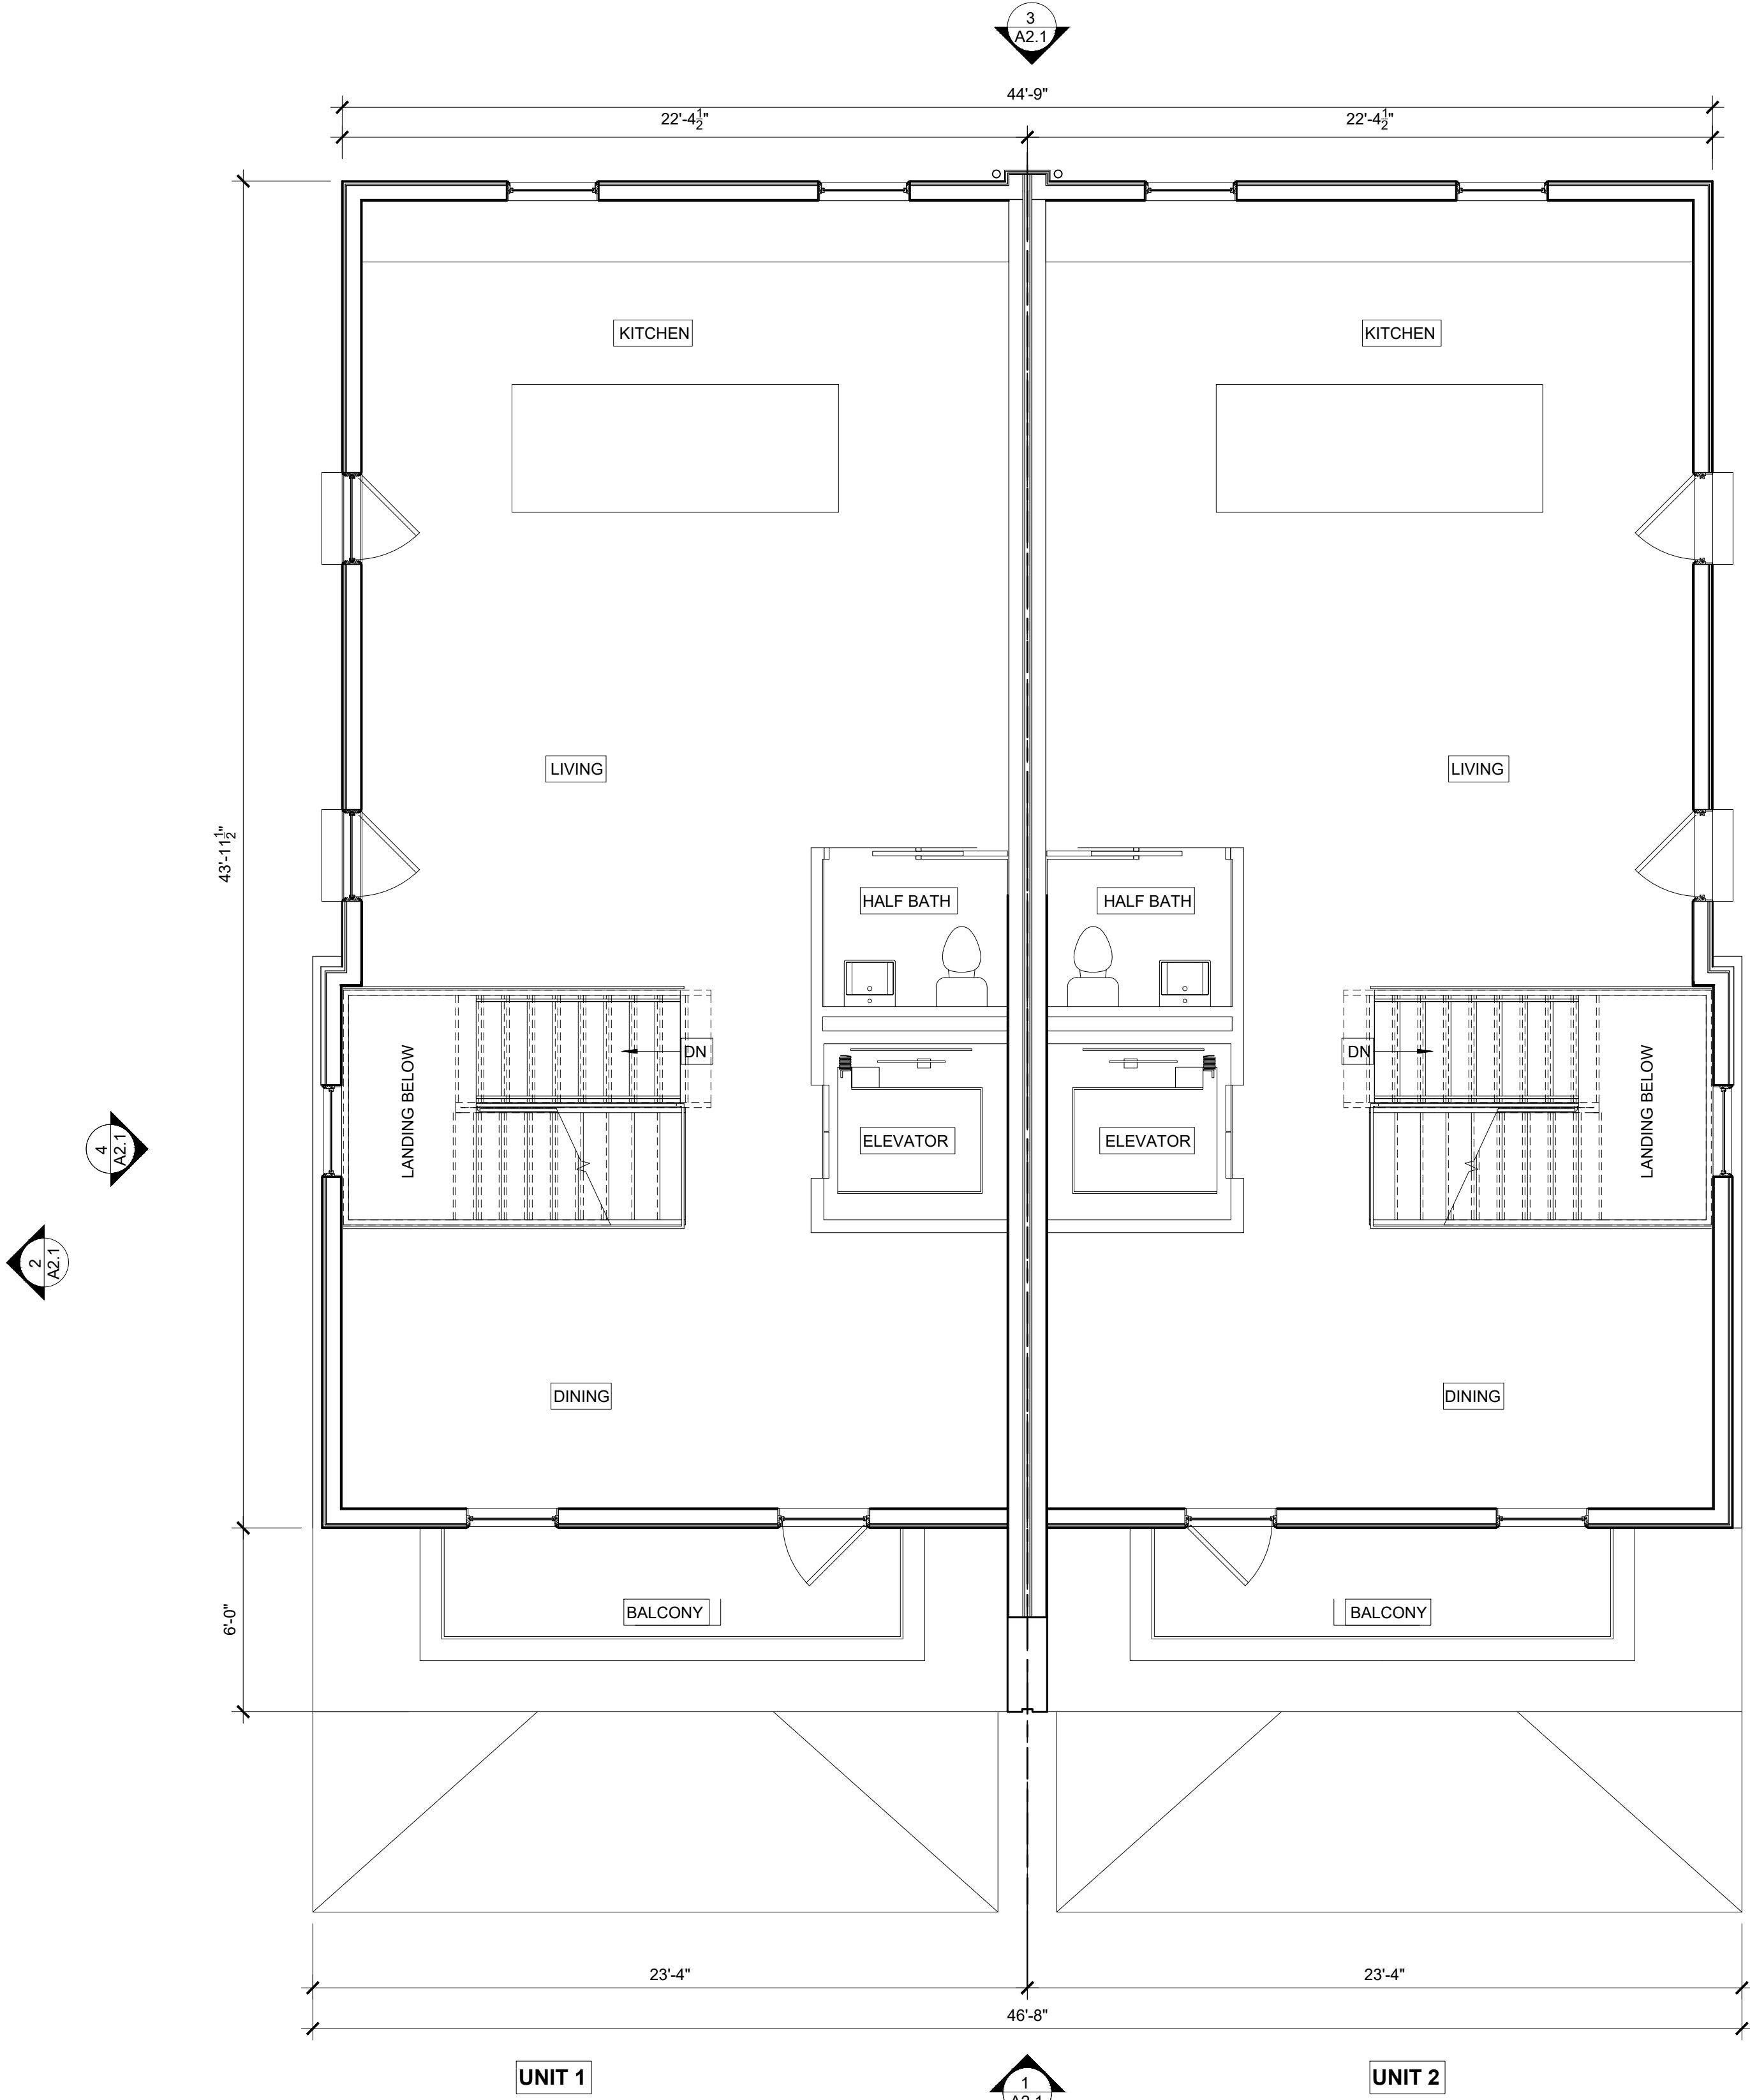DATE 10.28.2022

ISSUE SUP RESUBMISSION


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**NEW CONSTRUCTION**  
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PROGRESS SET  
NOT FOR  
CONSTRUCTION



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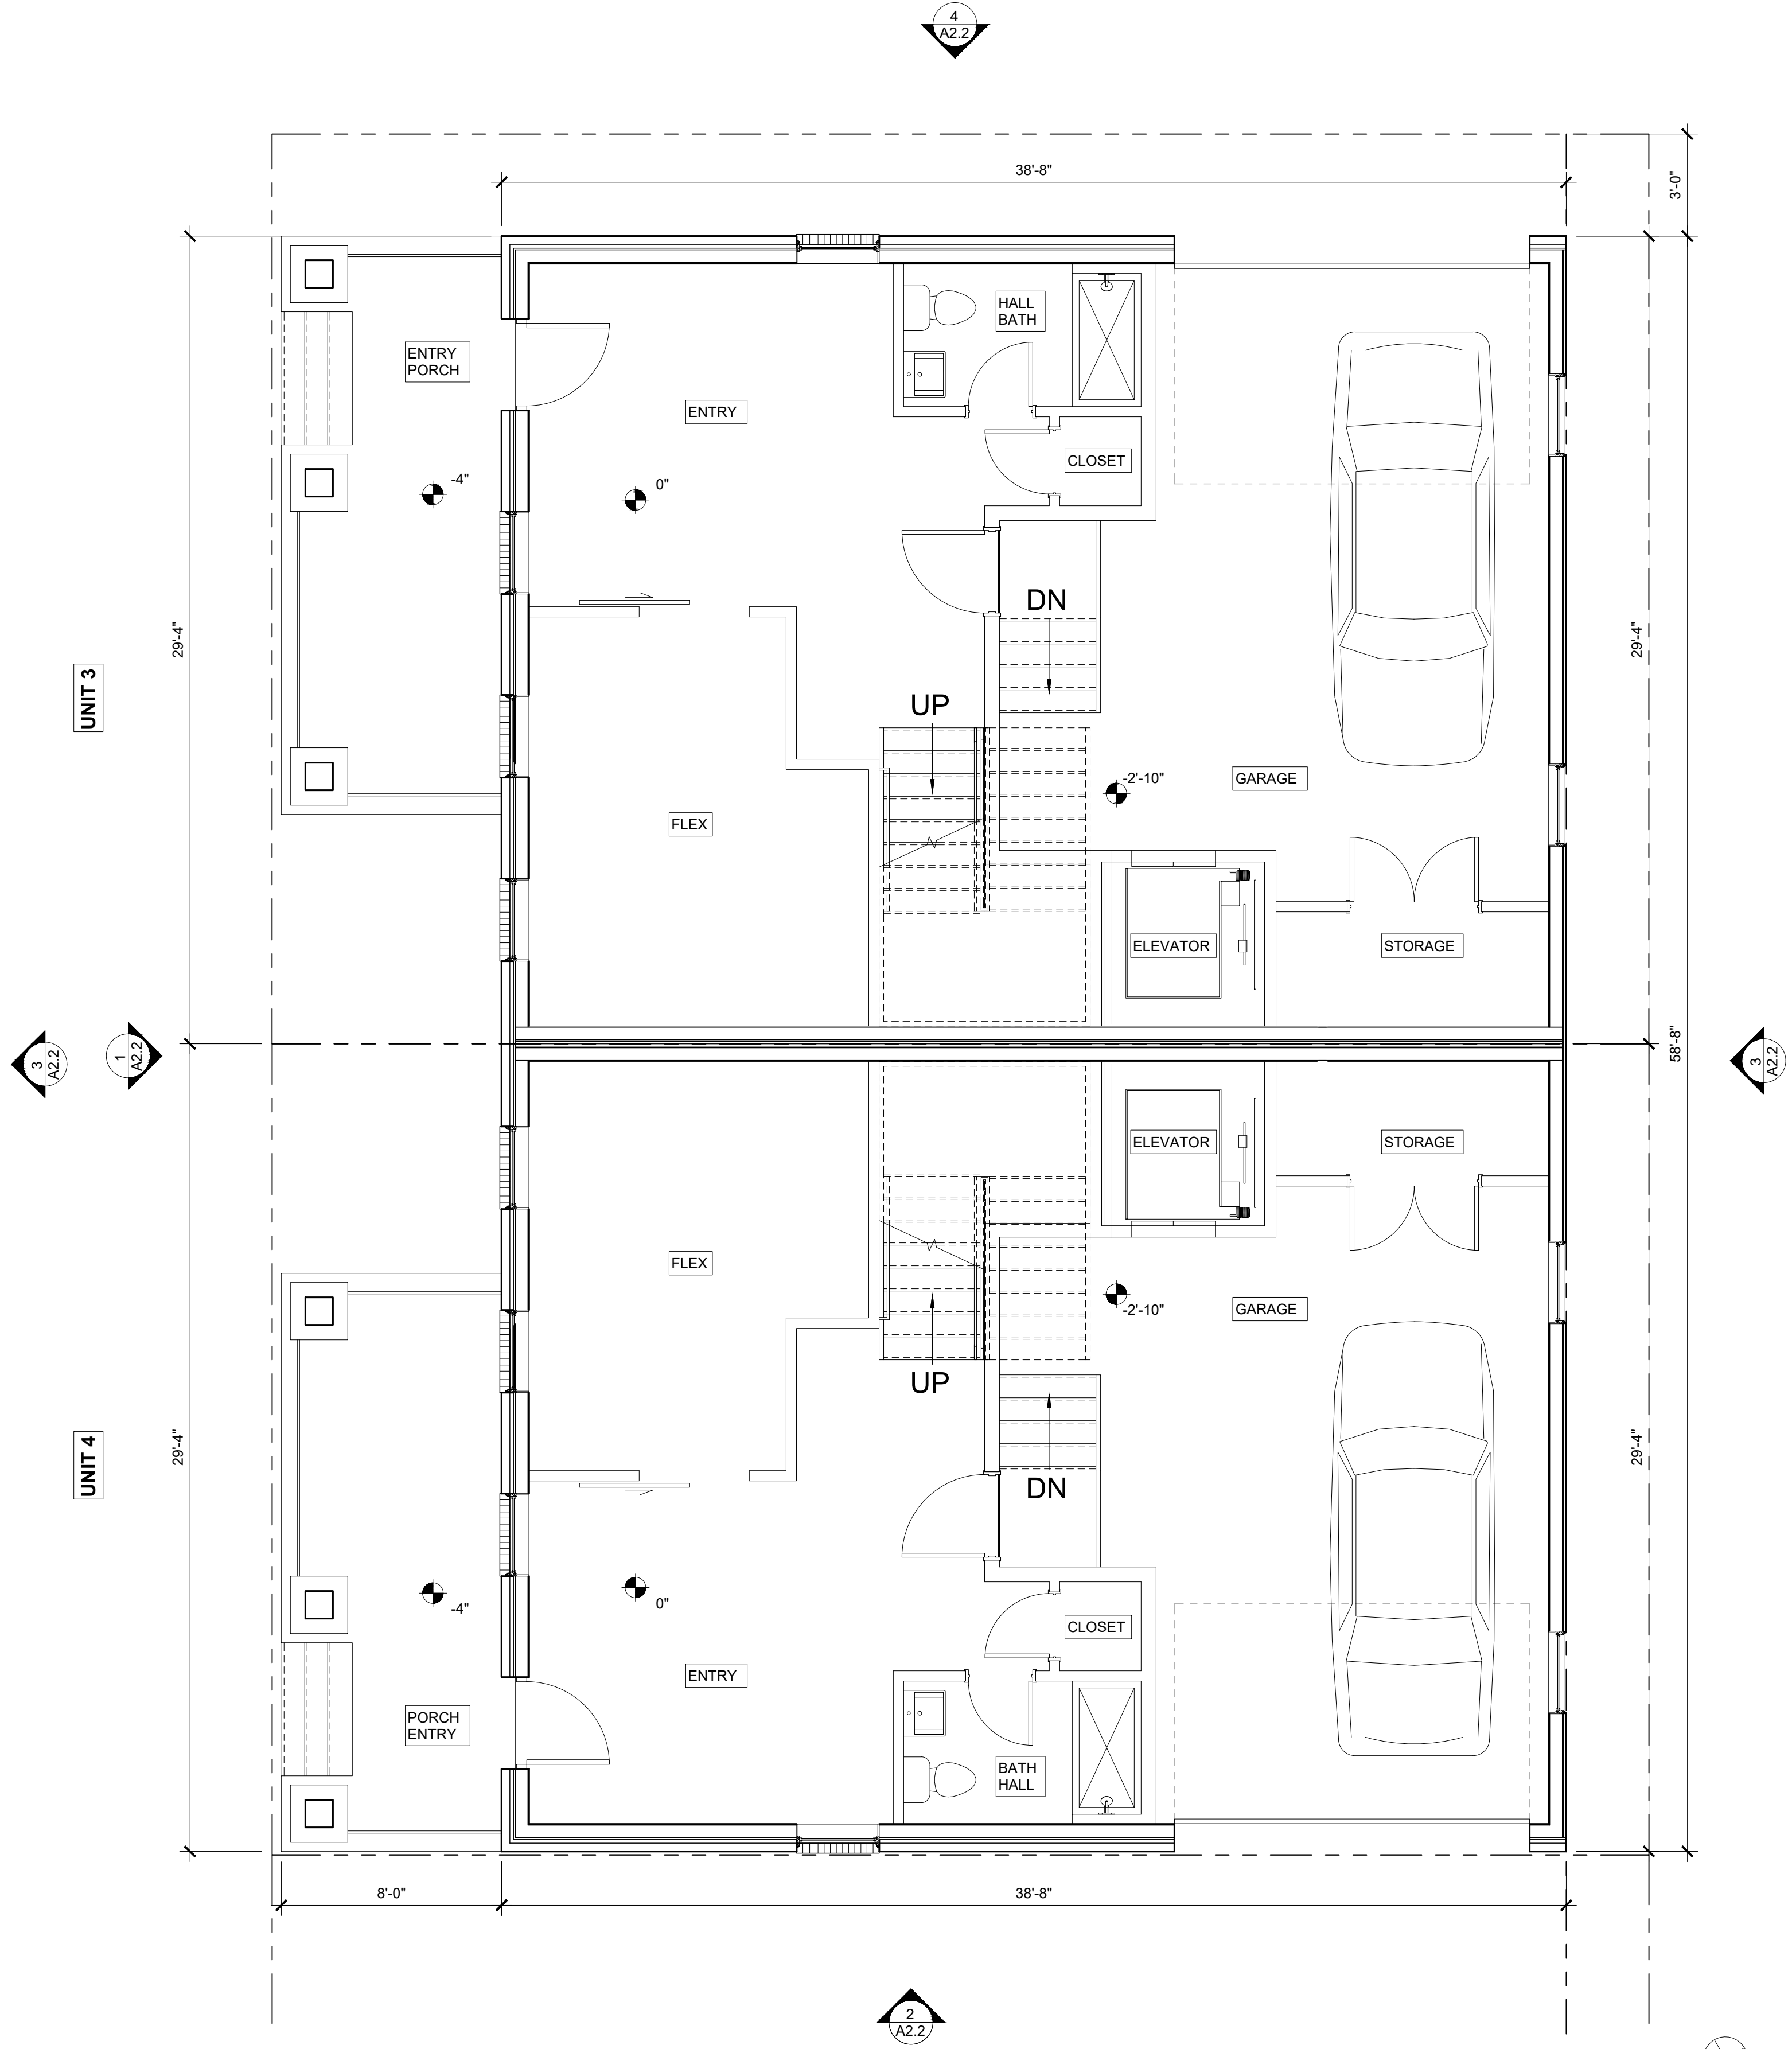




LEVEL 2 - CONSTRUCTION PLAN - TILDEN

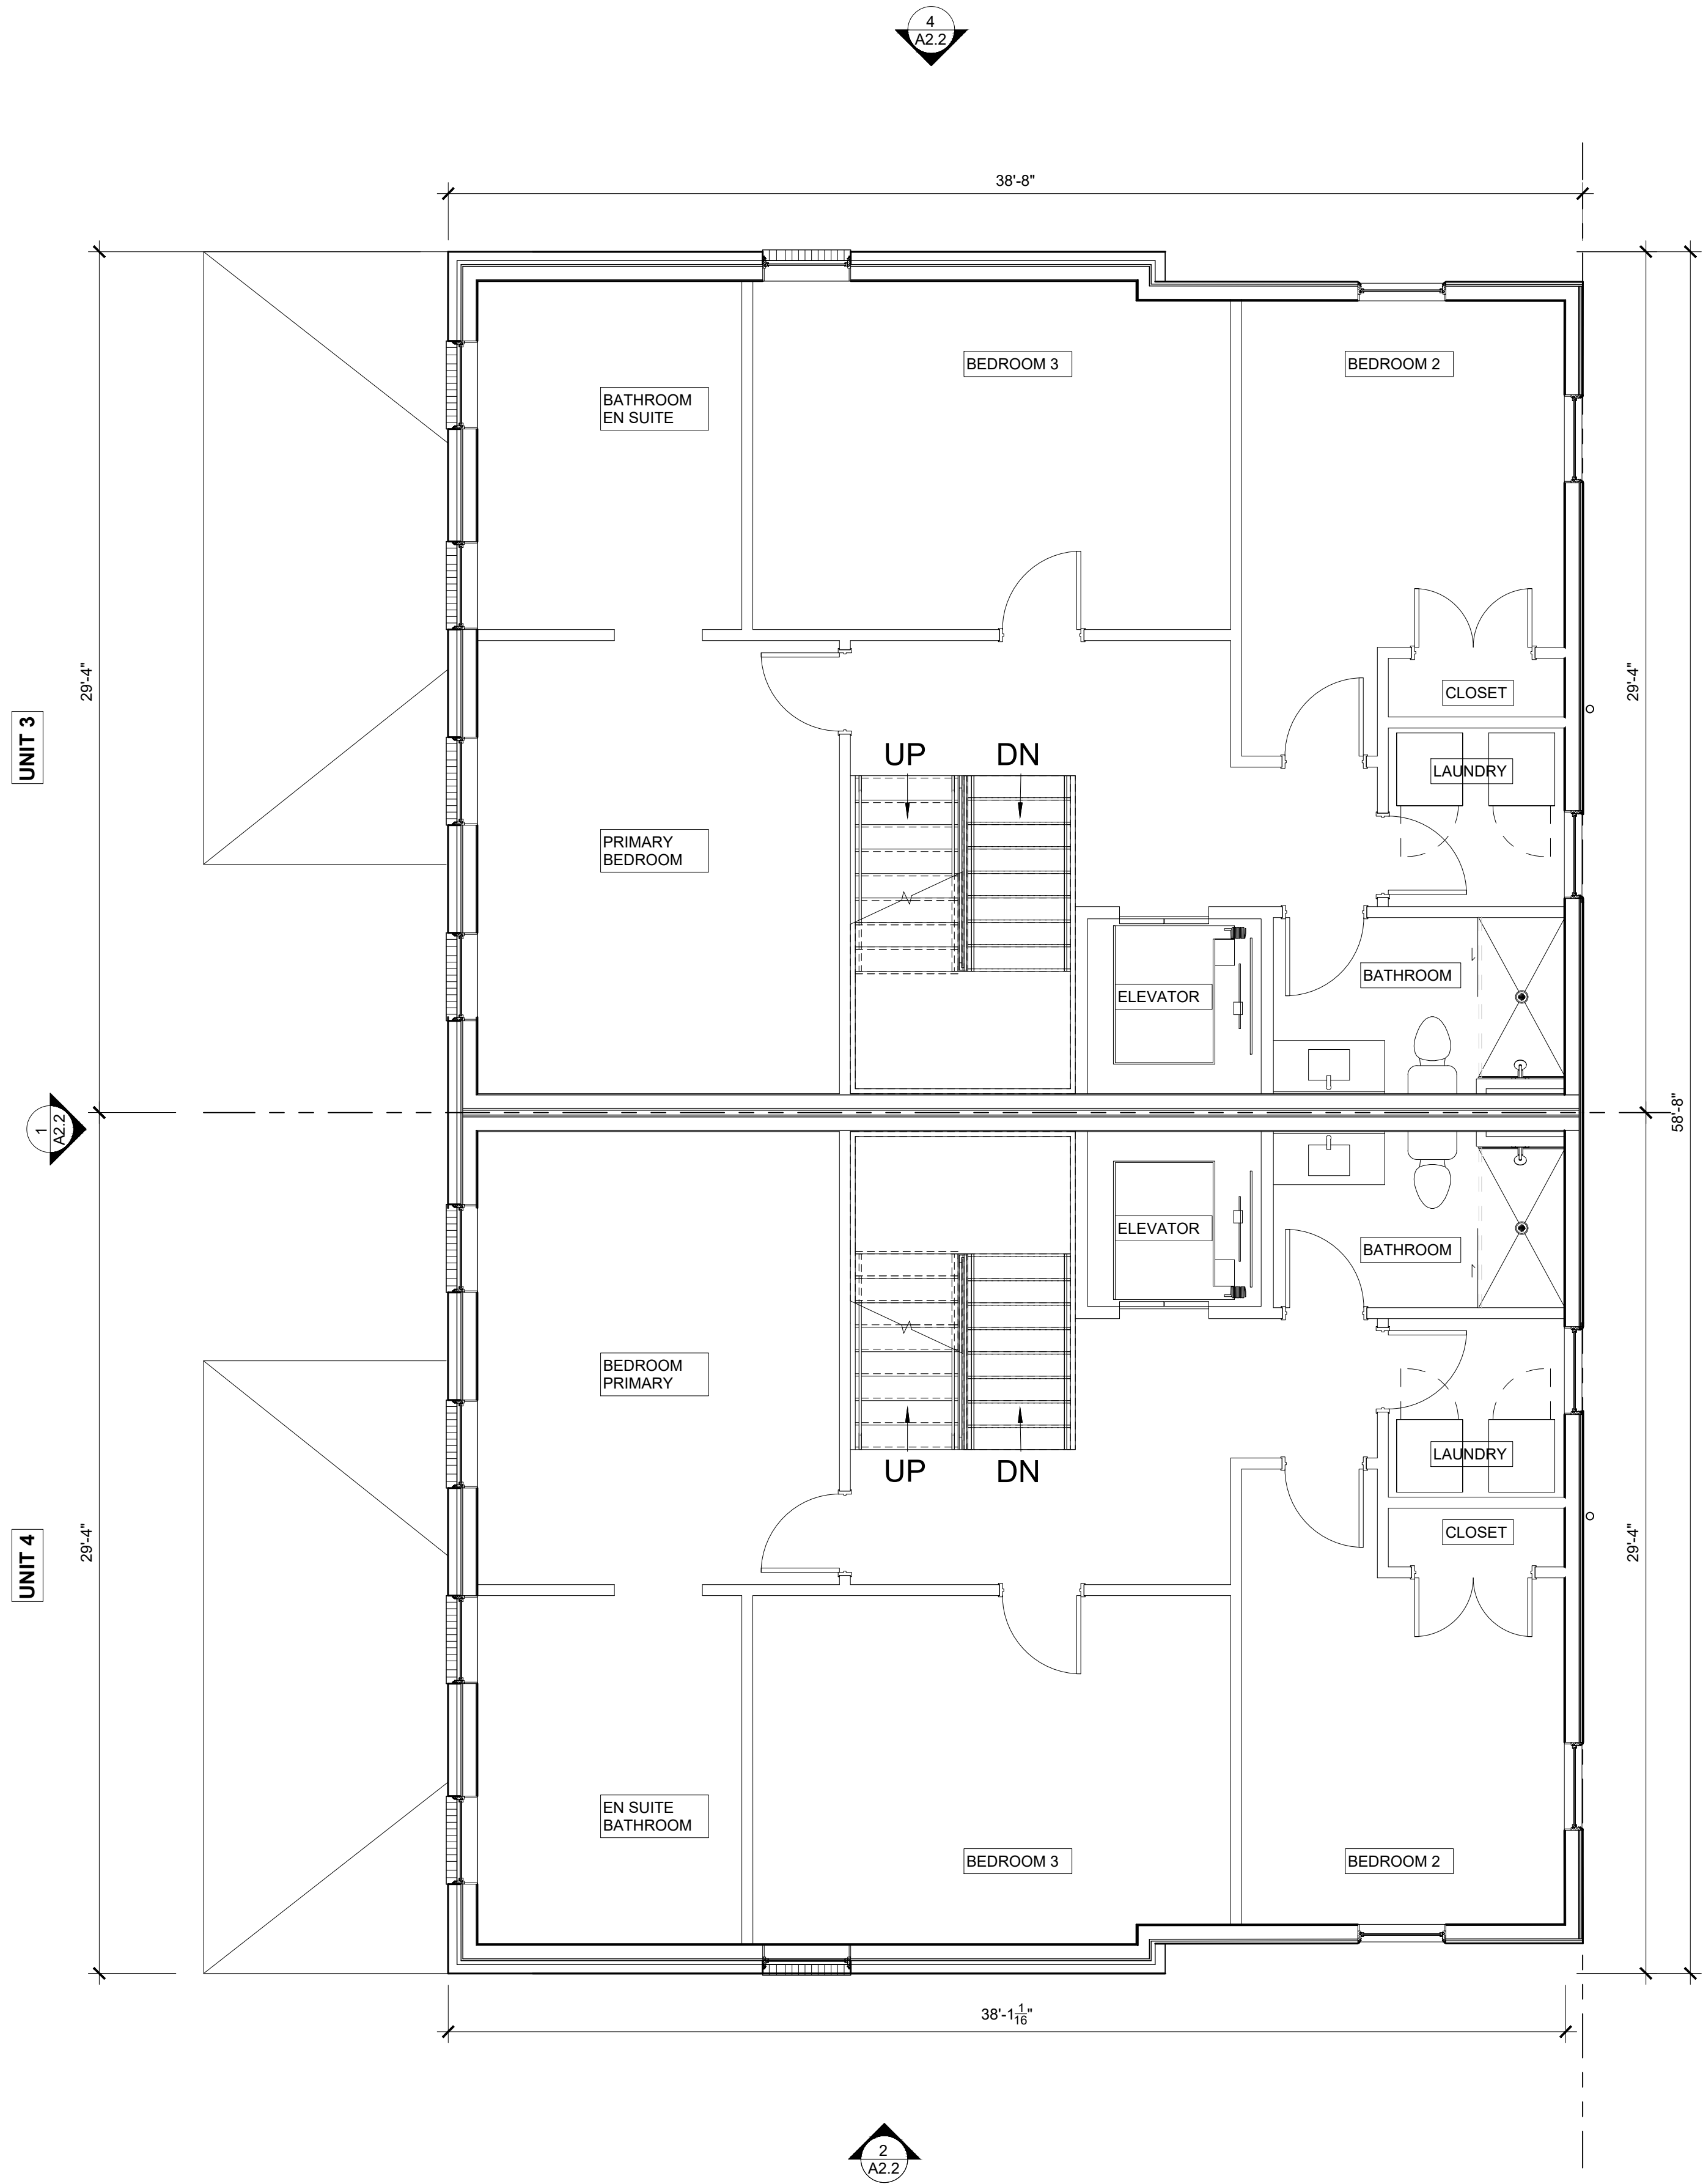1/4" = 1'-0"

2



LEVEL 1 - CONSTRUCTION PLAN -TILDEN

1/4" = 1'-0"

1





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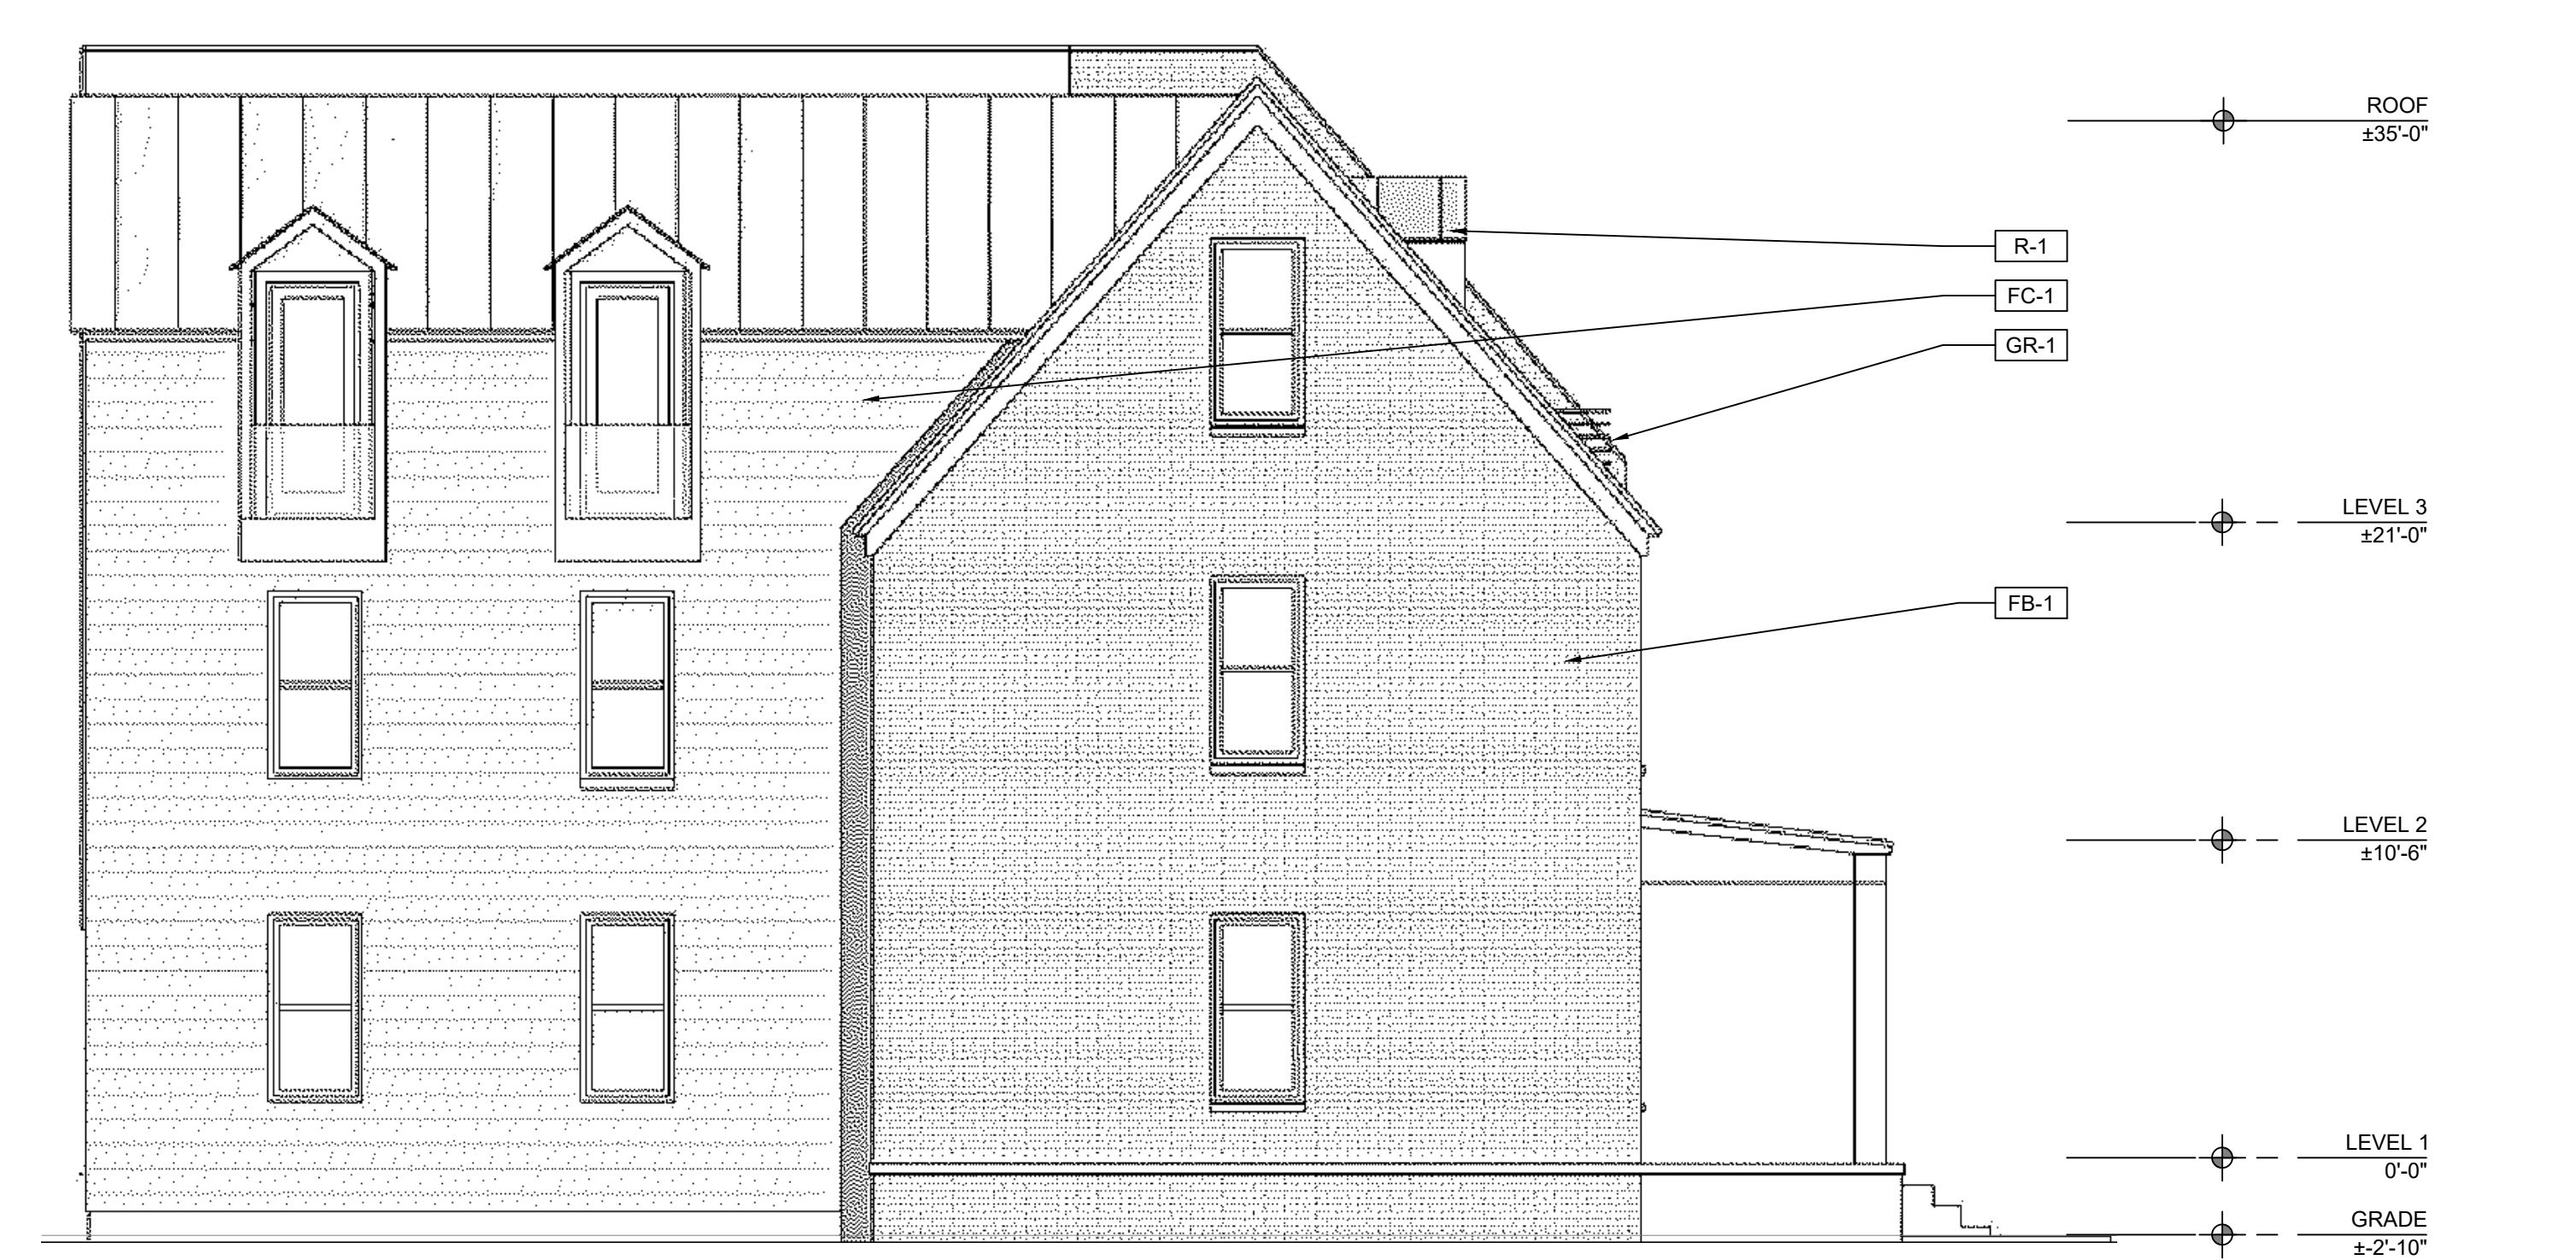
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A. 1.4





EXTERIOR FINISHES SCHEDULE			
TAG	DESCRIPTION	BASIS OF DESIGN	REMARKS
FB-1	FACE BRICK	MODULAR	FINAL COLOR: TBD
FC-1	FIBER CEMENT	LAP SIDING OR PANELIZED REVEAL SYSTEM: SMOOTH , PRIMED FOR PAINT, ALUMINUM TRIM, TYP	SEE DETAILS
GR-1	GUARD RAIL SYSTEM	ALUMINUM GUARDRAIL SYSTEM	SEE DETAILS FOR PROFILE(S), COLOR TO BE SELECTED FROM MFR FULL RANGE
PC-1	PRECAST COPING		SEE DETAILS FOR PROFILE(S), COLOR TO BE SELECTED FROM MFR FULL RANGE
R-1	ROOFING	STANDING SEAM OR COMPOSITE	FINAL COLOR: TBD



EAST ELEVATION | TILDEN STREET FRONTAGE - PARK  
3/16" = 1'-0"

4



WEST ELEVATION | PARK  
3/16" = 1'-0"

2




SOUTH ELEVATION | PARK  
3/16" = 1'-0"

3



NORTH ELEVATION | PARK AVE STREET FRONTAGE ELEVATION  
3/16" = 1'-0"

1

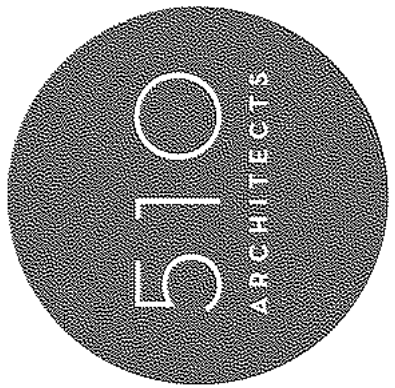

PROGRESS SET  
NOT FOR  
CONSTRUCTION

# PARK & TILDEN ROWHOUSES

## NEW CONSTRUCTION


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EXTERIOR  
ELEVATIONS  
A 2.1



EXTERIOR FINISHES SCHEDULE			
TAG	DESCRIPTION	BASIS OF DESIGN	REMARKS
FB-1	FACE BRICK	MODULAR	FINAL COLOR: TBD
FC-1	FIBER CEMENT	LAP SIDING OR PANELIZED REVEAL SYSTEM: SMOOTH , PRIMED FOR PAINT, ALUMINUM TRIM, TYP	SEE DETAILS
GR-1	GUARD RAIL SYSTEM	ALUMINUM GUARDRAIL SYSTEM	SEE DETAILS FOR PROFILE(S), COLOR TO BE SELECTED FROM MFR FULL RANGE
PC-1	PRECAST COPING		SEE DETAILS FOR PROFILE(S), COLOR TO BE SELECTED FROM MFR FULL RANGE
R-1	ROOFING	STANDING SEAM OR COMPOSITE	FINAL COLOR: TBD



SOUTH ELEVATION | ALLEY - TILDEN

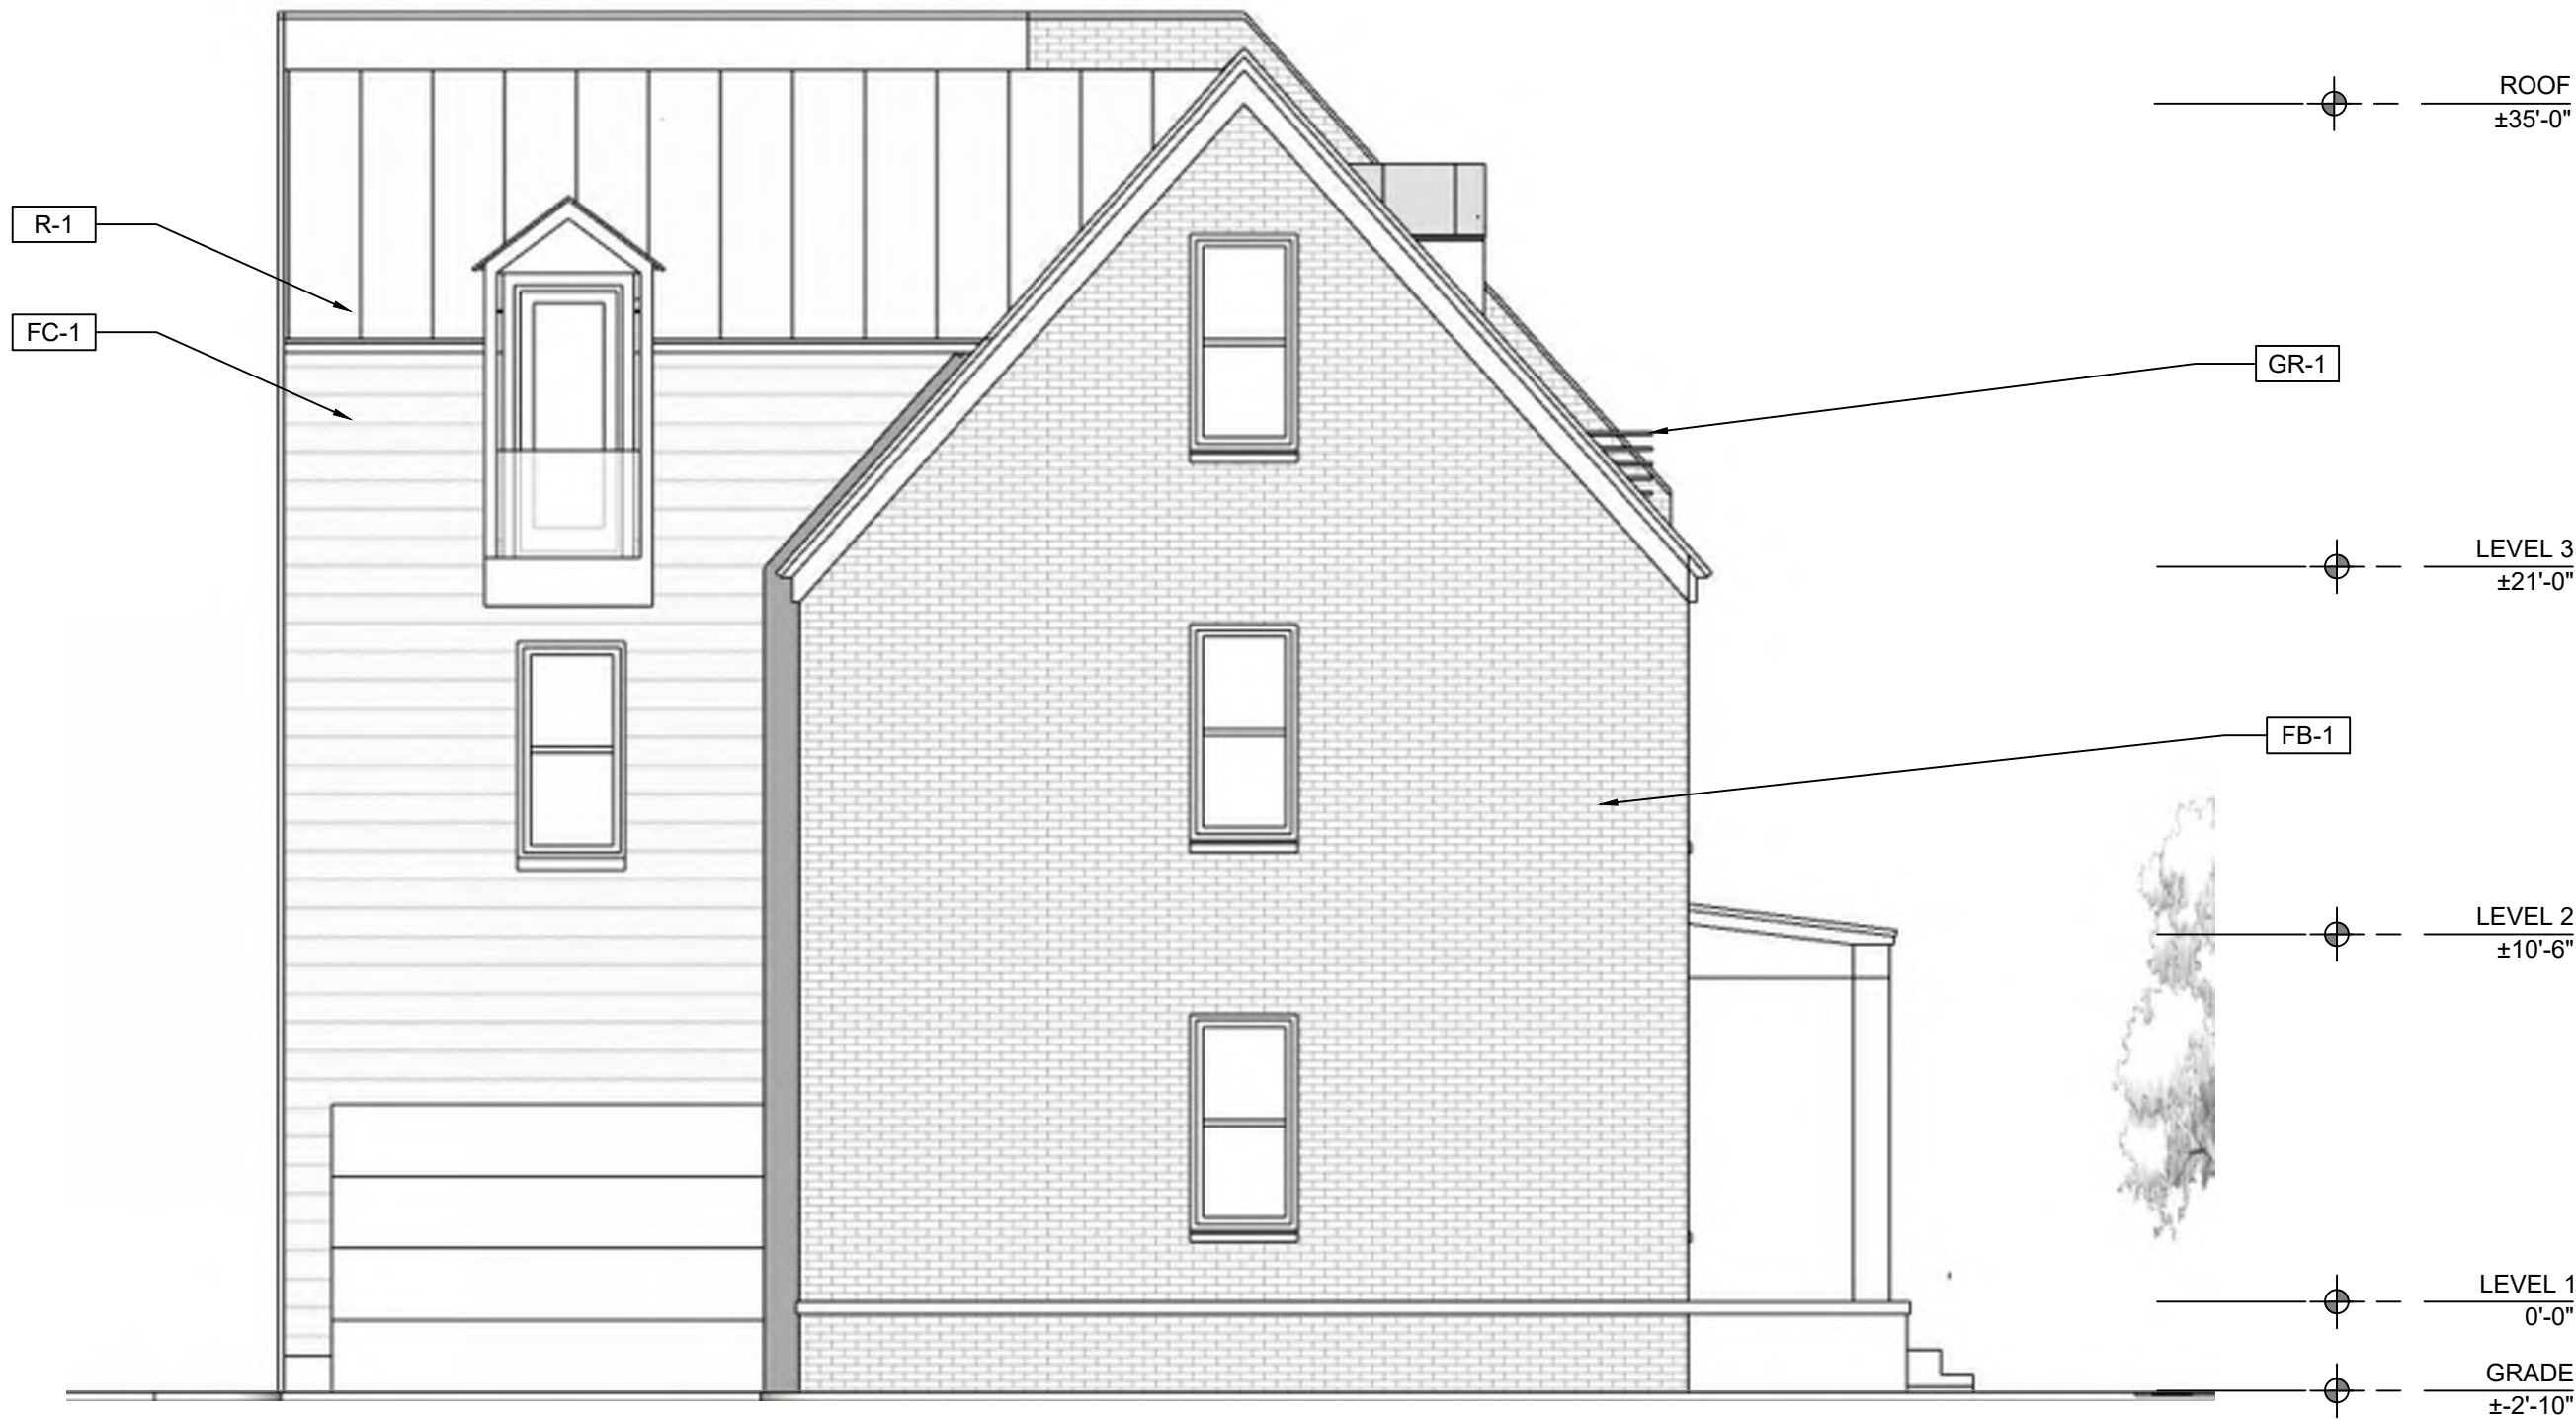3/16" = 1'-0"


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NORTH ELEVATION | TILDEN

3/16" = 1'-0"

2



WEST ELEVATION | TILDEN

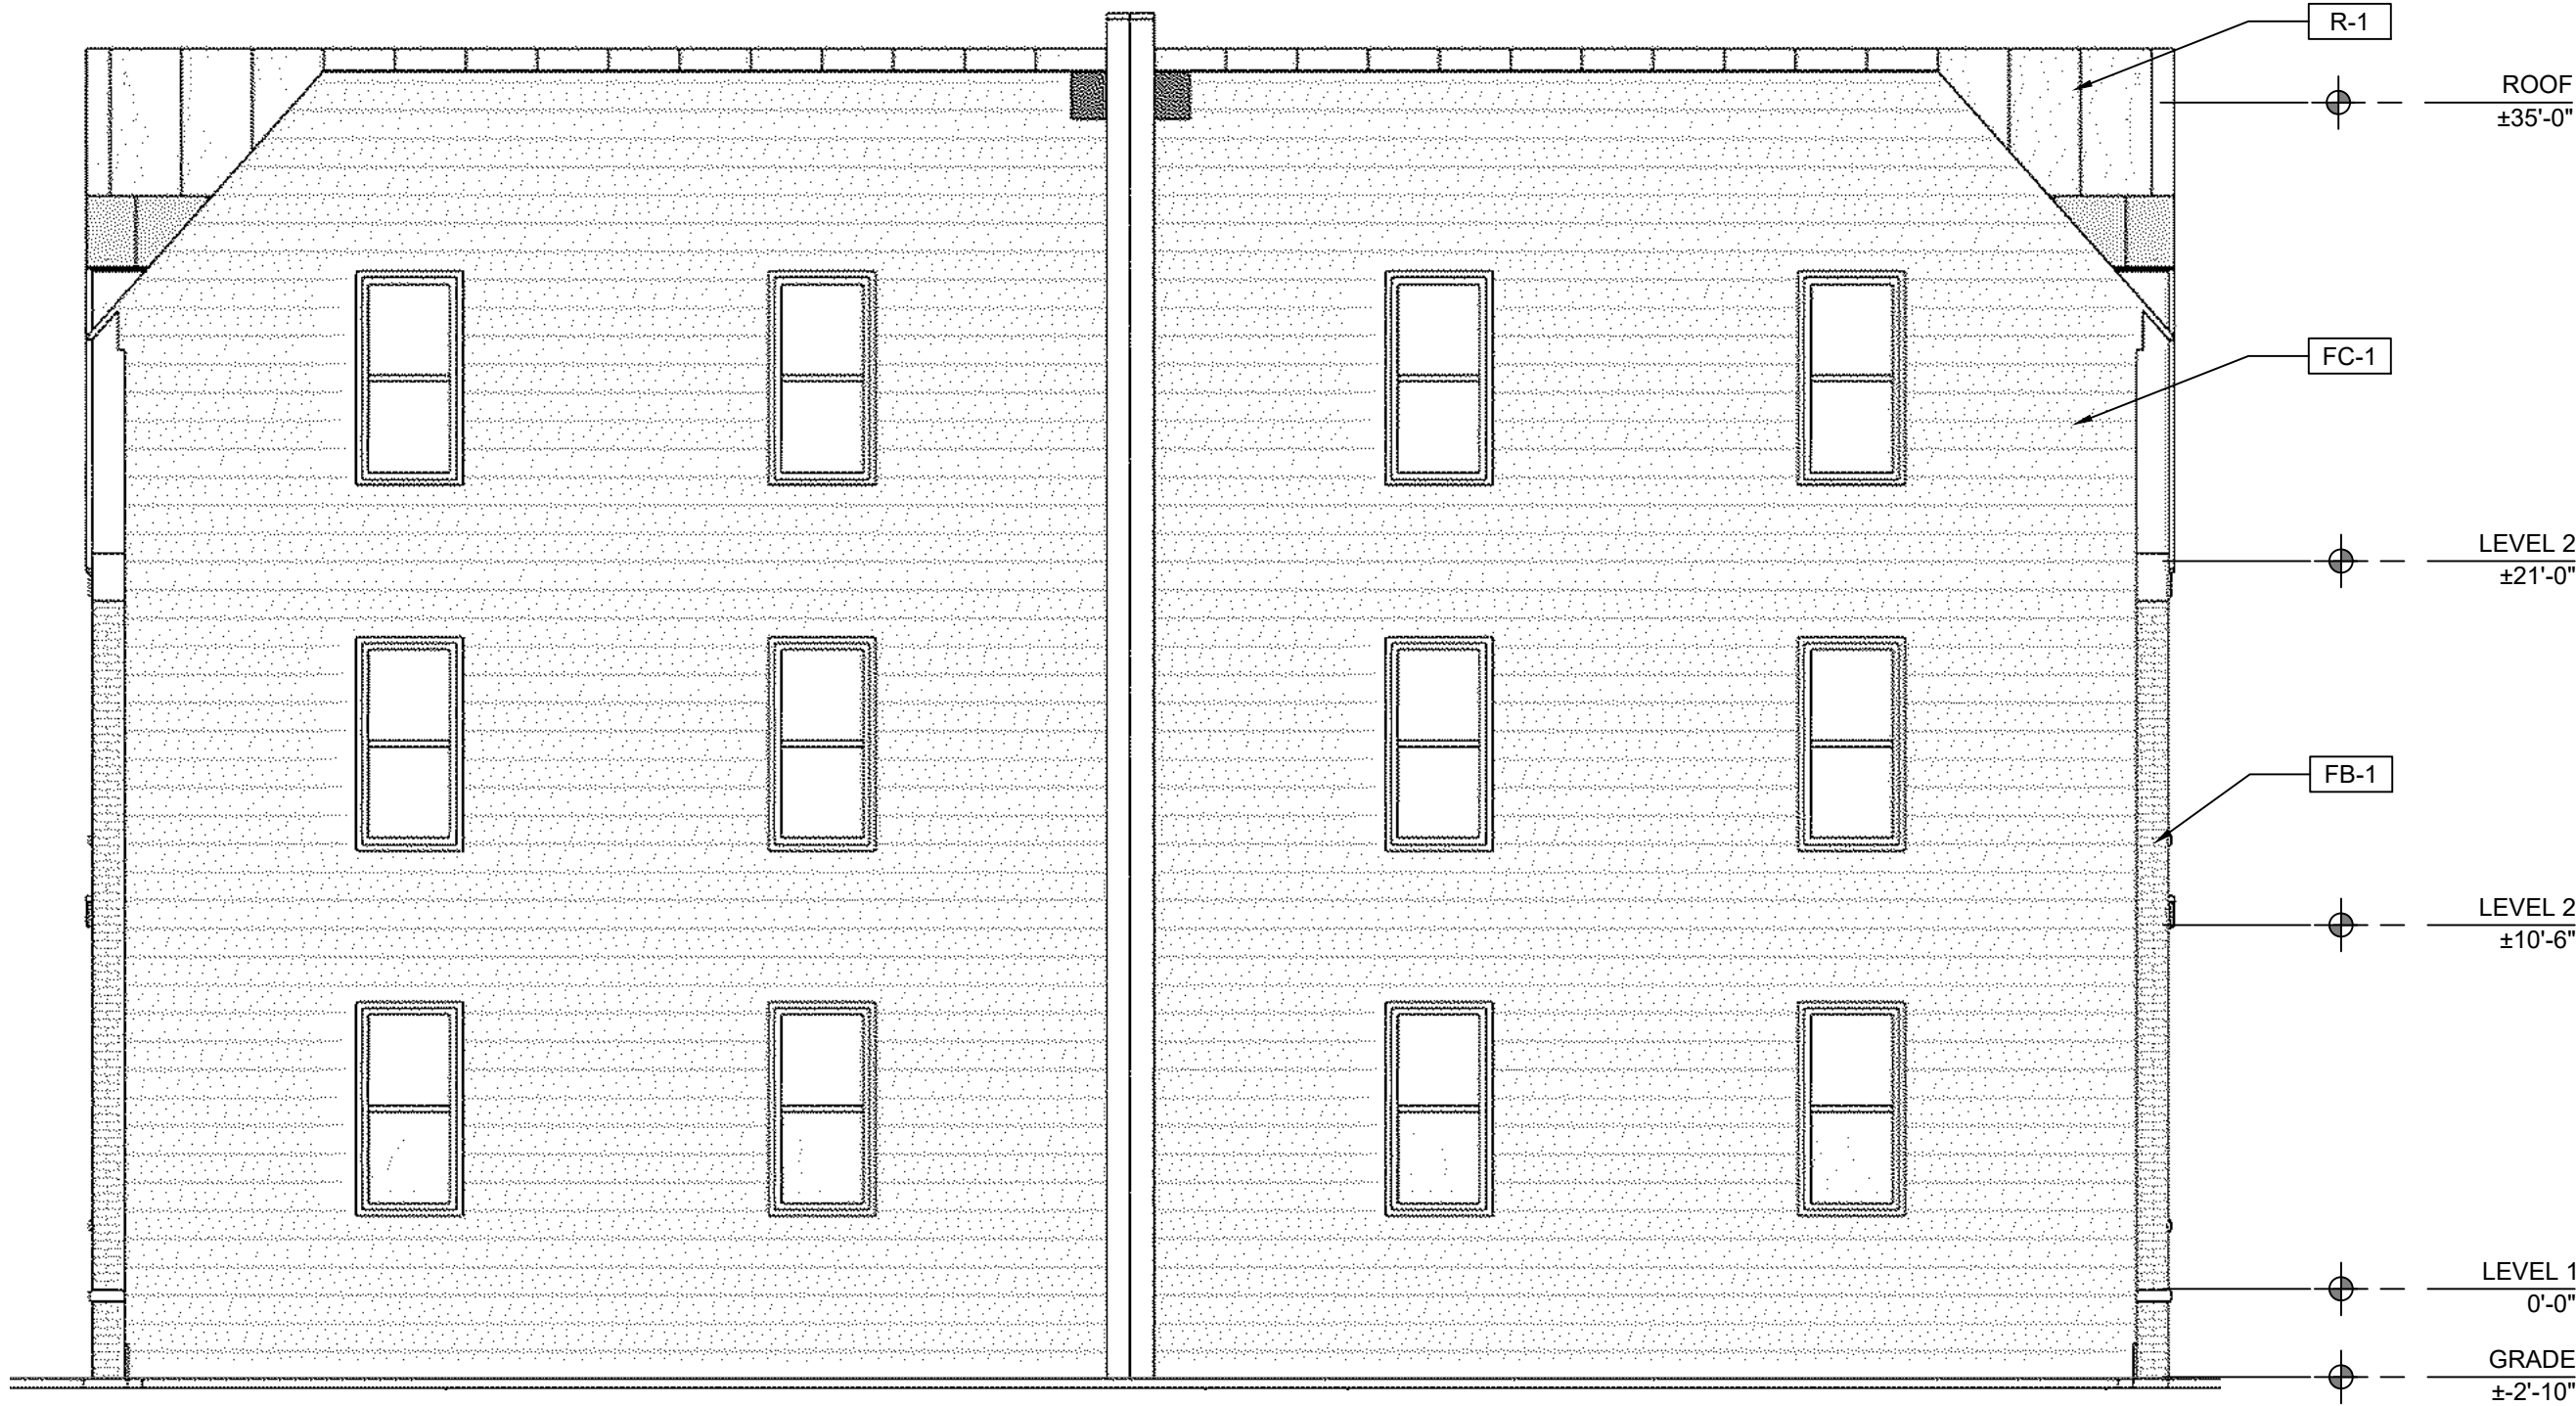3/16" = 1'-0"


3



EAST ELEVATION | TILDEN STREET FRONTAGE - TILDEN

3/16" = 1'-0"

1

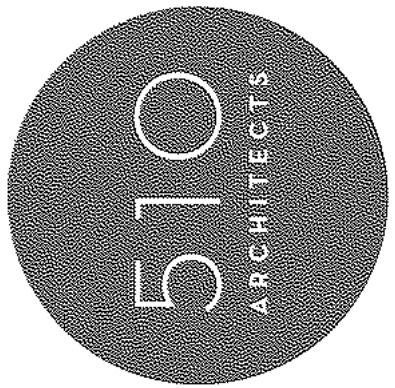

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EXTERIOR  
ELEVATIONS  
A 2.2