4704 GROVE AVENUE SPECIAL USE PERMIT REQUEST CITY OF RICHMOND, VIRGINIA

LATITUDE: 37.5496655 LONGITUDE: -77.4071675

VAHU6 WATERSHED CODE: JL01

ROAD & DRAINAGE

CULVERT OR STORM SEWER

DROP INLET

JUTE MESH OR SODDED DITCH

---105--- EXISTING MAJOR CONTOUR

---101 --- EXISTING MINOR CONTOUR

+ 95.25 EXISTING SPOT ELEVATION

ELEVATION

95 — PROPOSED MAJOR CONTOUR

94)—— PROPOSED MINOR CONTOUR

SSWL SINGLE SOLID WHITE LINE

SSYL SINGLE SOLID YELLOW LINE

SDWL SINGLE DASHED WHITE LINE

DSYL DOUBLE SOLID YELLOW LINE

PROPOSED SPOT ELEVATION

PROPOSED TOP OF CURB

EARTHEN, GRASSED LINED DITCH

PAVED DITCH

(WITH STRUCTURE NO.)

EXISTING STORM SEWER

(WITH STRUCTURE NO.)

PROPOSED DRAINAGE MANHOLE

EXISTING DRAINAGE MANHOLE

SITE LOCATION MAP: 1" = 2000'

1. EROSION CONTROL 2. SEWER:

PLANNING COMMISSION APPROVAL DATE:

APPLICANT'S NAME: CAVA CAPITAL LLC

3. WATER: 4. ROAD & DRAINAGE:

REVISION DATE

ZONING & CASE #: R-5

CITY APPROVAL

INDEX TO SHEETS

DESCRIPTION

REQUIRED UTILITY NOTES

- ALL MATERIALS FOR SEWER & WATER SYSTEMS SHOWN SHALL BE SUPPLIED AND INSTALLED IN ACCORDANCE WITH THE LATEST SPECIFICATIONS OF THE LOCAL AGENCY APPLICABLE AT THE TIME OF NOTICE TO PROCEED. WATER LINES ARE TO BE CLASS 150 PIPE WITH CAST IRON FITTINGS WITH RING - TIGHT BELL CONFORMING TO ASA2110 AND AWWA

- ALL WATER METERS WHOSE ELEVATION IS AT 122.00 OR BELOW WILL REQUIRE INDIVIDUAL PRESSURE REGULATORS TO BE INSTALLED
- ON THE CUSTOMERS SIDE OF THE WATER METER. DATUM FOR ALL ELEVATIONS IS NAVD88.
- ALL WORK SHALL BE DONE IN ACCORDANCE WITH THE CURRENT SANITARY SEWER SPECIFICATIONS OF THE CITY OF RICHMOND. ALL WORK SHALL BE SUBJECT TO INSPECTION BY CITY OF RICHMOND INSPECTORS. IT SHALL BE THE CONTRACTOR'S RESPONSIBILITY TO NOTIFY THE PROPER COUNTY OFFICIALS 48 HOURS PRIOR TO START OF WORK. A PRECONSTRUCTION MEETING BETWEEN CONTRACTOR AND ENGINEER WILL BE MANDATORY.
- GRADE STAKES WILL BE SET BY TOWNES P.C. COPIES OF CUT SHEETS WILL BE SENT TO THE CITY OF RICHMOND. PIPE STRENGTHS TO BE AS FOLLOWS:
- A. PVC ASTM D3034, SDR 35. B. EXCEPT AS SHOWN ON PROFILE.
- 18. ALL MANHOLES TO BE PRECAST CONCRETE
- JOB SHALL BE BID ON A UNIT PRICE BASIS. ALL EXCAVATION SHALL BE UNCLASSIFIED. EXISTING UTILITIES WHERE SHOWN, ARE APPROXIMATE ONLY. CONTRACTOR SHALL VERIFY ALL SUCH LOCATIONS BEFORE START OF
- ALL PIPE BEDDING TO BE CLASS B EXCEPT AS SHOWN FOR PLASTIC PIPE.
- 22. ALL SANITARY SEWER LINES WITH LESS THAT 6' OF COVER WILL BE MADE OF DUCTILE IRON PIPE IF WITHIN A RIGHT OF WAY.

EROSION AND SEDIMENT CONTROL NOTES

- Soil Erosion and Sediment Control shall be per the current edition of the Virginia Erosion and Sediment Control Handbook. Sediment basins and traps, perimeter dikes, sediment barriers, and other measures intended to trap sediment on-site, must be constructed as a first step in grading and be made functional before upslope land disturbance takes place. Stabilization measures shall be applied to earthen structures such as dams, dikes, and diversions immediately after installation. Permanent or temporary soil stabilization shall be applied to denuded areas within seven (7) days after final grade is reached on any
- enter the conveyance systems without first being filtered or otherwise treated to remove sediment.
- 6. The Department of Planning shall make a continuing review and evaluation of the erosion and sediment control methods used and the overall effectiveness of the erosion control program and shall direct changes to be made if deemed necessary.

SEEDING SCHEDULE

ALL CUT AND FILL SLOPES AND CHANNELSIDE SLOPES WHICH ARE NOT TO BE PAVED SHALL BE SEEDED UNTIL A GOOD STAND OF GRASS IS OBTAINED IN ACCORDANCE WITH THE FOLLOWING:

- A. 100 LBS PER 1,000 SQ. FT. GROUND LIMESTONE OR EQUIVALENT
- B. 20 LBS. OF 10-10-10 FERTILIZER OR EQUIVALENT PER 1,000 SQ. FT.
- C. VARIETIES TO BE SEEDED: SPRING SEEDING: MARCH 1 THROUGH APRIL 30; SPRING OATS (2.5 LBS. PER 1,000 SQ. FT.) SUMMER SEEDING: MAY 1 THROUGH AUGUST 1; WEEPING LOVE GRASS AT (2 OZ. PER 1,000 SQ. FT. MIXED WITH 1
- BUSHEL SAWDUST FOR UNIFORM SEEDING. AUTUMN SEEDING: AUGUST 1 THROUGH NOVEMBER 15; TALL FESCUE (KY 31) AT (1.5 LBS. PER 1,000 SQ. FT.)

NOTE: THE "CITY INSPECTOR" FOR E & S ISSUES IS THE DIRECTOR OF PLANNING. THE "CITY INSPECTOR" FOR PUBLIC WORKS AND PUBLIC UTILITIES ISSUES IS THE DIRECTOR OF PUBLIC WORKS OR HIS REPRESENTATIVE.

GENERAL EROSION AND SEDIMENT CONTROL NOTES

- ES-1: UNLESS OTHERWISE INDICATED, ALL VEGATATIVE AND STRUCTURAL EROSION AND SEDIMENT CONTROL PRACTICES WILL BE CONSTRUCTED AND MAINTAINED ACCORDING TO MINIMUM STANDARDS AND SPECIFICATIONS OF THE VIRGINIA EROSION AND SEDIMENT CONTROL HANDBOOK AND VIRGINIA REGULATIONS VR 625-05-00 EROSION AND SEDIMENT CONTROL REGULATIONS.
- THE PLAN APPROVING AUTHORITY MUST BE NOTIFIED ONE WEEK PRIOR TO THE PRE-CONSTRUCTION CONFERENCE, ONE WEEK PRIOR TO THE COMMENCEMENT OF LAND DISTURBING ACTIVITY, AND ONE WEEK PRIOR TO FINAL INSPECTION.
- ES-3: ALL EROSION AND SEDIMENT CONTROL MEASURES ARE TO BE PLACED PRIOR TO OR AS THE FIRST STEP ON CLEARING.
- A COPY OF THE APPROVED EROSION AND SEDIMENT CONTROL PLAN SHALL BE MAINTAINED ON THE SITE AT ALL TIMES.
- PRIOR TO COMMENCING LAND DISTUBING ACTIVITIES IN AREAS OTHER THAN INDICATED ON THESE PLANS (INCLUDING, BUT NOT LIMITED TO, OFF-SITE BORROW OR WASTE AREAS), THE CONTRACTOR SHALL SUBMIT A SUPPLEMENTARY EROSION CONTROL PLAN TO THE OWNER FOR REVIEW AND APPROVAL BY THE PLAN
- THE CONTRACTOR IS RESPONSIBLE FOR INSTALLATION OF ANY ADDITIONAL EROSION CONTROL MEASURES NECESSARY TO PREVENT EROSION AND SEDIMENTATION AS DETERMINED BY THE PLAN APPROVING AUTHORITY.
- ALL DISTURBED AREAS ARE TO DRAIN TO APPROVED SEDIMENT CONTROL MEASURES AT ALL TIMES DURING LAND DISTURBING ACTIVITIES AND DURING SITE DEVELOPMENT UNTIL FINAL STABILIZATION IS ACHIEVED.
- DURING DEWATERING OPERATIONS, WATER WILL BE PUMPED INTO AN APPROVED FILTERING DEVICE. THE CONTRACTOR SHALL INSPECT ALL EROSION CONTROL MEASURES
- PERIODICALLY AND AFTER EACH RUNOFF-PRODUCING RAINFALL EVENT. ANY NECESSARY REPAIRS OR CLEANUP TO MAINTAIN THE EFFECTIVENESS OF THE EROSION CONTROL DEVICES SHALL BE MADE IMMEDITATELY. STATE AGENCIES SHALL MAKE A CONTINUING REVIEW AND EVALUATION OF THE METHOD USED

AND THE OVERALL EFFECTIVENESS OF THE EROSION CONTROL PLAN. THE APPROVED EROSION AND SEDIMENT CONTROL PLAN MAY BE AMENDED BY THE PLAN APPROVING AUTHORITY IF ON-SITE INSPECTION INDICATES THAT THE APPROVED CONTROL MEASURES ARE NOT EFFECTIVE IN CONTROLLING EROSION AND SEDIMENTATION OR BECAUSE OF CHANGED CIRCUMSTANCES THE PLAN CANNOT BE CARRIED OUT.

PERMANENT OR TEMPORARY SOIL STABILIZATION SHALL BE APPLIED TO DENUDED AREAS WITHIN SEVEN DAYS AFTER FINAL GRADE IS REACHED ON ANY PORTION OF THE SITE. TEMPORARY SOIL STABILIZATION SHALL BE APPLIED WITHIN SEVEN DAYS TO DENUDED AREAS THAT MAY NOT BE AT FINAL GRADE BUT WILL REMAIN DORMANT (UNDISTURBED) FOR LONGER THAN 30 DAYS. PERMANENT STABILIZATION SHALL BE APPLIED TO AREAS THAT ARE TO BE LEFT DORMANT FOR MORE THAN ONE YEAR.

SITE SUMMARY AND NOTES

1. OWNER / DEVELOPERCAVA CAPITAL LLC

RECEIVING CHANNEL / WATERS: JAMES RIVER

- PARCEL ID'S W0190273012 SITE ADDRESS . 4704 GROVE AVENUE
- R-5 (RESIDENTIAL SINGLE FAMILY) ZONING . SITE AREA . ..0.075 ACRES
- 6. WATER .. . PUBLIC
- SEWER. **PUBLIC** 8. THIS SITE IS LOCATED WITHIN A 100-YEAR FEMA DEFINED FLOOD PLAIN ZONE X PER COMMUNITY PANEL
- NUMBER 5101290009D, EFFECTIVE DATE APRIL 2, 2009 9. THERE ARE NO WETLANDS LOCATED ON THIS SITE.
- 10. ALL PROPOSED UTILITIES ARE TO BE INSTALLED UNDERGROUND INCLUDING TELEPHONE. CATV. AND GAS.
- 11. ALL EXCESS MATERIAL SHALL BE REMOVED FROM THE SITE.
- 12. CONSTRUCTION TRAFFIC INGRESS/EGRESSS SHALL BE RESTRICTED TO FRONTAGE ROAD ENTRANCE ONLY.

LEGEND

SEWER

---SS-- EXISTING SANITARY SEWER

SANITARY SEWER LATERAL

→ SS → PROPOSED SANITARY SEWER

1 N: 3612745.34 SEWER MANHOLE # WITH STATION & COORDINATE LOCATION

WATER

— W — PROPOSED WATERLINE SERVICE

FIRE HYDRANT ASSEMBLY

TEE OR TAPPING SLEEVE

BLIND CAP & FLUSHING HYDRANT

— W — EXISTING WATERLINE

---- W ----- PROPOSED WATERLINE

PROPOSED GATE VALVE

► REDUCER

PROPOSED SEWER MANHOLE

EXISTING SEWER MANHOLE

EROSION CONTROL

EROSION CONTROL DEVICES AS PER VIRGINIA

(S.A.F.) — O SAFETY FENCE

XX SILT FENCE

 $\frac{D.D.}{3.09}$ \rightarrow DIVERSION DIKE

EROSION AND SEDIMENT CONTROL HANDBOOK

CONSTRUCTION ENTRANCE

CULVERT INLET PROTECTION

INLET PROTECTION

COVER SHEET SITE LAYOUT

1704 CIAL CITY (Ш

> DATE: APRIL 11, 2022 SCALE: N/A

PROJECT NUMBER:

DESIGN TEAM: CHARLES C. TOWNES, II, P.E., L.S. PROJECT MANAGER T.S.G.

CHECKED BY:

DRAWN BY:

REVISIONS: 4/21/2022 CLIENT COMMENTS

CONTACT INFORMATION

PROJECT NAME

4704 GROVE AVENUE

DEVELOPER NAME: CAVA CAPITAL LLC ADDRESS: 5310 MARKEL ROAD SUITE 104 RICHMOND, VIRGINIA 23230

CONTACT PERSON: AMANDA SCHWARTZ

TELEPHONE: (804) 385-6587 FACSIMILE:

SHEET

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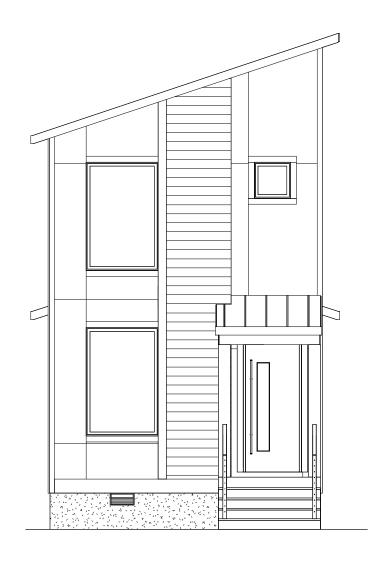
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CAVA COMPANIES

AREA CALCULATIONS


Heated Area	
1st Floor Livable	905 SF
2nd Floor Livable	899 SF
	1804 SF
Unheated Area	
Front Porch	32 SF
Rear Porch	180 SF
	212 SF
Total	2016 SF





APPROVAL SET NOT FOR CONSTRUCTION



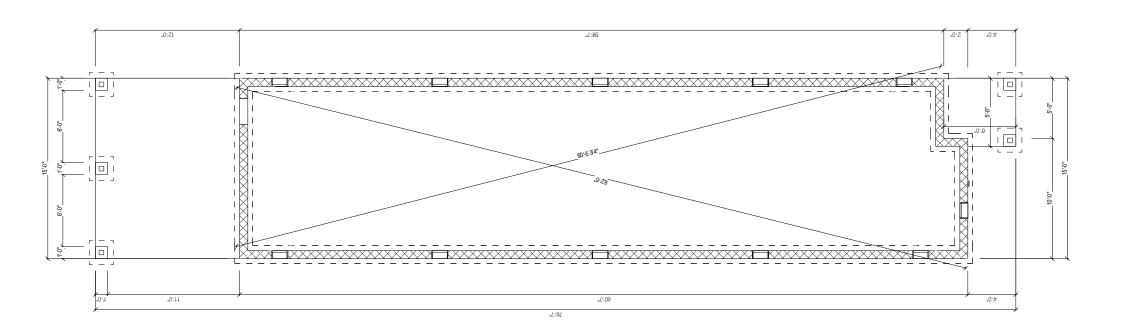

TOUNDATION PLAN

A.1

1/8" = 1-0" WHEN PRINTED ON 11"x.17" / ANSI B PAPER SIZ

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NEW CONSTRUCTION CAVA COMPANIES


SHEET
Foundation 4704 GROVE

PINNACLE

DESIGN

A-1



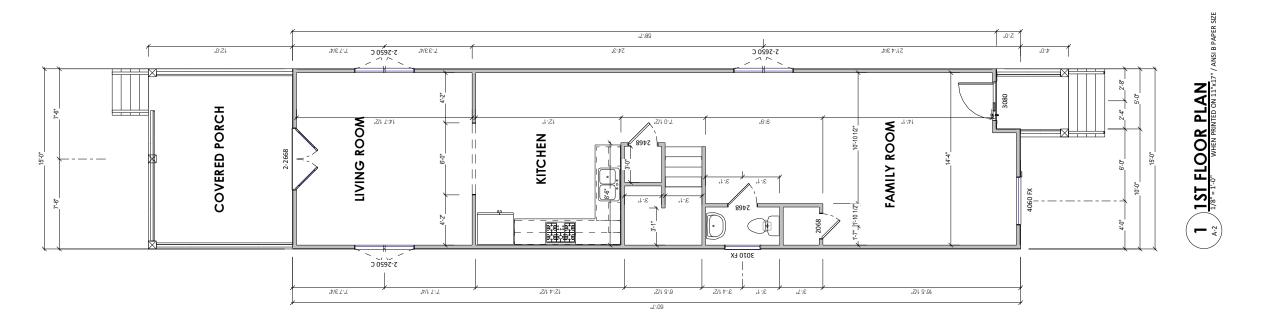

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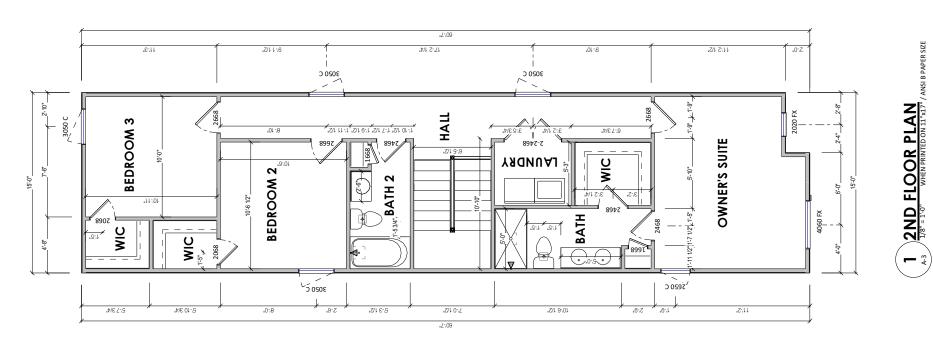
CAVA COMPANIES 4704 GROVE **NEW CONSTRUCTION** SHEET

1st Floor Plan ISSUE DATE 8/25/22

PINNACLE

DESIGN
SHEET NUMBER
A-2





NEW CONSTRUCTION CAVA COMPANIES

SHET

2nd Floor Plan

CAVA COMPANIES

ADDRESS

4704 GROVE

ISSUE DATE 8/25/22


PINNACLE

DESIGN
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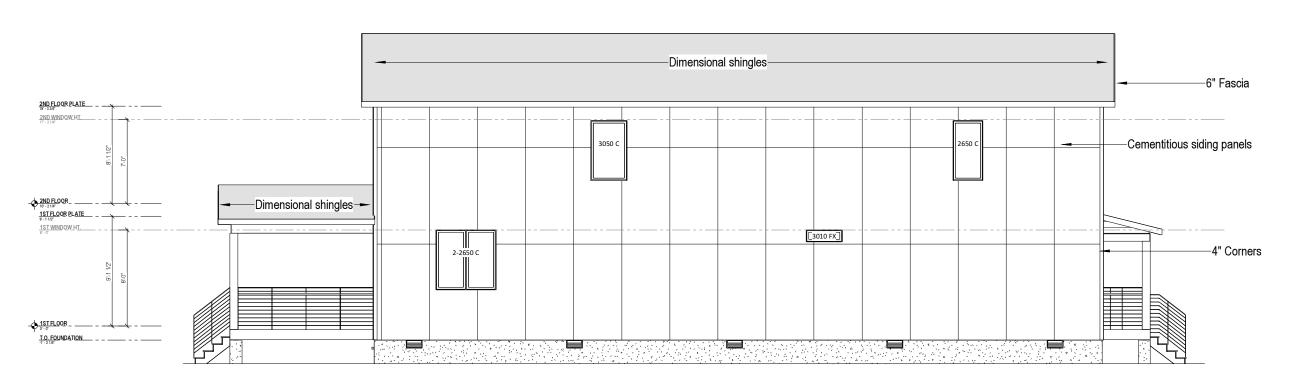
A-3

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1 FRONT VIEW
1/8" = 1'-0" WHEN PRINTED ON 11"x17" / ANSI B PAPER SIZE




2 LEFT VIEW
1/8" = 1'-0" WHEN PRINTED ON 11"x17" / ANSI B PAPER SIZE

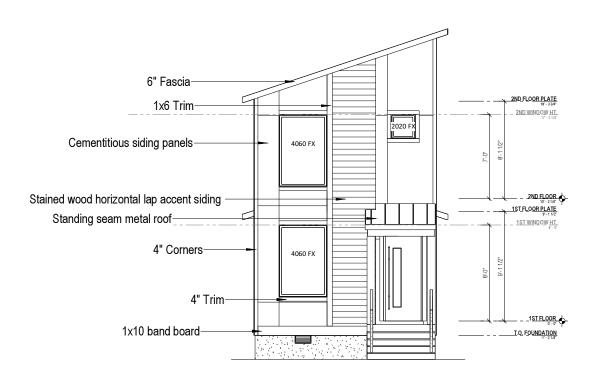


DRAWN BY PINNACLE					

A-5

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2 RIGHT VIEW

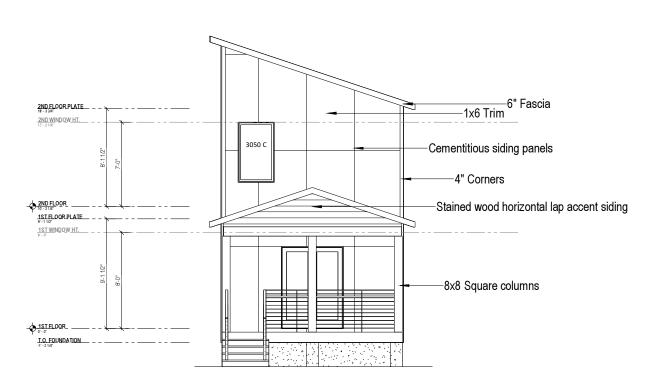A-6 1/8" = 1'-0" WHEN PRINTED ON 11"x17" / ANSI B PAPER SIZE

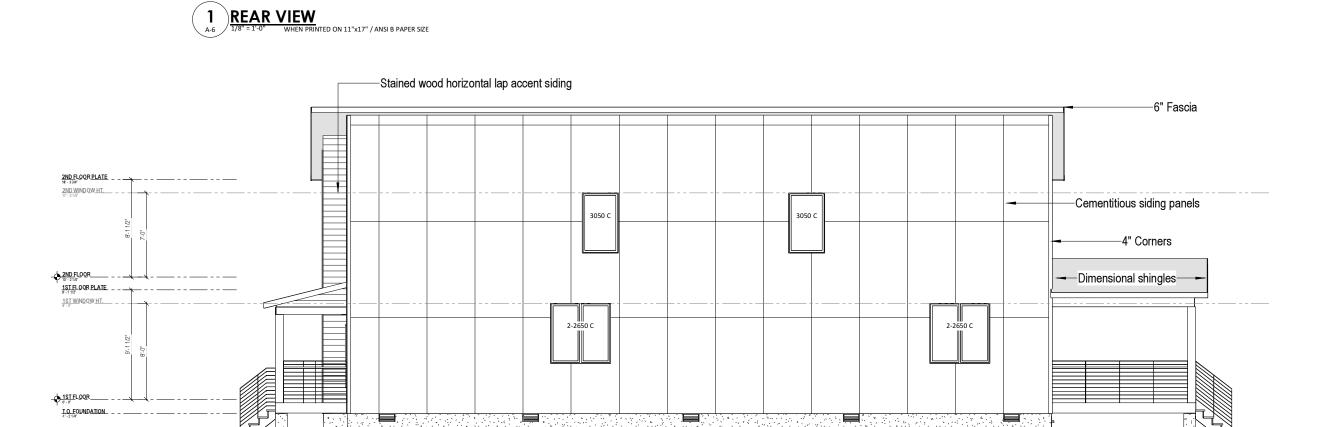

CAVA COMPANIES	ADDRESS 4704 GROVE				
NEW CONSTRUCTION	SHEET Elevations				
8/	SUE DATE /25/22				
DRAWN BY PINNACLE					
DESIGN					

A-6

DOOR SCHEDULE						
Туре	Count	Comments	Heat Transfer Coefficient (U)	Solar Heat Gain Coefficient		
3080 EXT FRONT DOOR	1					
Door_Exterior Double Swing Full Lite 2668	1					
Door_Interior Double Swing 2468	1					
Door_Interior Single Swing 1868	2					
Door_Interior Single Swing 2068	3					
Door_Interior Single Swing 2468	5					
Door_Interior Single Swing 2668	3					
Door_Interior Single Swing - Access Door 2030	1					

Grand total: 17

FIRST FLOOR WINDOW SCHEDULE							
Туре	Count	Comments	Heat Transfer Coefficient (U)	Solar Heat Gain Coefficient			
Vant Foundation 16"v9"	11						
Vent_Foundation 16"x8" Window_Casement 2650	1						
Window_Casement 3050	4						
Window_Fixed 2020	1						
Window_Fixed 3010	1						
Window_Fixed 4060	2						
Window_Twin Casement 2650	3						

Grand total: 23

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PINNACLE


DESIGN
SHEET NUMBER
A-6.00

THIS PROPERTY IS LOCATED IN ZONE X AS SHOWN ON THE FLOOD INSURANCE RATE MAP (FIRM), COMMUNITY PANEL #5101290009D, EFFECTIVE DATE APRIL 2, 2009.


THIS SURVEY IS SUBJECT TO ANY EASEMENT OF RECORD OR OTHER PERTINENT FACTS THAT A CURRENT TITLE REPORT MIGHT IDENTIFY. THIS SURVEY WAS PREPARED WITHOUT THE BENEFIT OF A TITLE REPORT.

THIS SURVEY WAS MADE FOR THE PURPOSE OF IDENTIFYING LEGAL BOUNDARIES AND DOES NOT PURPORT TO IDENTIFY ENVIRONMENTAL FEATURES THAT AN ENVIRONMENTAL ASSESSMENT MIGHT IDENTIFY.

<u>REFERENCE PLAT</u>: PLAT OF COLONIAL PLACE ANNEX. DATED JULY 16, 1912 BY T. CRAWFORD REDD & BRO.

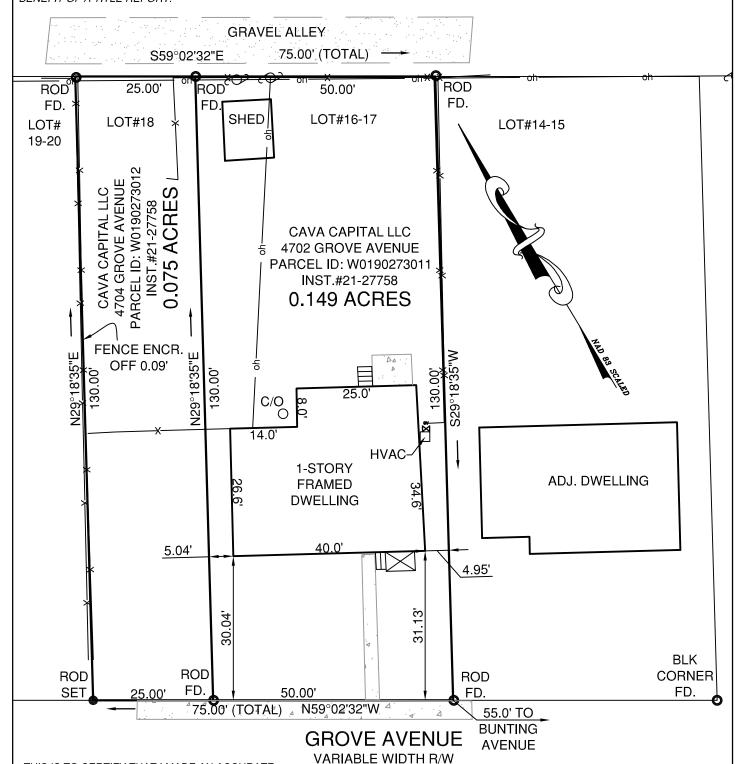

THIS IS TO CERTIFY THAT I MADE AN ACCURATE FIELD SURVEY ON <u>OCTOBER 6, 2021</u>. ALL VISIBLE IMPROVEMENTS ARE AS SHOWN HEREON AND THAT THERE ARE NO VISIBLE ENCROACHMENTS OTHER THAN SHOWN

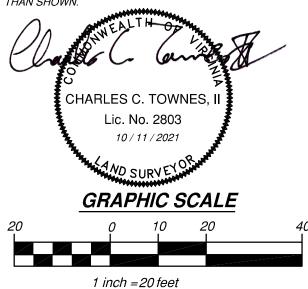

PLAT SHOWING
PHYSICAL IMPROVEMENTS OF
LOT 16-18, BLOCK 9,
COLONIAL PLACE ANNEX
SUBDIVISION

FOR

CAVA CAPITAL, LLC

CITY OF RICHMOND, VIRGINIA

DATE: OCTOBER 11, 2021 SCALE: 1"=20'



2463 boulevard colonial heights, va 23834 telephone: 804.520.9015 facsimile: 804.520.9016 email: cctownes@townespc.com

consulting engineers, planners, and land surveyors

DRAWN BY: TSG CHECKED BY:

ATTN: <u>AMANDA SCHWARTZ</u>