INTRODUCED: April 25, 2022

AN ORDINANCE No. 2022-125

To authorize the special use of the property known as 1308 North 26th Street for the purpose of two single-family attached dwellings, upon certain terms and conditions.

Patron – Mayor Stoney (By Request)

Approved as to form and legality by the City Attorney

PUBLIC HEARING: MAY 23 2022 AT 6 P.M.

WHEREAS, the owner of the property known as 1308 North 26th Street, which is situated in a R-6 Single-Family Attached Residential District, desires to use such property for the purpose of two single-family attached dwellings, which use, among other things, is not currently allowed by section 30-710.1, concerning the number of spaces required for particular uses, of the Code of the City of Richmond (2020), as amended; and

WHEREAS, in accordance with section 17.11 of the Charter of the City of Richmond (2020), as amended, it has been made to appear that, if granted subject to the terms and conditions set forth in this ordinance, the special use granted by this ordinance will not be detrimental to the safety, health, morals and general welfare of the community involved, will not tend to create congestion in streets, roads, alleys and other public ways and places in the area involved, will not

AYES:	8	NOES:	0	ABSTAIN:	
ADOPTED:	MAY 23 2022	REJECTED:		STRICKEN:	
-					

create hazards from fire, panic or other dangers, will not tend to overcrowding of land and cause an undue concentration of population, will not adversely affect or interfere with public or private schools, parks, playgrounds, water supplies, sewage disposal, transportation or other public requirements, conveniences and improvements, and will not interfere with adequate light and air; and

WHEREAS, (i) the City Planning Commission has conducted a public hearing to investigate the circumstances and conditions upon which the Council is empowered to authorize such use, (ii) the City Planning Commission has reported to the Council the results of such public hearing and investigation and its recommendations with respect thereto, and (iii) the Council has conducted a public hearing on this ordinance at which the person in interest and all other persons have had an opportunity to be heard;

NOW, THEREFORE,

THE CITY OF RICHMOND HEREBY ORDAINS:

§ 1. **Finding.** Pursuant to section 30-1050.1 of the Code of the City of Richmond (2020), as amended, the Council hereby finds that the special use set forth in and subject to the terms and conditions of this ordinance will not (i) be detrimental to the safety, health, morals and general welfare of the community involved, (ii) tend to create congestion in streets, roads, alleys and other public ways and places in the area involved, (iii) create hazards from fire, panic or other dangers, (iv) tend to overcrowding of land and cause an undue concentration of population, (v) adversely affect or interfere with public or private schools, parks, playgrounds, water supplies, sewage disposal, transportation or other public requirements, conveniences and improvements, or (vi) interfere with adequate light and air.

§ 2. Grant of Special Use Permit.

- (a) Subject to the terms and conditions set forth in this ordinance, the property known as 1308 North 26th Street and identified as Tax Parcel No. E000-0620/012 in the 2022 records of the City Assessor, being more particularly shown on a survey entitled "Plat Showing Improvements on Lot 12, Square 37, 'Heckler's Plan', in the City of Richmond, Virginia," prepared by McKnight & Associates, P.C., and dated July 30, 2021, a copy of which is attached to and made a part of this ordinance, hereinafter referred to as "the Property," is hereby permitted to be used for the purpose of two single-family attached dwellings, hereinafter referred to as "the Special Use," substantially as shown on the plans entitled "Plot Plan Showing Proposed Improvements on No. 1308 and No. 1308 ½ N. 26th Street, Lot 12, Square 37, 'Heckler's Plan', in the City of Richmond, Virginia," prepared by McKnight & Associates, P.C., and dated October 4, 2021, and entitled "Union Hill at 1308 N 26th Street," prepared by nVisionTEK, and dated November 1, 2021, and hereinafter referred to, collectively, as "the Plans," copies of which are attached to and made a part of this ordinance.
- (b) The adoption of this ordinance shall constitute the issuance of a special use permit for the Property. The special use permit shall inure to the benefit of the owner or owners of the fee simple title to the Property as of the date on which this ordinance is adopted and their successors in fee simple title, all of which are hereinafter referred to as "the Owner." The conditions contained in this ordinance shall be binding on the Owner.
- § 3. **Special Terms and Conditions.** This special use permit is conditioned on the following special terms and conditions:
- (a) The Special Use of the Property shall be as two single-family attached dwellings, substantially as shown on the Plans.

- (b) The height of the Special Use shall not exceed three stories, substantially as shown on the Plans.
- (c) All building materials and elevations shall be substantially as shown on the Plans. Vinyl siding shall not be a permitted building material.
 - (d) No off-street parking spaces shall be required for the Special Use.
- (e) All mechanical equipment serving the Property shall be located or screened so as not to be visible from any public right-of-way.
- (f) Prior to the issuance of any certificate of occupancy for the Special Use, the division of the Property into two lots, substantially as shown on the Plans, shall be accomplished by obtaining the necessary approvals from the City and recording the appropriate plats and deeds among the land records of the Clerk of the Circuit Court of the City of Richmond.
- § 4. **Supplemental Terms and Conditions.** This special use permit is conditioned on the following supplemental terms and conditions:
- (a) All required final grading and drainage plans, together with all easements made necessary by such plans, must be approved by the Director of Public Utilities prior to the issuance of the building permit.
- (b) Storm or surface water shall not be allowed to accumulate on the land. The Owner, at its sole cost and expense, shall provide and maintain at all times adequate facilities for the drainage of storm or surface water from the Property so as not to adversely affect or damage any other property or public streets and the use thereof.
- (c) Facilities for the collection of refuse shall be provided in accordance with the requirements of the Director of Public Works. Such facilities shall be located or screened so as not to be visible from adjacent properties and public streets.

- (d) Any encroachments existing, proposed on the Plans or contemplated in the future shall require separate authorization and shall be subject to the applicable provisions of the Code of the City of Richmond (2020), as amended, and all future amendments to such laws.
- (e) In all other respects, the use of the Property shall be in accordance with the applicable underlying zoning regulations.
- § 5. **General Terms and Conditions.** This special use permit is conditioned on the following general terms and conditions:
- (a) No permit implementing this special use permit shall be approved until satisfactory evidence has been presented to the Zoning Administrator that any delinquent real estate taxes applicable to the Property have been paid.
- (b) The Owner shall be bound by, shall observe and shall comply with all other laws, ordinances, rules and regulations applicable to the Property, except as otherwise expressly provided in this ordinance.
- (c) Words and phrases used in this ordinance shall be interpreted to have the meanings ascribed to them by section 30-1220 of the Code of the City of Richmond (2020), as amended, unless the context clearly indicates that a different meaning is intended.
- (d) Notwithstanding any other provision of law, this special use permit is being approved due, in part, to the mitigating effects of each and every condition attached hereto; consequently, if any portion of this ordinance is determined to be invalid for any reason by a final, non-appealable order of any Virginia or federal court of competent jurisdiction, the invalidity shall cause the entire ordinance to be void and of no further effect from the effective date of such order.
- (e) The privileges granted by this ordinance may be revoked pursuant to the provisions of sections 30-1050.7 through 30-1050.11 of the Code of the City of Richmond (2020), as

amended, and all future amendments to such laws. Failure to comply with the terms and conditions of this ordinance shall constitute a violation of section 30-1080 of the Code of the City of Richmond (2020), as amended, and all future amendments to such law, or any other applicable laws or regulations.

- (f) When the privileges granted by this ordinance terminate and the special use permit granted hereby becomes null and void, whether as a result of the Owner relinquishing this special use permit in a writing addressed to the Director of Planning and Development Review or otherwise, use of the Property shall be governed thereafter by the zoning regulations prescribed for the district in which the Property is then situated.
- § 6. **Implementation.** The Commissioner of Buildings is authorized to issue a building permit substantially in accordance with the Plans for the Special Use subject to the terms and conditions set forth in this ordinance. An application for the building permit shall be made within 730 calendar days following the date on which this ordinance becomes effective. If either the application for the building permit is not made within the time period stated in the previous sentence or the building permit terminates under any provision of the Virginia Statewide Building Code, this ordinance and the special use permit granted hereby shall terminate and become null and void.
 - § 7. **Effective Date.** This ordinance shall be in force and effect upon adoption.

A TRUE COPY:

TESTE:

andin D. Ril

City Clerk



2022-055



City of Richmond

900 East Broad Street 2nd Floor of City Hall Richmond, VA 23219 www.rva.gov

Item Request File Number: PRE.2022.0087

O & R Request

DATE: March 14, 2022 **EDITION:**1

TO: The Honorable Members of City Council

THROUGH: The Honorable Levar M. Stoney, Mayor (Patron: Mayor, by Request)

(This in no way reflects a recommendation on behalf of the Mayor.)

THROUGH: J.E. Lincoln Saunders, Chief Administrative Officer

THROUGH: Sharon L. Ebert, Deputy Chief Administrative Officer for Economic Development and

Planning

FROM: Kevin J. Vonck, Director, Department of Planning and Development Review

RE: To authorize the special use of the property known as 1308 North 26th Street for the purpose

of up to two single-family attached dwellings, upon certain terms and conditions.

ORD. OR RES. No.

PURPOSE: To authorize the special use of the property known as 1308 North 26th Street for the purpose of up to two single-family attached dwellings, upon certain terms and conditions.

REASON: The subject property is located in the R-6 Single-Family Attached Residential zoning district. Single-family attached dwellings are permitted uses in this district. However, not all of the lot feature requirements of the zoning district can be met. Therefore a Special Use Permit is requested in order to complete this project.

RECOMMENDATION: In accordance with the requirements of the City Charter and the Zoning Ordinance, the City Planning Commission will review this request and make a recommendation to City Council. This item will be scheduled for consideration by the Commission at its May 2, 2022 meeting.

BACKGROUND: The subject property is located on the west side of North 26th Street near midblock between S and T Streets. It is a vacant lot measuring 140 feet deep and 35 feet wide, for a total of 4,900 square feet. There are a mix of single-family attached and detached dwellings in the block. Properties to the

File Number: PRE.2022.0087

east and south are generally developed with single- and two-family dwellings. To the west and north lie the N 25th Street and Nine Mile Road commercial corridors along with The Market at 25th. To the south of the Property along N 26th Street lie various commercial and residential uses along with several vacant properties.

FISCAL IMPACT / COST: The Department of Planning and Development Review does not anticipate any impact to the City's budget for this or future fiscal years.

FISCAL IMPLICATIONS: Staff time for processing the request; preparation of draft ordinance; and publishing, mailing and posting of public notices.

BUDGET AMENDMENT NECESSARY: No.

REVENUE TO CITY: \$300 application fee

DESIRED EFFECTIVE DATE: Upon adoption

REQUESTED INTRODUCTION DATE: April 11, 2022

CITY COUNCIL PUBLIC HEARING DATE: May 9, 2022

REQUESTED AGENDA: Consent

RECOMMENDED COUNCIL COMMITTEE: None

CONSIDERATION BY OTHER GOVERNMENTAL ENTITIES: City Planning Commission

May 2, 2022

AFFECTED AGENCIES: Office of Chief Administration Officer

Law Department (for review of draft ordinance)

RELATIONSHIP TO EXISTING ORD. OR RES.: None

REQUIRED CHANGES TO WORK PROGRAM(S): None

ATTACHMENTS: Draft Ordinance, Application Form, Applicant's Repot, Plans, Survey, Map

STAFF: David Watson, Senior Planner, Land Use Administration, 804-646-1036



Application for **SPECIAL USE PERMIT**

Department of Planning and Development Review
Land Use Administration Division
900 E. Broad Street, Room 511
Richmond, Virginia 23219
(804) 646-6304
http://www.richmondgov.com/

Application is hereby submitted for: (check one)		
special use permit, new		
special use permit, plan amendment		
☐ special use permit, text only amendment		
Project Name/Location		
Property Address: 1308 N 26th Street		_Date <u>:</u>
Tax Map #: <u>E0000620012</u> Fee: <u>\$300</u>		
Total area of affected site in acres: 0.112		
(See <i>page 6</i> for fee schedule, please make check payable to the "City of	of Richmond")	
Zoning		
Current Zoning: R-6		
<u> </u>		
Existing Use: Vacant		
Proposed Use		
(Please include a detailed description of the proposed use in the require	d applicant's report)	
Construction of two (2) single-family attached dwellings.		
Existing Use: Vacant		
Is this property subject to any previous land use cases?		
Yes No		
If Yes, please list the Ordinance Number:		
Applicant/Contact Person: Mark Baker		
Company: Baker Development Resources		
Mailing Address: 530 East Main Street, Suite 730		
City: Richmond	State: VA	Zip Code: <u>23219</u>
Telephone: (804) 874-6275	 Fax: ())
Email: markbaker@bakerdevelopmentresources.com		
Property Owner: CCR3 HOLDINGS LLC		
If Business Entity, name and title of authorized signee: De	velopment Executive	
(The person or persons executing or attesting the execution of this Appl she has or have been duly authorized and empowered to so execute or a		e Company certifies that he or
she has of have been duly authorized and empowered to so execute of a	ittest.)	
Mailing Address: 11 S 12th Street, #115		
City: Richmond	State: VA	Zip Code: 23219
Telephone: (804) 999-4449	Fax: ()	
Email: josh@centercreekhomes.com	/	
Property Owner Signature:		

The names, addresses, telephone numbers and signatures of all owners of the property are required. Please attach additional sheets as needed. If a legal representative signs for a property owner, please attach an executed power of attorney. **Faxed or photocopied signatures will not be accepted.**

NOTE: Please attach the required plans, checklist, and a check for the application fee (see Filing Procedures for special use permits)

APPLICANT'S REPORT

November 18, 2021

Special Use Permit Request 1308 N 26th Street, Richmond, Virginia Map Reference Number: E000-0620/012

Submitted to: City of Richmond

Department of Planning and Development Review

Land Use Administration 900 East Broad Street, Suite 511 Richmond, Virginia 23219

Submitted by: Baker Development Resources

530 East Main Street, Suite 730 Richmond, Virginia 23219


Introduction

The property owner is requesting a special use permit (the "SUP") for 1308 N 26th Street (the "Property"). The SUP would authorize the construction of two (2) single-family attached dwellings on the currently vacant Property. While the single-family attached dwelling use is permitted by the underlying R-6 Single Family Attached Residential zoning district, some of the applicable feature requirements cannot be met, and therefore, the SUP is required.

Existing Conditions

SITE DESCRIPTION AND EXISTING LAND USE

The Property is located on the west side of N 26th Street between S and T Streets and consists of one parcel, which is referenced by the City Assessor as tax parcel E000-0620/012. The Property is 35 feet wide, 140 feet deep and contains approximately 4,900 square feet of lot area and is currently vacant.

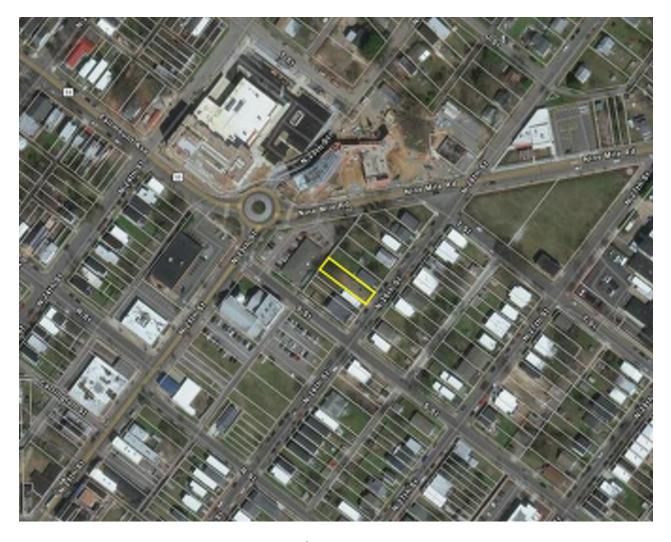

There are a mix of single-family attached and detached dwellings in the block. Properties to the east and south are generally developed with single- and two-family dwellings. To the west and north lie the N 25th Street and Nine Mile Road commercial corridors along with The Market at 25th. To the south of the Property along N 26th Street lie various commercial and residential uses along with several vacant properties.

The Property, and those nearby, lie in the 25th and Nine Mile Neighborhood Node. The Richmond 300 Master Plan describes nodes as "places in Richmond where people and jobs are today and continue to grow into the future. Nodes are the places of convergence of many uses and include offices, shopping, housing, and/or public gathering places as well as access to multiple modes of transportation."

EXISTING ZONING

The Property is zoned R-6 Single-Family Attached Residential, which permits the proposed single-family attached dwelling use. The surrounding properties along the N 25th and Nine Mile corridors are zoned a mixture of B-2, B-5, and UB-2 Business Districts. Southeast of the property along N 28th Street lies a block of properties which are zoned a combination M-1 Light Industrial and R-63 Multifamily Urban Residential.

TRANSPORTATION

Located 0.2 miles from the Property, less than a five-minute walk, is the 25th and S Street bus stop which serves the 7 and 12 bus lines. These lines run every 30 minutes and connect with the Pulse BRT, thereby providing connectivity throughout the City. The Property is also located a half mile from the Mosby and Fairmount bus stop which serves the 5 bus line. This line is described as a "high-frequency line" that runs every fifteen minutes.

MASTER PLAN DESIGNATION

The Richmond 300 Master Plan (the "Master Plan") suggests "Neighborhood Mixed-Use" for the Property. This land use category is described as "existing or new highly-walkable urban neighborhoods that are predominantly residential." The Master Plan suggests this future land use designation allow for a variety of housing types that are consistent with the scale, density, and design of what exists in the vicinity. Single-family dwellings are a primary use in the Neighborhood Mixed-Use designations which also encourages that developments reinforce a gridded street pattern to increase connectivity. Single-family dwellings are the contemplated primary use in the Residential future land use designation (p. 54). The Property is also located within the 25th and Nine Mile Neighborhood Node which is described as a local crossroads typically within or next to larger residential areas that offers goods and services to nearby residents, employees, and visitors.

In addition to the Property-specific guidance offered by the Vision and Core Concepts chapter, there are a number of other goals elsewhere within the Master Plan that support this request, including:

• Equitable Transportation, Objective 6.1, which is to "increase the number of residents...along enhanced transit corridors" as Richmond Highway is shown as being an enhanced transit corridor, and is within close proximity to the Property (Figure 28, p. 119).

- High-Quality Places, Objective 1.4, to "maintain and improve primarily residential areas by increasing their linkages to...corridors...and maintaining high-quality design standards"
- High Quality Places, Objective 4.1, to "create and preserve high-quality, distinctive, and well-designed neighborhoods and nodes throughout the City," as the request introduces thoughtfully-designed new construction in a manner not otherwise assured by-right.
- Inclusive Housing chapter, Objective 14.5, to "encourage more housing types throughout the City and greater density...at nodes...", as the request is a more efficient use of the Property than could be achieved by-right in the R-6 zoning district.

Proposal

PROJECT SUMMARY

The proposed development includes the construction of two (2) new, single-family attached dwellings on the vacant Property consistent with the historical use of the Property.

PURPOSE OF REQUEST

The Property is 35 feet in width which is equal to, or larger than, the other properties within the block. Historic Sanborn maps show two attached dwellings previously located on the Property. Therefore, the applicant would now like to construct two, new single-family attached dwellings, consistent with the historical use of the Property. While this request is consistent with both the lot pattern and historic development pattern in the vicinity, some of the underlying feature requirements, including unit width and off-street parking cannot be met and therefore, a SUP is required.

The proposed lot width and area are compatible with other lots in the vicinity, which are all characteristically smaller urban lots. In the subject block, a majority of the lots are developed with dwellings that do not comply with the current R-6 requirements. Based on this historic lot pattern, the majority of lots in the vicinity are nonconforming with regard to lot area. Furthermore, all properties located on the western portion of the block of N 26th Street bound by S and T Streets do not have rear alley access and therefore cannot provide off-street parking.

In exchange for the SUP, the intent of this request is to ensure a high-quality infill development that is consistent with the objectives of the Master Plan. The overall project would be appropriately efficient and would be compatible with the existing development in the vicinity. The quality assurances conditioned through the SUP would guarantee a higher quality development than what might otherwise be developed by right in the vicinity.

PROJECT DETAILS

The two new single-family attached dwellings would each be approximately 14 feet in width and three stories in height and are consistent with historic development pattern found throughout the neighborhood. The third floors would be set back and the building design would utilize a false mansard roof at the second story in order to achieve the appearance of a two-story building from the street. This design has been utilized elsewhere in the vicinity.

Each dwelling would contain three bedrooms and two-and-one-half bathrooms and approximately 2,207 square feet of floor area. An optional third-floor bathroom would allow future homeowners to meet the needs of their individual families. The dwelling floor plans are spacious and modern with open living areas and kitchens along with a primary bedroom which contains an en suite bathroom and walk in closet.

The new dwellings would be clad in cementitious lap siding in order to ensure quality and consistency in appearance with many other dwellings in the vicinity. A full-width front porch and rear facing balcony on the third-floor allow for additional outdoor living space and, potentially, views of the City of Richmond.

Findings of Fact

The following are factors included in Section 17.11 of the Charter and Section 30-1050.1 of the Zoning Ordinance relative to the approval of special use permits by City Council. The proposed special use permit will not:

• Be detrimental to the safety, health, morals and general welfare of the community involved.

The proposed special use permit for high-quality infill construction will not impact the safety, health, morals and general welfare of the nearby neighborhoods.

• Tend to create congestion in streets, roads, alleys and other public ways and places in the area involved.

The proposed special use permit will not result in significant traffic impacts to nearby residential neighborhoods. The negligible traffic generation and one off-street parking spaces for each of the six dwelling units will create no congestion on streets, roads, alleys or any other public right of way.

• Create hazards from fire, panic or other dangers.

The Property will be developed in a manner consistent with the requirements of the building code and in accordance with the requirements of Fire and Emergency Services. The City's codes applicable to this development are designed to eliminate such hazards.

• Tend to overcrowding of land and cause an undue concentration of population.

The proposed special use permit will not tend to over crowd the land or create an undue concentration of population.

• Adversely affect or interfere with public or private schools, parks, playgrounds, water supplies, sewage disposal, transportation or other public requirements, conveniences and improvements.

The special use permit would not adversely affect the above referenced City services.

Interfere with adequate light and air.

The light and air available to the subject and adjacent properties will not be affected. The proposed dwellings are of compatible massing and spacing to the existing dwellings throughout the neighborhood. As a result, this request will not interfere with the provision of adequate light and air to the adjacent buildings.

Summary

In summary we are enthusiastically seeking approval for the construction of two single-family attached dwellings on the Property. The SUP represents an ideal, small-scale urban infill development for this location that is historically appropriate and would contribute to the vibrancy of the block with street-oriented full width front porches. These dwellings provide new housing opportunities for the neighborhood which are consistent with the goals of the new Richmond 300 Master Plan. Finally, the quality assurances conditioned through the SUP would guarantee a higher quality development than what might otherwise be developed by right in the vicinity.


NOTES: THIS PROPERTY IS LOCATED IN F.E.M.A. FLOOD ZONE "X".

CURRENT OWNER: CCR3 HOLDINGS LLC ID 2021-25841

CONTOURS OVERLAYED FROM CITY OF RICHMOND GIS.


CITY OF RICHMOND LOT SPLIT APPROVAL PENDING.

KYONG Y & MOON C KIM ID 2010-10973 TM# E00006200020 _ 172

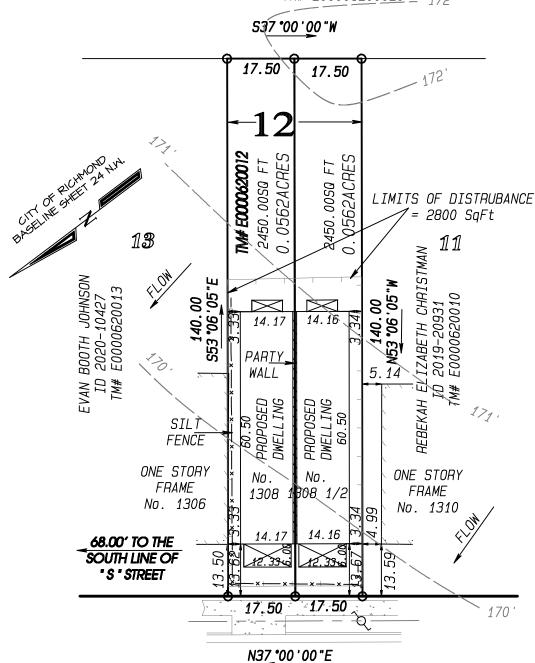

 $N. \quad 26^{TH} \quad STREET$

PLOT PLAN SHOWING PROPOSED IMPROVEMENTS ON No. 1308 & 1308 1/2 N. 26 TH STREET, LOT 12, SQUARE 37, "HECKLER'S PLAN", IN THE CITY OF RICHMOND, VIRGINIA.

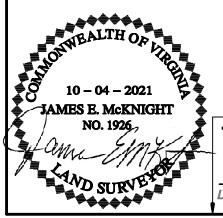



201 TWIN RIDGE LANE RICHMOND, VIRGINIA 23235 TELEPHONE (804) 320-2646

JOB NUMBER: 92063308PF

SCALE: 1" = 25'

UNION HILL AT 1308 N 26TH STREET

PROJECT ADDRESS: 1308 N 26TH STREET, RICHMOND, VA 23223 3-STORY 3-BEDROOM, 3-1/2 BATH, NEW CONSTRUCTION 2-FAMILY ATTACHED RESIDENCE WITH OPEN 3RD LEVEL BALCONY





	ABBREVIATION	S LEG	END
λ B	ANCHOR BOLT	MAX	MAXIMUM
\BV	ABOVE	MECH	MECHANICAL
\DJ	ADJUSTABLE	MFR	MANUFACTURER
\FF	ABOVE FINISHED FLOOR	MIN	MINIMUM
ALUM	ALUMINUM	MLDG	MOLDING
APPROX	APPROXIMATE	MO	MASONRY OPENING
BLDG	BUILDING	NTS	NOT TO SCALE
BLK	BLOCK	0/	ON
BLKG	BLOCKING	OC	ON CENTER
30	BOTTOM OF	OH	OVERHEAD
CJ	CONTROL JOINT	OSB	ORIENTED STRAND BOARD
CL	CENTER LINE	PERF	PERFORATED
CLG	CEILING	PGM	PLATE GLASS MIRROR
CLR	CLEAR	PL	PROPERTY LINE
CMU	CONCRETE MASONRY UNIT	PLY	PLYWOOD
COL	COLUMN	PSI	POUNDS PER SQUARE INCH
CONC	CONCRETE	PT	PRESSURE TREATED
CONT	CONTINUOUS OR CONTINUE CARPET	PWD RM	POWDER ROOM
CPT CT	CERAMIC TILE	QTY	QUANTITY
CW	COLD WATER	REF	REFRIGERATOR
DBL	DOUBLE	REINF	REINFORCED
DIA	DIAMETER	REQ'D	REQUIRED
DIM DIM	DIMENSION	RM	ROOM
DR DR	DOOR	RO	ROUGH OPENING
DS .	DOWN SPOUT	SD	SMOKE DETECTOR
DW DW	DISHWASHER	SF	SQUARE FEET
DWG	DRAWING	SHTG	SHEATHING
DRY	DRYER	SIM	SIMILAR
ΞA	EACH	STD	STANDARD
-/ \ EJ	EXPANSION JOINT	T&G	TONGUE & GROOVE
ELV	ELEVATION	TBS	TO BE SELECTED
EQ	EQUAL	TEL	TELEPHONE
	EOI IIPMENT	TEMP	TEMPERED

TOP OF

TOP OF BEAM

VAPOR BARRIER

WASHER

WALK-IN-CLOSET

WATER PROOFING

WATER RESISTANT

IF AN ABBREVIATION IS FOUND IN THE SET

INTENDED MEANING, NOTIFY NVISIONTEK,

OF PLANS, IS NOT LISTED ABOVE, AND

THERE IS ANY QUESTIONS AS TO IT'S

LLC IMMEDIATELY.

VENTILATION

UNLESS NOTED OTHERWISE

TOP OF SILI

TOP PLATE

TYPICAL

VERTICAL

WITHOUT

WOOD

WINDOW

WITH

TOB

TOS

UNO

VENT

VERT

WD

EQUIPMENT

FLOOR (OR FLOORING)

FACE OF CONCRETE

FACE OF FRAMING

HEATING / VENTILATING / AIR CONDITIONING

EXTERIOR

FLOOR DRAIN

FINISH FLOOR

FOUNDATION

FACE OF

GYPSUM

HOSE BIB

HEADER

HANDRAIL

HOT WATER

INTERIOR

LAVATORY

JOIST

INSULATION

LAMINATED VENEER LUMBER

HEIGHT

EXT

FOC

FOF

FTG

GWB

HDR

HGT

HVAC

HW

INSUL

INT

LAV

PROJECT INFORMATION

NEW CONSTRUCTION 2-STORY 2-BEDROOM, 1-1/2 BATH, SINGLE-FAMILY RESIDENCE

OWNER / CLIENT: CENTER CREEK HOMES 11 S 12TH STREET, SUITE 115 RICHMOND, VA 23219

UNION HILL AT 1308 N 26TH STREET

T: 804.999.4449 E: JOSH@CENTERCREEKHOMES.COM

PROJECT ADDRESS: 1308 N 26TH STREET, RICHMOND, VA 23223

DRAWN BY: NVISIONTEK, LLC

CONTACT: DUSTIN HETRICK NORTH CHESTERFIELD, VA 23236 T: 804.372.0991 E: DHETRICK@NVISIONTEKBIM.COM

ARCHITECT: CHRIS WOLF ARCHITECTURE, PLLC

CONTACT: CHRIS WOLF ARCHITECTURE, PLLC 11 S 12TH STREET, SUITE 115 RICHMOND, VA, 23219 T: 804.514.7644 E: CHRIS@CENTERCREEKHOMES.COM

GENERAL CONTRACTOR / DEVELOPER: CENTER CREEK HOMES CONTACT: JOSH BOSLER 11 S 12TH STREET, SUITE 115

E: JOSH@CENTERCREEKHOMES.COM **BUILDING AREA:**

T: 804.999.4449

RICHMOND, VA 23219

OVERALL CONSTRUCTION SQUARE FOOTAGE MEASURED TO OUTSIDE SURFACE OF EXTERIOR WALLS, DECKS, PORCHES, OR PATIO SLAB

REFER TO AREA PLANS FOR AREA CALCULATIONS

GENERAL NOTES

1. ALL WORK SHALL CONFORM TO ALL BUILDING AND OCCUPATIONAL SAFETY CODES PERTAINING TO THIS

2. PRIOR TO ANY SITE ACTIVITIES, THE CONTRACTOR SHALL VERIFY LOCATION OF ALL UTILITIES.

3. PLANS AND SPECIFICATIONS IN SOME INSTANCES, DO NOT CONTAIN SPECIFIC INSTRUCTIONS FOR INSTALLATION OR PREPREPATION METHODS. CONTRACTOR AND SUBS ARE RESPONSIBLE FOR FOLLOWING ASTM STANDARDS AND APPLICABLE CODES.

4. INTERIOR WALLS AT POCKET DOORS TO BE 2x6 STUD FRAMING. ALL OTHER INTERIOR WALLS TO BE 2x4 STUD FRAMING, U.N.O.. REFER TO WALL TAGS AND LEGEND.

5. ALL EXTERIOR WALLS TO BE 2x4 STUDS WITH 7/16" OSB. R-15 (MIN.) INSULATION, HOUSE WRAP, AND

6. EXTERIOR DOORS TO HAVE MIN. 3'-0" X 3'-0" LANDING IF MORE THAN (3) RISERS ARE NEEDED TO REACH FINISHED GRADE, U.N.O.

7. WRITTEN DIMENSIONS ON THESE DRAWINGS SHALL HAVE PRECEDENCE OVER SCALED DIMENSIONS. 8. ALL EXTERIOR FRAMING DIMENSIONS ARE SHOWN TO FACE OF STUDS. ALL INTERIOR FRAMING DIMENSIONS ARE TO FACE OF STUDS, U.N.O. WALL FINISHES ARE EXCLUDED UNLESS NOTED AS "FIN.". REFER TO WALL LEGEND, IF SHOWN, FOR ADDITIONAL WALL INFORMATION.

9. ALL WINDOW AND DOOR DIMENSIONS ARE TO CENTER LINE. AS-BUILT ONLY PLANS SHOW ALL WINDOW AND DOOR DIMENSIONS TO OPENING WIDTHS. ALL STRUCTURAL MEMBERS (FLOOR AND CEILING JOIST, RAFTERS, HEADERS, BEAMS) MUST NOT BE CHANGED WITHOUT VERIFICATION & APPROVAL, UNLESS TO MEET ENGINEERING REQUIREMENTS.

10. FIELD VERIFY ALL DIMENSIONS PRIOR TO CONSTRUCTION.

11. ALL INTERIOR OPENINGS 48" AND LARGER REQUIRE DOUBLE JACK STUDS. ALL HEADERS AT INTERIOR AND EXTERIOR LOAD-BEARING WALLS TO BE MIN. (2)2x8, U.N.O.. ALL HEADERS AT INTERIOR DOORS TO BE (2)2x6, U.N.O.. REFERENCE R602.7 AND/OR VERIFY w/LICENSED STRUCTURAL ENGINEER.

12. ALL LUMBER TO BE S.P.F. #2 OR BETTER U.N.O..

13. INCREASE ENTRY DOOR ROUGH OPENING HEIGHT +3/4" WHEN THE FINISHED FLOOR IS 3/4" HARDWOOD

14. ALL INTERIOR WALLS TO BE FRAMED AT 16" O.C. WITH WALLS PERPENDICULAR TO FLOOR JOISTS TO HAVE STUDS STACKED OVER JOISTS. ALL FRAMED WALLS TO HAVE DOUBLE TOP PLATES AND SINGLE

15. DOUBLE UP ALL FLOOR JOISTS OR PROVIDE SOLID BLOCKING BETWEEN ALL JOISTS BELOW ALL BEARING WALLS, TUBS, AND APPLIANCES.

16. ALL DECORATIVE ELEMENTS AND FINISHES ARE TO BE SELECTED BY OWNER. CONTRACTOR TO VERIFY WITH OWNER PRIOR TO ORDERING AND INSTALLATION, TYP. FOR ENTIRE PROJECT.

17. HEAT LOSS CALCULATIONS SHALL COMPLY WITH THE REQUIREMENTS OF REGIONAL AND LOCAL CODES. SEE CALCULATIONS. PORCHES, DECKS, FOUNDATION, FIREPLACE ENCLOSURES, AND GARAGE AREAS NOT INCLUDED IN LIVING AREA. ALL EXHAUST FANS TO BE VENTED DIRECTLY TO THE EXTERIOR. ALL PENETRATIONS OF THE BUILDING ENVELOPE SHALL BE SEALED WITH CAULK OR FOAM.

18. INSULATE ALL ACCESS DOORS/ HATCHES TO CRAWL SPACES AND ATTICS TO THE EQUIVALENT RATING OF THE WALL, FLOOR OR CEILING THROUGH WHICH THEY PENETRATE. U.N.O. ON PLANS.

19. REFER TO STRUCTURAL DRAWINGS (IF APPLICABLE) FOR ANY STRUCTURAL INFORMATION NOT INDICATED. VERIFY ALL STRUCTURAL ITEMS SHOWN THROUGHOUT DRAWINGS WITH LICENSED STRUCTURAL ENGINEER.

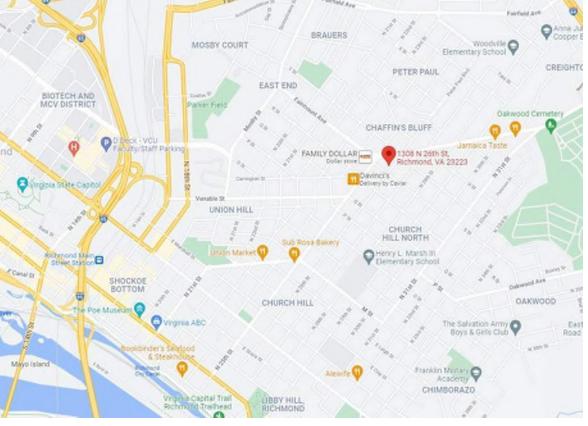


IMAGE OF EXISTING LOT



DRAWING SYMBOL LEGEND - SECTION/ELEVATION/DETAIL # - PLAN # ON SHEET REVISION CLOUD (REFERENCE REVISION SCHEDULE) __ DETAIL# ELEVATION / SECTION MARKER DIRECTION INDICATOR REFERENCING PITCH / SLOPE INDICATOR DETAIL CALLOUT MARKER REFERENCING CENTER LINE BREAK LINE DETAIL # REFERENCING SHEET # FRAMING BLOCKING PLAN NORTH (SECTION) DETAIL CALLOUT MARKER WITH AREA BOUNDARY BATT / CELLULOSE GRAVEL FILL, U.N.O. INSULATION EARTH OR COMPACTED RIGID INSULATION, INTERIOR ELEVATION MARKER U.N.O. FILL, U.N.O. CLOSED-CELL FOAM TILE FLOOR INSULATION, U.N.O. (GENERIC), U.N.O. ROOM NAME, ASSOCIATED w/ROOM SCHEDULE X'-X" x X'-X" DROPPED CEILING DOOR NUMBER, ASSOCIATED CMU BLOCKS, U.N.O OR SOFFIT, U.N.O. w/DOOR SCHEDULE WINDOW NUMBER, ASSOCIATED ASPHALT SHINGLE w/WINDOW SCHEDULE BRICKS, U.N.O. ROOFING, U.N.O. NOTE, ASSOCIATED w/ CORRESPONDING SCHEDULE DECK/PORCH PLANKING CONCRETE, U.N.O. OR SIDING, U.N.O. LEVEL NAME ELEVATION MARKER w/HEIGHT

BUILDING CODE & ZONING

PROJECT SHALL CONFORM TO THE 2018 VIRGINIA UNIFORM STATEWIDE BUILDING CODE AND 2018 VIRGINIA INTERNATIONAL RESIDENTIAL CODE. RICHMOND COUNTY ZONING, LOT ZONED R-6. CONSTRUCTION TYPE V-B

STRUCTURAL REQUIREMENTS (VERIFY w/LICENSED ENGINEER): • FROST DEPTH: 18"

• ULTIMATE DESIGN WIND SPEED: 115 MPH, EXPOSURE B SNOW LOAD: 20 PSF • SEISMIC DESIGN CATEGORY: B

 MAXIMUM BUILDING HEIGHT: 35'-0" • FOUNDATION: SEE GEOTECHNICAL REPORT BY OTHERS • EXTERIOR WALL BRACING PER IRC R602.10

INSULATION REQUIREMENTS

REFER TO TABLE N1102.1.2 (R402.1.2) CLIMATE ZONE: 4 • FENESTRATION U-FACTOR: 0.32 • SKYLIGHT U-FACTOR: 0.55 GLAZED FENESTRATION SHGC: 0.40

• CEILING R-VALUE: 49 • WOOD FRAME WALL R-VALUE: 13 MASS WALL R-VALUE: 8 (CONTINUOUS)/13 (CAVITY) • FLOOR R-VALUE: 19 BASEMENT WALL R-VALUE: 10 (CONTINUOUS)/13 (CAVITY)

• UNHEATED SLAB R-VALUE & DEPTH: NOT REQUIRED • HEATED SLAB R-VALUE: R-5 • CRAWL SPACE WALL R-VALUE: 10 (CONTINUOUS)/13 (CAVITY)

INFO@NVISIONTEKBIM.COM CELL: 804.372.099⁻ RICHMOND, VA 23236

REVISIONS

BUILDER NOTICE

PLANS WITH LICENSED STRUCTURAL

F THE GENERAL CONTRACTOR OF

DUSTIN HETRICK AT NVISIONTEK, LLC, CEL

PROJECT NAME

UNION HILL AT 1308 N

26TH STREET

CLIENT(S)

PROJECT ADDRESS

1308 N 26TH STREET

RICHMOND, VA 23223

COVER SHEET

DOCUMENT PHASE:

PERMIT SET

PLOT DATE:

11/1/2021

9:56:54 AM

DRAWN BY:

DUSTIN HETRICK

SHEET


SCALE: SEE PLAN


CENTER CREEK HOMES 11 S 12TH STREET, SUITE

RICHMOND, VA, 23219

T: 804.999.4449

DHETRICK@NVISIONTEKBIM.COM

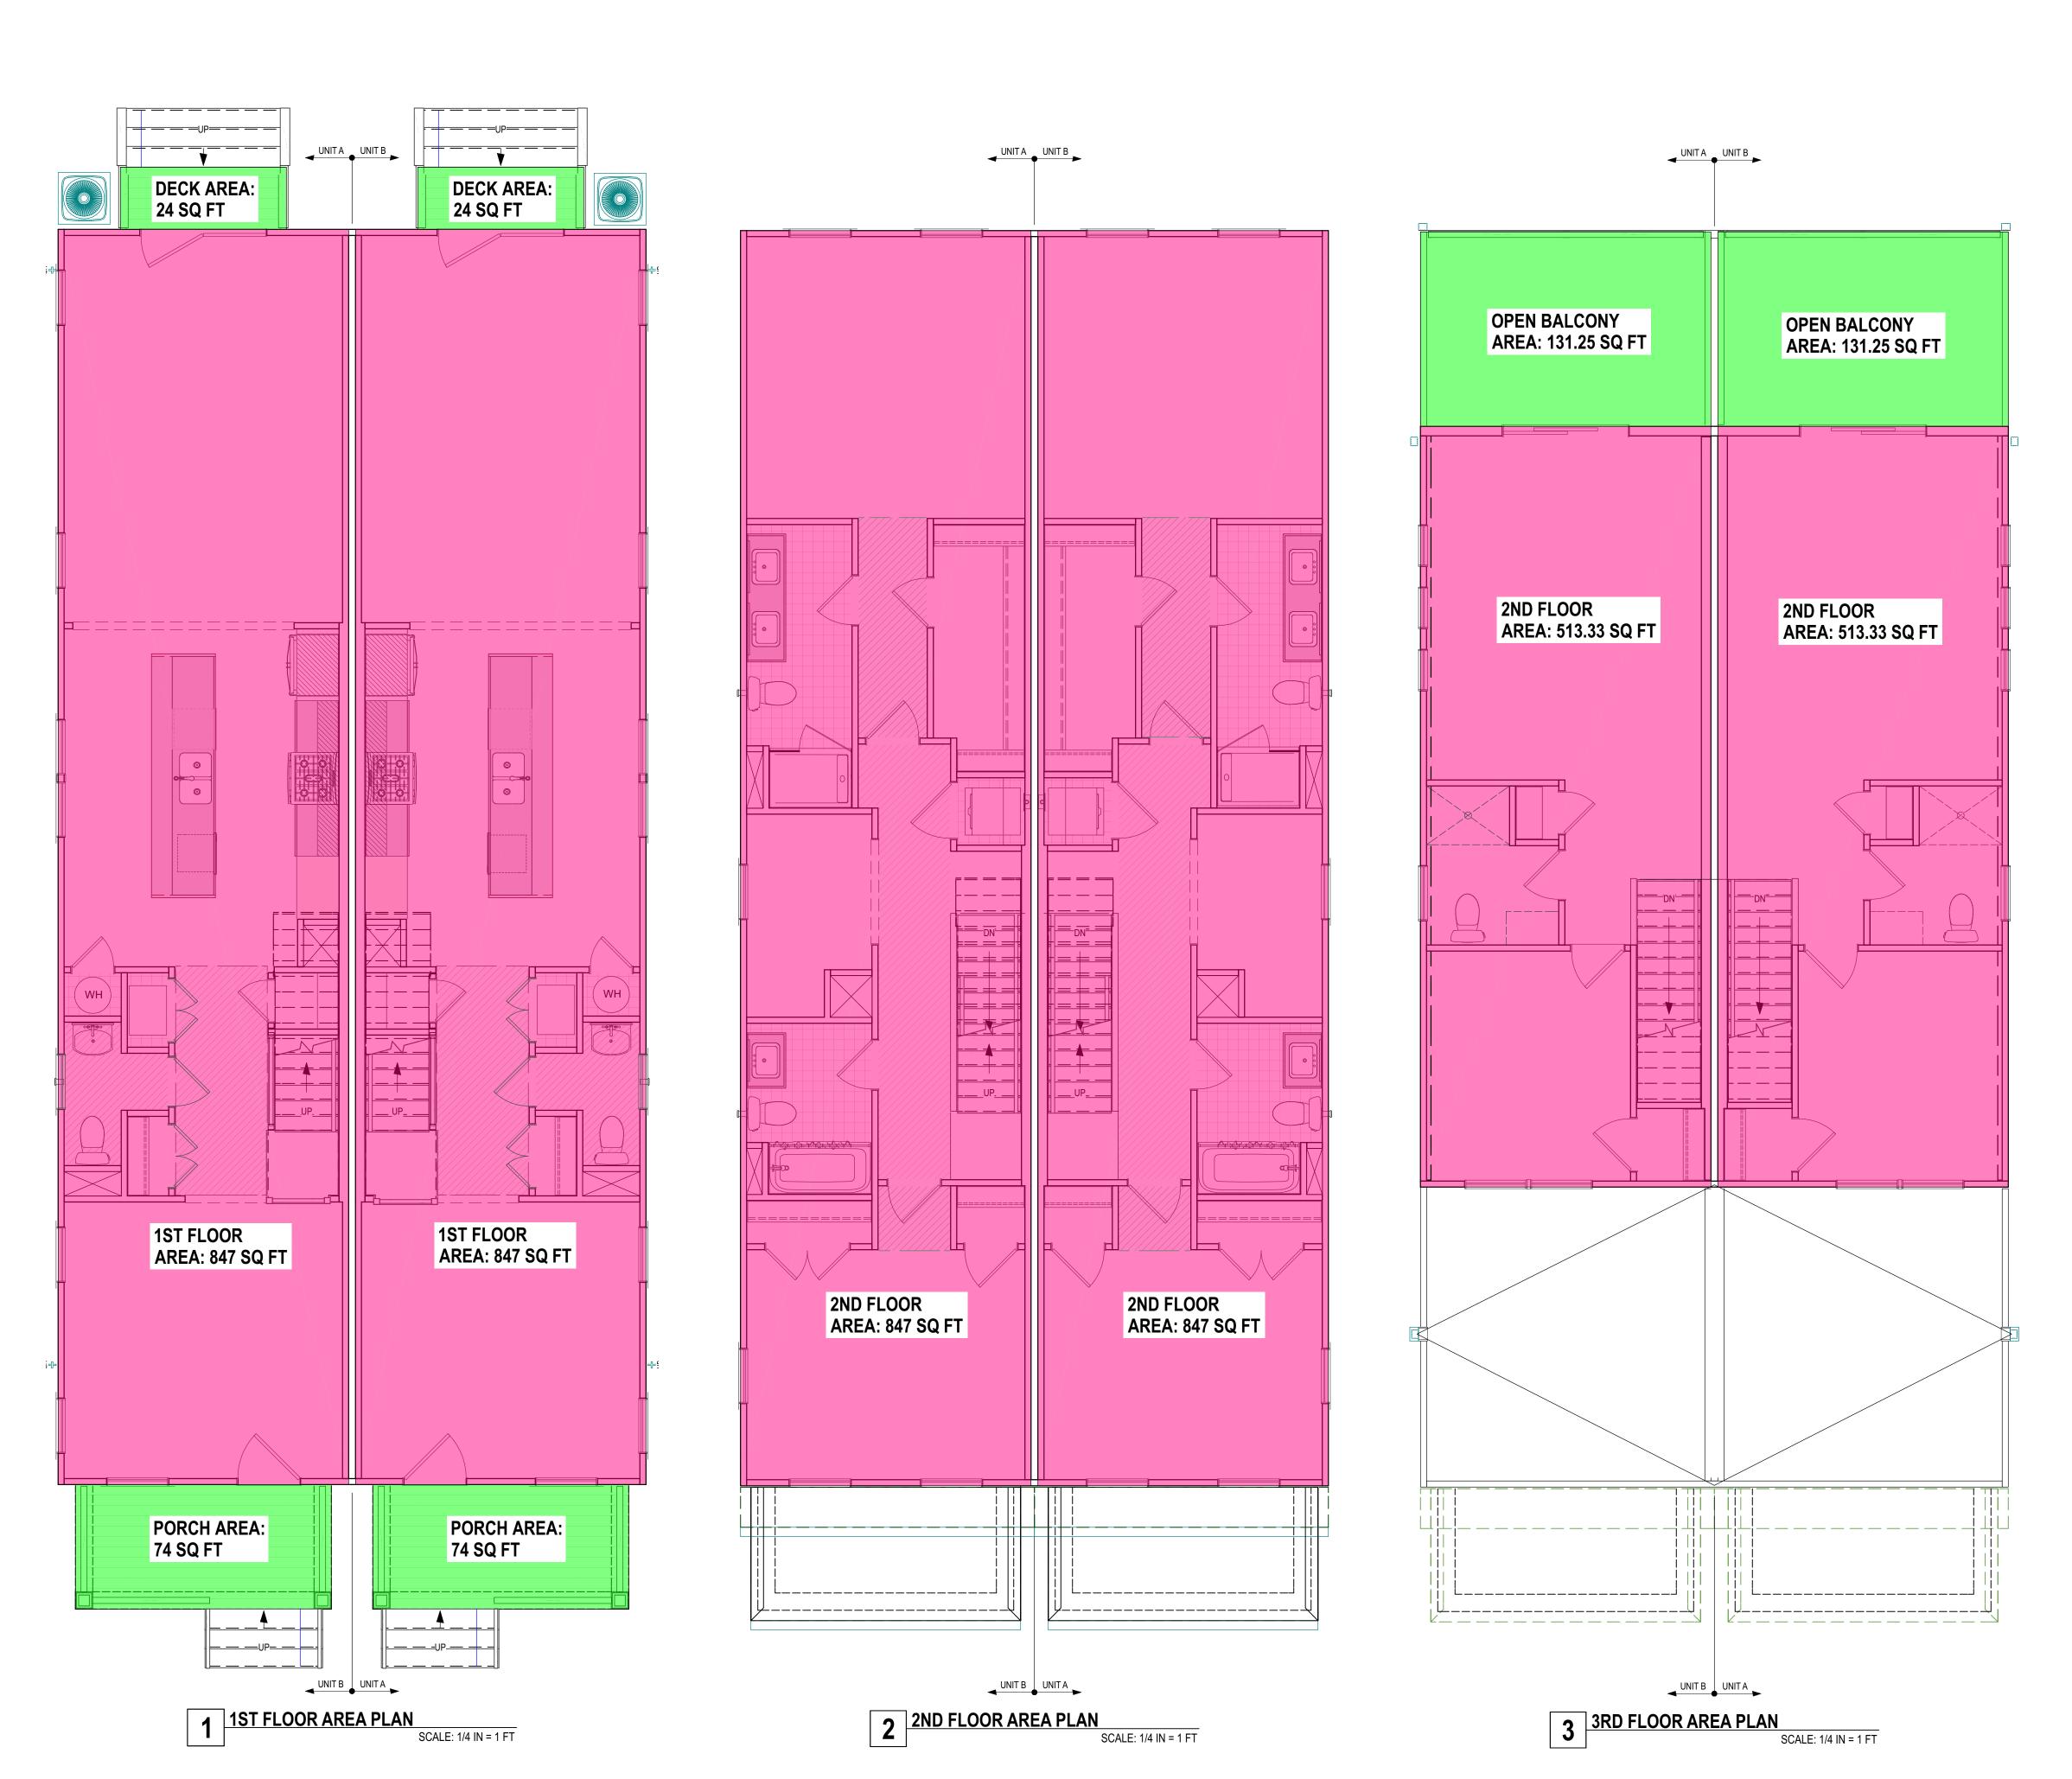

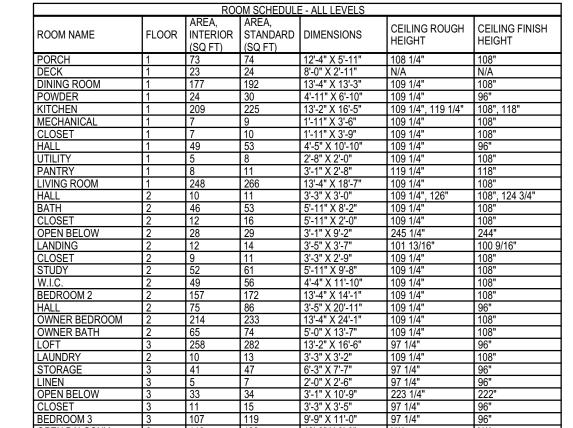

AREA CALCULATIONS

PORCH AREA: 74 SF
DECK AREA: 24 SF
3RD FLOOR OPEN BALCONY AREA: 131 SF
TOTAL NON-LIVING AREA: 229 SF

1ST FLOOR LIVING AREA: 847 SF 2ND FLOOR LIVING AREA: 847 SF 3RD FLOOR LIVING AREA: 513 SE TOTAL LIVING AREA: 2,207 SF

GRAND TOTAL BUILDING AREA: 2,236 SF



NVISIONTEKBIM.COM INFO@NVISIONTEKBIM.COM CELL: 804.372.0991 RICHMOND, VA 23236

REVISIONS

DATE DESCRIPTION

BUILDER NOTICE

IT IS THE INTENT OF THE DESIGNER /
DRAFTER LISTED IN THE TITLE BLOCK OF
THESE DOCUMENTS THAT THESE
DOCUMENTS ARE ACCURATE, PROVIDING
LICENSED PROFESSIONALS CLEAR
INFORMATION. EVERY ATTEMPT HAS BEEN
MADE TO PREVENT ERROR. THE BUILDER
AND SUBCONTRACTORS ARE REQUIRED TO
REVIEW ALL THE INFORMATION CONTAINED
IN THESE DOCUMENTS, PRIOR TO
COMMENCEMENT OF ANY WORK.
NVISIONTEK IS NOT RESPONSIBLE FOR ANY
PLAN ERRORS, OMISSIONS, OR
MISINTERPRETATIONS UNDETECTED AND
NOT REPORTED WITHIN 3 DAYS AFTER FINAL

VERIFY ALL STRUCTURAL ITEMS ON PLANS WITH LICENSED STRUCTURAL ENGINEER

SUBMISSION OF DRAWINGS.

IF THE GENERAL CONTRACTOR OR
ARCHITECT IS SHOWN ON THE COVER
SHEET, PLEASE USE THEM AS YOUR FIRST
POINT OF CONTACT BEFORE CONTACTING
NVISIONTEK, LLC. OTHERWISE, ANY
QUESTIONS CONCERNING THESE
DOCUMENTS SHALL BE DIRECTED TO
DUSTIN HETRICK AT NVISIONTEK, LLC, CELL:
(804) 372-0991, EMAIL:
DHETRICK@NVISIONTEKBIM.COM.

PROJECT NAME

UNION HILL AT 1308 N 26TH STREET

CLIENT(S)

CENTER CREEK HOMES 11 S 12TH STREET, SUITE

RICHMOND, VA, 23219 T: 804.999.4449

PROJECT ADDRESS

1308 N 26TH STREET RICHMOND, VA 23223

TITLE

AREA PLANS

DOCUMENT PHASE:PERMIT SET

PLOT DATE:


11/1/2021 9:56:54 AM

DRAWN BY:DUSTIN HETRICK

SCALE: SEE PLAN

SHEET 1

2 OF 17

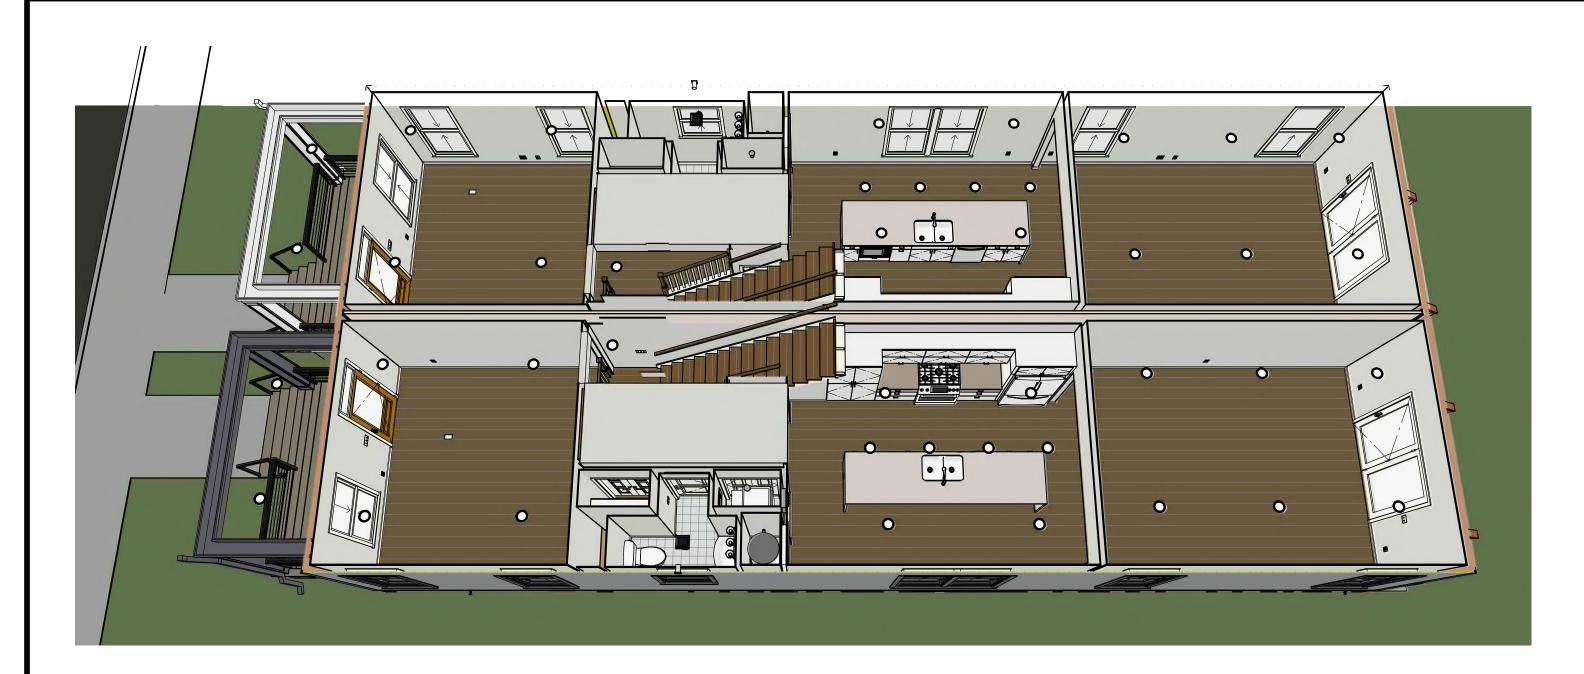


1 3D OVERVIEW OF 1ST FLOOR

NOT TO SCALE - FOR REFERENCE ONLY



3 3D OVERVIEW OF 3RD FLOOR

NOT TO SCALE - FOR REFERENCE ONLY

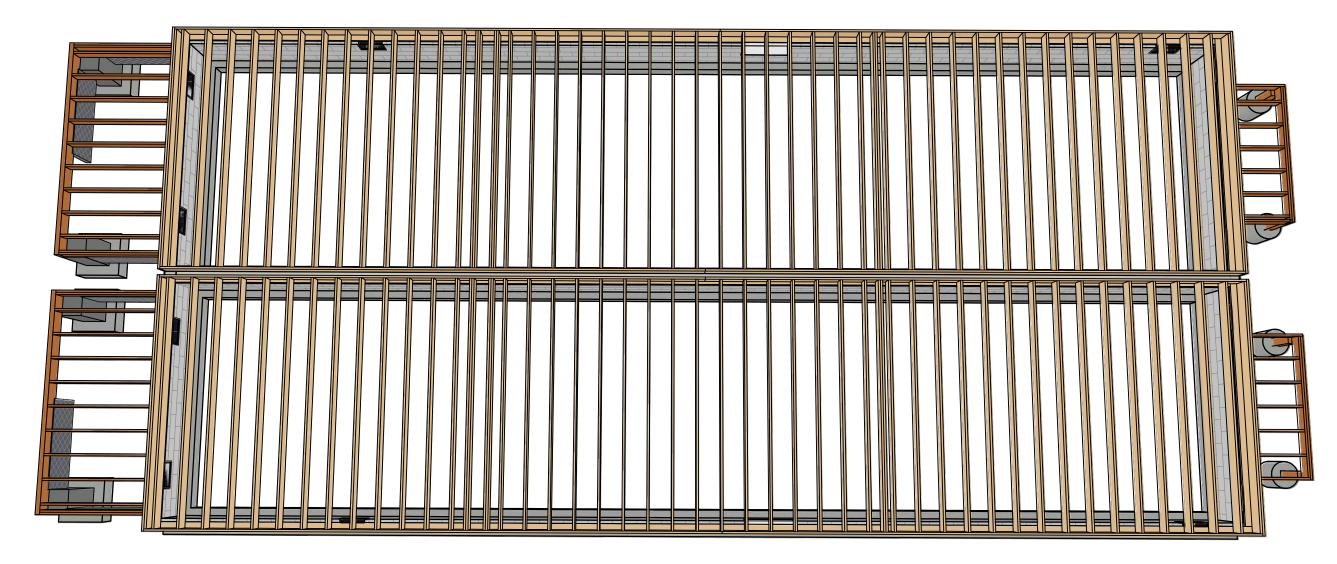


5 3D OVERVIEW OF FOUNDATION

NOT TO SCALE - FOR REFERENCE ONLY



2 3D OVERVIEW OF 2ND FLOOR

NOT TO SCALE - FOR REFERENCE ONLY

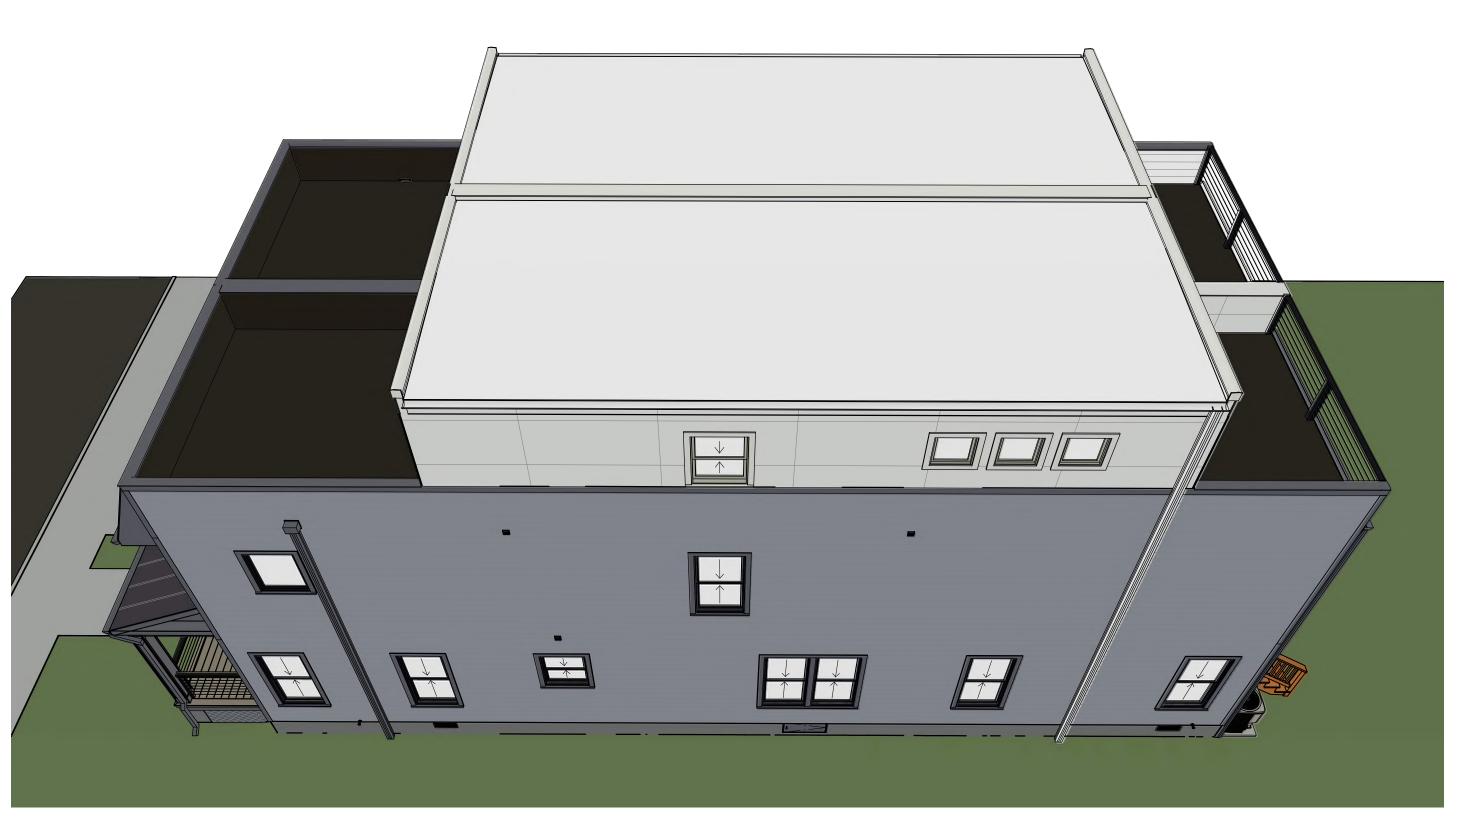

4 3D OVERVIEW OF ROOF

NOT TO SCALE - FOR REFERENCE ONLY

GENERAL ELEVATION & 3D NOTES 1. REFERENCE WINDOW, DOOR, OR ANY OTHER TAGS TO LEGENDS AND SCHEDULES,

SHOWN THROUGHOUT SET.

2. ANY FURNITURE SHOWN IS GENERIC AND IS FOR REFERENCE ONLY. CONSULT WITH INTERIOR DESIGNER (IF APPLICABLE) FOR SPACE PLANNING.

3. ALL MATERIALS, PATTERNS, TRIM, WINDOWS, DOORS, CASEWORK, APPLIANCES, AND OTHER FIXTURES SHOWN DO NOT REPRESENT EXACT SELECTIONS. GENERIC STYLES SHOWN, UNLESS OTHERWISE INDICATED.

4. TOPOGRAPHY SHOWN IS RELATIVELY ACCURATE, BUT NOT EXACT. REFER TO SURVEY PHOTOS OR SITE PLAN (BY OTHERS).

5. IF KEYNOTES ARE USED, REFERENCE KEYNOTE LEGEND ON THIS SHEET FOR DESCRIPTION.

nVisionTEK

NVISIONTEKBIM.COM INFO@NVISIONTEKBIM.COM CELL: 804.372.0991 RICHMOND, VA 23236

REVISIONS

DATE DESCRIPTION

BUILDER NOTICE

IT IS THE INTENT OF THE DESIGNER /
DRAFTER LISTED IN THE TITLE BLOCK OF
THESE DOCUMENTS THAT THESE
DOCUMENTS ARE ACCURATE, PROVIDING
LICENSED PROFESSIONALS CLEAR
INFORMATION. EVERY ATTEMPT HAS BEEN
MADE TO PREVENT ERROR. THE BUILDER
AND SUBCONTRACTORS ARE REQUIRED TO
REVIEW ALL THE INFORMATION CONTAINED
IN THESE DOCUMENTS, PRIOR TO
COMMENCEMENT OF ANY WORK.
NVISIONTEK IS NOT RESPONSIBLE FOR ANY
PLAN ERRORS, OMISSIONS, OR
MISINTERPRETATIONS UNDETECTED AND
NOT REPORTED WITHIN 3 DAYS AFTER FINAL

VERIFY ALL STRUCTURAL ITEMS ON PLANS WITH LICENSED STRUCTURAL ENGINEER

SUBMISSION OF DRAWINGS.

IF THE GENERAL CONTRACTOR OR ARCHITECT IS SHOWN ON THE COVER SHEET, PLEASE USE THEM AS YOUR FIRST POINT OF CONTACT BEFORE CONTACTING NVISIONTEK, LLC. OTHERWISE, ANY QUESTIONS CONCERNING THESE DOCUMENTS SHALL BE DIRECTED TO DUSTIN HETRICK AT NVISIONTEK, LLC, CELL: (804) 372-0991, EMAIL: DHETRICK@NVISIONTEKBIM.COM.

PROJECT NAME

UNION HILL AT 1308 N 26TH STREET

CLIENT(S)

CENTER CREEK HOMES
11 S 12TH STREET, SUITE

RICHMOND, VA, 23219 T: 804.999.4449

PROJECT ADDRESS

1308 N 26TH STREET RICHMOND, VA 23223

TITLE

3D OVERVIEWS

DOCUMENT PHASE:

PERMIT SET

PLOT DATE: 11/1/2021 9:56:55 AM


DRAWN BY:

DUSTIN HETRICK

SCALE: SEE PLAN

SHEET

A0.2

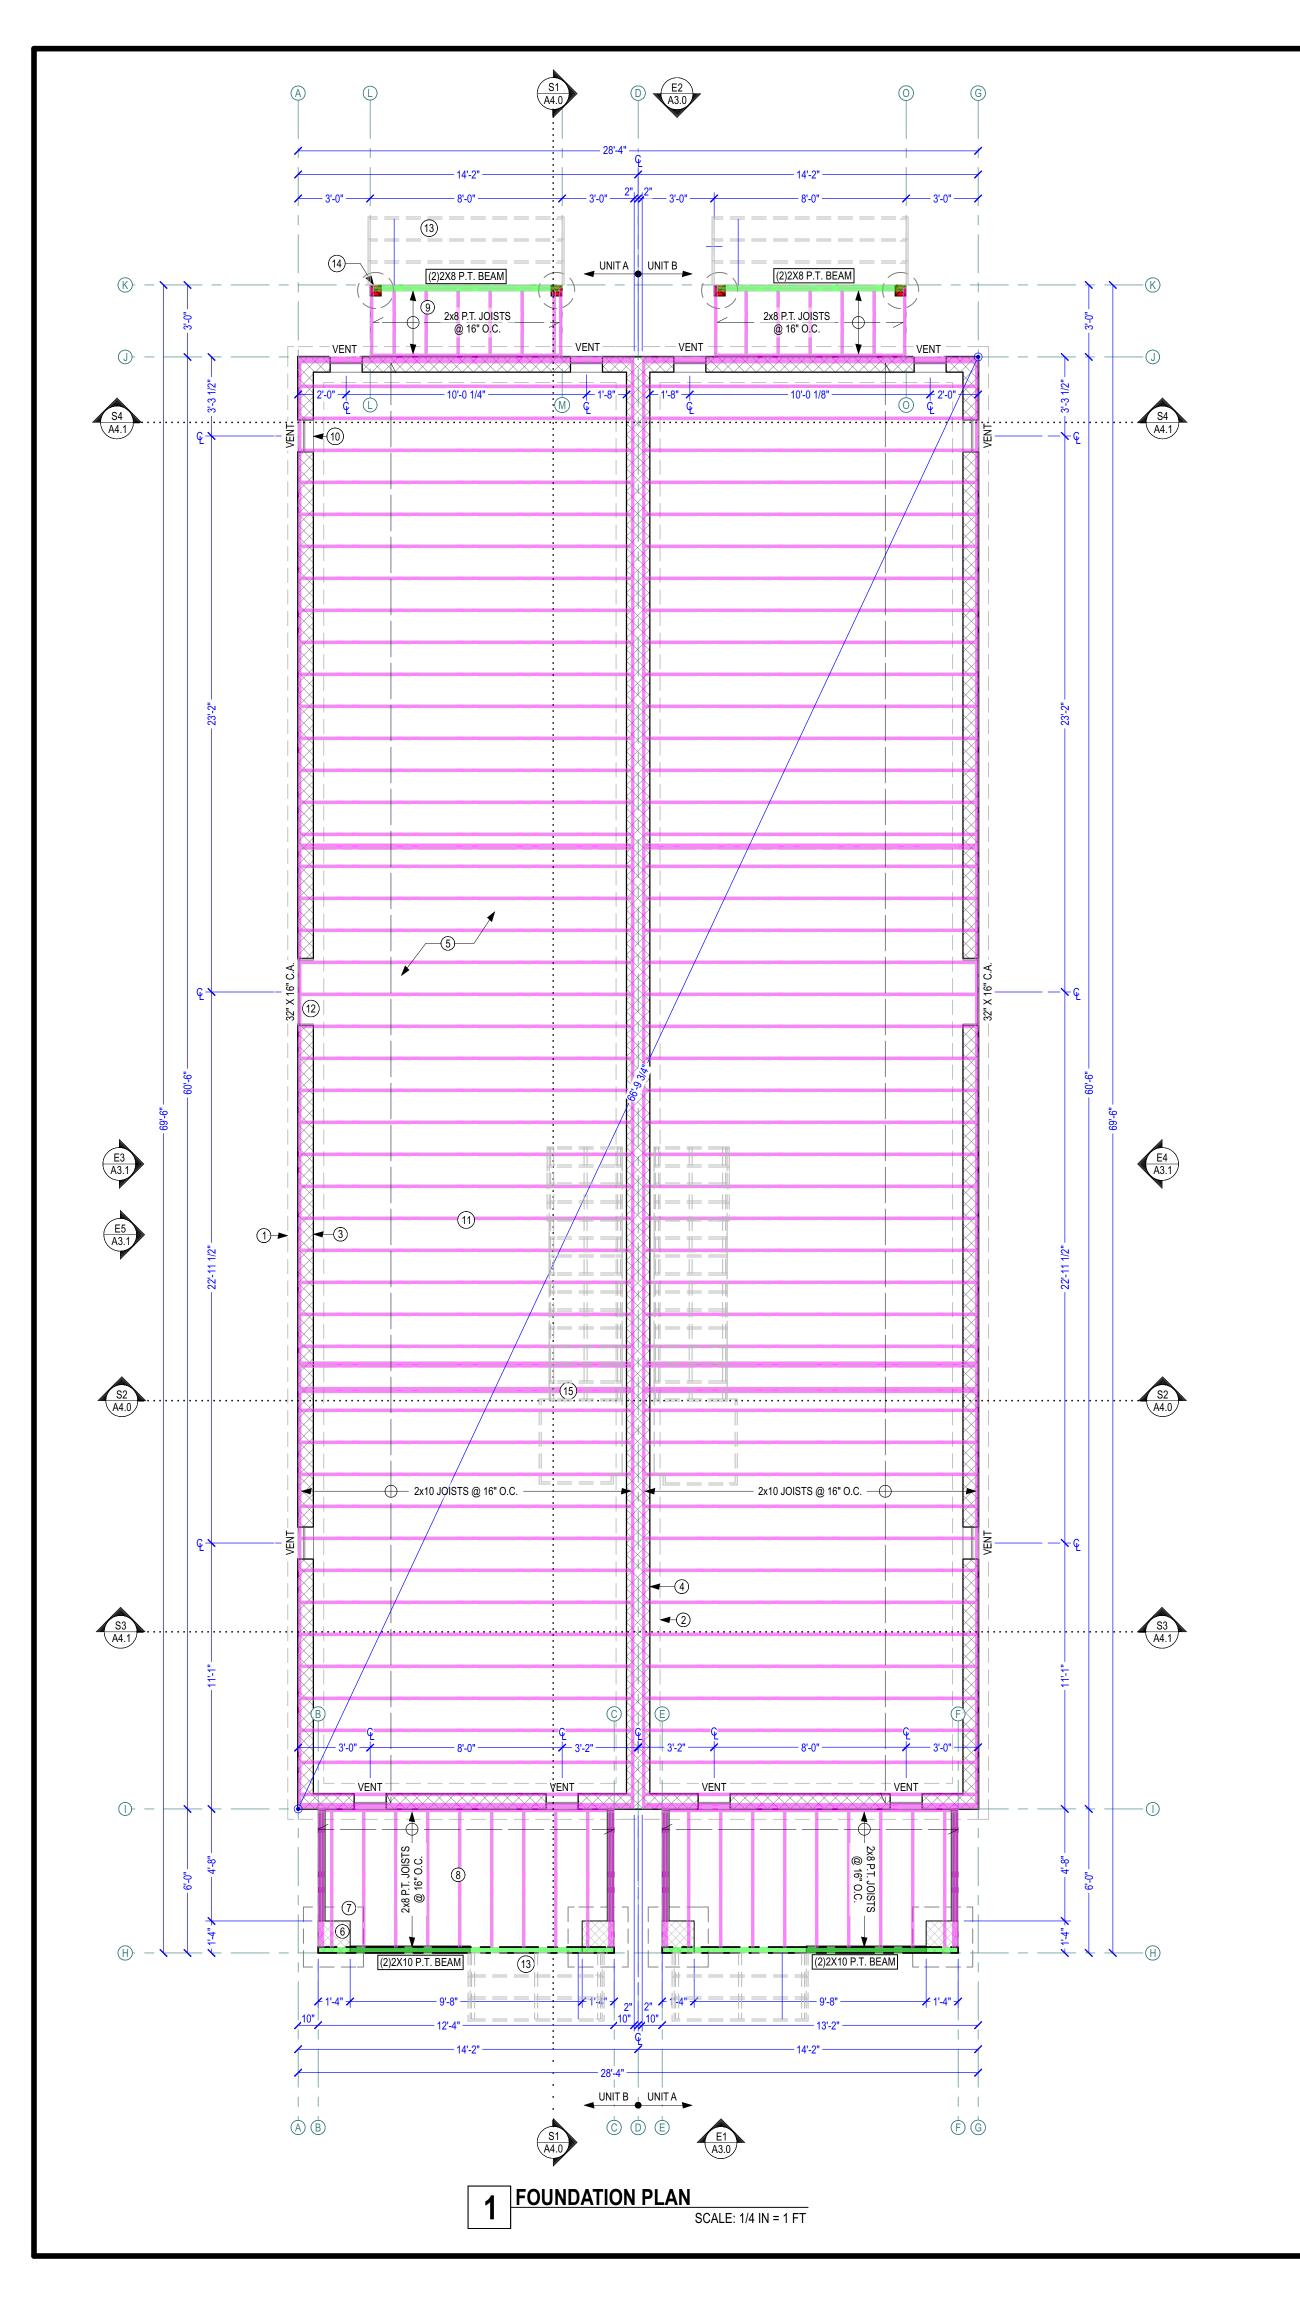

PENDING PLOT PLAN FROM SURVEYOR

CONT. 18" WIDE X 10" DEEP CONCRETE FOOTING W/(2) CONT. #4 REBAR REINFORCING;
BOTTOM OF FOOTING MIN. 18" BELOW GRADE - SEE GEOTECH REPORT FOR FURTHER INSTRUCTIONS/SPECS, TYP. ALL FOOTINGS U.N.O.

CONT. 22" WIDE X 10" DEEP CONCRETE FOOTING WITH (2) CONT. #4 REBAR REINFORCING;
BOTTOM OF FOOTING MIN. 30" BELOW GRADE- SEE GEOTECH. REPORT FOR FURTHER

INSTRUCTIONS/SPECS. (TYP. ALL FOOTINGS U.N.O.)

8" CMU FOUNDATION WALL WITH PARGE COAT TO GRADE, #4 VERTICAL REINFORCING WITH
BENT HOOK INTO FOOTING BELOW & ANCHOR BOLTS AT 6' O.C., MAX 12" FROM CORNERS/
ENDS, MIN. (2) PER WALL SEGMENT; GROUT CELLS AT REINFORCING/ANCHOR BOLTS SOLID-

12" CMU FOUNDATION WALL WITH #4 VERTICAL REINFORCING WITH BENT HOOK INTO FOOTING
BELOW & ANCHOR BOLTS AT 6' O.C., MAX 12" FROM CORNERS/ENDS, MIN. (2) PER WALL
SEGMENT; GROUT CELLS AT REINFORCING/ANCHOR BOLTS SOLID- SEE ENLARGED PARTY

20 MIL VAPOR BARRIER OVER ENTIRE CRAWLSPACE; OVERLAP SEAMS MIN. 6" AND TAPE, CONT. MIN. 6" UP FOUNDATION AND TAPE

16"X16" CMU PIERS W/PARGE COAT TO GRADE, GROUT & TAPER TOP FOR WATER DRAINAGE

(7) 30"W X 12" THICK SQUARE CONCRETE FOOTING WITH (2) #4 EACH WAY, MIN. 18" BELOW GRADE

PORCH FRAMING: 5/4 P.T. DECKING BOARDS OVER 2X8 P.T. JOISTS AT 16" O.C. W/GALV.
HANGERS W/(3) 2X10 P.T. OUTER BEAM & 2X8 P.T. LEDGER BOARD W/ 1/2" GALV. THROUGH

BOLTS AT 32" O.C. STAGGERED, PROVIDE METAL FLASHING AT HOUSE

DECK FRAMING: 5/4X6 P.T. DECKING BOARDS OVER 2X8 P.T. JOISTS AT 16" O.C. W/GALV.

HANGERS & (2)2X8 P.T. FLUSH OUTER BEAM & 2X8 P.T. LEDGER BOARD W/ 1/2" GALV. THROUGH

BOLTS AT 16" O.C. STAGGERED

8X16 SLOTTED GALVANIZED CRAWLSPACE VENT WITH INSECT SCREE, TYP. AS SHOWN - SEE FOUNDATION NOTES FOR VENTING REQUIREMENTS

2X10 FLOOR JOISTS AT 16" O.C. WITH 2X10 RIM BOARD ENTIRE PERIMETER, W/R-19 BATT INSULATION, TYPICAL THROUGHOUT FIRST FLOOR LEVEL

| 12 | MIN. 32"X16" CRAWL-SPACE ACCESS WITH PRE-FAB DOOR

13) EXTERIOR WOOD STEPS ABOVE

P.T. 6X6 DECK POSTS FASTENED W/SIMPSON POST BASE ON 18"DIA CONCRETE FOOTINGS MIN. 18" BELOW GRADE, TYP. - SEE ENLARGED DETAIL

15) DBL. JOIST UNDER START OF STAIRS

nVisionTEK BIM SERVICES

> NVISIONTEKBIM.COM INFO@NVISIONTEKBIM.COM CELL: 804.372.0991 RICHMOND, VA 23236

> > **REVISIONS**

DATE DESCRIPTION

BUILDER NOTICE

IT IS THE INTENT OF THE DESIGNER /
DRAFTER LISTED IN THE TITLE BLOCK OF
THESE DOCUMENTS THAT THESE
DOCUMENTS ARE ACCURATE, PROVIDING
LICENSED PROFESSIONALS CLEAR
INFORMATION. EVERY ATTEMPT HAS BEEN
MADE TO PREVENT ERROR. THE BUILDER
AND SUBCONTRACTORS ARE REQUIRED TO
REVIEW ALL THE INFORMATION CONTAINED
IN THESE DOCUMENTS, PRIOR TO
COMMENCEMENT OF ANY WORK.
NVISIONTEK IS NOT RESPONSIBLE FOR ANY
PLAN ERRORS, OMISSIONS, OR
MISINTERPRETATIONS UNDETECTED AND
NOT REPORTED WITHIN 3 DAYS AFTER FINAL

VERIFY ALL STRUCTURAL ITEMS ON PLANS WITH LICENSED STRUCTURAL ENGINEER

SUBMISSION OF DRAWINGS.

IF THE GENERAL CONTRACTOR OR ARCHITECT IS SHOWN ON THE COVER SHEET, PLEASE USE THEM AS YOUR FIRST POINT OF CONTACT BEFORE CONTACTING NVISIONTEK, LLC. OTHERWISE, ANY QUESTIONS CONCERNING THESE DOCUMENTS SHALL BE DIRECTED TO DUSTIN HETRICK AT NVISIONTEK, LLC, CELL: (804) 372-0991, EMAIL: DHETRICK@NVISIONTEKBIM.COM.

PROJECT NAME

UNION HILL AT 1308 N 26TH STREET

CLIENT(S)

CENTER CREEK HOMES 11 S 12TH STREET, SUITE

RICHMOND, VA, 23219 T: 804.999.4449

PROJECT ADDRESS

1308 N 26TH STREET RICHMOND, VA 23223

TITLE

FOUNDATION & SITE PLANS

DOCUMENT PHASE:

PERMIT SET

PLOT DATE: 11/1/2021 9:56:56 AM


DRAWN BY:

DUSTIN HETRICK

SCALE: SEE PLAN

SHEET

A1.0

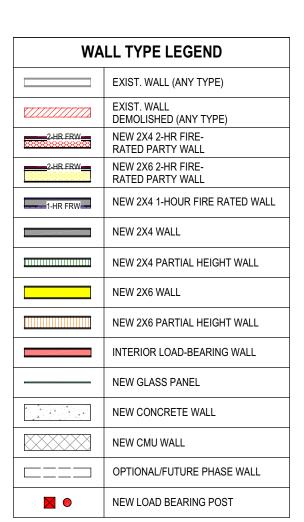

GENERAL FOUNDATION NOTES

1. FOUNDATION WALLS TO BE CONCRETE MASONRY UNITS (CMU) WITH PARGE COAT TO GRADE. IF WALL TAGS ARE SHOWN, REFER TO WALL LEGEND FOR ASSEMBLY INFORMATION AND THICKNESSES.

E. FOOTINGS ARE POURED CONCRETE AND DEVELOP 3,000 PSI IN 28 DAYS. TO BE SIZED PER LOCAL CODES AND ENGINEER REVIEW. FROST FOOTINGS SHALL BE INSTALLED AT 18" MIN. BELOW GRADE AND SHALL BE DICTATED BY SITE TOPOGRAPHY AND LOCAL CODE REQUIREMENTS. STEPPED FOOTINGS ARE INDICATED WITH "SF-SF" SYMBOLS. NEW FOOTINGS SHALL NOT COMPROMISE THE STRUCTURAL INTEGRITY OF ANY ADJACENT EXISTING FOOTING THAT IS TO

3. SLAB ON GRADES ARE POURED CONCRETE AND DEVELOP 3,000 PSI IN 28 DAYS. PROVIDE WELD SMOOTH WIRE FABRIC MINIMUM 6x6- W2.1 x 2.1, U.N.O. SLAB TO HAVE 6-MIL POLY VAPOR BARRIER AND 4" CRUSHED STONE OVER COMPACTED FILL

CRAWL ACCESS TO BE PROVIDED, 16" x 24" MIN. SIZE, IN PERIMETER WALL.
PROVIDE CLEARANCE OPENING BELOW GRADE IF NECESSARY. REFERENCE IRC R408.4.


5. 12 MIL VAPOR BARRIER OVER ENTIRE CRAWLSPACE; OVERLAP SEAMS MIN. 6" AND TAPE, CONT. MIN. 6" UP FOUNDATION AND TAPE.

SPACES, MIN. OF 1 PER 150 SQ. FT. REFERENCE IRC R408.1 AND R408.2.

7. ALL DIMENSIONS ARE TO FACE OF FOUNDATION OR CENTER OF COLUMNS AND BEAMS, U.N.O.

6. 16"x8" FOUNDATION VENTS TO BE PROVIDED FOR UNCONDITIONED CRAWL

8. IF KEYNOTES ARE USED, REFERENCE KEYNOTE LEGEND ON THIS SHEET FOR DESCRIPTION

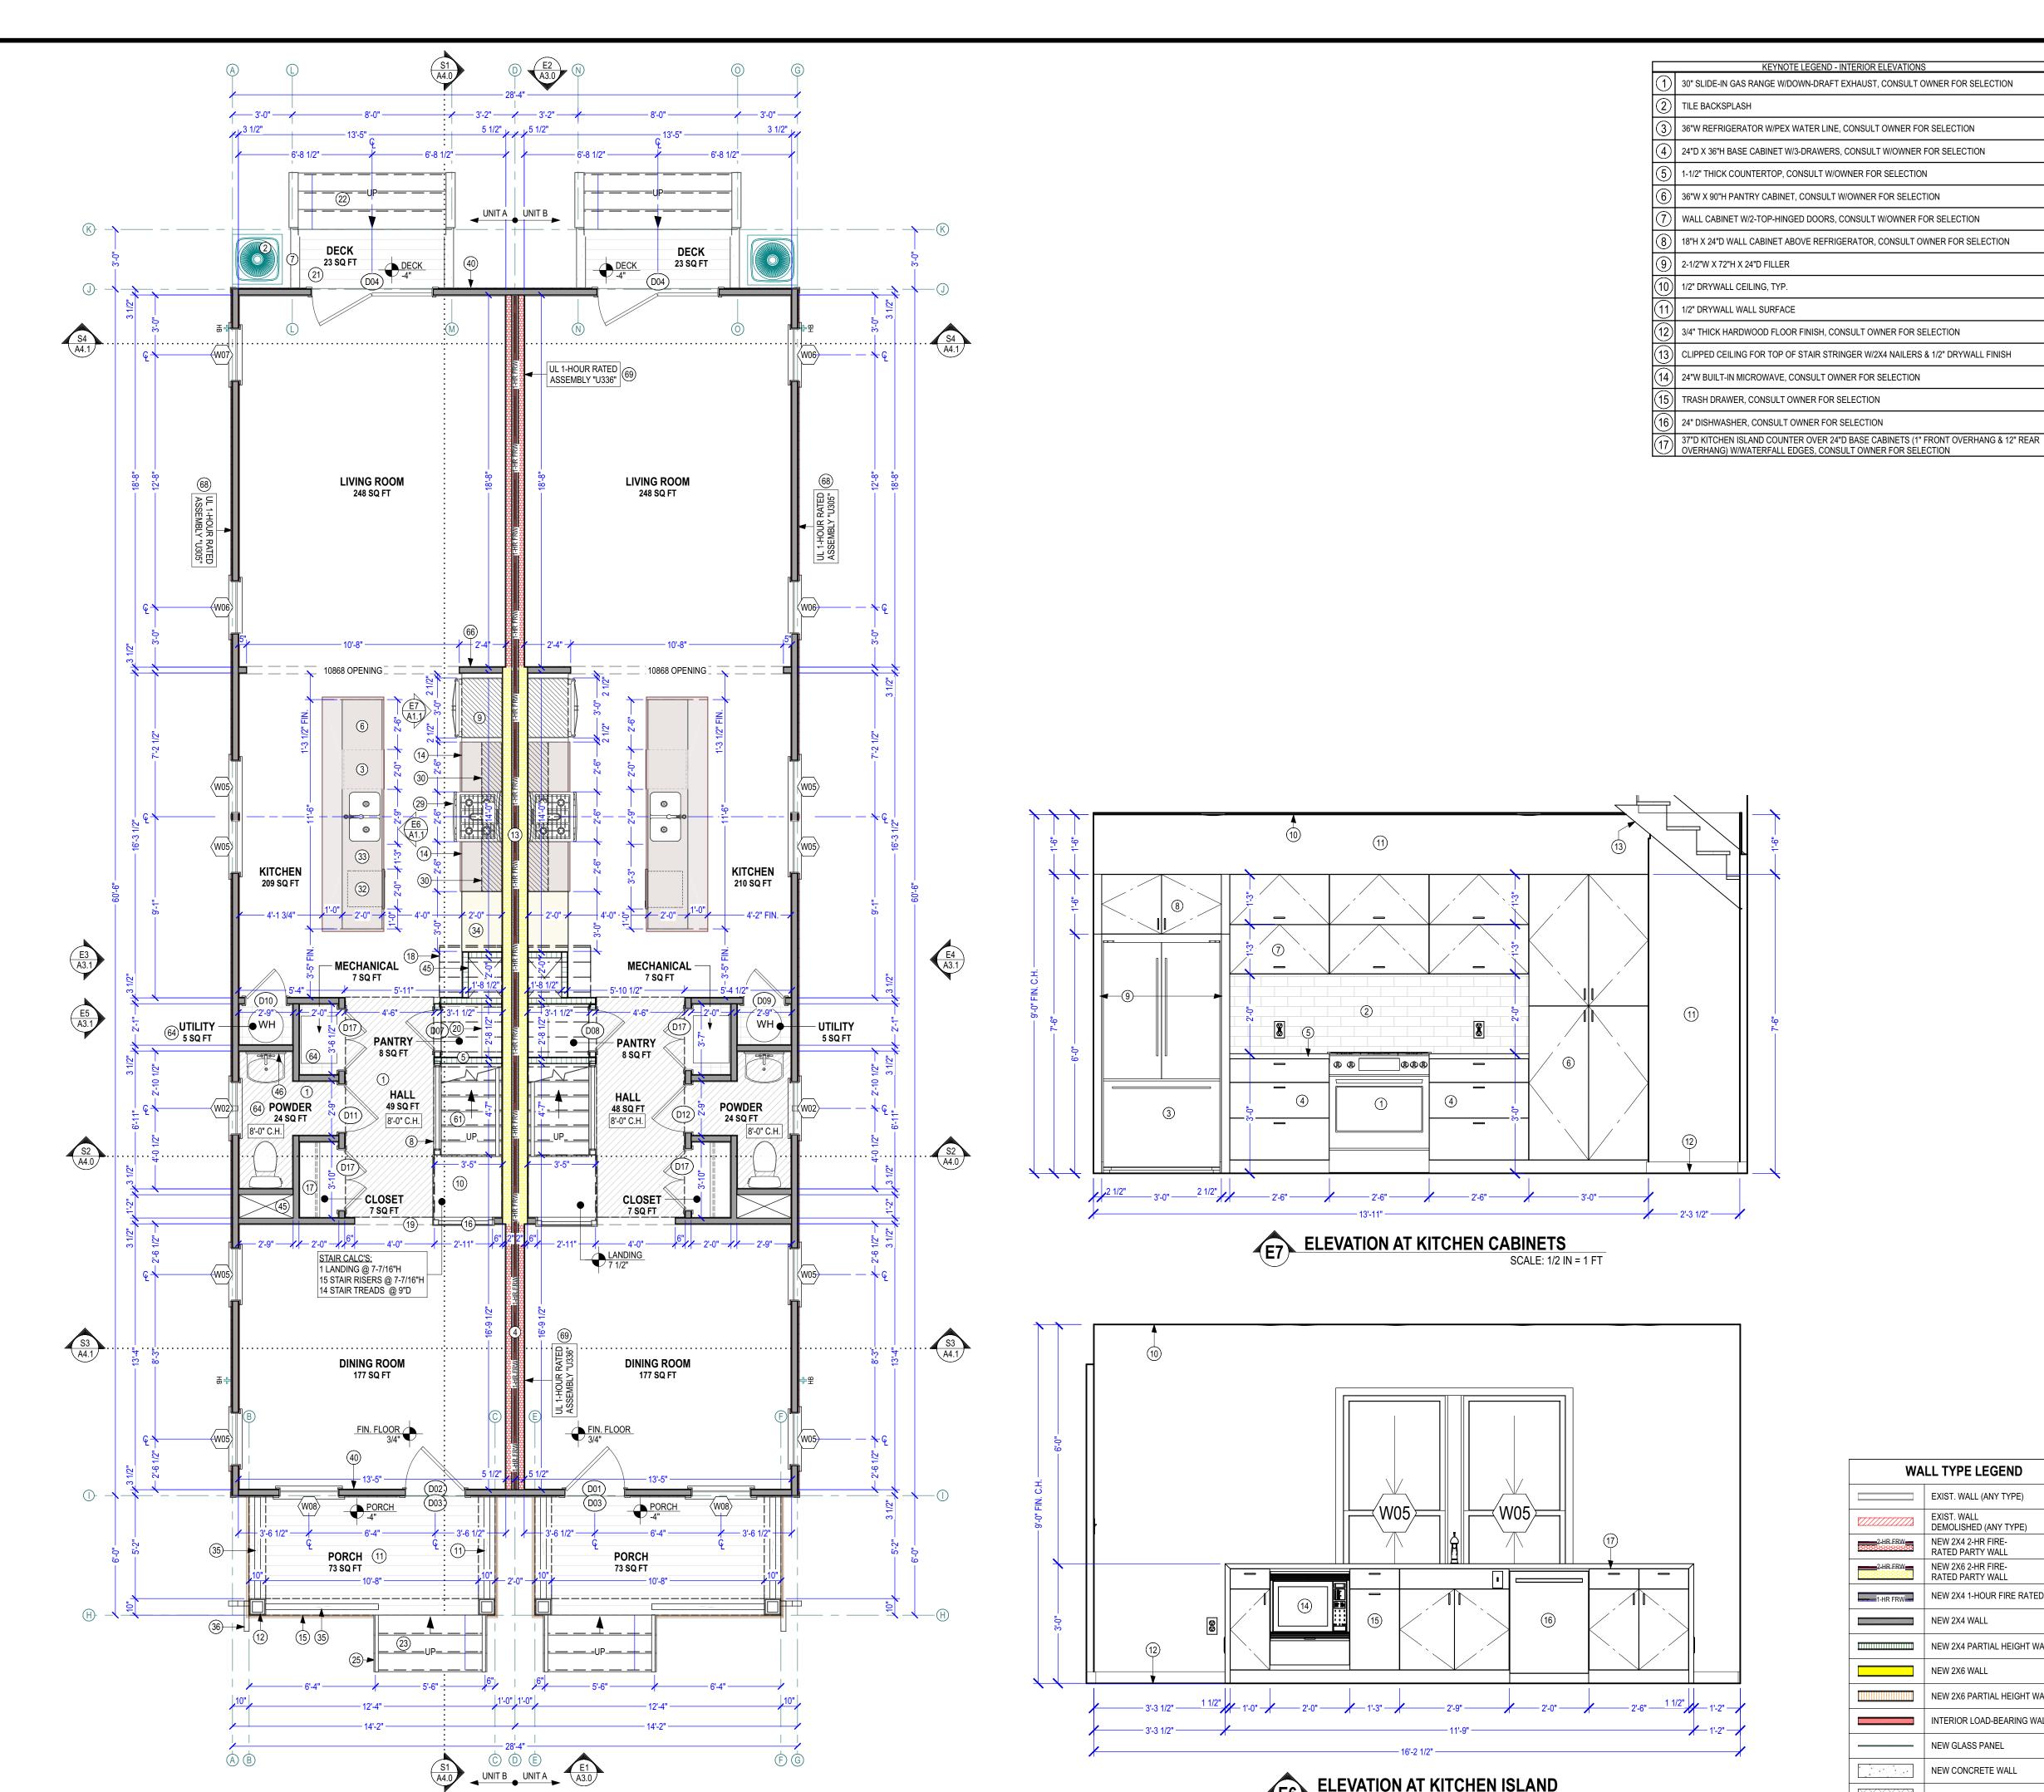

1ST FLOOR CONSTRUCTION PLAN

SCALE: 1/4 IN = 1 FT

1ST FLOOR LIVING AREA: 1700 SQ FT

FINISHED CEILING HEIGHT: 9'-0", U.N.O.

12"H SOFFIT FOR HVAC DUCT - 2X4 LADDER FRAME W/ 1/2" GYPSUM DRYWALL FINISH PROVIDING 8'-0" FINISHED CELING HEIGHT

HVAC AIR CONDENSER - REFER TO HVAC CONTRACTOR FOR HVAC REQUIREMENTS

24" DISHWASHER, CONSULT OWNER FOR SELECTION

4) 2X4 FRAMED PARTY WALL - SEE ENLARGED DETAIL

2X4 KNEEWALL UNDER STAIRS W/ 1/2" DRYWALL FINISH

37"D KITCHEN ISLAND COUNTER OVER 24"D BASE CABINETS (1" FRONT OVERHANG & 12" REAR OVERHANG) W/WATERFALL EDGES, CONSULT OWNER FOR SELECTION 36"H P.T. WOOD DECK RAILING PER CODE W/4" WOOD BALUSTERS @ 4" O.C. MAX SPACING, 2X6 P.T. TOP RAIL, 2X4 TOP & BOTTOM NAILERS, & 4X4 P.T. WOOD POSTS AT 8'-0" O.C. MAX SPACING MOUNTED FLUSH INSIDE RIM JOIST - SEE ENLARGED DETAIL

2X4 FRAMED SLOPED RAILING WALL W/1X WOOD CAP W/34-36"H WOOD RAILING ABOVE PER

CODE (W/WOOD BALUSTERS AT 4" O.C. MAX SPACING & WOOD NEWEL POSTS, CONSULT W/ OWNER FOR SELECTIONS) 36"W REFRIGERATOR W/18"H X 24"D WALL CABINET ABOVE, CONSULT OWNER FOR SELECTION

1ST LEVEL STAIR LANDING: 3/4" HARDWOOD FLOOR FINISH (U.N.O., OWNER TO SELECT) OVER 3/4" T&G SUBFLOOR W/ADHESIVE OVER 2X6 JOISTS AT 16" O.C. PORCH FRAMING: 5/4 P.T. DECKING BOARDS OVER 2X8 P.T. JOISTS AT 16" O.C. W/GALV.

HANGERS W/(3) 2X10 P.T. OUTER BEAM & 2X8 P.T. LEDGER BOARD W/ 1/2" GALV. THROUGH BOLTS AT 32" O.C. STAGGERED, PROVIDE METAL FLASHING AT HOUSE

10" SQUARE LOAD-BEARING SYNTHETIC COLUMN - PROVIDE 4X4 P.T. WOOD POST DOWN TO

PIER W/GALV. POST ANCHOR) 2X6 FRAMED PARTY WALL - SEE ENLARGED DETAIL

DASHED LINE OF (3)2X10 BOX BEAM AROUND PORCH - SEE ENLARGED DETAIL

4) 24"D X 36"H BASE CABINETS W/COUNTERTOP, CONSULT W/OWNER FOR SELECTION

34-36"H WOOD RAILING ON EDGE OF LANDING, PER CODE (W/WOOD BALUSTERS AT 4" O.C. MAX SPACING & WOOD NEWEL POSTS, CONSULT W/OWNER FOR SELECTIONS)

STAIR STRINGERS EXPOSED BELOW CEILING, PROVIDE 2X4 BLOCKING AT 16" O.C. W/ 1/2"

DRYWALL CEILING FINISH

19) 8'-0"H OPENING

MULTI-SHELVING FOR PANTRY

DECK FRAMING: 5/4X6 P.T. DECKING BOARDS OVER 2X8 P.T. JOISTS AT 16" O.C. W/GALV. HANGERS & (2)2X8 P.T. FLUSH OUTER BEAM & 2X8 P.T. LEDGER BOARD W/ 1/2" GALV. THROUGH

T. WOOD STEPS TO GRADE W/36"H P.T. WOOD RAILING PER CODE W/4" WOOD BALUSTERS (2) @ 4" O.C. MAX SPACING, 2X6 P.T. TOP RAIL, 2X4 TOP & BOTTOM NAILERS, & 4X4 P.T. WOOD

POSTS - SEE ENLARGED DETAIL
WOOD STAIRS FROM CONCRETE SIDEWALK UP TO PORCH FLOOR, VERIFY GRADE HEIGHT IN) FIELD; 11" TREADS, MAX. 8" RISERS, TREAD MATERIAL TO MATCH PORCH FLOOR, PROVIDE LATTICE SKIRTING

BLACK PAINTED STEEL/IRON HANDRAIL AT STEPS, MIN. 34"H

29) 30" SLIDE-IN GAS RANGE W/DOWN-DRAFT EXHAUST, CONSULT OWNER FOR SELECTION

WALL CABINETS, CONSULT W/OWNER FOR SELECTION

24"W BUILT-IN MICROWAVE, CONSULT OWNER FOR SELECTION

TRASH DRAWER, CONSULT OWNER FOR SELECTION

(4) 36"W X 90"H PANTRY CABINET, CONSULT W/OWNER FOR SELECTION

36"H BLACK PAINTED STEEL/IRON HANDRAIL, MIN. 36"H, W/STAINLESS STEEL CABLES AT 4" O.C., RAILING REQUIREMENT T.B.D. BY SITE TOPOGRAPHY AND HEIGHT OF PORCH FLOOR

ALUMINUM DOWNSPOUT W/TOP ELBOW CONNECTED TO GUTTER AT FRONT AND BOTTOM ELBOW AT SIDE OF COLUMN/PIER EXT. WALL CONSTRUCTION AT F/R 1ST & 2ND LEVELS: HORIZONTAL LAP SIDING OVER HOUSE

WRAP VAPOR BARRIER OVER 7/16" OSB SHEATHING (BOTTOM TO OVERLAP FOUNDATION 1") OVER 2X4 STUDS AT 16" O.C. W/(2) TOP PLATE & (1) BOTTOM PLATE W/CAULK W/R-15 BATT INSULATION (BETWEEN STUDS) OVER 1/2" GYPSUM DRYWALL FINISH

(45) HVAC CHASE

ABOVE FINISHED GRADE

(6) MIRROR TO BE SELECTED BY OWNER

61) STAIRS PER CODE TO ABOVE W/WOOD RISERS, TREADS, & SKIRT BOARDS 3/4" TILE FLOOR FINISH, TYP. AT ALL WET LOCATIONS U.N.O., CONSULT W/OWNER FOR

(66) TYP. 2X4 INTERIOR WALL W/ 1/2" DRYWALL FINISH

UL 1-HOUR RATED ASSEMBLY "U305": HORIZONTAL LAP SIDING OVER HOUSE WRAP VAPOR

RRIER OVER 5/8" FIRE-RATED DENSGLASS SHEATHING (BOTTOM TO OVERLAP FOUNDATION 1") OVER 2X4 STUDS AT 16" O.C. W/(2) TOP PLATE & (1) BOTTOM PLATE W/CAULK W/R-15 BATT

GENERAL FLOOR PLAN NOTES

FOUNDATION. INTERIOR DIMENSIONS ARE TO FACE OF STUD, U.N.O. THICKNESS

WINDOWS AT BEDROOMS TO MEET EGRESS SIZE REQUIREMENTS. TEMPERED GLAZING SHALL BE USED AT ALL WINDOW AND DOOR LOCATIONS AS REQUIRED BY

3. ALL WINDOWS & ALL DOORS IN BEARING WALLS SHALL HAVE MIN. (2) JACK STUDS

& (2)2x6 HEADERS, U.N.O. REFERENCE WINDOW & DOOR TAGS TO WINDOW, AND

4. CONTRACTOR SHALL VERIFY ALL DIMENSIONS AND IS RESPONSIBLE FOR ALL

DIMENSIONS (INCLUDING ROUGH OPENINGS). ALL WORK TO BE DONE SHALL

INSULATION, AND 7/16" OSB SHEATHING, U.N.O.. BOTTOM PLATE TO BE FLUSH WITH FOUNDATION, AND SHEATHING TO OVERLAP 1" BELOW. ALL INTERIOR WALLS

TO BE 2x4, U.N.O. IF WALL TAGS ARE SHOWN, REFER TO WALL LEGEND AND

5. ALL EXTERIOR WALL FRAMING TO BE 2x4 STUDS AT 16" O.C. WITH BATT

9. PROVIDE BLOCKING FOR PLUMBING FIXTURES, CABINETS, SHELVING,

10. IF KEYNOTES ARE USED, REFERENCE KEYNOTE LEGEND ON THIS SHEET FOR

MECHANICAL SYSTEMS, ECT. AS REQUIRED. G.C. TO COORDINATE.

ALL WINDOW AND DOOR DIMENSIONS ARE TO CENTER OF ROUGH OPENING, U.N.O. REFER TO EXTERIOR ELEVATIONS FOR WINDOW TOP HEIGHTS. ALL

1. ALL EXTERIOR FRAMING DIMENSIONS ARE TO FACE OF STUD / FACE OF

OF 2x6 WALLS = 5-1/2", AND 2x4 WALLS = 3-1/2".

CODE. REFERENCE SECTIONS R308.

COMPLY WITH ALL APPLICABLE CODES.

DOOR SCHEDULES..

DESCRIPTION.

O.C. W/(2) TOP PLATE & (1) BOTTOM PLATE W/CAULK & R-15 BATT INSULATION (BETWEEN STUDS), 1" AIR SPACE W/1" TYPE SLX GYPSUM BOARD SHAFT LINER - ALL LAYERS LISTED ARE BIM SERVICES

NVISIONTEKBIM.COM INFO@NVISIONTEKBIM.COM CELL: 804.372.0991 RICHMOND, VA 23236

REVISIONS

DATE DESCRIPTION

BUILDER NOTICE

T IS THE INTENT OF THE DESIGNER / DRAFTER LISTED IN THE TITLE BLOCK OF THESE DOCUMENTS THAT THESE DOCUMENTS ARE ACCURATE, PROVIDING LICENSED PROFESSIONALS CLEAR INFORMATION. EVERY ATTEMPT HAS BEEN MADE TO PREVENT ERROR. THE BUILDER AND SUBCONTRACTORS ARE REQUIRED TO REVIEW ALL THE INFORMATION CONTAINED IN THESE DOCUMENTS, PRIOR TO COMMENCEMENT OF ANY WORK. NVISIONTEK IS NOT RESPONSIBLE FOR ANY PLAN ERRORS, OMISSIONS, OR MISINTERPRETATIONS UNDETECTED AND

SUBMISSION OF DRAWINGS. ***VERIFY ALL STRUCTURAL ITEMS ON PLANS WITH LICENSED STRUCTURAL

NOT REPORTED WITHIN 3 DAYS AFTER FINAL

ENGINEER***

IF THE GENERAL CONTRACTOR OR ARCHITECT IS SHOWN ON THE COVER SHEET, PLEASE USE THEM AS YOUR FIRST POINT OF CONTACT BEFORE CONTACTING *NVISIONTEK, LLC.* OTHERWISE, ANY QUESTIONS CONCERNING THESE DOCUMENTS SHALL BE DIRECTED TO DUSTIN HETRICK AT NVISIONTEK, LLC, CELL: (804) 372-0991, EMAIL: DHETRICK@NVISIONTEKBIM.COM.

PROJECT NAME

UNION HILL AT 1308 N 26TH STREET

CLIENT(S)

CENTER CREEK HOMES 11 S 12TH STREET, SUITE

RICHMOND, VA, 23219 T: 804.999.4449

PROJECT ADDRESS

1308 N 26TH STREET RICHMOND, VA 23223

TITLE

1ST FLOOR **CONSTRUCTION PLAN**

DOCUMENT PHASE:

PERMIT SET

PLOT DATE: 11/1/2021 9:56:57 AM

DRAWN BY:

DUSTIN HETRICK

SCALE: SEE PLAN

SHEET

5 OF 17

SCHEDULE FOR ASSEMBLY INFORMATION AND THICKNESSES. NEW 2X6 WALL 6. HATCHED AREAS INDICATE DROPPED CEILINGS, SOFFITS, OR WALL CABINETS, NEW 2X6 PARTIAL HEIGHT WALL 7. DOORS TO BE CENTERED IN CLOSETS OR HALLWAYS, U.N.O. 8. IF I-JOISTS OR FLOOR TRUSSES ARE SPECIFIED, REFER TO LAYOUT AND DETAILS PROVIDED BY JOIST MANUFACTURER. IF I-JOISTS OR FLOOR TRUSSES ARE SHOWN ON PLAN, THE LAYOUT IS "ASSUMED" U.N.O..

INTERIOR LOAD-BEARING WALL NEW GLASS PANEL

WALL TYPE LEGEND

EXIST. WALL

EXIST. WALL (ANY TYPE)

DEMOLISHED (ANY TYPE)

NEW 2X4 2-HR FIRE-

RATED PARTY WALL

NEW 2X6 2-HR FIRE-

NEW 2X4 WALL

RATED PARTY WALL


NEW 2X4 1-HOUR FIRE RATED WALL

NEW 2X4 PARTIAL HEIGHT WALL

NEW CONCRETE WALL

NEW CMU WALL

OPTIONAL/FUTURE PHASE WALL NEW LOAD BEARING POST

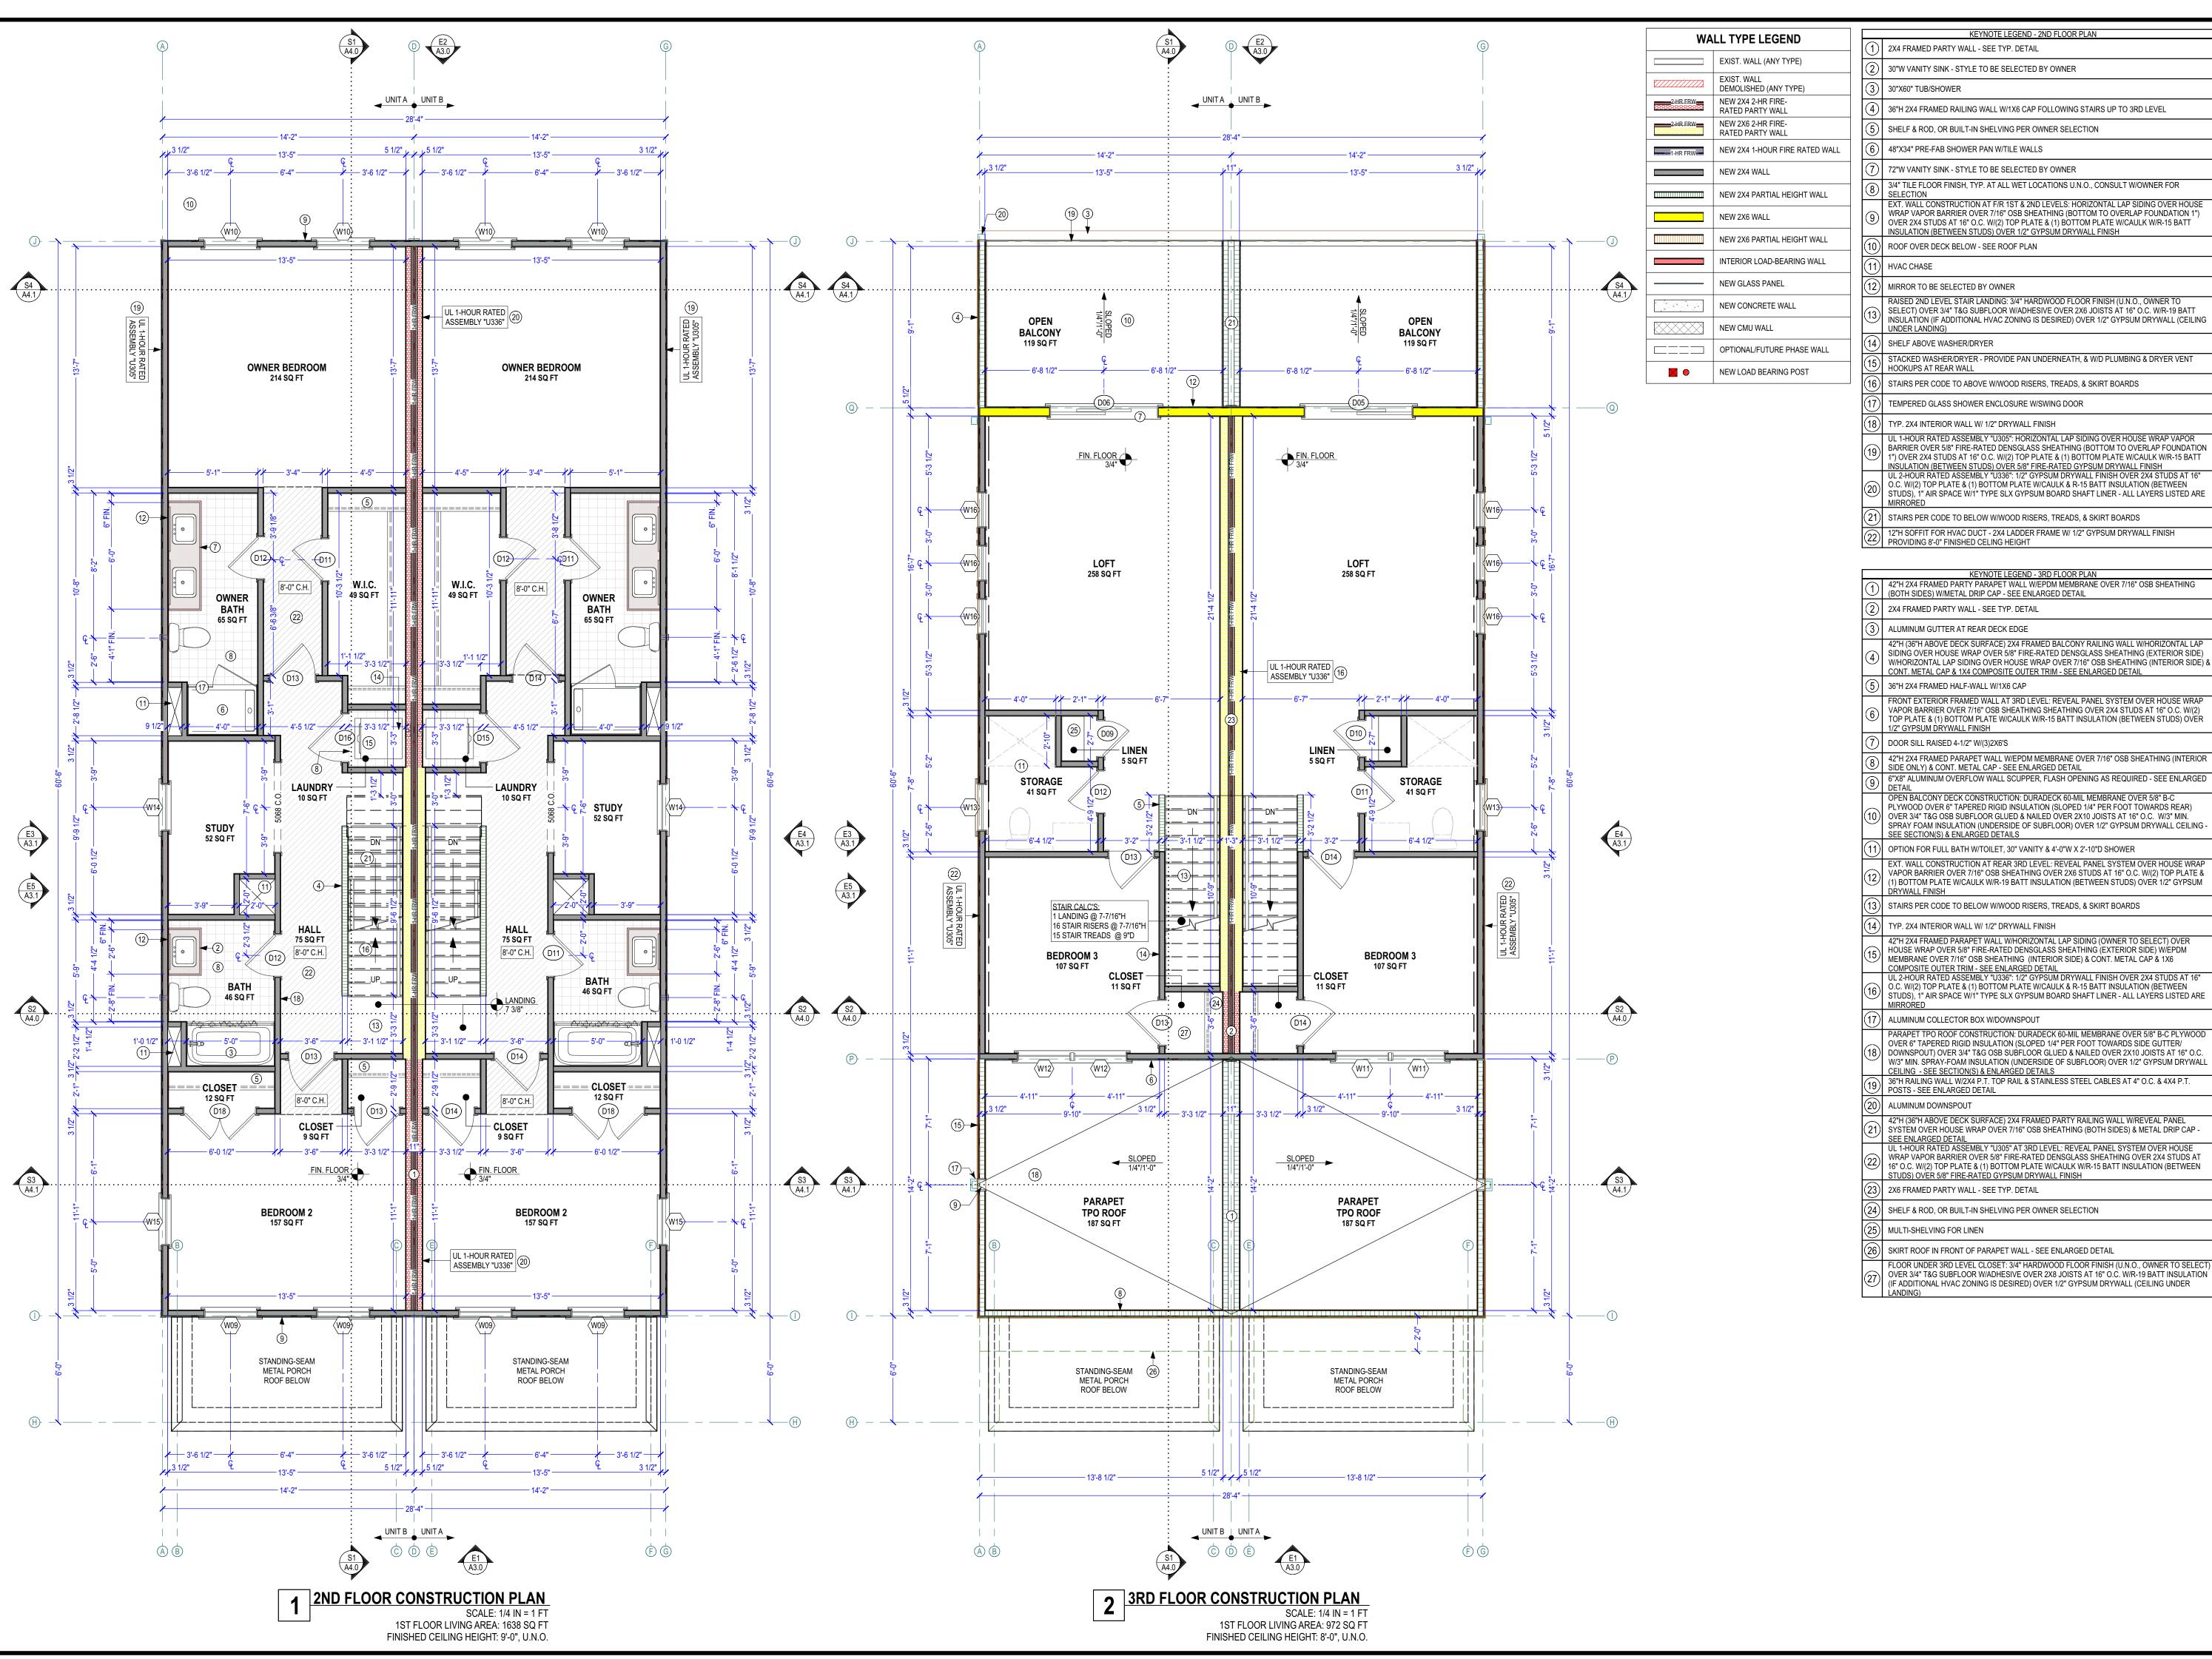



KEYNOTE LEGEND - 2ND FLOOR PLAN

NVISIONTEKBIM.COM INFO@NVISIONTEKBIM.COM CELL: 804.372.0991 RICHMOND, VA 23236

REVISIONS

DATE DESCRIPTION

BUILDER NOTICE

IT IS THE INTENT OF THE DESIGNER / DRAFTER LISTED IN THE TITLE BLOCK OF THESE DOCUMENTS THAT THESE DOCUMENTS ARE ACCURATE, PROVIDING LICENSED PROFESSIONALS CLEAR INFORMATION. EVERY ATTEMPT HAS BEEN MADE TO PREVENT ERROR. THE BUILDER AND SUBCONTRACTORS ARE REQUIRED TO REVIEW ALL THE INFORMATION CONTAINED IN THESE DOCUMENTS, PRIOR TO COMMENCEMENT OF ANY WORK. NVISIONTEK IS NOT RESPONSIBLE FOR ANY PLAN ERRORS, OMISSIONS, OR MISINTERPRETATIONS UNDETECTED AND NOT REPORTED WITHIN 3 DAYS AFTER FINAL SUBMISSION OF DRAWINGS.

VERIFY ALL STRUCTURAL ITEMS ON PLANS WITH LICENSED STRUCTURAL ENGINEER

IF THE GENERAL CONTRACTOR OR ARCHITECT IS SHOWN ON THE COVER SHEET, PLEASE USE THEM AS YOUR FIRST POINT OF CONTACT BEFORE CONTACTING *NVISIONTEK, LLC.* OTHERWISE, ANY QUESTIONS CONCERNING THESE DOCUMENTS SHALL BE DIRECTED TO DUSTIN HETRICK AT NVISIONTEK, LLC, CELL: (804) 372-0991, EMAIL: DHETRICK@NVISIONTEKBIM.COM.

PROJECT NAME

UNION HILL AT 1308 N **26TH STREET**

CLIENT(S)

CENTER CREEK HOMES 11 S 12TH STREET, SUITE

RICHMOND, VA, 23219 T: 804.999.4449

PROJECT ADDRESS

1308 N 26TH STREET RICHMOND, VA 23223

2ND & 3RD FLOOR CONSTRUCTION **PLANS**

DOCUMENT PHASE: PERMIT SET


PLOT DATE: 11/1/2021 9:56:58 AM

DRAWN BY: DUSTIN HETRICK

SCALE: SEE PLAN

SHEET

6 OF 17

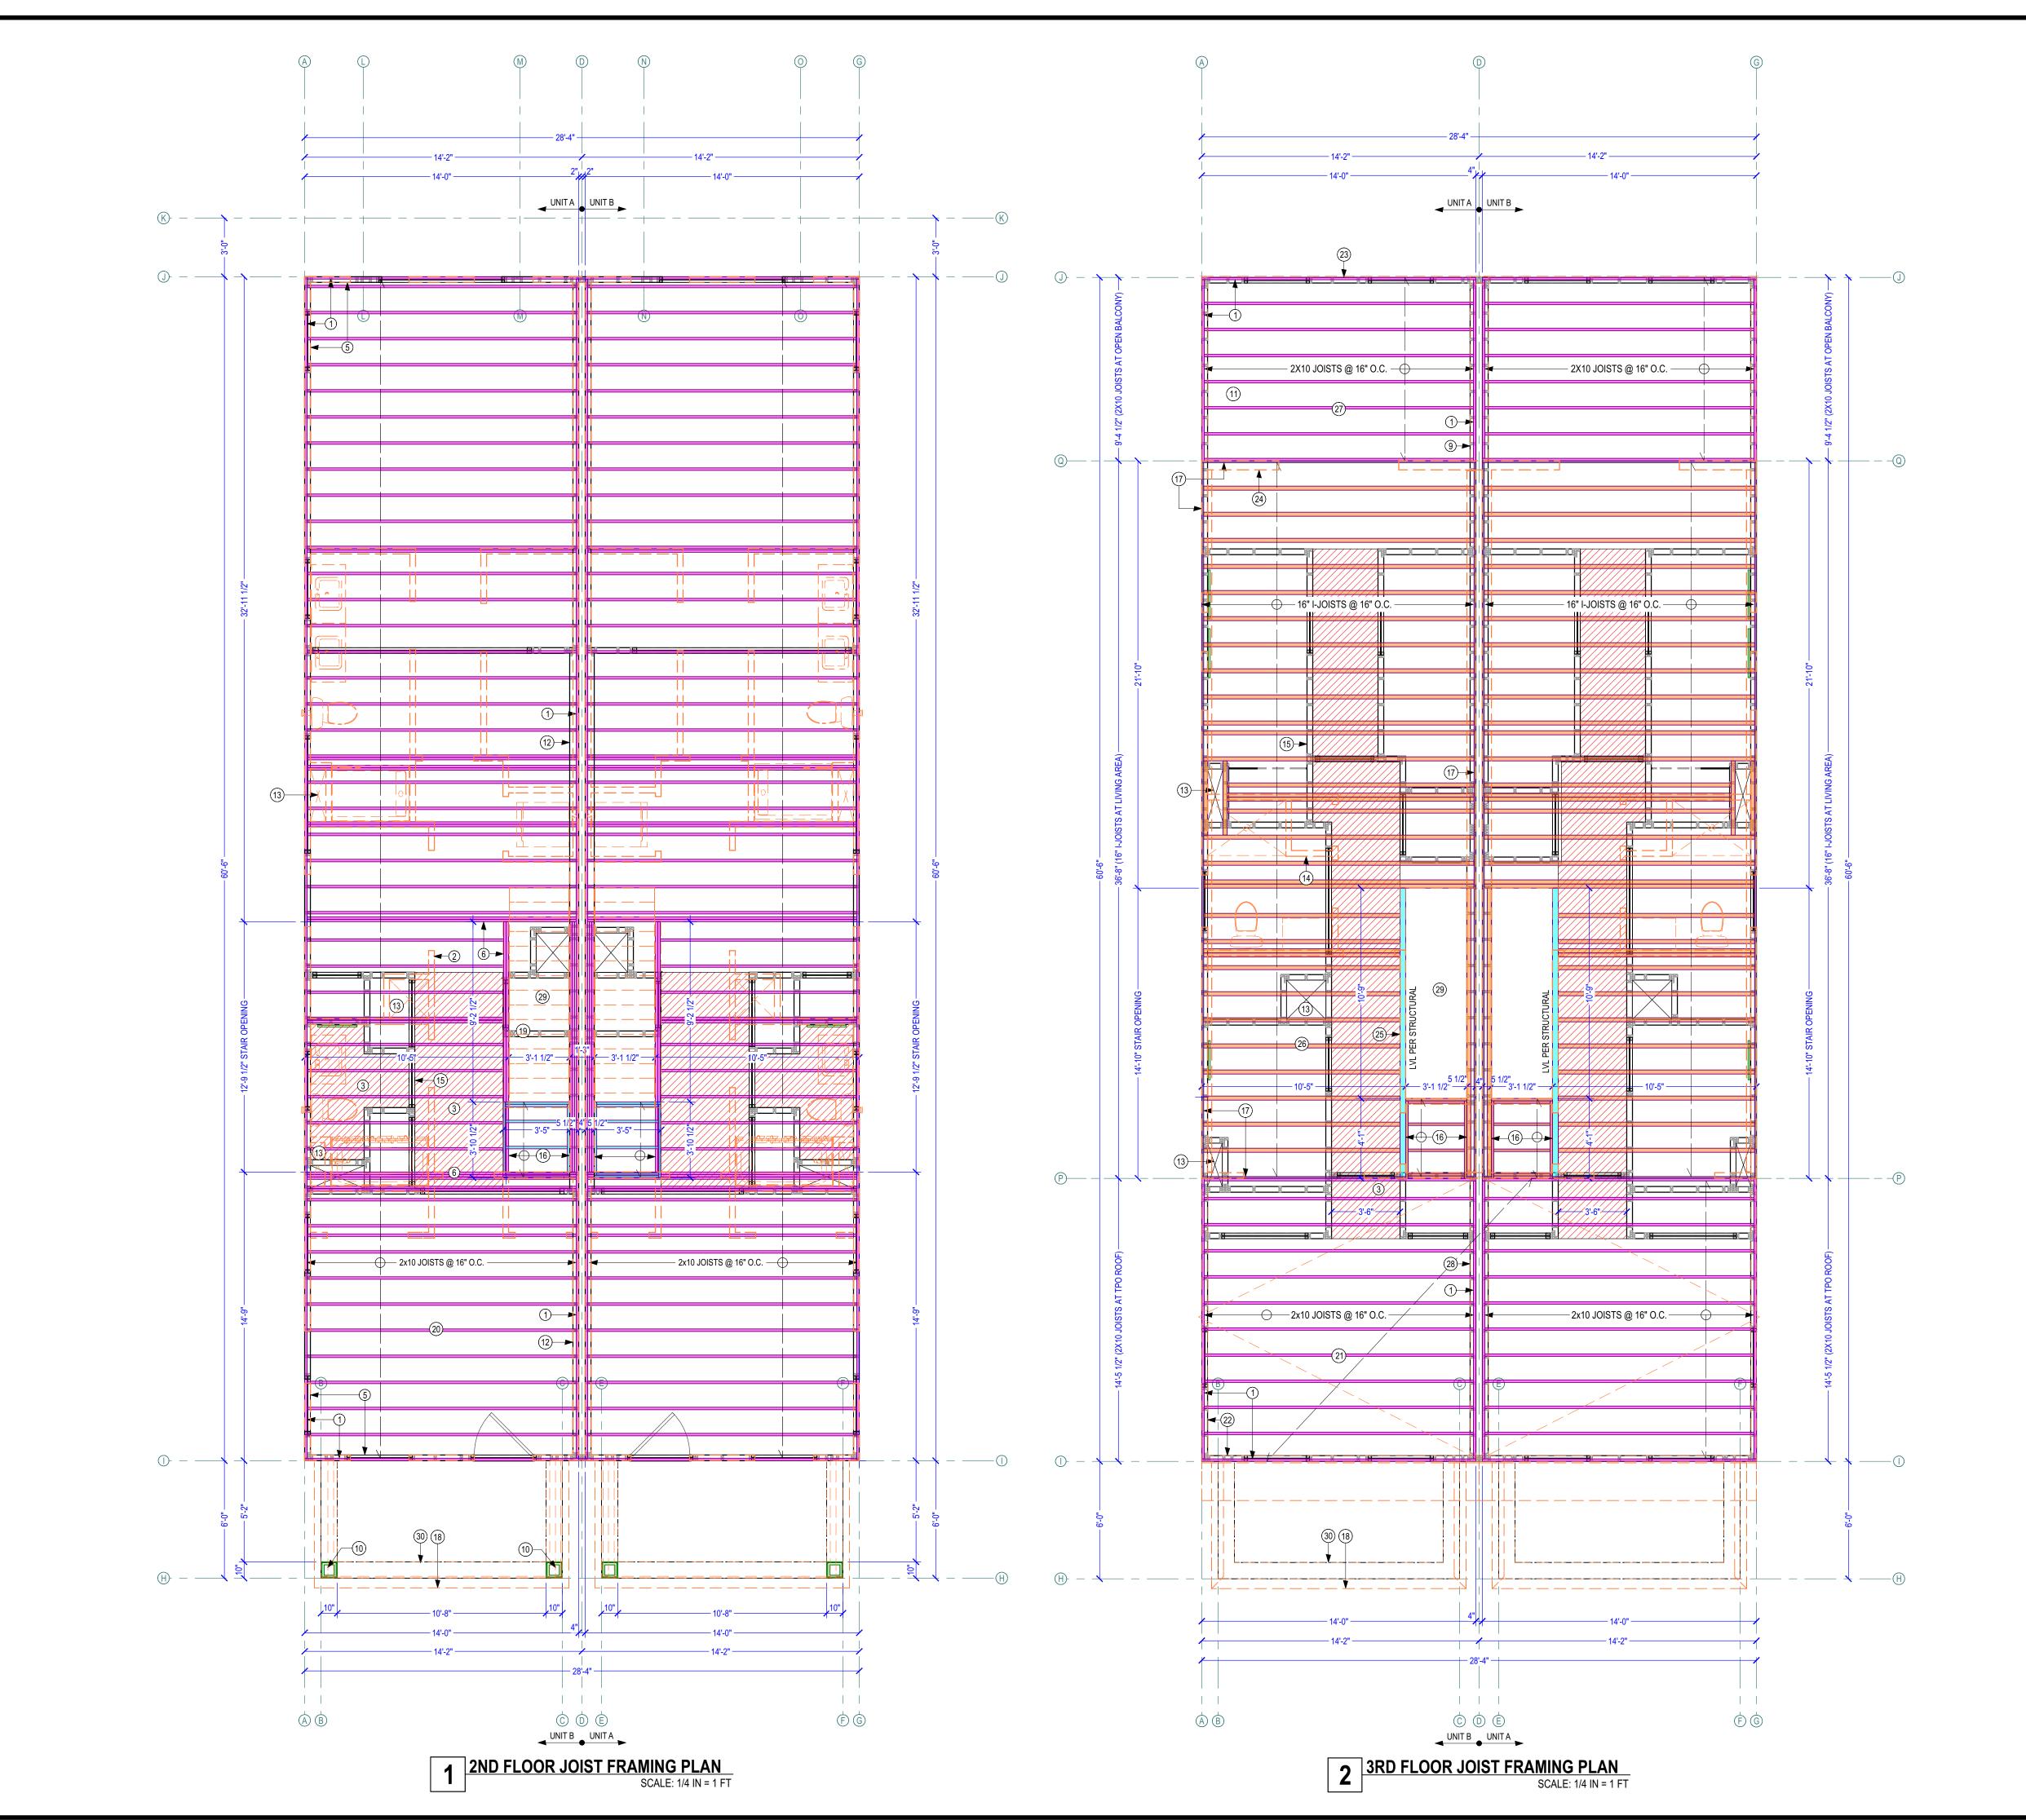

KEYNOTE LEGEND - FLOOR FRAMING PLANS 1) 2X10 RIM JOIST 2X4 FRAMED INTERIOR WALLS AT FLOOR ABOVE, TYP. AT DASHED LINES U.N.O. 3) 12"H HVAC CHASE UNDER FLOOR JOISTS W/ 1/2" DRYWALL CEILING FINISH 5) 2X4 FRAMED EXTERIOR WALL ABOVE & BELOW (6) DBL 2X10 JOISTS AT STAIR OPENING 2X4 FRAMED PARTY WALL BELOW & 42"H 2X4 FRAMED RAILING PARTY WALL ABOVE - SEE 0) 4X4 WOOD POST FROM PORCH BEAM DOWN TO BRICK PIER BELOW 1) 2X4 FRAMED EXTERIOR WALL BELOW & 2X4 FRAMED RAILING WALL ABOVE AT OPEN BALCONY 2X4 FRAMED PARTY WALL ABOVE & BELOW - SEE ENLARGED DETAIL S) SPACE FLOOR JOISTS FOR HVAC CHASE OPENING (14) 2X4 FRAMED INTERIOR WALLS ABOVE, TYP. AT DASHED LINES U.N.O. 5) 2X4 FRAMED INTERIOR WALLS BELOW, TYP. AT SOLID LINES U.N.O. 16) STAIR LANDING PLATFORM WITH 2X6 JOISTS AT 16" O.C. - SEE SECTION 1-1/8"X16" ENGINEERED RIM JOIST - VERIFY LAYOUT FROM I-JOIST MANUFACTURER 18) PORCH ROOF BELOW - SEE ROOF PLAN (19) 2X4 FRAMED KNEEWALL AT MECHANICAL ROOM BELOW STAIRS 20) 2X10 FLOOR JOISTS AT 16" O.C. WITH 2X10 RIM BOARD ENTIRE PERIMETER, TYPICAL THROUGHOUT 2ND FLOOR LEVEL 21) 2X10 JOISTS AT 16" O.C. WITH 2X10 RIM JOIST, TYP. AT TPO ROOF 22) 2X4 FRAMED EXTERIOR WALL BELOW & 36"H 2X4 FRAMED PARAPET WALL ABOVE 3) 2X4 FRAMED EXTERIOR WALL BELOW 24) 2X6 FRAMED EXTERIOR WALL ABOVE 25) LVL BEAM PER STRUCTURAL AT STAIR OPENING 16" I-JOIST AT 16" O.C. WITH 1-1/8" ENGINEERED RIM BOARD (AS SHOWN) - REFER TO JOIST 26 LAYOUT BY I-JOIST MANUFACTURER 2X10 JOISTS AT 16" O.C. WITH 2X10 RIM JOIST, TYP. AT OPEN BALCONY

2X4 FRAMED PARTY WALL BELOW & 24"H 2X4 FRAMED PARAPET PARTY WALL ABOVE - SEE

ENLARGED DETAIL

(29) OPENING FOR STAIRS

30) PORCH BEAM BELOW - SEE SECTION

NVISIONTEK BIM SERVICES

NVISIONTEKBIM.COM INFO@NVISIONTEKBIM.COM CELL: 804.372.0991 RICHMOND, VA 23236

REVISIONS

DATE DESCRIPTION

BUILDER NOTICE

IT IS THE INTENT OF THE DESIGNER / DRAFTER LISTED IN THE TITLE BLOCK OF THESE DOCUMENTS THAT THESE DOCUMENTS ARE ACCURATE, PROVIDING LICENSED PROFESSIONALS CLEAR INFORMATION. EVERY ATTEMPT HAS BEEN MADE TO PREVENT ERROR. THE BUILDER AND SUBCONTRACTORS ARE REQUIRED TO REVIEW ALL THE INFORMATION CONTAINED IN THESE DOCUMENTS, PRIOR TO COMMENCEMENT OF ANY WORK. NVISIONTEK IS NOT RESPONSIBLE FOR ANY PLAN ERRORS, OMISSIONS, OR MISINTERPRETATIONS UNDETECTED AND NOT REPORTED WITHIN 3 DAYS AFTER FINAL SUBMISSION OF DRAWINGS.

VERIFY ALL STRUCTURAL ITEMS ON PLANS WITH LICENSED STRUCTURAL ENGINEER

IF THE GENERAL CONTRACTOR OR ARCHITECT IS SHOWN ON THE COVER SHEET, PLEASE USE THEM AS YOUR FIRST POINT OF CONTACT BEFORE CONTACTING NVISIONTEK, LLC. OTHERWISE, ANY QUESTIONS CONCERNING THESE DOCUMENTS SHALL BE DIRECTED TO DUSTIN HETRICK AT NVISIONTEK, LLC, CELL: (804) 372-0991, EMAIL: DHETRICK@NVISIONTEKBIM.COM.

PROJECT NAME

UNION HILL AT 1308 N 26TH STREET

CLIENT(S)

CENTER CREEK HOMES 11 S 12TH STREET, SUITE

RICHMOND, VA, 23219 T: 804.999.4449

PROJECT ADDRESS

1308 N 26TH STREET RICHMOND, VA 23223

TITLE

2ND & 3RD FLOOR JOIST FRAMING PLANS

DOCUMENT PHASE:
PERMIT SET

PERIVIT SI

PLOT DATE: 11/1/2021 9:56:59 AM

DRAWN BY:

DUSTIN HETRICK

SCALE: SEE PLAN

SHEET

A2.0

GENERAL STRUCTURAL NOTES

1 REFERENCE STRUCTURAL FRAMING TAGS TO SCHEDULES AND LEGEND, SHOWN ON


2 LAYOUT SHOWN IS A GENERAL REFERENCE ONLY, AND SHOULD BE REVIEWED BY A

LICENSED ENGINEER. ANY STRUCTURAL CHANGES ISSUED BY A LICENSED

3 IF KEYNOTES ARE USED, REFERENCE KEYNOTE LEGEND ON THIS SHEET FOR

ENGINEER SHALL OVERRIDE INFORMATION SHOWN.

DESCRIPTION.

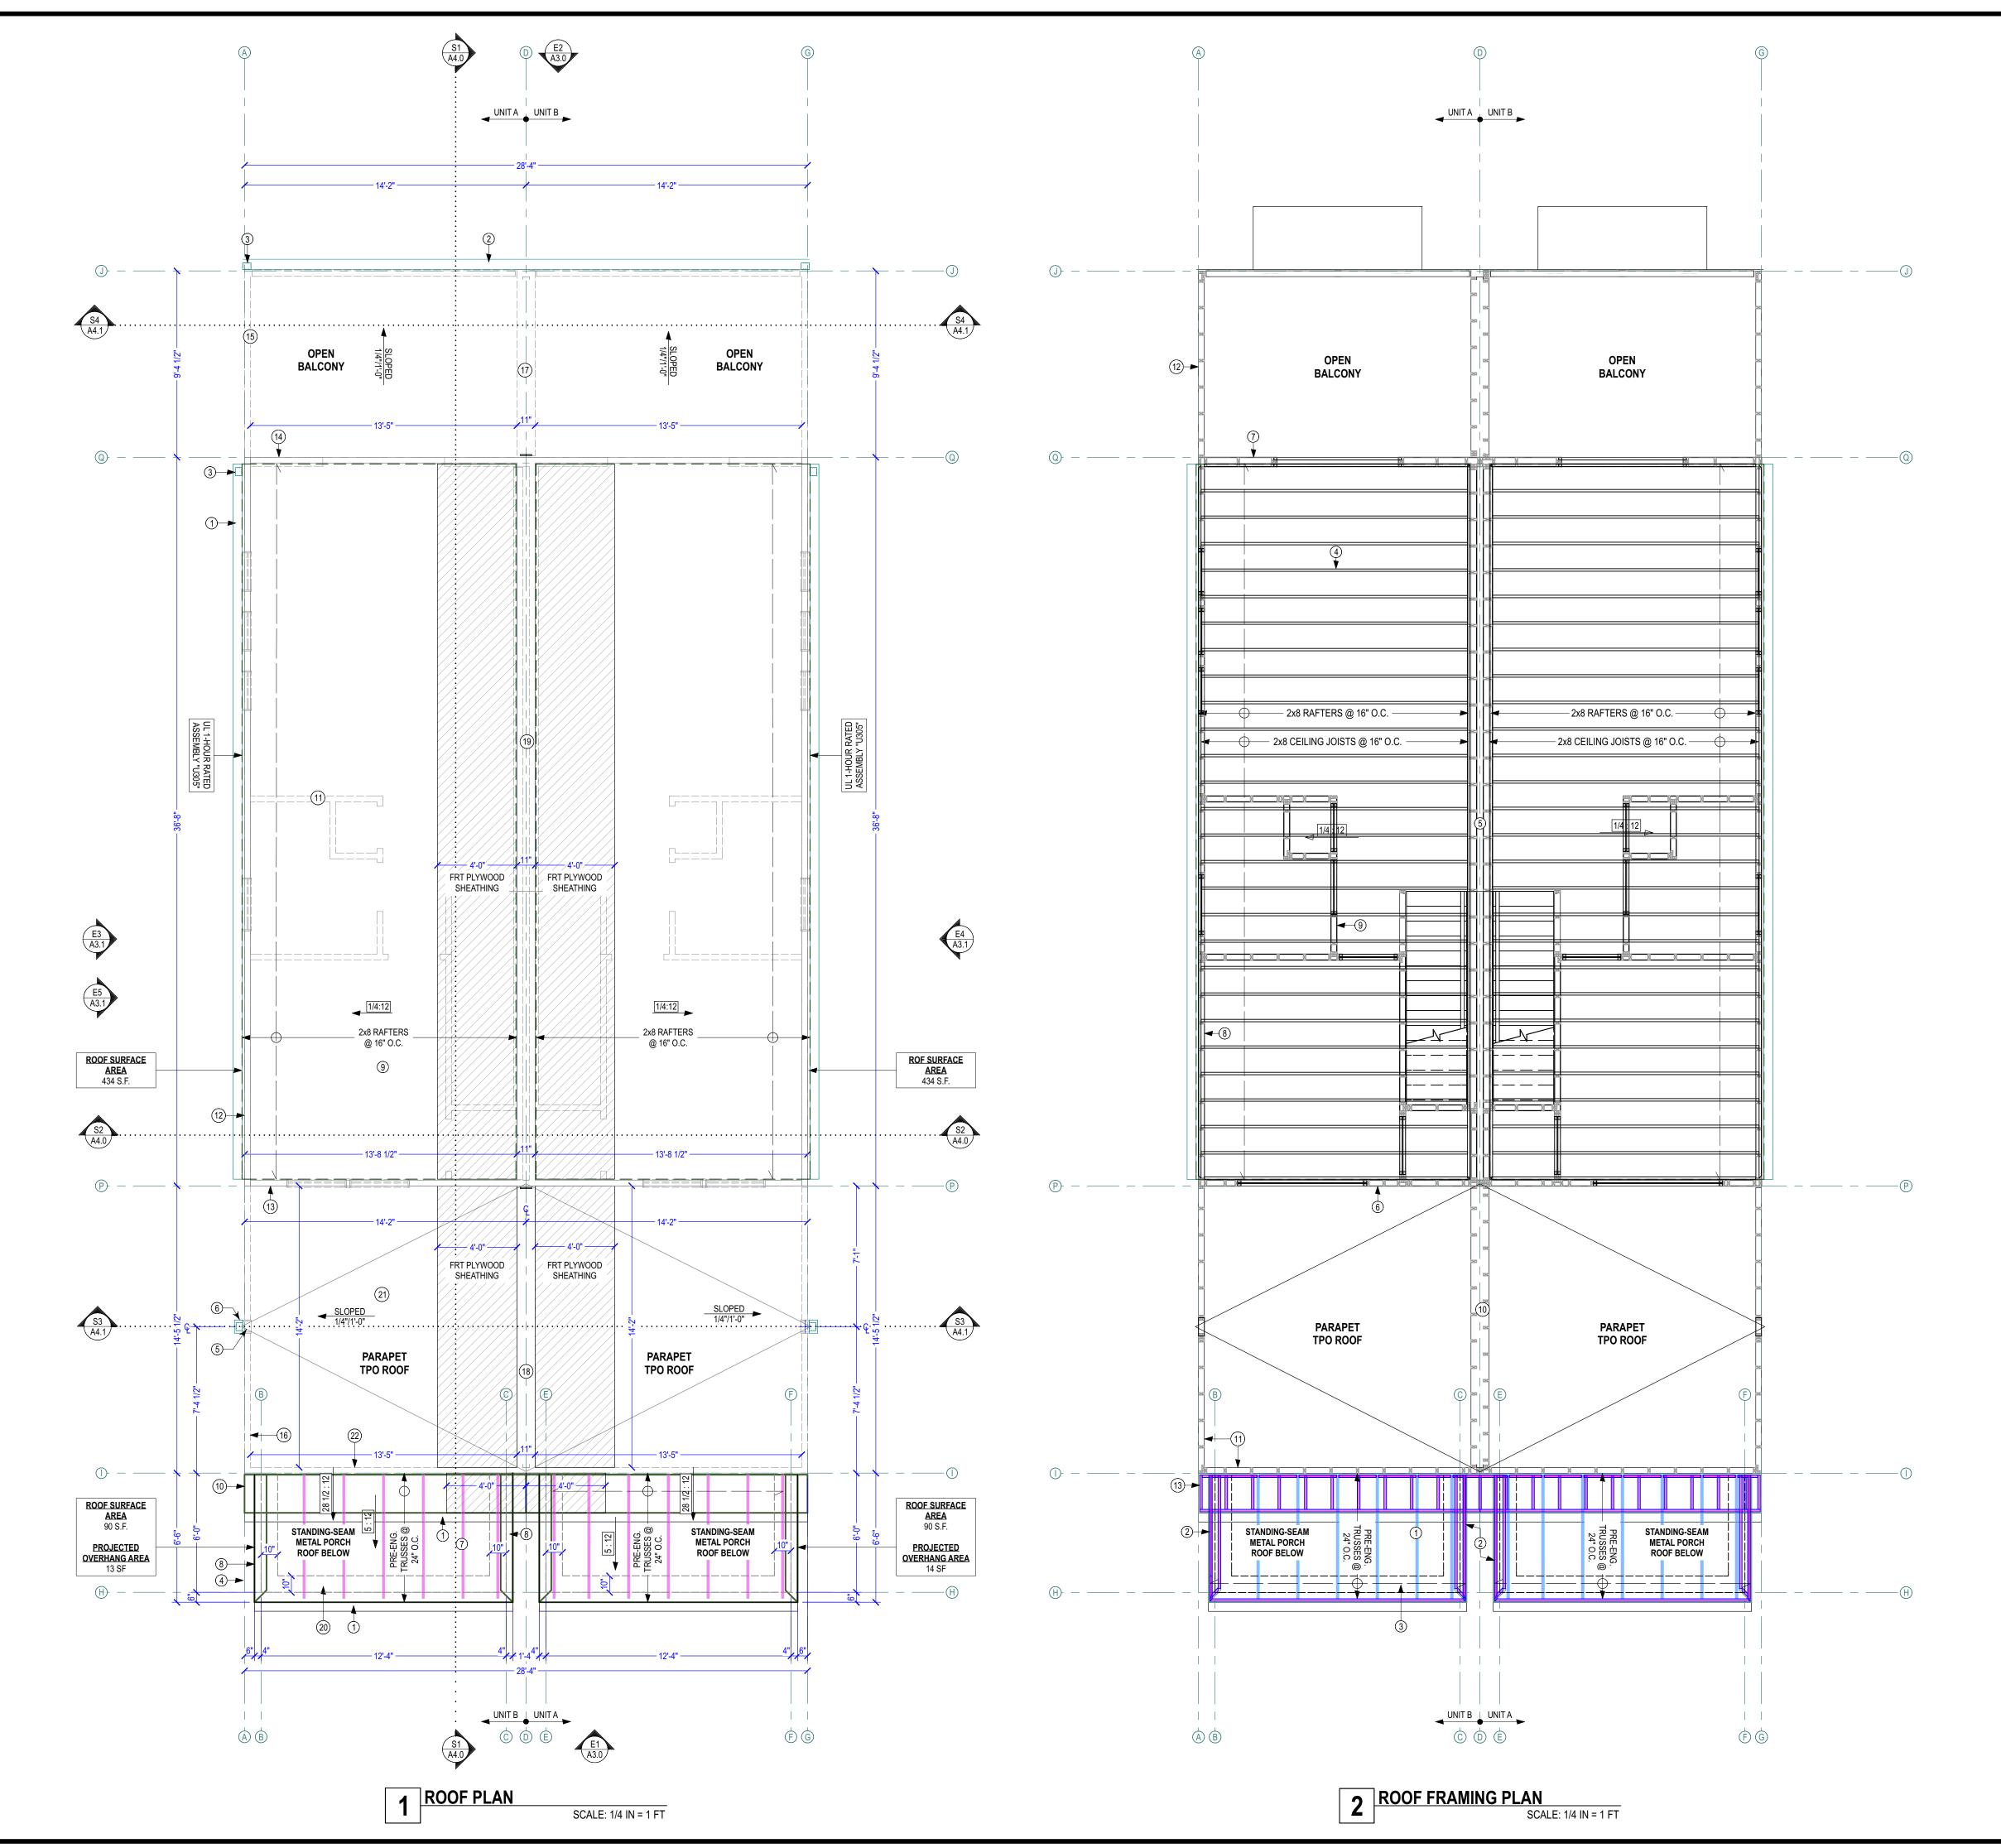

KEYNOTE LEGEND - ROOF PLAN

1 HALF-ROUND ALUMINUM GUTTER

(2) HALF-ROUND ALUMINUM GUTTER AT REAR DECK EDGE

(3) ALUMINUM DOWNSPOUT

4 ALUMINUM DOWNSPOUT W/TOP ELBOW CONNECTED TO GUTTER AT FRONT AND BOTTOM ELBOW AT SIDE OF COLUMN/PIER

6"X8" ALUMINUM OVERFLOW WALL SCUPPER, FLASH OPENING AS REQUIRED - SEE TYP. DETAIL

(6) ALUMINUM COLLECTOR BOX W/DOWNSPOUT

PORCH ROOF: STANDING SEAM METAL OVER SYNTHETIC UNDERLAYMENT OVER 5/8" CDX
PLYWOOD SHEATHING OVER PRE-ENGINEERED ROOF TRUSSES AT 24" O.C. W/HANGERS/CLIPS
AT HOUSE & HUPPICANE CLIP AT OUTED BEAM, DESERVING BY TRUSS

AT HOUSE & HURRICANE CLIP AT OUTER BEAM - REFER TO DESIGN BY TRUSS

MANUFACTURER

2M EDAMED BUILT LENGTH SOEET BETTIDD W//4X6 COMPOSITE EASON TRIM HAPPINS

8 2X4 FRAMED FULL-LENGTH SOFFIT RETURN W/1X6 COMPOSITE FASCIA TRIM, HARDI-SOFFIT, & ALUMINUM TOP FINISH SLOPED 2"/1'-0" WITH FLASHING AS REQUIRED

LOW PITCH ROOF: WHITE TPO OVER 5/8" CDX PLYWOOD OVER 6" RIGID INSULATION OVER 2X8

9 RAFTERS AT 16" O.C. (SLOPED 1/4" PER 1'-0") OVER 2X8 CEILING JOISTS AT 16" O.C. WITH R-49 CELLULOSE INSULATION

SKIRT ROOF IN FRONT OF PARAPET WALL: STANDING-SEAM METAL ROOFING OVER SYNTHETIC UNDERLAYMENT OVER 5/8" CDX PLYWOOD SHEATHING OVER 2X6 RAFTERS AT 16" O.C. - SEE

(11) 2X4 FRAMED INTERIOR WALLS BELOW, TYP. U.N.O.

(12) 2X4 FRAMED EXTERIOR WALL BELOW

2X4 FRAMED EXTERIOR WALL BELOW WITH 19"H 2X4 FRAMED PARAPET WALL ABOVE WITH METAL CAP - SEE ENLARGED DETAIL

2X6 FRAMED EXTERIOR WALL BELOW WITH 19"H 2X4 FRAMED PARAPET WALL ABOVE WITH

METAL CAP - SEE ENLARGED DETAIL

42"H (36" ABOVE DECK) 2X4 FRAMED BALCONY RAILING WALL W/HORIZONTAL LAP SIDING

(15) (BOTH SIDES), 5/8" FIRE-RATED DENSGLASS SHEATHING (EXTERIOR SIDE) & CONT. METAL CAP

& 1X4 COMPOSITE OUTER TRIM - SEE ENLARGED DETAIL
42"H 2X4 FRAMED PARAPET WALL W/HARDIPLANK SIDING, 5/8" FIRE-RATED DENSGLASS

SHEATHING (EXTERIOR SIDE), EPDM MEMBRANE (INTERIOR SIDE) & CONT. METAL CAP & 1X6 COMPOSITE OUTER TRIM - SEE ENLARGED DETAIL

42"H (36" ABOVE DECK) 2X4 FRAMED PARTY RAILING WALL W/REVEAL PANEL SYSTEM (BOTH SIDES) & METAL DRIP CAP - SEE ENLARGED DETAIL

42"H 2X4 FRAMED PARTY PARAPET WALL W/METAL DRIP CAP - SEE ENLARGED DETAIL

19"H 2X4 FRAMED PARTY PARAPET WALL (ABOVE 3RD FLOOR CEILING) W/ METAL DRIP CAP - SEE ENLARGED DETAIL

(3)2X10 PORCH BEAM BELOW - SEE SECTION

PARAPET TPO ROOF CONSTRUCTION: DURADECK 60-MIL MEMBRANE OVER 5/8" B-C PLYWOOD OVER 6" TAPERED RIGID INSULATION (SLOPED 1/4" PER FOOT TOWARDS SIDE GUTTER/DOWNSPOUT) OVER 3/4" T&G OSB SUBFLOOR GLUED & NAILED OVER 2X10 JOISTS AT 16" O.C. W/3" MIN. SPRAY-FOAM INSULATION (UNDERSIDE OF SUBFLOOR) OVER 1/2" GYPSUM DRYWALL

CEILING - SEE SECTION(S) & ENLARGED DETAILS

42"H 2X4 FRAMED PARAPET WALL W/EPDM MEMBRANE OVER 7/16" OSB SHEATHING (INTERIOR SIDE ONLY) & CONT. METAL CAP - SEE ENLARGED DETAIL

PRE-ENGINEERED ROOF TRUSSES AT 24" O.C. W/HANGERS/CLIPS AT HOUSE & HURRICANE
CLIP AT OUTER BEAM - REFER TO DESIGN BY TRUSS MANUFACTURER

2) FULL-LENGTH SOFFIT RETURN WITH 2X4 RAFTERS AT 16" O.C. SLOPED 2" PER 1'-0"

(3) (3)2X10 PORCH BEAM BELOW - SEE SECTION

200 DAETEDS AT 16" O.C. (SLODED 1/4" DED 1' 0") OVED 200 CEILING TOISTS AT 16" O.C.

2X8 RAFTERS AT 16" O.C. (SLOPED 1/4" PER 1'-0") OVER 2X8 CEILING JOISTS AT 16" O.C.

19"H 2X4 FRAMED PARTY PARAPET WALL (ABOVE 3RD FLOOR CEILING) - SEE ENLARGED DETAIL

2X4 FRAMED EXTERIOR WALL BELOW WITH 19"H 2X4 FRAMED PARAPET WALL ABOVE - SEE

6 ENLARGED DETAIL

2X6 FRAMED EXTERIOR WALL BELOW WITH 19"H 2X4 FRAMED PARAPET WALL ABOVE - SEE

2X6 FRAMED EXTERIOR WALL BELOW WITH 19"H 2X4 FRAMED PARAPET WALL ABOVE - SEE

ENLARGED DETAIL

(8) 2X4 FRAMED EXTERIOR WALL BELOW

9) 2X4 FRAMED INTERIOR WALLS BELOW, TYP. U.N.O.

10) 42"H 2X4 FRAMED PARTY PARAPET WALL - SEE ENLARGED DETAIL

|1)| 42"H 2X4 FRAMED PARAPET WALL - SEE ENLARGED DETAIL

42"H 2X4 FRAMED BALCONY RAILING WALL - SEE ENLARGED DETAIL

SKIRT ROOF IN FRONT OF PARAPET WALL: STANDING-SEAM METAL ROOFING OVER SYNTHETIC UNDERLAYMENT OVER 5/8" CDX PLYWOOD SHEATHING OVER 2X6 RAFTERS AT 16" O.C. - SEE

GENERAL ROOF VENT CALCULATIONS TWO METHODS OF NET FREE VENT AREA (NFVA) CALCULATION

• 1:150 (1 SF OF VENTILATION FOR EVERY 150 SF OF ATTIC FLOOR SPACE • 1:300 (1 SF OF VENTILATION FOR EVERY 300 SF OF ATTIC FLOOR SPACE

THE US FHA REQURIES A MIN. OF 1:300 NFVA, HOWEVER 1:150 IS RECOMMENDED FOR OPTIMAL PERFORMANCE, AND MAY BE REQUIRED DEPENDING ON LOCAL

BOTH OF THESE CALCULATIONS ARE BASED ON AN IDEALLY BALANCED SYSTEM (50% INTAKE, 50% EXHAUST).

ROOF SQUARE FOOTAGE

BUILDING CODES.

MAIN ROOF SQUARE FOOTAGE = XXX SF +/- AT 1:150 = XXX SQ. IN. OF NET FREE VENT AREA (NFVA)

50% INTAKE (EAVE VENT) = XX LF +/- SF AT EAVES 50% EXHAUST VENT (RIDGE VENT) = 19.2 +/- SF AT RIDGES

EAVE PERIMETER AVAILBILITY = XX LF +/-AVAILABLE RIDGE LENGTH = XX'-X" LF +/-

GENERAL ROOF PLAN NOTES

1. ROOF SLOPE ARROWS POINT IN THE DIRECTION IN WHICH WATER WILL FLOW.

2. INSTALL ROOF COVERINGS, FLASHING, CRICKETS, AND ROOF DRAINAGE IN ACCORDANCE WITH CODE REQUIREMENTS.

ANY TRUSSES SHOWN ARE FOR ILLUSTRATION ONLY. REFERENCE TRUSS LAYOUT DRAWINGS BY OTHERS, IF TRUSSES ARE NOTED (IN LIEU OF RAFTERS).
 RIDGE VENT AS REQ'D FOR ADEQUATE VENTILATION, UNLESS PLANS INDICATE

SEALED AND CONDITIONED ATTIC SPACE.

5. IF KEYNOTES ARE USED, REFERENCE KEYNOTE LEGEND ON THIS SHEET FOR DESCRIPTION.

6. PLACE ROOF PENETRATIONS (EXHAUSTS, VENT STACKS, ETC.) IN LEAST VISIBLE AREAS PRACTICAL.

7. PROVIDE ICE & WATER SHIELD 3' UP FROM ROOF EDGES & IN ALL VALLEY

8. IF KEYNOTES ARE USED, REFERENCE KEYNOTE LEGEND ON THIS SHEET FOR DESCRIPTION.

GENERAL STRUCTURAL NOTES 1 REFERENCE STRUCTURAL FRAMING TAGS TO SCHEDULES AND LEGEND, SHOWN ON

LICENSED ENGINEER. ANY STRUCTURAL CHANGES ISSUED BY A LICENSED

ENGINEER SHALL OVERRIDE INFORMATION SHOWN.

THIS SHEET.

2 LAYOUT SHOWN IS A GENERAL REFERENCE ONLY, AND SHOULD BE REVIEWED BY A

3 IF KEYNOTES ARE USED, REFERENCE KEYNOTE LEGEND ON THIS SHEET FOR DESCRIPTION.



NVISIONTEKBIM.COM INFO@NVISIONTEKBIM.COM CELL: 804.372.0991 RICHMOND, VA 23236

REVISIONS

DATE DESCRIPTION

BUILDER NOTICE

IT IS THE INTENT OF THE DESIGNER /

DRAFTER LISTED IN THE TITLE BLOCK OF THESE DOCUMENTS THAT THESE DOCUMENTS ARE ACCURATE, PROVIDING LICENSED PROFESSIONALS CLEAR INFORMATION. EVERY ATTEMPT HAS BEEN MADE TO PREVENT ERROR. THE BUILDER AND SUBCONTRACTORS ARE REQUIRED TO REVIEW ALL THE INFORMATION CONTAINED IN THESE DOCUMENTS, PRIOR TO COMMENCEMENT OF ANY WORK. NVISIONTEK IS NOT RESPONSIBLE FOR ANY PLAN ERRORS, OMISSIONS, OR MISINTERPRETATIONS UNDETECTED AND NOT REPORTED WITHIN 3 DAYS AFTER FINAL

VERIFY ALL STRUCTURAL ITEMS ON PLANS WITH LICENSED STRUCTURAL ENGINEER

IF THE GENERAL CONTRACTOR OR

SUBMISSION OF DRAWINGS.

ARCHITECT IS SHOWN ON THE COVER SHEET, PLEASE USE THEM AS YOUR FIRST POINT OF CONTACT BEFORE CONTACTING NVISIONTEK, LLC. OTHERWISE, ANY QUESTIONS CONCERNING THESE DOCUMENTS SHALL BE DIRECTED TO DUSTIN HETRICK AT NVISIONTEK, LLC, CELL: (804) 372-0991, EMAIL: DHETRICK@NVISIONTEKBIM.COM.

PROJECT NAME

UNION HILL AT 1308 N 26TH STREET

CLIENT(S)

CENTER CREEK HOMES 11 S 12TH STREET, SUITE

RICHMOND, VA, 23219 T: 804.999.4449

PROJECT ADDRESS

1308 N 26TH STREET RICHMOND, VA 23223

TITLE

ROOF PLAN & ROOF FRAMING PLAN

DOCUMENT PHASE:

PERMIT SET

PLOT D

PLOT DATE: 11/1/2021 9:57:00 AM

DRAWN BY:DUSTIN HETRICK

SCALE: SEE PLAN

SHEET

A2.1



KEYNOTE LEGEND - EXTERIOR ELEVATIONS

- APPROXIMATE FINISHED GRADE, SLOPE AWAY FROM HOUSE (V.I.F.)
- CONT. 18" WIDE X 10" DEEP CONCRETE FOOTING W/(2) CONT. #4 REBAR REINFORCING; BOTTOM OF FOOTING MIN. 18" BELOW GRADE - SEE GEOTECH REPORT FOR FURTHER INSTRUCTIONS/SPECS, TYP. ALL FOOTINGS U.N.O.
- PARGED CMU FOUNDATION SEE FOUNDATION PLAN
- 30"W X 12" THICK SQUARE CONCRETE FOOTING WITH (2) #4 EACH WAY, MIN. 18" BELOW GRADE
- 16"X16" CMU PIERS W/PARGE COAT TO GRADE, GROUT & TAPER TOP FOR WATER DRAINAGE
- WOOD STAIRS FROM CONCRETE SIDEWALK UP TO PORCH FLOOR, VERIFY GRADE HEIGHT IN FIELD; 11" TREADS, MAX. 8" RISERS, TREAD MATERIAL TO MATCH PORCH FLOOR, PROVIDE
- LATTICE SKIRTING (8) BLACK PAINTED STEEL/IRON HANDRAIL AT STEPS, MIN. 34"H
- 10" SQUARE LOAD-BEARING SYNTHETIC COLUMN PROVIDE 4X4 P.T. WOOD POST DOWN TO PIER W/GALV. POST ANCHOR
- 36"H BLACK PAINTED STEEL/IRON HANDRAIL, MIN. 36"H, W/STAINLESS STEEL CABLES AT 4" O.C., RAILING REQUIREMENT T.B.D. BY SITE TOPOGRAPHY AND HEIGHT OF PORCH FLOOR
- ABOVE FINISHED GRADE

 2X P.T. WOOD STEPS TO GRADE W/36"H P.T. WOOD RAILING PER CODE W/4" WOOD BALUSTERS (11) @ 4" O.C. MAX SPACING, 2X6 P.T. TOP RAIL, 2X4 TOP & BOTTOM NAILERS, & 4X4 P.T. WOOD
- POSTS SEE ENLARGED DETAIL

 DECK FRAMING: 5/4X6 P.T. DECKING BOARDS OVER 2X8 P.T. JOISTS AT 16" O.C. W/GALV.

 HANGERS & (2)2X8 P.T. FLUSH OUTER BEAM & 2X8 P.T. LEDGER BOARD W/ 1/2" GALV. THROUGH
- BOLTS AT 16" O.C. STAGGERED
- P.T. 6X6 DECK POSTS FASTENED W/SIMPSON POST BASE ON 18"DIA CONCRETE FOOTINGS MIN. 18" BELOW GRADE, TYP. SEE ENLARGED DETAIL 36"H P.T. WOOD DECK RAILING PER CODE W/4" WOOD BALUSTERS @ 4" O.C. MAX SPACING, 2X6
- (14) P.T. TOP RAIL, 2X4 TOP & BOTTOM NAILERS, & 4X4 P.T. WOOD POSTS AT 8'-0" O.C. MAX SPACING MOUNTED FLUSH INSIDE RIM JOIST - SEE ENLARGED DETAIL
- 36"H RAILING WALL W/2X4 P.T. TOP RAIL & STAINLESS STEEL CABLES AT 4" O.C. & 4X4 P.T. POSTS - SEE ENLARGED DETAIL
- 16) 5/4 P.T. DECKING BOARDS W/PAINTED COMPOSITE 1X10 OUTER BOARD AND 1X4 TOP TRIM
- DOOR SILL RAISED 4-1/2" W/(3)2X6'S
- (2)5/4X4 PAINTED COMPOSITE VERTICAL TRIM AT CENTER OF UNITS SYMMETRICAL COLOR
- 5/4X4 PAINTED COMPOSITE FRIEZE TRIM
- 1X6 PAINTED COMPOSITE FASCIA TRIM
- 1X4 PAINTED COMPOSITE FRIEZE TRIM
- 5/4X4 PAINTED COMPOSITE CORNER TRIM, TYP.
- 1X8 PAINTED COMPOSITE FASCIA W/METAL DRIP CAP
- (25) CONTINUOUS METAL PARAPET WALL CAP SEE ENLARGED DETAIL

1X4 PAINTED COMPOSITE WINDOW & DOOR TRIM, TYP.

- CONTINUOUS METAL RAILING WALL CAP & 1X4 PAINTED COMPOSITE OUTER TRIM SEE
- CONTINUOUS 5/4X6 PAINTED COMPOSITE TRIM SEPARATING HORIZONTAL LAP SIDING &
- REVEAL PANEL SYSTEM (2)5/4X4 PAINTED COMPOSITE VERTICAL TRIM AT CENTER OF UNITS - MATCH COLORS FOR
- リ EACH UNIT 29) CEMENTITIOUS HORIZONTAL LAP SIDING
- BUILT-UP PORCH BEAM W/1X PAINTED COMPOSITE TRIM BOARDS (10" FINISHED WIDTH) SEE
- SECTION & ENLARGED DETAIL
- HARDIEPANEL SMOOTH, FINISH TO MATCH PORCH TRIM
- HARDIEPANEL SMOOTH WITH ALUMINUM REVEAL JOINT SYSTEM, LIGHT MIST STANDING-SEAM METAL ROOF, CONSULT W/OWNER FOR SELECTION
- 42"H (36"H ABOVE DECK SURFACE) 2X4 FRAMED BALCONY RAILING WALL W/HORIZONTAL LAP SIDING OVER HOUSE WRAP OVER 5/8" FIRE-RATED DENSGLASS SHEATHING (EXTERIOR SIDE)
- W/HORIZONTAL LAP SIDING OVER HOUSE WRAP OVER 7/16" OSB SHEATHING (INTERIOR SIDE) & CONT. METAL CAP & 1X4 COMPOSITE OUTER TRIM - SEE ENLARGED DETAIL

 42"H (36"H ABOVE DECK SURFACE) 2X4 FRAMED PARTY RAILING WALL W/REVEAL PANEL
- (35) SYSTEM OVER HOUSE WRAP OVER 7/16" OSB SHEATHING (BOTH SIDES) & METAL DRIP CAP SEE ENLARGED DETAIL 2X4 FRAMED FULL-LENGTH SOFFIT RETURN W/1X6 PAINTED COMPOSITE FASCIA TRIM, VENTED
- COMPOSITE SOFFIT, & ALUMINUM TOP FINISH SLOPED 2"/1'-0" WITH FLASHING AS REQUIRED OW PITCH ROOF: WHITE TPO OVER 5/8" CDX PLYWOOD OVER 6" RIGID INSULATION OVER 2X8 (37) RAFTERS AT 16" O.C. (SLOPED 1/4" PER 1'-0") OVER 2X8 CEILING JOISTS AT 16" O.C. WITH R-49
- CELLULOSE INSULATION
- (38) ALUMINUM DOWNSPOUT
- ALUMINUM COLLECTOR BOX W/DOWNSPOUT ALUMINUM GUTTER AT REAR DECK EDGE
- ALUMINUM DOWNSPOUT W/TOP ELBOW CONNECTED TO GUTTER AT FRONT AND BOTTOM ELBOW AT SIDE OF COLUMN/PIER
- HALF-ROUND ALUMINUM GUTTER
- HALF-ROUND ALUMINUM GUTTER AT REAR DECK EDGE TO DOWNSPOUT
- HVAC AIR CONDENSER REFER TO HVAC CONTRACTOR FOR HVAC REQUIREMENTS
- SKIRT ROOF IN FRONT OF PARAPET WALL W/PAINTED COMPOSITE PANEL AT ENDS, 1X6
 PAINTED COMPOSITE FASCIA TRIM, VENTED COMPOSITE SOFFIT, 5/4X6 PAINTED COMPOSITE
 FRIEZE TRIM, & HALF-ROUND ALUMINUM GUTTER W/DOWNSPOUT SEE ENLARGED DETAIL

GENERAL ELEVATION & 3D NOTES

I. REFERENCE WINDOW, DOOR, OR ANY OTHER TAGS TO LEGENDS AND SCHEDULES

2. ANY FURNITURE SHOWN IS GENERIC AND IS FOR REFERENCE ONLY. CONSULT

3. ALL MATERIALS, PATTERNS, TRIM, WINDOWS, DOORS, CASEWORK, APPLIANCES,

4. TOPOGRAPHY SHOWN IS RELATIVELY ACCURATE, BUT NOT EXACT. REFER TO

5. IF KEYNOTES ARE USED, REFERENCE KEYNOTE LEGEND ON THIS SHEET FOR

AND OTHER FIXTURES SHOWN DO NOT REPRESENT EXACT SELECTIONS. GENERIC

WITH INTERIOR DESIGNER (IF APPLICABLE) FOR SPACE PLANNING.

BIM SERVICES

NVISIONTEKBIM.COM INFO@NVISIONTEKBIM.COM CELL: 804.372.0991 RICHMOND, VA 23236

REVISIONS

DATE DESCRIPTION

BUILDER NOTICE

IT IS THE INTENT OF THE DESIGNER / DRAFTER LISTED IN THE TITLE BLOCK OF THESE DOCUMENTS THAT THESE DOCUMENTS ARE ACCURATE, PROVIDING LICENSED PROFESSIONALS CLEAR INFORMATION. EVERY ATTEMPT HAS BEEN MADE TO PREVENT ERROR. THE BUILDER AND SUBCONTRACTORS ARE REQUIRED TO REVIEW ALL THE INFORMATION CONTAINED IN THESE DOCUMENTS, PRIOR TO COMMENCEMENT OF ANY WORK. NVISIONTEK IS NOT RESPONSIBLE FOR ANY PLAN ERRORS, OMISSIONS, OR MISINTERPRETATIONS UNDETECTED AND NOT REPORTED WITHIN 3 DAYS AFTER FINAL

VERIFY ALL STRUCTURAL ITEMS ON PLANS WITH LICENSED STRUCTURAL ENGINEER

SUBMISSION OF DRAWINGS.

(804) 372-0991, EMAIL:

IF THE GENERAL CONTRACTOR OR ARCHITECT IS SHOWN ON THE COVER SHEET, PLEASE USE THEM AS YOUR FIRST POINT OF CONTACT BEFORE CONTACTING *NVISIONTEK, LLC.* OTHERWISE, ANY QUESTIONS CONCERNING THESE DOCUMENTS SHALL BE DIRECTED TO DUSTIN HETRICK AT NVISIONTEK, LLC, CELL:

PROJECT NAME

DHETRICK@NVISIONTEKBIM.COM.

UNION HILL AT 1308 N **26TH STREET**

CLIENT(S)

CENTER CREEK HOMES 11 S 12TH STREET, SUITE

RICHMOND, VA, 23219 T: 804.999.4449

PROJECT ADDRESS

1308 N 26TH STREET RICHMOND, VA 23223

> TITLE **EXTERIOR**

ELEVATIONS

DOCUMENT PHASE: PERMIT SET

PLOT DATE: 11/1/2021 9:57:01 AM

DRAWN BY:

DUSTIN HETRICK

SCALE: SEE PLAN

SHEET

9 OF 17

STYLES SHOWN, UNLESS OTHERWISE INDICATED.

SURVEY PHOTOS OR SITE PLAN (BY OTHERS).

SHOWN THROUGHOUT SET.



KEYNOTE LEGEND - EXTERIOR ELEVATIONS

- APPROXIMATE FINISHED GRADE, SLOPE AWAY FROM HOUSE (V.I.F.)
- CONT. 18" WIDE X 10" DEEP CONCRETE FOOTING W/(2) CONT. #4 REBAR REINFORCING; BOTTOM OF FOOTING MIN. 18" BELOW GRADE - SEE GEOTECH REPORT FOR FURTHER INSTRUCTIONS/SPECS, TYP. ALL FOOTINGS U.N.O.
- PARGED CMU FOUNDATION SEE FOUNDATION PLAN
- 30"W X 12" THICK SQUARE CONCRETE FOOTING WITH (2) #4 EACH WAY, MIN. 18" BELOW GRADE
- 16"X16" CMU PIERS W/PARGE COAT TO GRADE, GROUT & TAPER TOP FOR WATER DRAINAGE
- WOOD STAIRS FROM CONCRETE SIDEWALK UP TO PORCH FLOOR, VERIFY GRADE HEIGHT IN) | FIELD; 11" TREADS, MAX. 8" RISERS, TREAD MATERIAL TO MATCH PORCH FLOOR, PROVIDE
- LATTICE SKIRTING
- 8 BLACK PAINTED STEEL/IRON HANDRAIL AT STEPS, MIN. 34"H 10" SQUARE LOAD-BEARING SYNTHETIC COLUMN - PROVIDE 4X4 P.T. WOOD POST DOWN TO
- PIER W/GALV. POST ANCHOR 36"H BLACK PAINTED STEEL/IRON HANDRAIL, MIN. 36"H, W/STAINLESS STEEL CABLES AT 4"
 O.C., RAILING REQUIREMENT T.B.D. BY SITE TOPOGRAPHY AND HEIGHT OF PORCH FLOOR
- ABOVE FINISHED GRADE

 2X P.T. WOOD STEPS TO GRADE W/36"H P.T. WOOD RAILING PER CODE W/4" WOOD BALUSTERS

 (11) @ 4" O.C. MAX SPACING, 2X6 P.T. TOP RAIL, 2X4 TOP & BOTTOM NAILERS, & 4X4 P.T. WOOD
- POSTS SEE ENLARGED DETAIL

 DECK FRAMING: 5/4X6 P.T. DECKING BOARDS OVER 2X8 P.T. JOISTS AT 16" O.C. W/GALV.

 HANGERS & (2)2X8 P.T. FLUSH OUTER BEAM & 2X8 P.T. LEDGER BOARD W/ 1/2" GALV. THROUGH BOLTS AT 16" O.C. STAGGERED
- P.T. 6X6 DECK POSTS FASTENED W/SIMPSON POST BASE ON 18"DIA CONCRETE FOOTINGS MIN. 18" BELOW GRADE, TYP. SEE ENLARGED DETAIL
- 36"H P.T. WOOD DECK RAILING PER CODE W/4" WOOD BALUSTERS @ 4" O.C. MAX SPACING, 2X6 (14) P.T. TOP RAIL, 2X4 TOP & BOTTOM NAILERS, & 4X4 P.T. WOOD POSTS AT 8'-0" O.C. MAX SPACING
- MOUNTED FLUSH INSIDE RIM JOIST SEE ENLARGED DETAIL 36"H RAILING WALL W/2X4 P.T. TOP RAIL & STAINLESS STEEL CABLES AT 4" O.C. & 4X4 P.T.
- POSTS SEE ENLARGED DETAIL (16) 5/4 P.T. DECKING BOARDS W/PAINTED COMPOSITE 1X10 OUTER BOARD AND 1X4 TOP TRIM
- DOOR SILL RAISED 4-1/2" W/(3)2X6'S
- 8) (2)5/4X4 PAINTED COMPOSITE VERTICAL TRIM AT CENTER OF UNITS SYMMETRICAL COLOR
- 5/4X4 PAINTED COMPOSITE FRIEZE TRIM
- 1X6 PAINTED COMPOSITE FASCIA TRIM
- 1X4 PAINTED COMPOSITE FRIEZE TRIM
- 5/4X4 PAINTED COMPOSITE CORNER TRIM, TYP. 1X8 PAINTED COMPOSITE FASCIA W/METAL DRIP CAP
- 1X4 PAINTED COMPOSITE WINDOW & DOOR TRIM, TYP.
- (25) CONTINUOUS METAL PARAPET WALL CAP SEE ENLARGED DETAIL
- CONTINUOUS METAL RAILING WALL CAP & 1X4 PAINTED COMPOSITE OUTER TRIM SEE
- CONTINUOUS 5/4X6 PAINTED COMPOSITE TRIM SEPARATING HORIZONTAL LAP SIDING &
- REVEAL PANEL SYSTEM (2)5/4X4 PAINTED COMPOSITE VERTICAL TRIM AT CENTER OF UNITS - MATCH COLORS FOR
- 29) HORIZONTAL LAP SIDING, CONSULT W/OWNER FOR SELECTION
- BUILT-UP PORCH BEAM W/1X PAINTED COMPOSITE TRIM BOARDS (10" FINISHED WIDTH) SEE
- SECTION & ENLARGED DETAIL
- HARDIEPANEL SMOOTH, FINISH TO MATCH PORCH TRIM
- HARDIEPANEL SMOOTH WITH ALUMINUM REVEAL JOINT SYSTEM, LIGHT MIST STANDING-SEAM METAL ROOF, CONSULT W/OWNER FOR SELECTION
- 42"H (36"H ABOVE DECK SURFACE) 2X4 FRAMED BALCONY RAILING WALL W/HORIZONTAL LAP SIDING OVER HOUSE WRAP OVER 5/8" FIRE-RATED DENSGLASS SHEATHING (EXTERIOR SIDE)
- W/HORIZONTAL LAP SIDING OVER HOUSE WRAP OVER 7/16" OSB SHEATHING (INTERIOR SIDE) & CONT. METAL CAP & 1X4 COMPOSITE OUTER TRIM - SEE ENLARGED DETAIL

 42"H (36"H ABOVE DECK SURFACE) 2X4 FRAMED PARTY RAILING WALL W/REVEAL PANEL
- (35) 42"H (36"H ABOVE DECK SUKRACE) 2/4 FRANCED FANT I MAILING WALL WILLEY IN THE CAP -SEE ENLARGED DETAIL
- (36) 2X4 FRAMED FULL-LENGTH SOFFIT RETURN W/1X6 PAINTED COMPOSITE FASCIA TRIM, VENTED COMPOSITE SOFFIT, & ALUMINUM TOP FINISH SLOPED 2"/1'-0" WITH FLASHING AS REQUIRED
- LOW PITCH ROOF: WHITE TPO OVER 5/8" CDX PLYWOOD OVER 6" RIGID INSULATION OVER 2X8 37) RAFTERS AT 16" O.C. (SLOPED 1/4" PER 1'-0") OVER 2X8 CEILING JOISTS AT 16" O.C. WITH R-49 CELLULOSE INSULATION
- (38) ALUMINUM DOWNSPOUT

EACH UNIT

- ALUMINUM COLLECTOR BOX W/DOWNSPOUT
- ALUMINUM GUTTER AT REAR DECK EDGE
- ALUMINUM DOWNSPOUT W/TOP ELBOW CONNECTED TO GUTTER AT FRONT AND BOTTOM ELBOW AT SIDE OF COLUMN/PIER
- HALF-ROUND ALUMINUM GUTTER
- HALF-ROUND ALUMINUM GUTTER AT REAR DECK EDGE TO DOWNSPOUT
- HVAC AIR CONDENSER REFER TO HVAC CONTRACTOR FOR HVAC REQUIREMENTS
- SKIRT ROOF IN FRONT OF PARAPET WALL W/PAINTED COMPOSITE PANEL AT ENDS, 1X6
 PAINTED COMPOSITE FASCIA TRIM, VENTED COMPOSITE SOFFIT, 5/4X6 PAINTED COMPOSITE
 FRIEZE TRIM, & HALF-ROUND ALUMINUM GUTTER W/DOWNSPOUT SEE ENLARGED DETAIL

GENERAL ELEVATION & 3D NOTES

I. REFERENCE WINDOW, DOOR, OR ANY OTHER TAGS TO LEGENDS AND SCHEDULES

3. ALL MATERIALS, PATTERNS, TRIM, WINDOWS, DOORS, CASEWORK, APPLIANCES, AND OTHER FIXTURES SHOWN DO NOT REPRESENT EXACT SELECTIONS. GENERIC

2. ANY FURNITURE SHOWN IS GENERIC AND IS FOR REFERENCE ONLY. CONSULT

4. TOPOGRAPHY SHOWN IS RELATIVELY ACCURATE, BUT NOT EXACT. REFER TO

5. IF KEYNOTES ARE USED, REFERENCE KEYNOTE LEGEND ON THIS SHEET FOR

WITH INTERIOR DESIGNER (IF APPLICABLE) FOR SPACE PLANNING.

STYLES SHOWN, UNLESS OTHERWISE INDICATED.

SURVEY PHOTOS OR SITE PLAN (BY OTHERS).

SHOWN THROUGHOUT SET.

BIM SERVICES

NVISIONTEKBIM.COM INFO@NVISIONTEKBIM.COM CELL: 804.372.0991 RICHMOND, VA 23236

REVISIONS

DATE DESCRIPTION

BUILDER NOTICE

IT IS THE INTENT OF THE DESIGNER / DRAFTER LISTED IN THE TITLE BLOCK OF THESE DOCUMENTS THAT THESE DOCUMENTS ARE ACCURATE, PROVIDING LICENSED PROFESSIONALS CLEAR INFORMATION. EVERY ATTEMPT HAS BEEN MADE TO PREVENT ERROR. THE BUILDER AND SUBCONTRACTORS ARE REQUIRED TO REVIEW ALL THE INFORMATION CONTAINED IN THESE DOCUMENTS, PRIOR TO COMMENCEMENT OF ANY WORK. NVISIONTEK IS NOT RESPONSIBLE FOR ANY PLAN ERRORS, OMISSIONS, OR MISINTERPRETATIONS UNDETECTED AND

NOT REPORTED WITHIN 3 DAYS AFTER FINAL

SUBMISSION OF DRAWINGS.

VERIFY ALL STRUCTURAL ITEMS ON PLANS WITH LICENSED STRUCTURAL ENGINEER

IF THE GENERAL CONTRACTOR OR ARCHITECT IS SHOWN ON THE COVER SHEET, PLEASE USE THEM AS YOUR FIRST POINT OF CONTACT BEFORE CONTACTING *NVISIONTEK, LLC.* OTHERWISE, ANY QUESTIONS CONCERNING THESE DOCUMENTS SHALL BE DIRECTED TO DUSTIN HETRICK AT NVISIONTEK, LLC, CELL: (804) 372-0991, EMAIL:

PROJECT NAME

DHETRICK@NVISIONTEKBIM.COM.

UNION HILL AT 1308 N **26TH STREET**

CLIENT(S)

CENTER CREEK HOMES 11 S 12TH STREET, SUITE

RICHMOND, VA, 23219 T: 804.999.4449

PROJECT ADDRESS

1308 N 26TH STREET RICHMOND, VA 23223

TITLE

EXTERIOR ELEVATIONS

DOCUMENT PHASE:

PERMIT SET

PLOT DATE: 11/1/2021

9:57:02 AM


DRAWN BY:

DUSTIN HETRICK

SCALE: SEE PLAN

10 OF 17

SHEET

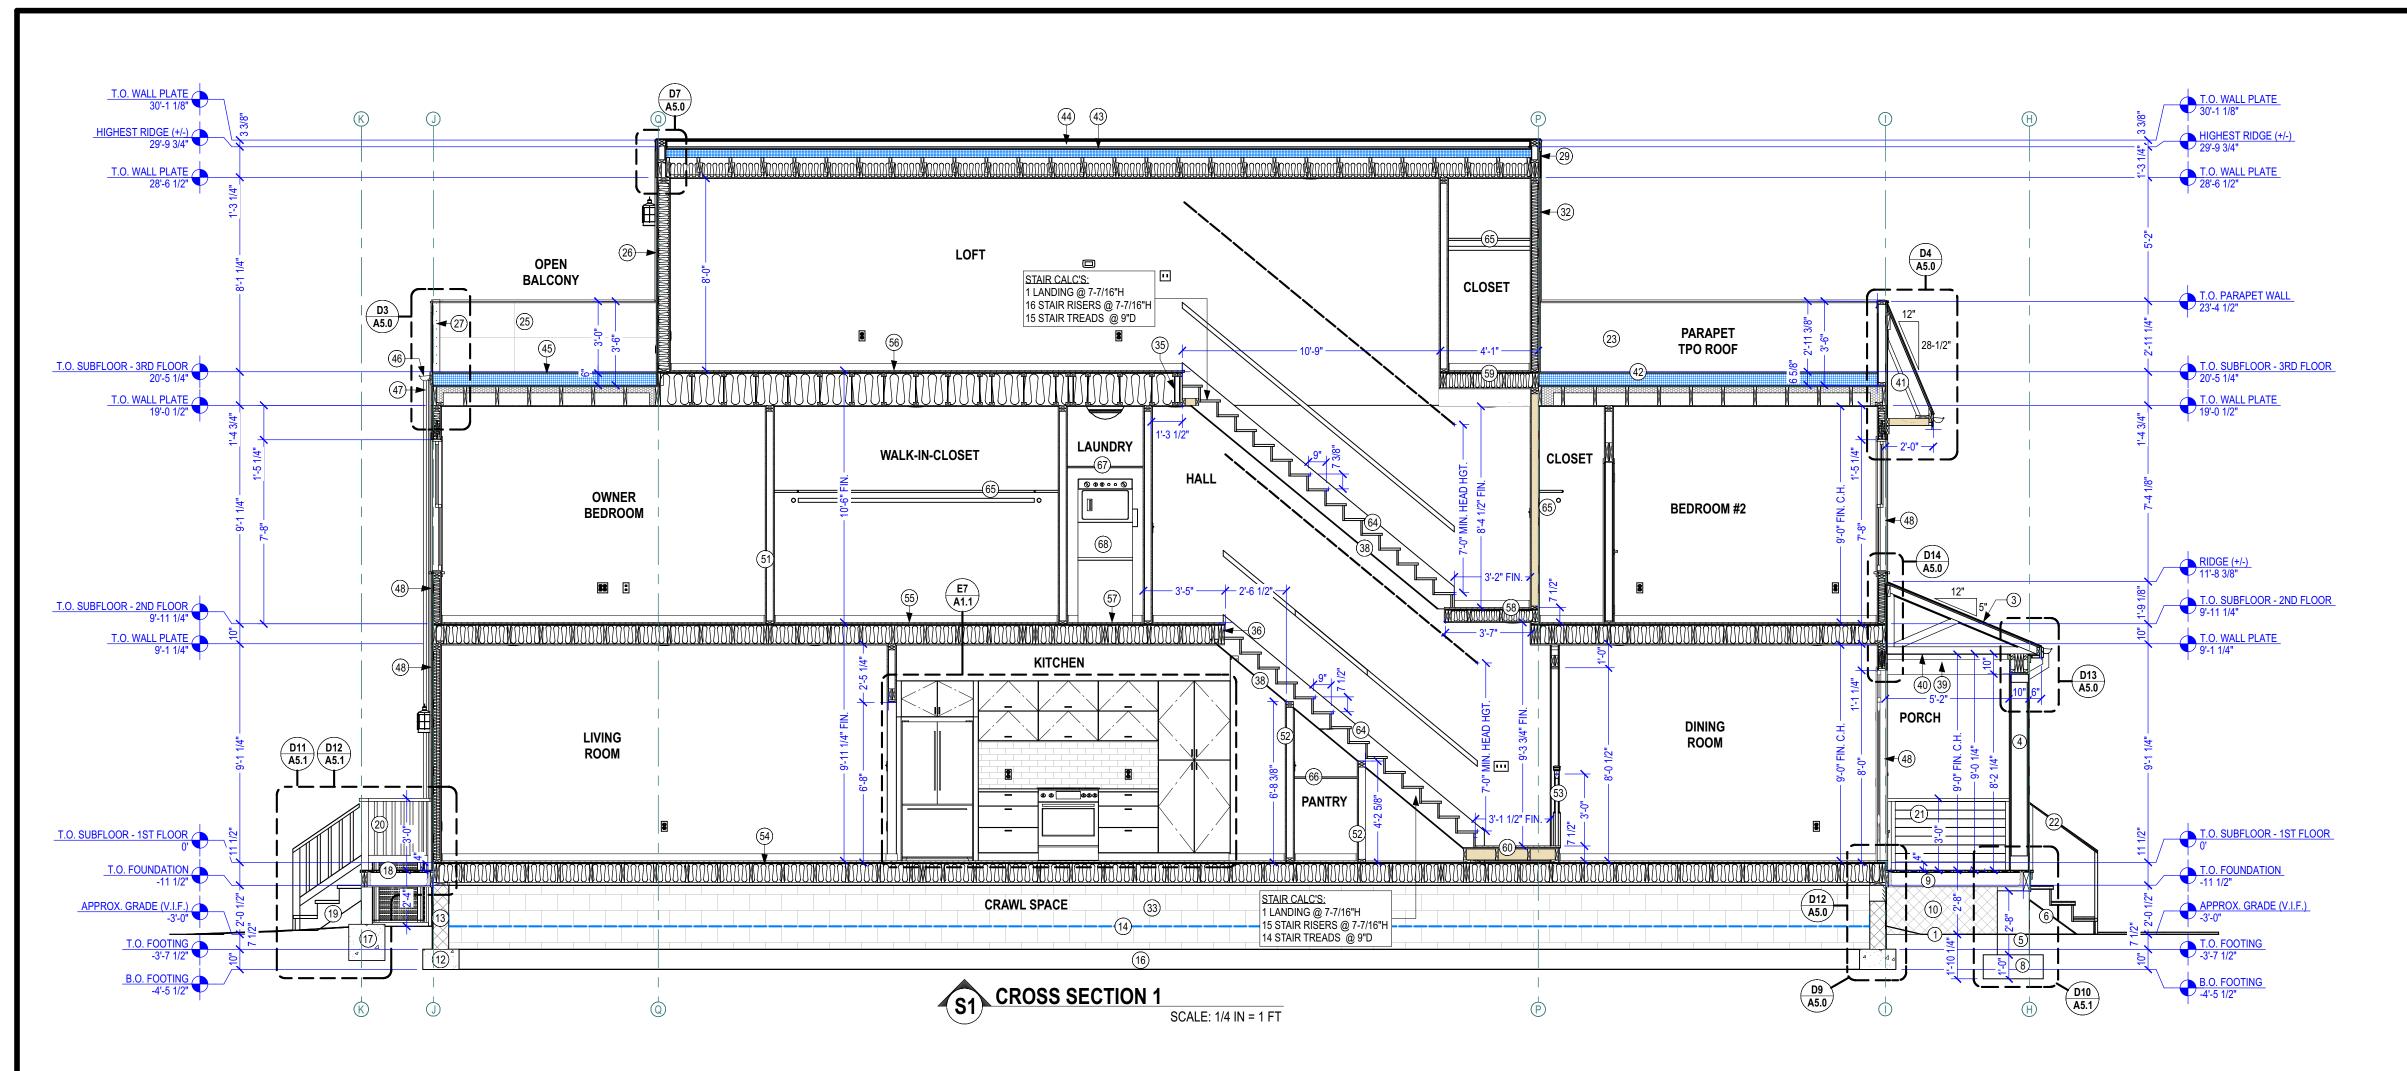

GENERAL STAIR & RAILING NOTES . NOT BE MORE THAN A 3/8" VARIANCE BETWEEN ANY RISER HEIGHT. REFERENCE

2. STAIR NOSING TO BE NOT LESS THAN 3/4" BUT NOT MORE THAN 1-1/4" ON STAIRWAYS WITH SOLID RISERS. REFERENCE R311.7.5.3 OF THE 2012 IRC.

3. ALL DIMENSIONS ARE TO FINISHED FLOOR. CERAMIC TILE & HARDWOOD FLOOR = 3/4", UNLESS NOTED OTHERWISE.

4. STAIRWAYS SHALL HAVE A MIN. WIDTH OF 34". HAND RAILS MAY ENCROACH A MAX. OF 3 1/2" INTO THE REQUIRED WIDTH.

. TREADS SHALL HAVE A MIN. WIDTH OF 9". STAIR TREADS MUST BE UNIFORM AND

CAN NOT VARY FROM THE LARGEST TO THE SMALLEST BY MORE THAN 3/8".

6. STAIRWAYS SHALL HAVE MIN. 6'-8" OF HEADROOM AT THE NOSE OF THE STAIR. . ENCLOSED USABLE SPACE UNDER INTERIOR STAIRS SHALL BE PROTECTED ON

THE ENCLOSED FACE WITH 5/8" TYPE "X" GYPSUM WALL BOARD.

B. STAIRWAYS SHALL HAVE AT LEAST ONE HANDRAIL LOCATED 34" TO 38" ABOVE THE NOSING OF TREADS AND LANDINGS. THE HAND GRIP PORTION OF HANDRAILS SHALL NOT BE LESS THAN 1-1/2" OR GREATER THAN 2" IN CROSS-SECTIONAL

9. HANDRAILS SHALL BE CONTINUOUS THE FULL LENGTH OF THE STAIRS. THE ENDS OF HANDRAILS SHALL RETURN TO WALL OR TERMINATE INTO A NEWEL POST OR

10. STAIRWAYS HAVING LESS THAN 2 RISERS DO NOT REQUIRE A HAND RAIL.

1. 34" MIN. HEIGHT GUARDRAILS SHALL BE PROVIDED FOR AT PORCHES, DECKS, BALCONIES, STAIRWAYS AND LANDINGS WHERE THE ADJACENT SURFACE IS GREATER THAN 24" BELOW.

12. RAILING AND GUARDRAIL BALUSTER SPACING SHALL BE NO GREATER THAN 4".

13. THE TRIANGULAR OPENINGS FORMED BY THE RISER, TREAD, AND BOTTOM OF GUARDRAIL SHALL NOT ALLOW A 6" DIAMETER SPHERE TO PASS THROUGH.

14. EXTERIOR SPIRAL STAIRS TO BE FABRICATED AND INSTALLED PER THE MFG.

INSTRUCTIONS, WITH A MIN. HEADROOM OF 6'-6".

5. RAMPS SHALL HAVE A MAXIMUM SLOPE OF 1 UNIT VERTICAL IN 12 UNITS HORIZONTAL (8.3% SLOPE), WITH A 3'x3' LANDING AT THE TOP & BOTTOM, WHERE DOORS OPEN ONTO RAMP, AND WHERE RAMP CHANGES DIRECTION.

GENERAL SECTION NOTES

1. 2x PRESSURE TREATED SILL PLATE WITH SILL SEALER AT TOP OF FOUNDATION WALLS WHERE FLOOR FRAMING MEMBERS BEAR SUPPORT. (TYPICAL).

EXTERIOR WALL FRAMING TO BE 2x4 WALL STUDS @ 16" O.C., U.N.O., WITH DOUBLE TOP PLATES AND SINGLE BOTTOM PLATE. BOTTOM PLATE TO BE FLUSH WITH FOUNDATION, AND 7/16" OSB SHEATHING TO OVERLAP 1" BELOW.

3. ALL LUMBER IN DIRECT CONTACT WITH FOUNDATION SHALL BE PRESSURE

. REFERENCE WINDOW, DOOR, OR ANY OTHER TAGS TO LEGENDS AND SCHEDULES, SHOWN THROUGHOUT SET.


5. IF KEYNOTES ARE USED, REFERENCE KEYNOTE LEGEND ON THIS SHEET FOR

DESCRIPTION.

E. ROOF VENTILATION OPTIONS (REFER TO PLANS): • VENTED - ROOF EAVES TO HAVE CONTINUOUS VENTED SOFFITS AND RIDGE

VENTS (LENGTHS AS REQ'D.)

• NON-VENTED - ATTIC AND CRAWL SPACES TO BE SEALED AND CONDITIONED WITH MECHANICAL VENTILATION AND HVAC. ROOF EAVES AND RIDGES TO BE NON-VENTED.

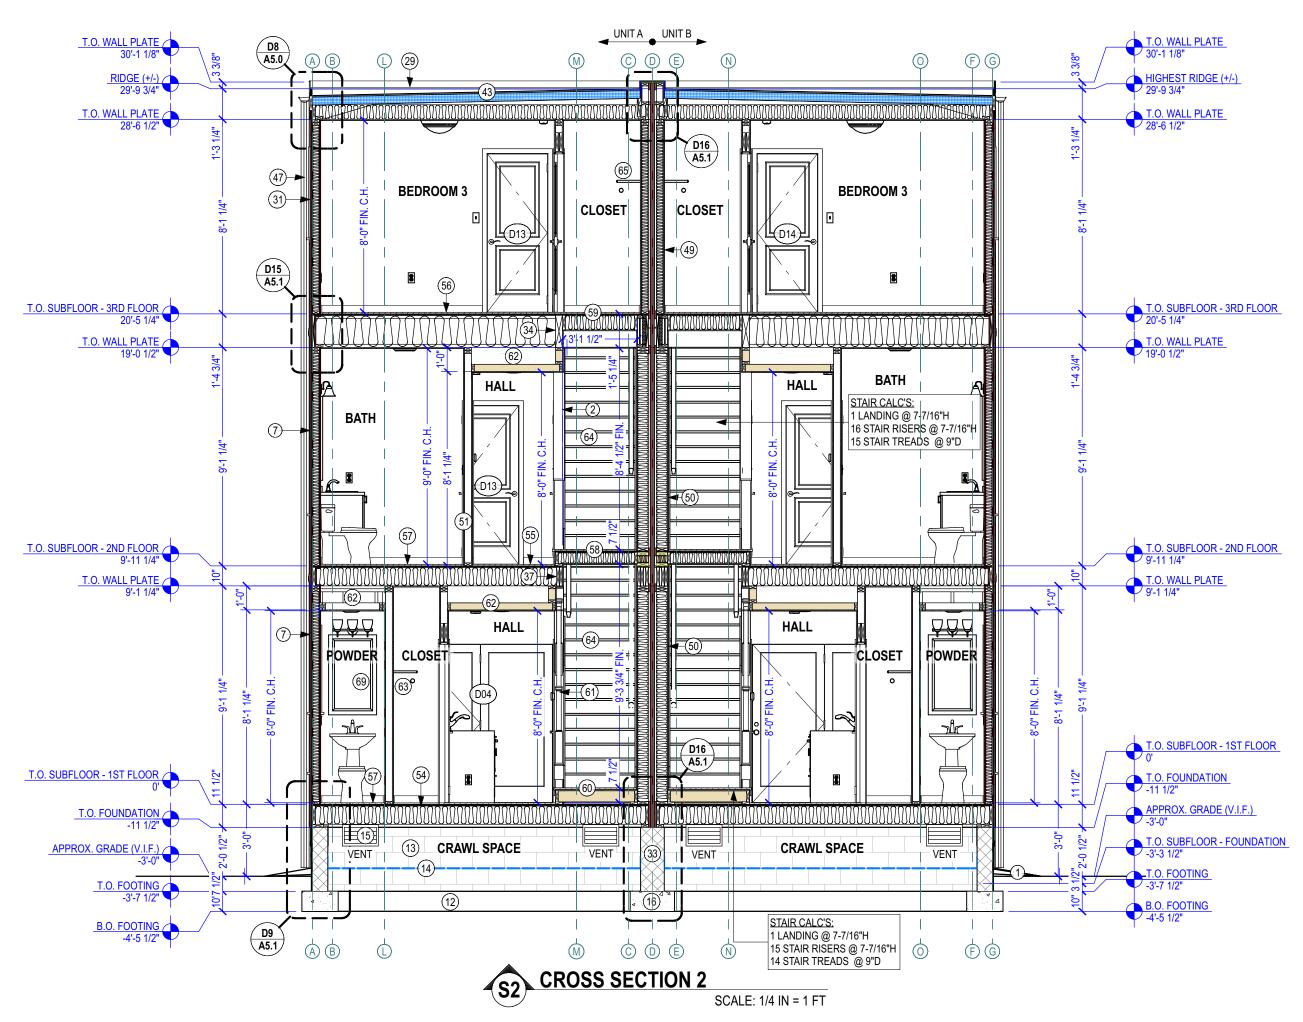

KEYNOTE LEGEND - 1/4" SCALE SECTION(S

APPROXIMATE FINISHED GRADE, SLOPE AWAY FROM HOUSE (V.I.F.)

36"H 2X4 FRAMED RAILING WALL W/1X6 CAP FOLLOWING STAIRS UP TO 3RD LEVEL

PORCH ROOF: STANDING SEAM METAL OVER SYNTHETIC UNDERLAYMENT OVER 5/8" CDX PLYWOOD SHEATHING OVER PRE-ENGINEERED ROOF TRUSSES AT 24" O.C. W/HANGERS/CLIPS AT HOUSE & HURRICANE CLIP AT OUTER BEAM - REFER TO DESIGN BY TRUSS MANUFACTURER 10" SQUARE LOAD-BEARING SYNTHETIC COLUMN - PROVIDE 4X4 P.T. WOOD POST DOWN TO PIER W/GALV. POST ANCHOR

16"X16" CMU PIERS W/PARGE COAT TO GRADE, GROUT & TAPER TOP FOR WATER DRAINAGE

WOOD STAIRS FROM CONCRETE SIDEWALK UP TO PORCH FLOOR, VERIFY GRADE HEIGHT IN FIELD; 11" TREADS, MAX. 8" RISERS, TREAD MATERIAL TO MATCH PORCH FLOOR, PROVIDE LATTICE SKIRTING.

UL 1-HOUR RATED ASSEMBLY "U305": HORIZONTAL LAP SIDING OVER HOUSE WRAP VAPOR BARRIER OVER 5/8 FIRE-RATED DENSGLASS SHEATHING (BOTTOM TO OVERLAP FOUNDATION 1") OVER 2X4 STUDS AT 16" O.C. W/(2) TOP PLATE & (1) BOTTOM PLATE W/CAÙLK W/R-15 BATT INSULATION (BETWEÉN STUDS) OVER 5/8" FIRE-RATED GYPSUM DRYWALL FINISH

30"W X 12" THICK SQUARE CONCRETE FOOTING WITH (2) #4 EACH WAY, MIN. 18" BELOW GRADE

OUTER BEAM & 2X8 P.T. LEDGER BOARD W/ 1/2" GALV. THROUGH BOLTS AT 32" O.C. STAGGERED, PROVIDE METAL 1 LATTICE SKIRTING

ALUMINUM COLLECTOR BOX W/DOWNSPOUT

CONT. 18" WIDE X 10" DEEP CONCRETE FOOTING W/(2) CONT. #4 REBAR REINFORCING; BOTTOM OF FOOTING MIN. 18" BELOW GRADE - SEE GEOTECH REPORT FOR FURTHER INSTRUCTIONS/SPECS. TYP. ALL FOOTINGS U.N.O.

8" CMU FOUNDATION WALL WITH PARGE COAT TO GRADE, #4 VERTICAL REINFORCING WITH BENT HOOK INTO FOOTING BELOW & ANCHOR BOLTS AT 6' O.C., MAX 12" FROM CORNERS/ENDS, MIN. (2) PER WALL SEGMENT; GROUT CELLS AT REINFORCING/ANCHOR BOLTS SOLID- SEE ENLARGED DETAIL 20 MIL VAPOR BARRIER OVER ENTIRE CRAWLSPACE; OVERLAP SEAMS MIN. 6" AND TAPE, CONT. MIN. 6" UP 4) FOUNDATION AND TAPE

8X16 SLOTTED GALVANIZED CRAWLSPACE VENT WITH INSECT SCREE, TYP. AS SHOWN - SEE FOUNDATION NOTES FOR VENTING REQUIREMENTS

CONT. 22" WIDE X 10" DEEP CONCRETE FOOTING WITH (2) CONT. #4 REBAR REINFORCING; BOTTOM OF FOOTING MIN. 30" BELOW GRADE- SEE GEOTECH. REPORT FOR FÜRTHER INSTRUCTIONS/SPECS. (TYP. ALL FOOTINGS U.N.O P.T. 6X6 DECK POSTS FASTENED W/SIMPSON POST BASE ON 18"DIA CONCRETE FOOTINGS MIN. 18" BELOW GRADE TYP. - SEE ENLARGED DETAIL

DECK FRAMING: 5/4X6 P.T. DECKING BOARDS OVER 2X8 P.T. JOISTS AT 16" O.C. W/GALV. HANGERS & (2)2X8 P.T. FLUSH OUTER BEAM & 2X8 P.T. LEDGER BOARD W/ 1/2" GALV. THROUGH BOLTS AT 16" O.C. STAGGERED

2X P.T. WOOD STEPS TO GRADE W/36"H P.T. WOOD RAILING PER CODE W/4" WOOD BALUSTERS @ 4" O.C. MAX SPACING, 2X6 P.T. TOP RAIL, 2X4 TOP & BOTTOM NAILERS. & 4X4 P.T. WOOD POSTS - SEE ENLARGED DETAIL 36"H P.T. WOOD DECK RAILING PER CODE W/4" WOOD BALUSTERS @ 4" O.C. MAX SPACING, 2X6 P.T. TOP RAIL, 2X4 TOP & BOTTOM NAILERS, & 4X4 P.T. WOOD POSTS AT 8'-0" O.C. MAX SPACING MOUNTED FLUSH INSIDE RIM JOIST -

36"H BLACK PAINTED STEEL/IRON HANDRAIL, MIN. 36"H, W/STAINLESS STEEL CABLES AT 4" O.C., RAILING REQUIREMENT T.B.D. BY SITE TOPOGRAPHY AND HEIGHT OF PORCH FLOOR ABOVE FINISHED GRADE

BLACK PAINTED STEEL/IRON HANDRAIL AT STEPS, MIN. 34"H

DRIP CAP - SEE ENLARGED DETAIL 42"H 2X4 FRAMED PARAPET WALL W/HORIZONTAL LAP SIDING (OWNER TO SELECT) OVER HOUSE WRAP OVER 5/8" [24] FIRE-RATED DENSGLASS SHEATHING (EXTERIOR SIDE) W/EPDM MEMBRANE OVER 7/16" OSB SHEATHING (INTERIOR SIDE) & CONT. METAL CAP & 1X6 COMPOSITE OUTER TRIM - SEE ENLARGED DETAIL 42"H (36"H ABOVE DECK SURFACE) 2X4 FRAMED PARTY RAILING WALL W/REVEAL PANEL SYSTEM OVER HOUSE WRAP OVER 7/16" OSB SHEATHING (BOTH SIDES) & METAL DRIP CAP - SEE ENLARGED DETAIL

EXT. WALL CONSTRUCTION AT REAR 3RD LEVEL: REVEAL PANEL SYSTEM OVER HOUSE WRAP VAPOR BARRIER 6) OVER 7/16" OSB SHEATHING OVER 2X6 STUDS AT 16" O.C. W/(2) TOP PLATE & (1) BOTTOM PLATE W/CAULK W/R-19 BATT INSULATION (BETWEEN STUDS) OVER 1/2" GYPSUM DRYWALL FINISH 36"H RAILING WALL W/2X4 P.T. TOP RAIL & STAINLESS STEEL CABLES AT 4" O.C. & 4X4 P.T. POSTS - SEE ENLARGED

 $28)\mid$ 6"X8" ALUMINUM OVERFLOW WALL SCUPPER, FLASH OPENING AS REQUIRED - SEE ENLARGED DETAIL

19"H 2X4 FRAMED PARAPET WALL WITH METAL CAP - SEE ENLARGED DETAIL

42"H (36"H ABOVE DECK SURFACE) 2X4 FRAMED BALCONY RAILING WALL W/HORIZONTAL LAP SIDING OVER HOUSE WRAP OVER 5/8" FIRE-RATED DENSGLASS SHEATHING (EXTERIOR SIDE) W/HORIZONTAL LAP SIDING OVER HOUSE WRAP OVER 7/16" OSB SHEATHING (INTERIOR SIDE) & CONT. METAL CAP & 1X4 COMPOSITE OUTER TRIM - SEE

.1.)│ OVER 5/8" FIRE-RATED DENSGLASS SHEATHING OVER 2X4 STUDS AT 16" O.C. W/(2) TOP PLATE & (1) BOTTOM PLATE W/CAULK W/R-15 BATT INSULATION (BETWEEN STUDS) OVER 5/8" FIRE-RATED GYPSUM DRYWALL FINISH FRONT EXTERIOR FRAMED WALL AT 3RD LEVEL: REVEAL PANEL SYSTEM OVER HOUSE WRAP VAPOR BARRIEF 2) OVER 7/16" OSB SHEATHING SHEATHING OVER 2X4 STUDS AT 16" O.C. W/(2) TOP PLATE & (1) BOTTOM PLATE W/

CAULK W/R-15 BATT INSULATION (BETWEEN STUDS) OVER 1/2" GYPSUM DRYWALL FINISH

12" CMU FOUNDATION WALL WITH #4 VERTICAL REINFORCING WITH BENT HOOK INTO FOOTING BELOW & ANCHOR BOLTS AT 6' O.C.. MAX 12" FROM CORNERS/ENDS, MIN. (2) PER WALL SEGMENT; GROUT CELLS AT REINFORCING/ ANCHOR BOLTS SOLID- SEE ENLARGED PARTY WALL DETAIL

34) LVL BEAM OR DBL 1-JOIST W/GALV. HANGERS AT STAIR OPENING - REFER TO LAYOUT BY JOIST MANUFACTURER

5) DBL I-JOIST AT STAIR OPENING - REFER TO LAYOUT BY JOIST MANUFACTURER 36) DBL 2X10 JOISTS AT STAIR OPENING

DBL 2X10 JOISTS W/GALV. HANGERS AT STAIR OPENING

38) 1/2" DRYWALL FINISH UNDER STAIRS W/2X4 NAILERS AT 24" O.C.

BUILT-UP PORCH BEAM W/1X PAINTED COMPOSITE TRIM BOARDS (10" FINISHED WIDTH) - SEE SECTION &

10) 1/4" THICK BEADBOARD CEILING FINISH

SKIRT ROOF IN FRONT OF PARAPET WALL: STANDING-SEAM METAL ROOFING OVER SYNTHETIC UNDERLAYMENT OVER 5/8" CDX PLYWOOD SHEATHING OVER 2X6 RAFTERS AT 16" O.C. - SEE ENLARGED DETAIL PARAPET TPO ROOF CONSTRUCTION: DURADECK 60-MIL MEMBRANE OVER 5/8" B-C PLYWOOD OVER 6" TAPERED RIGID INSULATION (SLOPED 1/4" PER FOOT TOWARDS SIDE GUTTER/DOWNSPOUT) OVER 3/4" T&G OSB SUBFLOOR

GLUED & NAILED OVER 2X10 JOISTS AT 16" O.C. W/3" MIN. SPRAY-FOAM INSULATION (UNDERSIDE OF SUBFLOOR) LOW PITCH ROOF: WHITE TPO OVER 5/8" CDX PLYWOOD OVER 6" RIGID INSULATION OVER 2X8 RAFTERS AT 16" O.C (SLOPED 1/4" PER 1'-0") OVER 2X8 CEILING JOISTS AT 16" O.C. WITH R-49 CELLULOSE INSULATION 19"H 2X4 FRAMED PARTY PARAPET WALL (ABOVE 3RD FLOOR CEILING) W/ METAL DRIP CAP - SEE ENLARGED

DETAIL
OPEN BALCONY DECK CONSTRUCTION: DURADECK 60-MIL MEMBRANE OVER 5/8" B-C PLYWOOD OVER 6" TAPERED RIGID INSULATION (SLOPED 1/4" PER FOOT TOWARDS REAR) OVER 3/4" T&G OSB SUBFLOOR GLUED & NAILED OVER 2X10 JOISTS AT 16" O.C. W/3" MIN. SPRAY FOAM INSULATION (UNDERSIDE OF SUBFLOOR) OVER 1/2" GYPSUM

46) ALUMINUM GUTTER AT REAR DECK EDGE

ALUMINUM DOWNSPOUT

EXT. WALL CONSTRUCTION AT F/R 1ST & 2ND LEVELS: HORIZONTAL LAP SIDING OVER HOUSE WRAP VAPOR BARRIER OVER 7/16" OSB SHEATHING (BOTTOM TO OVERLAP FOUNDATION 1") OVER 2X4 STUDS AT 16" O.C. W/(2) TOP PLATE & (1) BOTTOM PLATE W/CAULK W/R-15 BATT INSULATION (BETWEEN STUDS) OVER 1/2" GYPSUM

UL 2-HOUR RATED ASSEMBLY "U336": 1/2" GYPSUM DRYWALL FINISH OVER 2X4 STUDS AT 16" O.C. W/(2) TOP PLATE & (1) BOTTOM PLATE W/CAULK & R-15 BATT INSULATION (BETWEEN STUDS), 1" AIR SPACE W/1" TYPE SLX GYPSUM

0) 4 (1) BOTTOM PLATE W/CAULK 4 R-15 BATT INSULATION (BETWEEN STUDS), 1" AIR SPACE W/1" TYPE SLX GYPSUM BOARD SHAFT LINER - ALL LAYERS LISTED ARE MIRRORED

(1) TYP. 2X4 INTERIOR WALL W/ 1/2" DRYWALL FINISH

2X4 KNEEWALL UNDER STAIRS W/ 1/2" DRYWALL FINISH

34-36"H WOOD RAILING ON EDGE OF LANDING, PER CODE (W/WOOD BALUSTERS AT 4" O.C. MAX SPACING & WOOD NEWEL POSTS, CONSULT W/OWNER FOR SELECTIONS) 1ST LEVEL FLOOR STRUCTURE: 3/4" HARDWOOD FLOOR FINISH (U.N.O., OWNER TO SELECT) OVER 3/4" T&G OSB SUBFLOOR GLUED & NAILED OVER 2X10 FLOOR JOISTS AT 16" O.C. W/R-19 BATT INSULATION

2ND LEVEL FLOOR STRUCTURE: 3/4" HARDWOOD FLOOR FINISH (U.N.O., OWNER TO SELECT) OVER 3/4" T&G OSB 55)| SUBFLOOR GLUED & NAILED OVER 2X10 FLOOR JOISTS AT 16" O.C. W/R-19 BATT INSULATION (IF ADDITIONAL HVAC ZONING IS DESIRED)

3RD LEVEL FLOOR STRUCTURE: 3/4" HARDWOOD FLOOR FINISH (U.N.O., OWNER TO SELECT) OVER 3/4" T&G OSB

56) SUBFLOOR GLUED & NAILED OVER 14" ENGINEERED I-JOISTS AT 16" O.C. (REFER TO LAYOUT BY MANUFACTURER) W/R-19 BATT INSULATION (IF ADDITIONAL HVAC ZONING IS DESIRED) 3/4" TILE FLOOR FINISH, TYP. AT ALL WET LOCATIONS U.N.O., CONSULT W/OWNER FOR SELECTION

RAISED 2ND LEVEL STAIR LANDING: 3/4" HARDWOOD FLOOR FINISH (U.N.O., OWNER TO SELECT) OVER 3/4" T&G 58) SUBFLOOR W/ADHESIVE OVER 2X6 JOISTS AT 16" O.C. W/R-19 BATT INSULATION (IF ADDITIONAL HVAC ZONING IS

59) SUBFLOOR W/ADHESIVE OVER 2X8 JOISTS AT 16" O.C. W/R-19 BATT INSULATION (IF ADDITIONAL HVAC ZONING IS DESIRED) OVER 1/2" GYPSUM DRYWALL (CEILING UNDER LANDING 1ST LEVEL STAIR LANDING: 3/4" HARDWOOD FLOOR FINISH (U.N.O., OWNER TO SELECT) OVER 3/4" T&G SUBFLOOR W/ADHESIVE OVER 2X6 JOISTS AT 16" O.C.

2X4 FRAMED SLOPED RAILING WALL W/1X WOOD CAP W/34-36"H WOOD RAILING ABOVE PER CODE (W/WOOD BALUSTERS AT 4" O.C. MAX SPACING & WOOD NEWEL POSTS, CONSULT W/OWNER FOR SELECTIONS) 12"H SOFFIT FOR HVAC DUCT - 2X4 LADDER FRAME W/ 1/2" GYPSUM DRYWALL FINISH PROVIDING 8'-0" FINISHED

33) SHELF & ROD

(S4) STAIRS PER CODE TO W/WOOD RISERS, TREADS, & SKIRT BOARDS

5) SHELF & ROD, OR BUILT-IN SHELVING PER OWNER SELECTION

MULTI-SHELVING FOR PANTRY

SHELF ABOVE WASHER/DRYER

STACKED WASHER/DRYER - PROVIDE PAN UNDERNEATH, & W/D PLUMBING & DRYER VENT HOOKUPS AT REAR

(69) MIRROR TO BE SELECTED BY OWNER

BIM SERVICES

NVISIONTEKBIM.COM INFO@NVISIONTEKBIM.COM CELL: 804.372.0991 RICHMOND, VA 23236

REVISIONS

DATE DESCRIPTION

BUILDER NOTICE

T IS THE INTENT OF THE DESIGNER / DRAFTER LISTED IN THE TITLE BLOCK OF THESE DOCUMENTS THAT THESE DOCUMENTS ARE ACCURATE, PROVIDING LICENSED PROFESSIONALS CLEAR INFORMATION. EVERY ATTEMPT HAS BEEN MADE TO PREVENT ERROR. THE BUILDER AND SUBCONTRACTORS ARE REQUIRED TO REVIEW ALL THE INFORMATION CONTAINED IN THESE DOCUMENTS, PRIOR TO COMMENCEMENT OF ANY WORK. NVISIONTEK IS NOT RESPONSIBLE FOR ANY PLAN ERRORS, OMISSIONS, OR MISINTERPRETATIONS UNDETECTED AND NOT REPORTED WITHIN 3 DAYS AFTER FINAL

VERIFY ALL STRUCTURAL ITEMS ON PLANS WITH LICENSED STRUCTURAL ENGINEER

SUBMISSION OF DRAWINGS.

ARCHITECT IS SHOWN ON THE COVER SHEET, PLEASE USE THEM AS YOUR FIRST POINT OF CONTACT BEFORE CONTACTING *NVISIONTEK, LLC.* OTHERWISE, ANY QUESTIONS CONCERNING THESE DOCUMENTS SHALL BE DIRECTED TO DUSTIN HETRICK AT NVISIONTEK, LLC, CELL: (804) 372-0991, EMAIL: DHETRICK@NVISIONTEKBIM.COM.

IF THE GENERAL CONTRACTOR OR

PROJECT NAME

UNION HILL AT 1308 N 26TH STREET

CLIENT(S)

CENTER CREEK HOMES 11 S 12TH STREET, SUITE

RICHMOND, VA, 23219 T: 804.999.4449

PROJECT ADDRESS

1308 N 26TH STREET RICHMOND, VA 23223

BUILDING SECTIONS

DOCUMENT PHASE: PERMIT SET

> PLOT DATE: 11/1/2021


> > 9:57:04 AM

DRAWN BY:

DUSTIN HETRICK

SCALE: SEE PLAN

SHEET

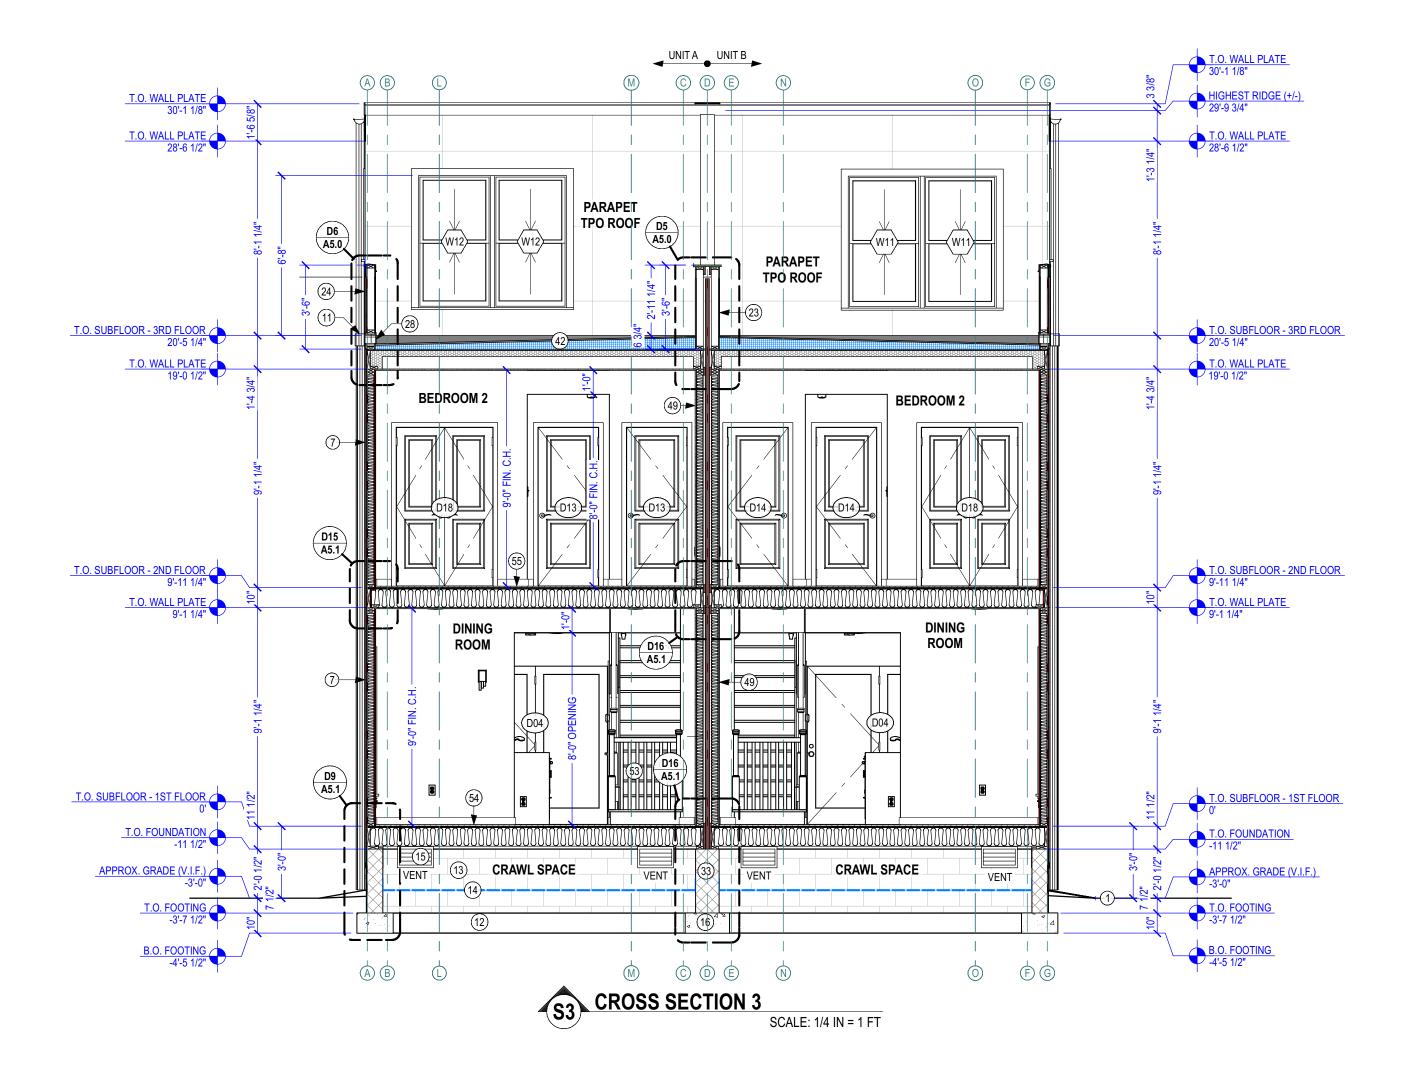



GENERAL STAIR & RAILING NOTES . NOT BE MORE THAN A 3/8" VARIANCE BETWEEN ANY RISER HEIGHT. REFERENCE R311.7.5.1 OF THE 2012 IRC.

- 2. STAIR NOSING TO BE NOT LESS THAN 3/4" BUT NOT MORE THAN 1-1/4" ON STAIRWAYS WITH SOLID RISERS. REFERENCE R311.7.5.3 OF THE 2012 IRC.
- 3. ALL DIMENSIONS ARE TO FINISHED FLOOR. CERAMIC TILE & HARDWOOD FLOOR = 3/4", UNLESS NOTED OTHERWISE.
- 4. STAIRWAYS SHALL HAVE A MIN. WIDTH OF 34". HAND RAILS MAY ENCROACH A MAX. OF 3 1/2" INTO THE REQUIRED WIDTH.
- . TREADS SHALL HAVE A MIN. WIDTH OF 9". STAIR TREADS MUST BE UNIFORM AND CAN NOT VARY FROM THE LARGEST TO THE SMALLEST BY MORE THAN 3/8".
- 6. STAIRWAYS SHALL HAVE MIN. 6'-8" OF HEADROOM AT THE NOSE OF THE STAIR.
- . ENCLOSED USABLE SPACE UNDER INTERIOR STAIRS SHALL BE PROTECTED ON THE ENCLOSED FACE WITH 5/8" TYPE "X" GYPSUM WALL BOARD.
- 8. STAIRWAYS SHALL HAVE AT LEAST ONE HANDRAIL LOCATED 34" TO 38" ABOVE THE NOSING OF TREADS AND LANDINGS. THE HAND GRIP PORTION OF HANDRAILS SHALL NOT BE LESS THAN 1-1/2" OR GREATER THAN 2" IN CROSS-SECTIONAL
- 9. HANDRAILS SHALL BE CONTINUOUS THE FULL LENGTH OF THE STAIRS. THE ENDS OF HANDRAILS SHALL RETURN TO WALL OR TERMINATE INTO A NEWEL POST OR SAFETY TERMINAL.
- 10. STAIRWAYS HAVING LESS THAN 2 RISERS DO NOT REQUIRE A HAND RAIL.
- 1. 34" MIN. HEIGHT GUARDRAILS SHALL BE PROVIDED FOR AT PORCHES, DECKS, BALCONIES, STAIRWAYS AND LANDINGS WHERE THE ADJACENT SURFACE IS GREATER THAN 24" BELOW.
- 12. RAILING AND GUARDRAIL BALUSTER SPACING SHALL BE NO GREATER THAN 4".
- 13. THE TRIANGULAR OPENINGS FORMED BY THE RISER, TREAD, AND BOTTOM OF GUARDRAIL SHALL NOT ALLOW A 6" DIAMETER SPHERE TO PASS THROUGH.
- 14. EXTERIOR SPIRAL STAIRS TO BE FABRICATED AND INSTALLED PER THE MFG.
- INSTRUCTIONS, WITH A MIN. HEADROOM OF 6'-6".
- 5. RAMPS SHALL HAVE A MAXIMUM SLOPE OF 1 UNIT VERTICAL IN 12 UNITS HORIZONTAL (8.3% SLOPE), WITH A 3'x3' LANDING AT THE TOP & BOTTOM, WHERE DOORS OPEN ONTO RAMP, AND WHERE RAMP CHANGES DIRECTION.

GENERAL SECTION NOTES

- 1. 2x PRESSURE TREATED SILL PLATE WITH SILL SEALER AT TOP OF FOUNDATION WALLS WHERE FLOOR FRAMING MEMBERS BEAR SUPPORT. (TYPICAL).
- EXTERIOR WALL FRAMING TO BE 2x4 WALL STUDS @ 16" O.C., U.N.O., WITH DOUBLE TOP PLATES AND SINGLE BOTTOM PLATE. BOTTOM PLATE TO BE FLUSH WITH FOUNDATION, AND 7/16" OSB SHEATHING TO OVERLAP 1" BELOW.
- 3. ALL LUMBER IN DIRECT CONTACT WITH FOUNDATION SHALL BE PRESSURE
- REFERENCE WINDOW, DOOR, OR ANY OTHER TAGS TO LEGENDS AND SCHEDULES, SHOWN THROUGHOUT SET.
- 5. IF KEYNOTES ARE USED, REFERENCE KEYNOTE LEGEND ON THIS SHEET FOR DESCRIPTION.
- E. ROOF VENTILATION OPTIONS (REFER TO PLANS): • VENTED - ROOF EAVES TO HAVE CONTINUOUS VENTED SOFFITS AND RIDGE VENTS (LENGTHS AS REQ'D.)
- NON-VENTED ATTIC AND CRAWL SPACES TO BE SEALED AND CONDITIONED WITH MECHANICAL VENTILATION AND HVAC. ROOF EAVES AND RIDGES TO BE NON-VENTED.

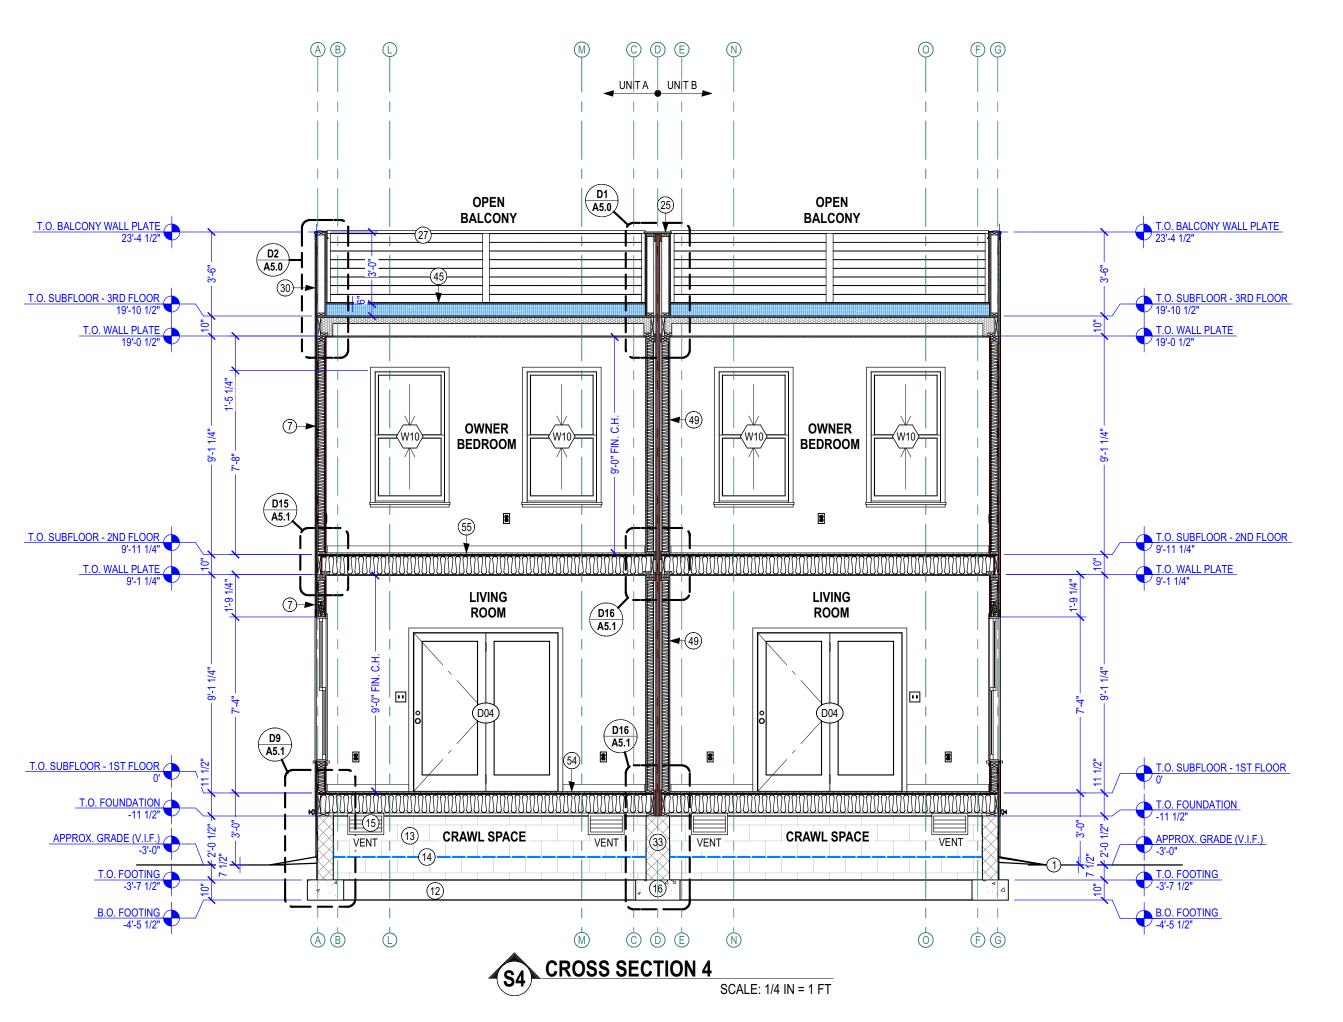

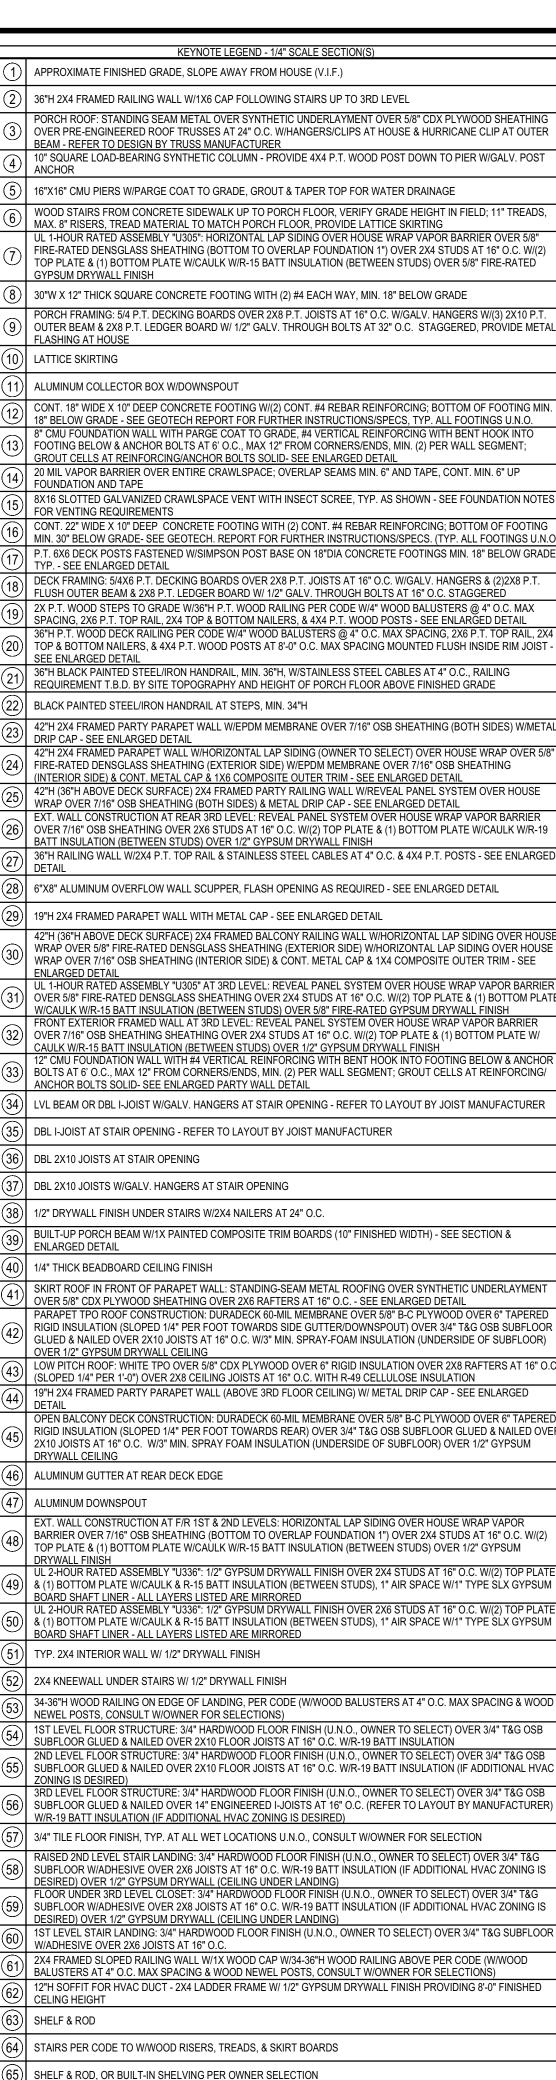

6) MULTI-SHELVING FOR PANTRY

SHELF ABOVE WASHER/DRYER

(69) MIRROR TO BE SELECTED BY OWNER

STACKED WASHER/DRYER - PROVIDE PAN UNDERNEATH, & W/D PLUMBING & DRYER VENT HOOKUPS AT REAR

KEYNOTE LEGEND - 1/4" SCALE SECTION(S APPROXIMATE FINISHED GRADE, SLOPE AWAY FROM HOUSE (V.I.F.) 36"H 2X4 FRAMED RAILING WALL W/1X6 CAP FOLLOWING STAIRS UP TO 3RD LEVEL PORCH ROOF: STANDING SEAM METAL OVER SYNTHETIC UNDERLAYMENT OVER 5/8" CDX PLYWOOD SHEATHING OVER PRE-ENGINEERED ROOF TRUSSES AT 24" O.C. W/HANGERS/CLIPS AT HOUSE & HURRICANE CLIP AT OUTER 10" SQUARE LOAD-BEARING SYNTHETIC COLUMN - PROVIDE 4X4 P.T. WOOD POST DOWN TO PIER W/GALV. POST 16"X16" CMU PIERS W/PARGE COAT TO GRADE, GROUT & TAPER TOP FOR WATER DRAINAGE WOOD STAIRS FROM CONCRETE SIDEWALK UP TO PORCH FLOOR, VERIFY GRADE HEIGHT IN FIELD; 11" TREADS, MAX, 8" RISERS, TREAD MATERIAL TO MATCH PORCH FLOOR, PROVIDE LATTICE SKIRTING UL 1-HOUR RATED ASSEMBLY "U305": HORIZONTAL LAP SIDING OVER HOUSE WRAP VAPOR BARRIER OVER 5/8 FIRE-RATED DENSGLASS SHEATHING (BOTTOM TO OVERLAP FOUNDATION 1") OVER 2X4 STUDS AT 16" O.C. W/(2) TOP PLATE & (1) BOTTOM PLATE W/CAÙLK W/R-15 BATT INSULATION (BETWEÉN STUDS) OVER 5/8" FIRE-RATED ` 30"W X 12" THICK SQUARE CONCRETE FOOTING WITH (2) #4 EACH WAY, MIN. 18" BELOW GRADE PORCH FRAMING: 5/4 P.T. DECKING BOARDS OVER 2X8 P.T. JOISTS AT 16" O.C. W/GALV. HANGERS W/(3) 2X10 P.T. OUTER BEAM & 2X8 P.T. LEDGER BOARD W/ 1/2" GALV. THROUGH BOLTS AT 32" O.C. STAGGERED, PROVIDE METAL CONT. 18" WIDE X 10" DEEP CONCRETE FOOTING W/(2) CONT. #4 REBAR REINFORCING; BOTTOM OF FOOTING MIN. 18" BELOW GRADE - SEE GEOTECH REPORT FOR FURTHER INSTRUCTIONS/SPECS. TYP. ALL FOOTINGS U.N.O. 8" CMU FOUNDATION WALL WITH PARGE COAT TO GRADE, #4 VERTICAL REINFORCING WITH BENT HOOK INTO 3) FOOTING BELOW & ANCHOR BOLTS AT 6' O.C., MAX 12" FROM CORNERS/ENDS, MIN. (2) PER WALL SEGMENT; GROUT CELLS AT REINFORCING/ANCHOR BOLTS SOLID- SEE ENLARGED DETAIL 20 MIL VAPOR BARRIER OVER ENTIRE CRAWLSPACE; OVERLAP SEAMS MIN. 6" AND TAPE, CONT. MIN. 6" UP 8X16 SLOTTED GALVANIZED CRAWLSPACE VENT WITH INSECT SCREE, TYP. AS SHOWN - SEE FOUNDATION NOTES CONT. 22" WIDE X 10" DEEP CONCRETE FOOTING WITH (2) CONT. #4 REBAR REINFORCING; BOTTOM OF FOOTING MIN. 30" BELOW GRADE- SEE GEOTECH. REPORT FOR FURTHER INSTRUCTIONS/SPECS. (TYP. ALL FOOTINGS U.N.O P.T. 6X6 DECK POSTS FASTENED W/SIMPSON POST BASE ON 18"DIA CONCRETE FOOTINGS MIN. 18" BELOW GRADE DECK FRAMING: 5/4X6 P.T. DECKING BOARDS OVER 2X8 P.T. JOISTS AT 16" O.C. W/GALV. HANGERS & (2)2X8 P.T. FLUSH OUTER BEAM & 2X8 P.T. LEDGER BOARD W/ 1/2" GALV. THROUGH BOLTS AT 16" O.C. STAGGERED 2X P.T. WOOD STEPS TO GRADE W/36"H P.T. WOOD RAILING PER CODE W/4" WOOD BALUSTERS @ 4" O.C. MAX SPACING, 2X6 P.T. TOP RAIL, 2X4 TOP & BOTTOM NAILERS. & 4X4 P.T. WOOD POSTS - SEE ENLARGED DETAIL 36"H P.T. WOOD DECK RAILING PER CODE W/4" WOOD BALUSTERS @ 4" O.C. MAX SPACING, 2X6 P.T. TOP RAIL, 2X4 \mid TOP & BOTTOM NAILERS, & 4X4 P.T. WOOD POSTS AT 8'-0" O.C. MAX SPACING MOUNTED FLUSH INSIDE RIM JOIST -SEE ENLARGED DETAIL
36"H BLACK PAINTED STEEL/IRON HANDRAIL, MIN. 36"H, W/STAINLESS STEEL CABLES AT 4" O.C., RAILING REQUIREMENT T.B.D. BY SITE TOPOGRAPHY AND HEIGHT OF PORCH FLOOR ABOVE FINISHED GRADE 42"H 2X4 FRAMED PARTY PARAPET WALL W/EPDM MEMBRANE OVER 7/16" OSB SHEATHING (BOTH SIDES) W/METAL 42"H 2X4 FRAMED PARAPET WALL W/HORIZONTAL LAP SIDING (OWNER TO SELECT) OVER HOUSE WRAP OVER 5/8" 24) FIRE-RATED DENSGLASS SHEATHING (EXTERIOR SIDE) W/EPDM MEMBRANE OVER 7/16" OSB SHEATHING (INTERIOR SIDE) & CONT. METAL CAP & 1X6 COMPOSITE OUTER TRIM - SEE ENLARGED DETAIL 42"H (36"H ABOVE DECK SURFACE) 2X4 FRAMED PARTY RAILING WALL W/REVEAL PANEL SYSTEM OVER HOUSE WRAP OVER 7/16" OSB SHEATHING (BOTH SIDES) & METAL DRIP CAP - SEE ENLARGED DETAIL EXT. WALL CONSTRUCTION AT REAR 3RD LEVEL: REVEAL PANEL SYSTEM OVER HOUSE WRAP VAPOR BARRIER 3) OVER 7/16" OSB SHEATHING OVER 2X6 STUDS AT 16" O.C. W/(2) TOP PLATE & (1) BOTTOM PLATE W/CAULK W/R-19 BATT INSULATION (BETWEEN STUDS) OVER 1/2" GYPSUM DRYWALL FINIS 36"H RAILING WALL W/2X4 P.T. TOP RAIL & STAINLESS STEEL CABLES AT 4" O.C. & 4X4 P.T. POSTS - SEE ENLARGED [28] 6"X8" ALUMINUM OVERFLOW WALL SCUPPER, FLASH OPENING AS REQUIRED - SEE ENLARGED DETAIL 19"H 2X4 FRAMED PARAPET WALL WITH METAL CAP - SEE ENLARGED DETAIL 42"H (36"H ABOVE DECK SURFACE) 2X4 FRAMED BALCONY RAILING WALL W/HORIZONTAL LAP SIDING OVER HOUSE WRAP OVER 5/8" FIRE-RATED DENSGLASS SHEATHING (EXTERIOR SIDE) W/HORIZONTAL LAP SIDING OVER HOUSE WRAP OVER 7/16" OSB SHEATHING (INTERIOR SIDE) & CONT. METAL CAP & 1X4 COMPOSITE OUTER TRIM - SEE UL 1-HOUR RATED ASSEMBLY "U305" AT 3RD LEVEL: REVEAL PANEL SYSTEM OVER HOUSE WRAP VAPOR BARRIER $31)\mid$ OVER 5/8" FIRE-RATED DENSGLASS SHEATHING OVER 2X4 STUDS AT 16" O.C. W/(2) TOP PLATE & (1) BOTTOM PLATE W/CAULK W/R-15 BATT INSULATION (BETWEEN STUDS) OVER 5/8" FIRE-RATED GYPSUM DRYWALL FINISH FRONT EXTERIOR FRAMED WALL AT 3RD LEVEL: REVEAL PANEL SYSTEM OVER HOUSE WRAP VAPOR BARRIEF 32) OVER 7/16" OSB SHEATHING SHEATHING OVER 2X4 STUDS AT 16" O.C. W/(2) TOP PLATE & (1) BOTTOM PLATE W/ CAULK W/R-15 BATT INSULATION (BETWEEN STUDS) OVER 1/2" GYPSUM DRYWALL FINISH

12" CMU FOUNDATION WALL WITH #4 VERTICAL REINFORCING WITH BENT HOOK INTO FOOTING BELOW & ANCHOR BOLTS AT 6' O.C.. MAX 12" FROM CORNERS/ENDS, MIN. (2) PER WALL SEGMENT; GROUT CELLS AT REINFORCING/ 34) LVL BEAM OR DBL I-JOIST W/GALV. HANGERS AT STAIR OPENING - REFER TO LAYOUT BY JOIST MANUFACTURER 5) DBL I-JOIST AT STAIR OPENING - REFER TO LAYOUT BY JOIST MANUFACTURER BUILT-UP PORCH BEAM W/1X PAINTED COMPOSITE TRIM BOARDS (10" FINISHED WIDTH) - SEE SECTION & SKIRT ROOF IN FRONT OF PARAPET WALL: STANDING-SEAM METAL ROOFING OVER SYNTHETIC UNDERLAYMENT OVER 5/8" CDX PLYWOOD SHEATHING OVER 2X6 RAFTERS AT 16" O.C. - SEE ENLARGED DETAIL PARAPET TPO ROOF CONSTRUCTION: DURADECK 60-MIL MEMBRANE OVER 5/8" B-C PLYWOOD OVER 6" TAPERED RIGID INSULATION (SLOPED 1/4" PER FOOT TOWARDS SIDE GUTTER/DOWNSPOUT) OVER 3/4" T&G OSB SUBFLOOR GLUED & NAILED OVER 2X10 JOISTS AT 16" O.C. W/3" MIN. SPRAY-FOAM INSULATION (UNDERSIDE OF SUBFLOOR) .O .16 LOW PITCH ROOF: WHITE TPO OVER 5/8" CDX PLYWOOD OVER 6" RIGID INSULATION OVER 2X8 RAFTERS AT (SLOPED 1/4" PER 1'-0") OVER 2X8 CEILING JOISTS AT 16" O.C. WITH R-49 CELLULOSE INSULATION 19"H 2X4 FRAMED PARTY PARAPET WALL (ABOVE 3RD FLOOR CEILING) W/ METAL DRIP CAP - SEE ENLARGED DETAIL
OPEN BALCONY DECK CONSTRUCTION: DURADECK 60-MIL MEMBRANE OVER 5/8" B-C PLYWOOD OVER 6" TAPERED RIGID INSULATION (SLOPED 1/4" PER FOOT TOWARDS REAR) OVER 3/4" T&G OSB SUBFLOOR GLUED & NAILED OVER 2X10 JOISTS AT 16" O.C. W/3" MIN. SPRAY FOAM INSULATION (UNDERSIDE OF SUBFLOOR) OVER 1/2" GYPSUM EXT. WALL CONSTRUCTION AT F/R 1ST & 2ND LEVELS: HORIZONTAL LAP SIDING OVER HOUSE WRAP VAPOR

PROJECT NAME

(804) 372-0991, EMAIL:

UNION HILL AT 1308 N **26TH STREET**

BIM SERVICES

NVISIONTEKBIM.COM

INFO@NVISIONTEKBIM.COM

CELL: 804.372.0991

RICHMOND, VA 23236

REVISIONS

BUILDER NOTICE

T IS THE INTENT OF THE DESIGNER /

THESE DOCUMENTS THAT THESE

LICENSED PROFESSIONALS CLEAR

IN THESE DOCUMENTS, PRIOR TO

COMMENCEMENT OF ANY WORK.

PLAN ERRORS, OMISSIONS, OR

SUBMISSION OF DRAWINGS.

DRAFTER LISTED IN THE TITLE BLOCK OF

DOCUMENTS ARE ACCURATE, PROVIDING

INFORMATION. EVERY ATTEMPT HAS BEEN

MADE TO PREVENT ERROR. THE BUILDER

AND SUBCONTRACTORS ARE REQUIRED TO

REVIEW ALL THE INFORMATION CONTAINED

NVISIONTEK IS NOT RESPONSIBLE FOR ANY

NOT REPORTED WITHIN 3 DAYS AFTER FINAL

***VERIFY ALL STRUCTURAL ITEMS ON

PLANS WITH LICENSED STRUCTURAL

ENGINEER***

IF THE GENERAL CONTRACTOR OR

NVISIONTEK, LLC. OTHERWISE, ANY

QUESTIONS CONCERNING THESE DOCUMENTS SHALL BE DIRECTED TO

DHETRICK@NVISIONTEKBIM.COM.

ARCHITECT IS SHOWN ON THE COVER

SHEET, PLEASE USE THEM AS YOUR FIRST

POINT OF CONTACT BEFORE CONTACTING

DUSTIN HETRICK AT NVISIONTEK, LLC, CELL:

MISINTERPRETATIONS UNDETECTED AND

DESCRIPTION

DATE

CLIENT(S)

CENTER CREEK HOMES 11 S 12TH STREET, SUITE

RICHMOND, VA, 23219 T: 804.999.4449

PROJECT ADDRESS

1308 N 26TH STREET RICHMOND, VA 23223

BUILDING SECTIONS

DOCUMENT PHASE:

PLOT DATE:

11/1/2021 9:57:06 AM

PERMIT SET


DRAWN BY:

DUSTIN HETRICK

SCALE: SEE PLAN

12 OF 17

SHEET

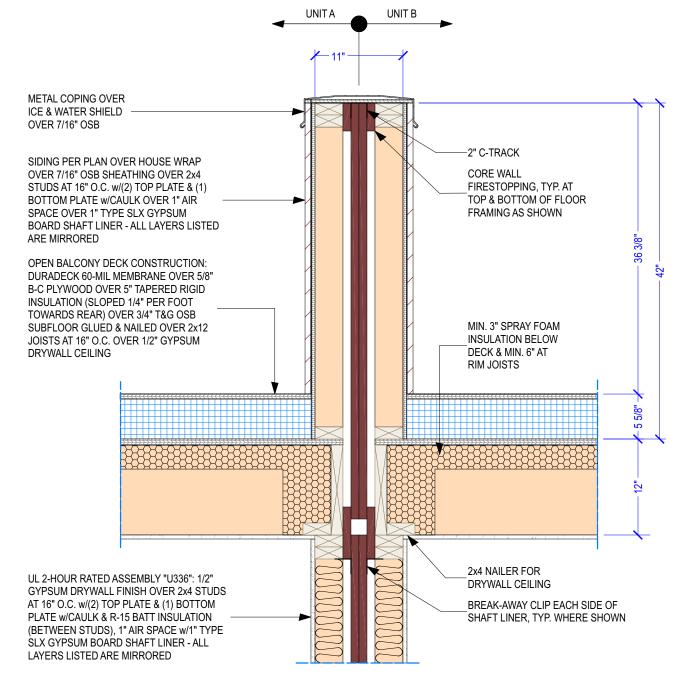

TYP. DETAIL - PARTY RAILING WALL AT OPEN BALCONY


SCALE: 1 IN = 1 FT

TPO MEMBRANE OVER 7/16" OSB SHEATHING -2" C-TRACK OVER 2X4 FRAMED PARAPET WALL w/STUDS AT 16" O.C. w/(2) TOP PLATE & (1) BOTTOM PLATE METAL COPING OVER w/CAULK OVER 1" AIR SPACE OVER 1" TYPE SLX ICE & WATER SHIELD GYPSUM BOARD SHAFT LINER - ALL LAYERS OVER 7/16" OSB LISTED ARE MIRRORED CORE WALL FIRESTOPPING, PARAPET TPO ROOF CONSTRUCTION: TYP. AT TOP & BOTTOM OF DURADECK 60-MIL MEMBRANE OVER 5/8" B-C FLOOR FRAMING AS SHOWN PLYWOOD OVER 6" TAPERED RIGID INSULATION (SLOPED 1/4" PER FOOT TOWARDS SIDE GUTTER/DOWNSPOUT) OVER 3/4" T&G OSB SUBFLOOR OVER 2x10 JOISTS AT 16" O.C. w/3" MIN. SPRAY-FOAM INSULATION OVER 1/2" GYPSUM DRYWALL CEILING 2x4 NAILER FOR UL 2-HOUR RATED ASSEMBLY "U336": 1/2" DRYWALL CEILING GYPSUM DRYWALL FINISH OVER 2x4 STUDS BREAK-AWAY CLIP EACH SIDE OF AT 16" O.C. w/(2) TOP PLATE & (1) BOTTOM SHAFT LINER, TYP. WHERE SHOWN PLATE w/CAULK & R-15 BATT INSULATION (BETWEEN STUDS), 1" AIR SPACE w/1" TYPE SLX GYPSUM BOARD SHAFT LINER - ALL

TYP. DETAIL - PARTY WALL AT PARAPET ROOF


SCALE: 1 IN = 1 FT

LAYERS LISTED ARE MIRRORED

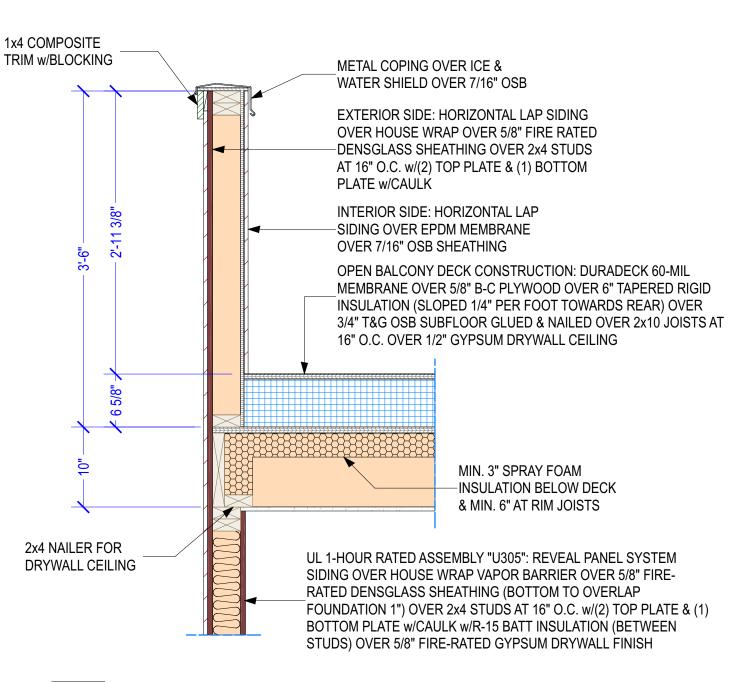


TYP. DETAIL - SIDE RAILING WALL AT OPEN BALCONY

SCALE: 1 IN = 1 F

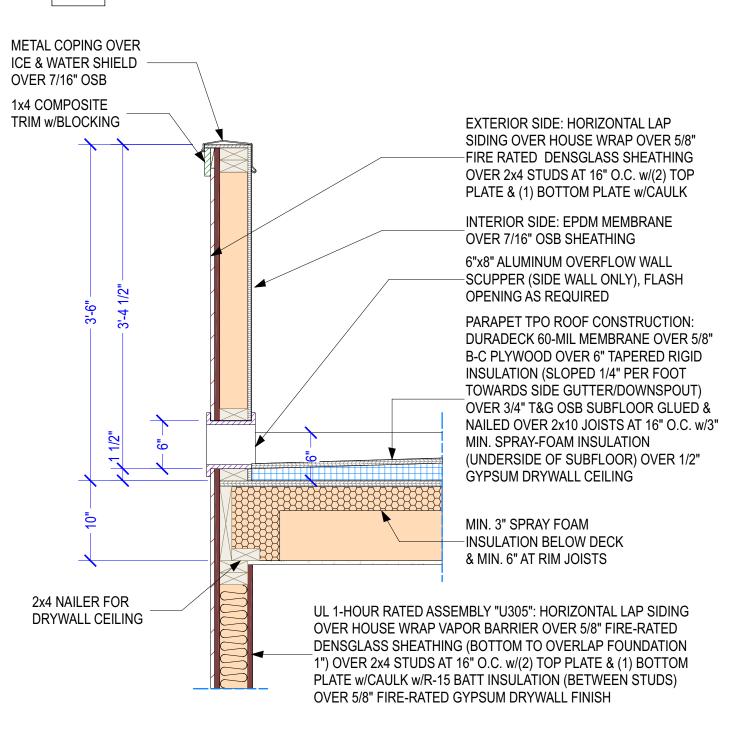


TYP. DETAIL - SIDE WALL AT PARAPET ROOF

SCALE: 1 IN = 1 FT

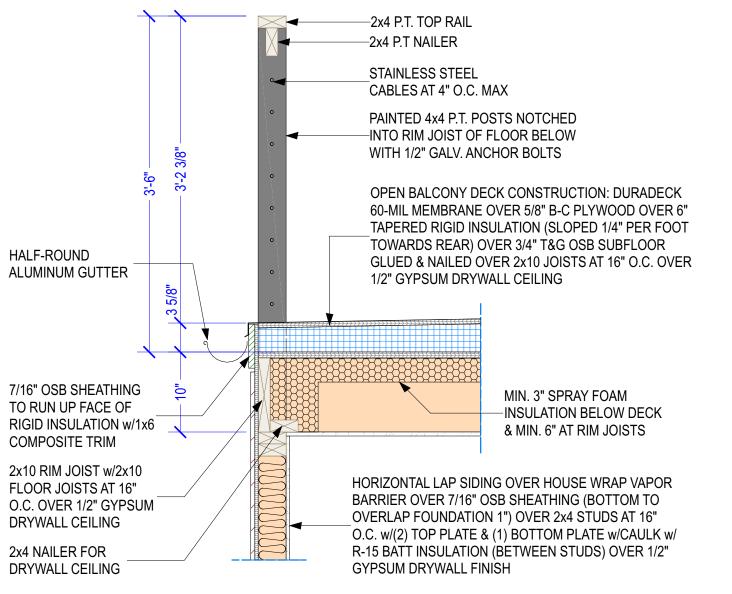


TYP. DETAIL - METAL RAILING REAR WALL AT OPEN BALCONY

SCALE: 1 IN = 1 FT

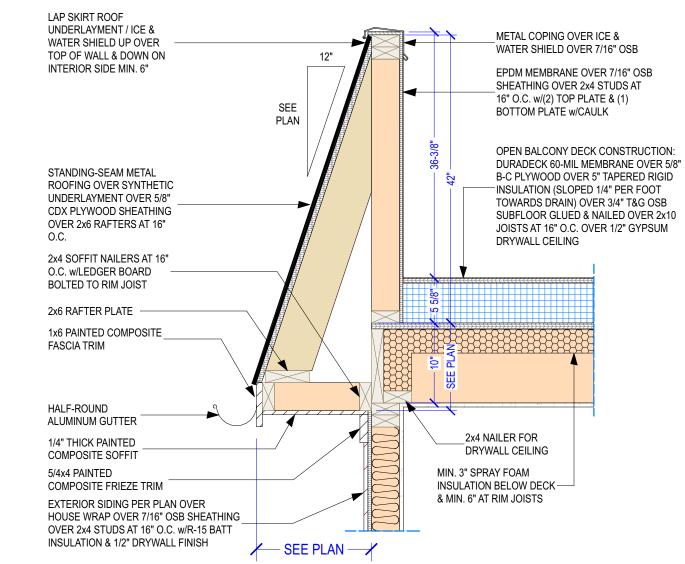


D4 TYP. DETAIL - FRONT SKIRT ROOF/PARAPET WALL

SCALE: 1 IN = 1 FT

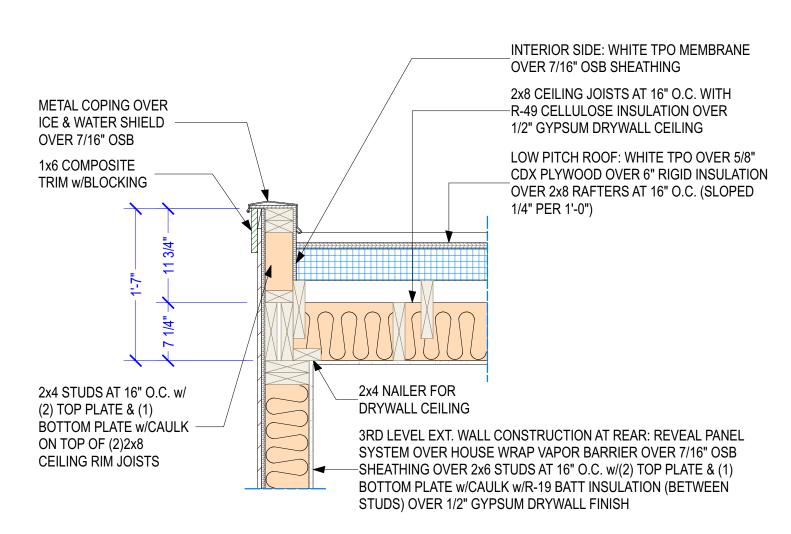

TYP. DETAIL - FRONT/REAR WALL AT PARAPET ROOF

SCALE: 1 IN = 1 FT

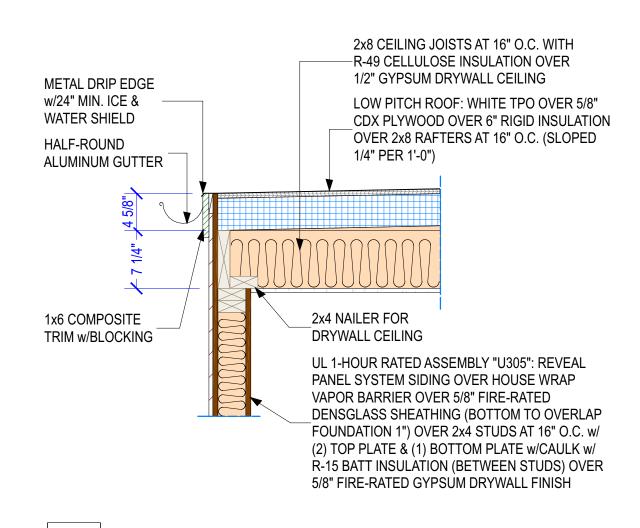

D8 TYP. DETAIL - LOW-PITCH ROOF EAVE

SCALE: 1 IN = 1 FT

nVisionTEK

NVISIONTEKBIM.COM INFO@NVISIONTEKBIM.COM CELL: 804.372.0991 RICHMOND, VA 23236

REVISIONS

DATE DESCRIPTION

BUILDER NOTICE

IT IS THE INTENT OF THE DESIGNER /
DRAFTER LISTED IN THE TITLE BLOCK OF
THESE DOCUMENTS THAT THESE
DOCUMENTS ARE ACCURATE, PROVIDING
LICENSED PROFESSIONALS CLEAR
INFORMATION. EVERY ATTEMPT HAS BEEN
MADE TO PREVENT ERROR. THE BUILDER
AND SUBCONTRACTORS ARE REQUIRED TO
REVIEW ALL THE INFORMATION CONTAINED
IN THESE DOCUMENTS, PRIOR TO
COMMENCEMENT OF ANY WORK.
NVISIONTEK IS NOT RESPONSIBLE FOR ANY
PLAN ERRORS, OMISSIONS, OR
MISINTERPRETATIONS UNDETECTED AND
NOT REPORTED WITHIN 3 DAYS AFTER FINAL

VERIFY ALL STRUCTURAL ITEMS ON PLANS WITH LICENSED STRUCTURAL ENGINEER

SUBMISSION OF DRAWINGS.

IF THE GENERAL CONTRACTOR OR ARCHITECT IS SHOWN ON THE COVER SHEET, PLEASE USE THEM AS YOUR FIRST POINT OF CONTACT BEFORE CONTACTING NVISIONTEK, LLC. OTHERWISE, ANY QUESTIONS CONCERNING THESE DOCUMENTS SHALL BE DIRECTED TO DUSTIN HETRICK AT NVISIONTEK, LLC, CELL: (804) 372-0991, EMAIL: DHETRICK@NVISIONTEKBIM.COM.

PROJECT NAME

UNION HILL AT 1308 N 26TH STREET

CLIENT(S)

CENTER CREEK HOMES

11 S 12TH STREET, SUITE

RICHMOND, VA, 23219 T: 804.999.4449

PROJECT ADDRESS

1308 N 26TH STREET RICHMOND, VA 23223

TITLE

DETAILS

DOCUMENT PHASE:
PERMIT SET

PLOT DATE:

9:57:07 AM


11/1/2021

DRAWN BY:DUSTIN HETRICK

SCALE: SEE PLAN

SHEET

A5.0

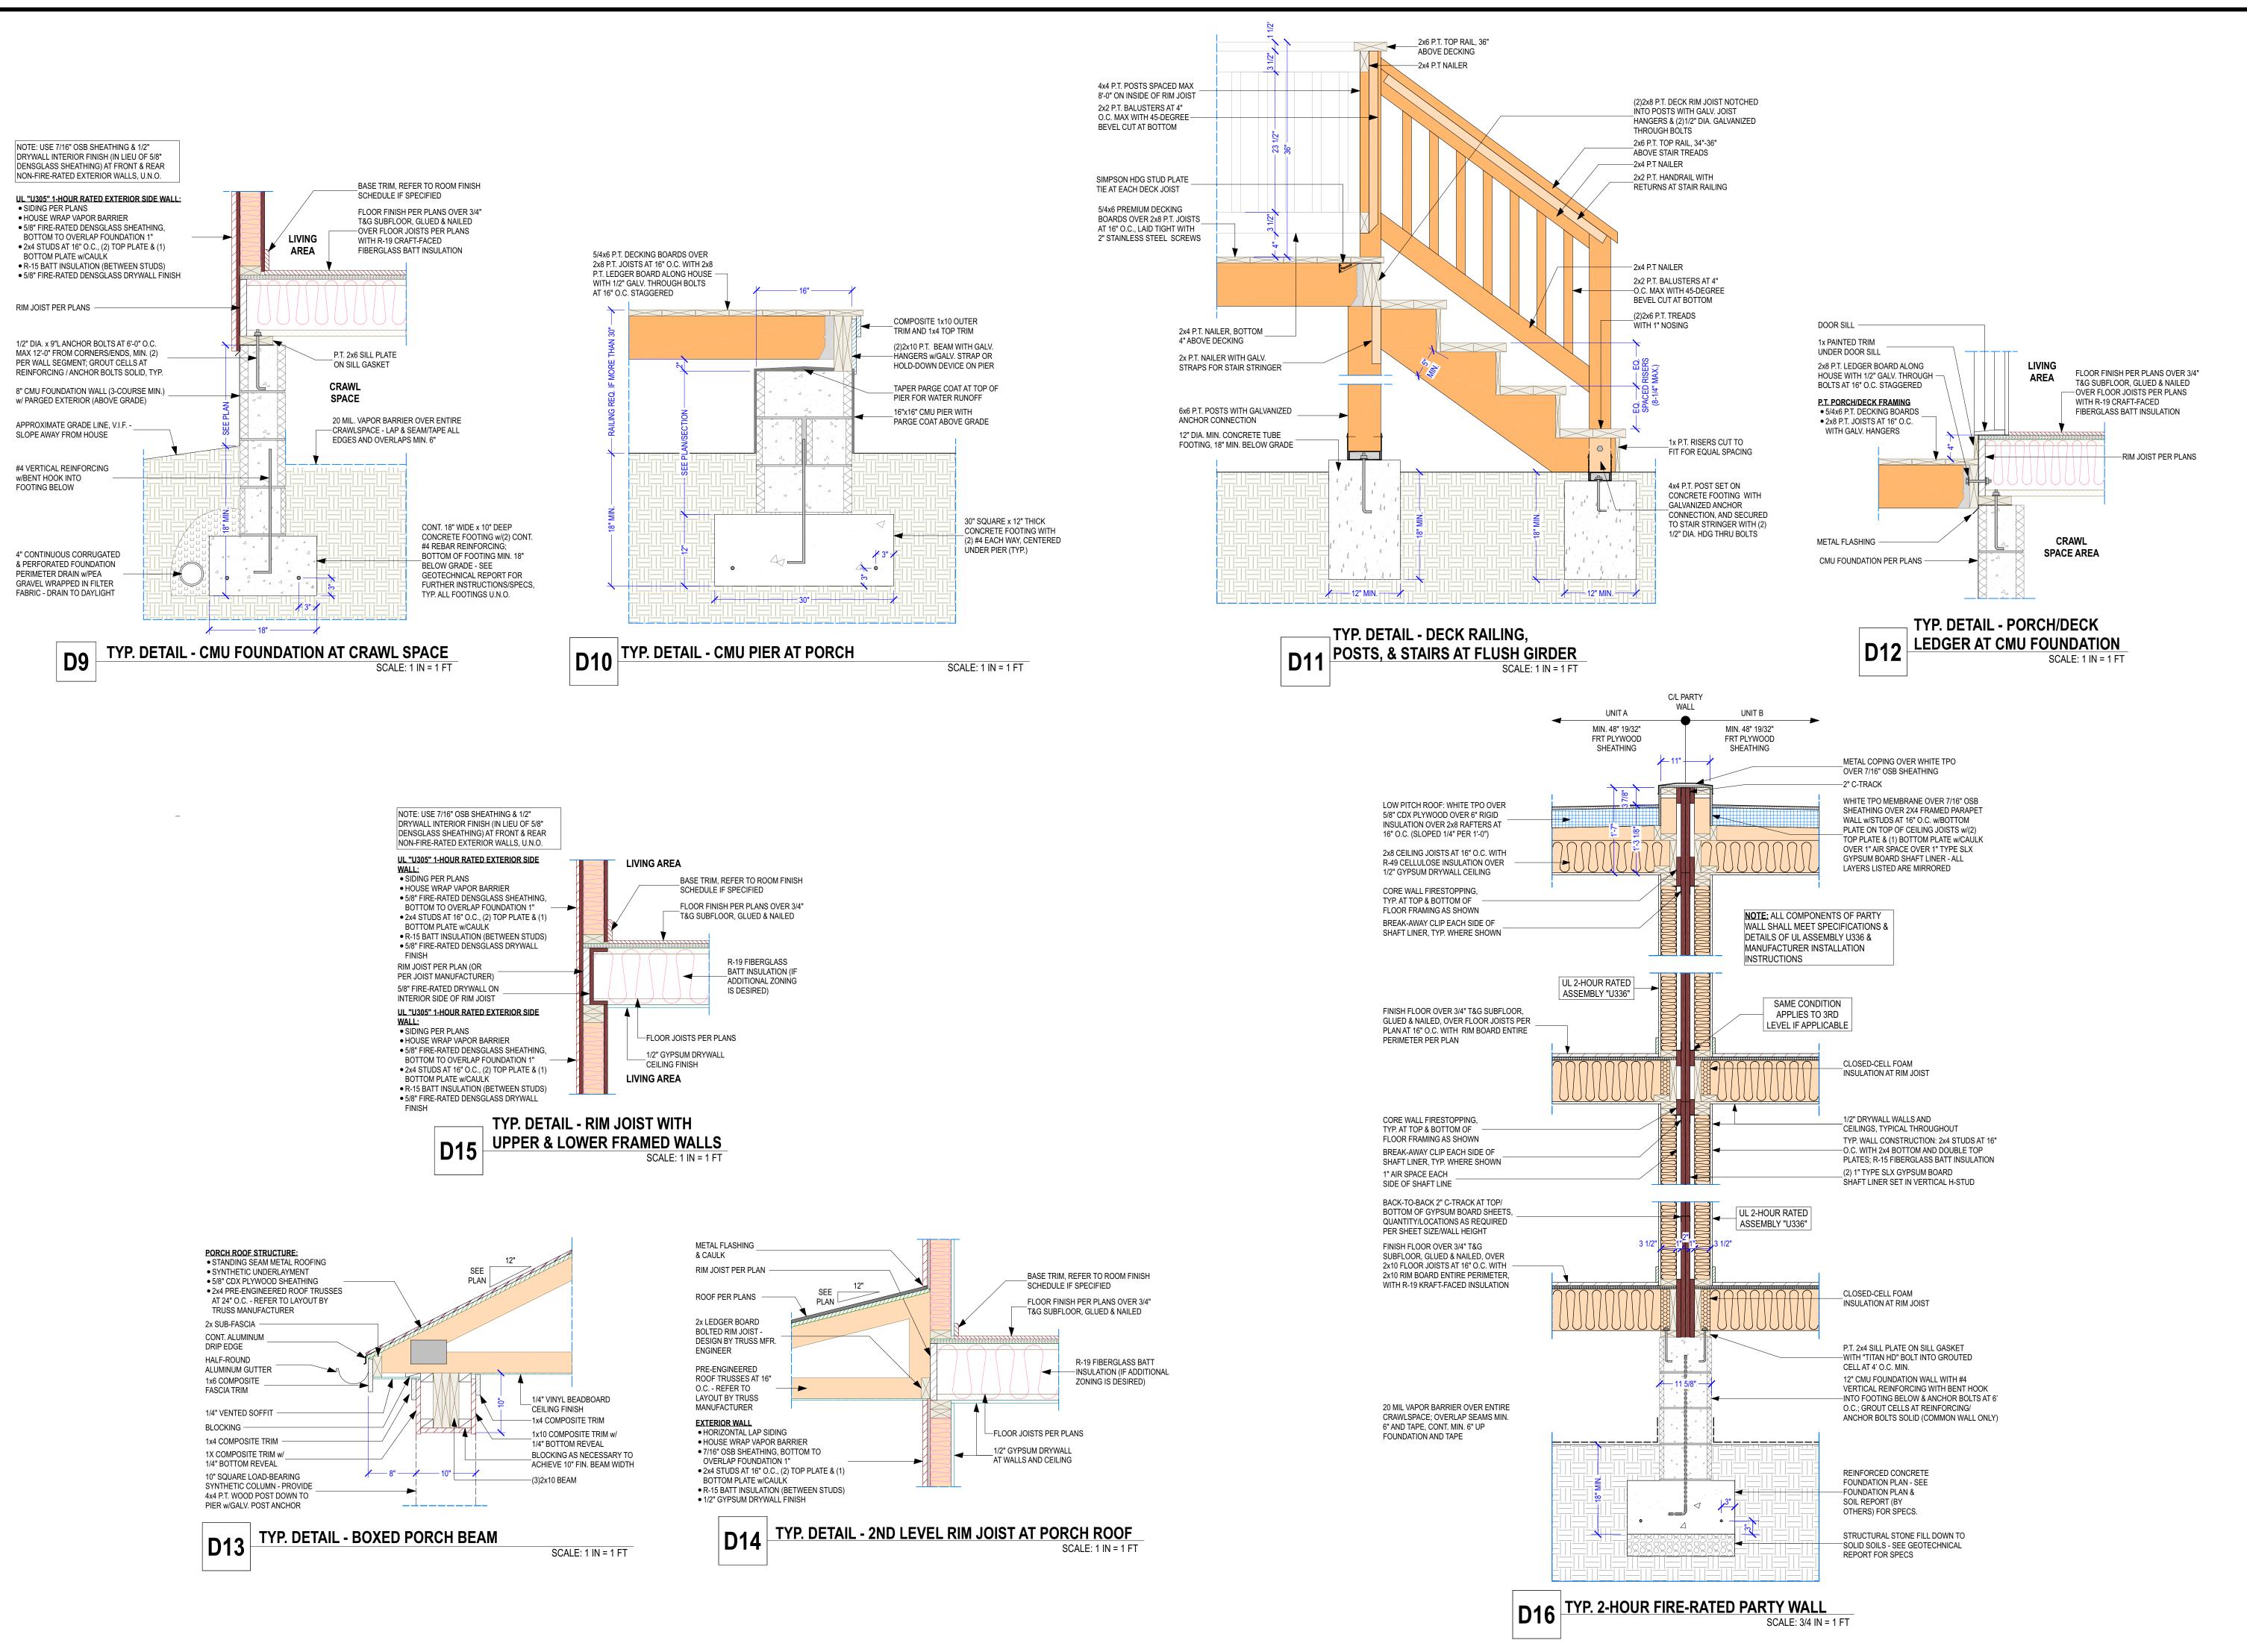

NVISIONTEKBIM.COM

INFO@NVISIONTEKBIM.COM

CELL: 804.372.0991

RICHMOND, VA 23236

REVISIONS

BUILDER NOTICE

IT IS THE INTENT OF THE DESIGNER /

THESE DOCUMENTS THAT THESE

LICENSED PROFESSIONALS CLEAR

IN THESE DOCUMENTS, PRIOR TO

COMMENCEMENT OF ANY WORK.

PLAN ERRORS, OMISSIONS, OR

SUBMISSION OF DRAWINGS.

DRAFTER LISTED IN THE TITLE BLOCK OF

DOCUMENTS ARE ACCURATE, PROVIDING

INFORMATION. EVERY ATTEMPT HAS BEEN

MADE TO PREVENT ERROR. THE BUILDER

AND SUBCONTRACTORS ARE REQUIRED TO

REVIEW ALL THE INFORMATION CONTAINED

NVISIONTEK IS NOT RESPONSIBLE FOR ANY

MISINTERPRETATIONS UNDETECTED AND

NOT REPORTED WITHIN 3 DAYS AFTER FINAL

***VERIFY ALL STRUCTURAL ITEMS ON

PLANS WITH LICENSED STRUCTURAL

ENGINEER***

SHEET, PLEASE USE THEM AS YOUR FIRST

POINT OF CONTACT BEFORE CONTACTING NVISIONTEK, LLC. OTHERWISE, ANY

DUSTIN HETRICK AT NVISIONTEK, LLC, CELL:

PROJECT NAME

UNION HILL AT 1308 N

26TH STREET

CLIENT(S)

CENTER CREEK HOMES

RICHMOND, VA, 23219

T: 804.999.4449

11 S 12TH STREET, SUITE

PROJECT ADDRESS

1308 N 26TH STREET

RICHMOND, VA 23223

TITLE

DETAILS

DOCUMENT PHASE:

PERMIT SET

PLOT DATE:

11/1/2021

9:57:08 AM

DRAWN BY:

DUSTIN HETRICK

SHEET

14 OF 17

SCALE: SEE PLAN

IF THE GENERAL CONTRACTOR OR ARCHITECT IS SHOWN ON THE COVER

QUESTIONS CONCERNING THESE DOCUMENTS SHALL BE DIRECTED TO

DHETRICK@NVISIONTEKBIM.COM.

(804) 372-0991, EMAIL:

DESCRIPTION

DATE

				DOOR	SCHEDULE - ALL LEVELS & E	ROTH LINITS	
UMBER	LABEL	QTY	WIDTH	HEIGHT	DESCRIPTION	MANUFACTURER	COMMENTS
D01	3068 L EX	1	36 "	80 "	EXT. 1/2 LITE HINGED ENTRY DOOR	TBD	
D02	3068 R EX	1	36 "	80 "	EXT. 1/2 LITE HINGED ENTRY DOOR	TBD	
D03	3014 EX	2	36 "	16 "	EXT. FIXED GLASS TBD AB		ABOVE ENTRY DOOR
D04	6068 C-L EX	2	72 "	80 "	EXT. DOUBLE HINGED- GLASS PANEL	TBD	
D05	6068 L EX	1	72 "	80 "	EXT. SLIDER-GLASS PANEL	TBD	
D06	6068 R EX	1	72 "	80 "	EXT. SLIDER-GLASS PANEL	TBD	
D07	2068 L IN	1	24 "	80 "	INT. HINGED DOOR	TBD	NOTE: BUILDER TO CREATE FAUX OVERLAP AT STAIRS SO DOOR TOP DOES NOT PROTRUDE THROUGH WALL
D08	2068 R IN	1	24 "	80 "	INT. HINGED DOOR	TBD	NOTE: BUILDER TO CREATE FAUX OVERLAP AT STAIRS SO DOOR TOP DOES NOT PROTRUDE THROUGH WALL
D09	2068 R IN	2	24 "	80 "	INT. HINGED DOOR	TBD	
D10	2068 L IN	2	24 "	80 "	INT. HINGED DOOR	TBD	
D11	2468 L IN	5	28 "	80 "	INT. HINGED DOOR	TBD	
D12	2468 R IN	5	28 "	80 "	INT. HINGED DOOR	TBD	
D13	2668 L IN	5	30 "	80 "	INT. HINGED DOOR	TBD	
D14	2668 R IN	5	30 "	80 "	INT. HINGED DOOR	TBD	
D15	2868 L IN	1	32 "	80 "	INT. HINGED DOOR	TBD	
D16	2868 R IN	1	32 "	80 "	INT. HINGED DOOR	TBD	
D17	3068 L/R IN	4	36 "	80 "	INT. HINGED FRENCH DOOR	TBD	
D18	4068 L/R IN	2	48 "	80 "	INT. HINGED FRENCH DOOR	TBD	

							1111111111	SCHEDULE - ALL LEVELS &	T CONTRACTOR		DIVIDED		ı
IMBER	LABEL	QTY	FLOOR	WIDTH	HEIGHT	TOP	воттом	DESCRIPTION	EGRESS	TEMPERED	LITES	MANUFACTURER	COMMENTS
)2	2836DH	2	1	32 "	42 "	88"	46"	1100 SERIES DOUBLE HUNG WINDOW			1/1	PLY-GEM	
)5	2860DH	8	1	32 "	72 "	88"	16"	1100 SERIES DOUBLE HUNG WINDOW			1/1		
)6	2860DH	3	1	32 "	72 "	88"	16"	1100 SERIES DOUBLE HUNG WINDOW			1/1	PLY-GEM	
)7	2860SH	1	1	32 "	72 "	88"	16"	1100 SERIES SINGLE HUNG WINDOW			1/1	PLY-GEM	
)8	3060DH	2	1	36 "	72 "	88"	16"	1100 SERIES DOUBLE HUNG WINDOW			1/1	PLY-GEM	
)9	3056DH	4	2	36 "	66 "	92"	26"	1100 SERIES DOUBLE HUNG WINDOW	YES		1/1	PLY-GEM	
10	3056DH	4	2	36 "	66 "	92"	26"	1100 SERIES DOUBLE HUNG WINDOW	YES		1/1	PLY-GEM	
11	3056DH	2	3	36 "	66 "	79 3/4"	13 3/4"	1100 SERIES DOUBLE HUNG WINDOW	YES		1/1	PLY-GEM	
12	3056DH	2	3	36 "	66 "	80"	14"	1100 SERIES DOUBLE HUNG WINDOW	YES		1/1	PLY-GEM	
13	2836DH	2	3	32 "	42 "	80"	38"	1100 SERIES DOUBLE HUNG WINDOW		YES	1/1	PLY-GEM	
14	2856DH	2	2	32 "	66 "	92"	26"	1100 SERIES DOUBLE HUNG WINDOW			1/1	PLY-GEM	
15	2836FX	2	2	32 "	42 "	92"	50"	1100 SERIES FIXED GLASS WINDOW			1	PLY-GEM	
16	2020FX	6	3	24 "	24 "	80"	56"	1100 SERIES FIXED GLASS WINDOW			1	PLY-GEM	

NUMBER	ROOM NAME	FLOOR	INTERIOR (SQ FT)	DIMENSIONS	CEILING ROUGH HEIGHT	CEILING FINISH HEIGHT	FLOOR FINISH	CEILING FINISH	WALL MATERIAL
R01	PORCH	1	73	12'-4" X 5'-11"	108 1/4"	108"	5/4X6 P.T. DECKING BOARDS WITH STAIN	1/4" BEADBOARD CEILING, STYLE & COLOR TBD	FIBER SIDING WHITE
R02	DECK	1	23	8'-0" X 2'-11"	N/A	N/A	5/4X6 P.T. DECKING BOARDS	NATURAL BEADBOARD, COLOR - BRITE	FIBER SIDING WHITE
R03	CLOSET	1	7	1'-11" X 3'-9"	109 1/4"	108"	3/4" HARDWOOD FLOORING, STYLE TBD	" HARDWOOD FLOORING, STYLE TBD 1/2" DRYWALL W/PAINT, COLOR TBD	
R04	DINING ROOM	1	177	13'-4" X 13'-3"	109 1/4"	108"	3/4" HARDWOOD FLOORING, STYLE TBD	1/2" DRYWALL W/PAINT, COLOR TBD	1/2" DRYWALL W/PAINT, COLOR TBD, 5/8" FIRE-RATED DRYWALL W/PAINT, COLOR TBD
R05	POWDER	1	24	4'-11" X 6'-10"	109 1/4"	96"	3/4" TILE FLOORING, STYLE TBD	AIR AREA, CEILING JOISTS, 1/ 2" DRYWALL W/PAINT, COLOR TBD	1/2" DRYWALL W/PAINT, COLOR TBD, 5/8" FIRE-RATED DRYWALL W/PAINT, COLOR TBD
R06	HALL	1	49	4'-5" X 10'-10"	109 1/4"	96"	3/4" HARDWOOD FLOORING, STYLE TBD	AIR AREA, CEILING JOISTS, 1/ 2" DRYWALL W/PAINT, COLOR TBD	1/2" DRYWALL W/PAINT, COLOR TBD
R07	UTILITY	1	5	2'-8" X 2'-0"	109 1/4"	108"	3/4" TILE FLOORING, STYLE TBD	1/2" DRYWALL W/PAINT, COLOR TBD	1/2" DRYWALL W/PAINT, COLOR TBD, 5/8" FIRE-RATED DRYWALL W/PAINT, COLOR TBD
₹08	MECHANICAL	1	7	1'-11" X 3'-6"	109 1/4"	108"	3/4" TILE FLOORING, STYLE TBD	1/2" DRYWALL W/PAINT, COLOR TBD	1/2" DRYWALL W/PAINT, COLOR TBD
₹09	KITCHEN	1	209	13'-2" X 16'-5"	109 1/4", 119 1/4"	108", 118"	3/4" HARDWOOD FLOORING, STYLE TBD	1/2" DRYWALL W/PAINT, COLOR TBD	1/2" DRYWALL W/PAINT, COLOR TBD, 5/8" FIRE-RATED DRYWALL W/PAINT, COLOR TBD
R10	PANTRY	1	8	3'-1" X 2'-8"	119 1/4"	118"	3/4" HARDWOOD FLOORING, STYLE TBD	1/2" DRYWALL W/PAINT, COLOR TBD	1/2" DRYWALL W/PAINT, COLOR TBD
R11	LIVING ROOM	1	248	13'-4" X 18'-7"	109 1/4"	108"	3/4" HARDWOOD FLOORING, STYLE TBD	1/2" DRYWALL W/PAINT, COLOR TBD	1/2" DRYWALL W/PAINT, COLOR TBD, 5/8" FIRE-RATED DRYWALL W/PAINT, COLOR TBD
R12	HALL	2	10	3'-3" X 3'-0"	109 1/4", 126"	108", 124 3/4"	3/4" HARDWOOD FLOORING, STYLE TBD	1/2" DRYWALL W/PAINT, COLOR TBD	1/2" DRYWALL W/PAINT, COLOR TBD
₹13	BATH	2	46	5'-11" X 8'-2"	109 1/4"	108"	3/4" TILE FLOORING, STYLE TBD	1/2" DRYWALL W/PAINT, COLOR TBD	1/2" DRYWALL W/PAINT, COLOR TBD, 5/8" FIRE-RATED DRYWALL W/PAINT, COLOR TBD
R14	CLOSET	2	12	5'-11" X 2'-0"	109 1/4"	108"	3/4" HARDWOOD FLOORING, STYLE TBD	1/2" DRYWALL W/PAINT, COLOR TBD	1/2" DRYWALL W/PAINT, COLOR TBD, 5/8" FIRE-RATED DRYWALL W/PAINT, COLOR TBD
R15	CLOSET	2	9	3'-3" X 2'-9"	109 1/4"	108"	3/4" HARDWOOD FLOORING, STYLE TBD	1/2" DRYWALL W/PAINT, COLOR TBD	1/2" DRYWALL W/PAINT, COLOR TBD
R16	BEDROOM 2	2	157	13'-4" X 14'-1"	109 1/4"	108"	3/4" HARDWOOD FLOORING, STYLE TBD	1/2" DRYWALL W/PAINT, COLOR TBD	1/2" DRYWALL W/PAINT, COLOR TBD, 5/8" FIRE-RATED DRYWALL W/PAINT, COLOR TBD
R17	HALL	2	75	3'-5" X 20'-11"	109 1/4"	96"	3/4" HARDWOOD FLOORING, STYLE TBD	TBD	1/2" DRYWALL W/PAINT, COLOR TBD
₹18	W.I.C.	2	49	4'-4" X 11'-10"	109 1/4"	108"	3/4" HARDWOOD FLOORING, STYLE TBD	1/2" DRYWALL W/PAINT, COLOR TBD	1/2" DRYWALL W/PAINT, COLOR TBD
R19	LANDING	2	12	3'-5" X 3'-7"	101 13/16"	100 9/16"	3/4" HARDWOOD FLOORING, STYLE TBD	1/2" DRYWALL W/PAINT, COLOR TBD	1/2" DRYWALL W/PAINT, COLOR TBD
R20	LAUNDRY	2	10	3'-3" X 3'-2"	109 1/4"	108"	3/4" TILE FLOORING, STYLE TBD	1/2" DRYWALL W/PAINT, COLOR TBD	1/2" DRYWALL W/PAINT, COLOR TBD
R21	OPEN BELOW	2	28	3'-1" X 9'-2"	245 1/4"	244"	3/4" HARDWOOD FLOORING, STYLE TBD	1/2" DRYWALL W/PAINT, COLOR TBD	1/2" DRYWALL W/PAINT, COLOR TBD
R22	OWNER BATH	2	65	5'-0" X 13'-7"	109 1/4"	108"	3/4" TILE FLOORING, STYLE TBD	1/2" DRYWALL W/PAINT, COLOR TBD	1/2" DRYWALL W/PAINT, COLOR TBD, 5/8" FIRE-RATED DRYWALL W/PAINT, COLOR TBD
R23	OWNER BEDROOM	2	214	13'-4" X 24'-1"	109 1/4"	108"	3/4" HARDWOOD FLOORING, STYLE TBD	1/2" DRYWALL W/PAINT, COLOR TBD	1/2" DRYWALL W/PAINT, COLOR TBD, 5/8" FIRE-RATED DRYWALL W/PAINT, COLOR TBD
₹24	STUDY	2	52	5'-11" X 9'-8"	109 1/4"	108"	3/4" HARDWOOD FLOORING, STYLE TBD	1/2" DRYWALL W/PAINT, COLOR TBD	1/2" DRYWALL W/PAINT, COLOR TBD, 5/8" FIRE-RATED DRYWALL W/PAINT, COLOR TBD
R25	BEDROOM 3	3	107	9'-9" X 11'-0"	97 1/4"	96"	3/4" HARDWOOD FLOORING, STYLE TBD	1/2" DRYWALL W/PAINT, COLOR TBD	1/2" DRYWALL W/PAINT, COLOR TBD, 5/8" FIRE-RATED DRYWALL W/PAINT, COLOR TBD
R26	CLOSET	3	11	3'-3" X 3'-5"	97 1/4"	96"	3/4" HARDWOOD FLOORING, STYLE TBD	1/2" DRYWALL W/PAINT, COLOR TBD	1/2" DRYWALL W/PAINT, COLOR TBD
R27	LINEN	3	5	2'-0" X 2'-6"	97 1/4"	96"	3/4" HARDWOOD FLOORING, STYLE TBD	1/2" DRYWALL W/PAINT, COLOR TBD	1/2" DRYWALL W/PAINT, COLOR TBD
R28	LOFT	3	258	13'-2" X 16'-6"	97 1/4"	96"	3/4" HARDWOOD FLOORING, STYLE TBD	1/2" DRYWALL W/PAINT, COLOR TBD	1/2" DRYWALL W/PAINT, COLOR TBD, 5/8' FIRE-RATED DRYWALL W/PAINT, COLOR TBD
R29	OPEN BELOW	3	33	3'-1" X 10'-9"	223 1/4"	222"	3/4" HARDWOOD FLOORING, STYLE TBD	1/2" DRYWALL W/PAINT, COLOR TBD	1/2" DRYWALL W/PAINT, COLOR TBD
₹30	STORAGE	3	41	6'-3" X 7'-7"	97 1/4"	96"	3/4" HARDWOOD FLOORING, STYLE TBD	1/2" DRYWALL W/PAINT, COLOR TBD	1/2" DRYWALL W/PAINT, COLOR TBD, 5/8" FIRE-RATED DRYWALL W/PAINT, COLOR TBD
R31	OPEN BALCONY	3	119	13'-3" X 9'-0"	N/A	N/A	DURADECK EPDM MEMBRANE, PLYWOOD HORIZONTAL, INSULATION RIGID		CEMENT PANEL - WHITE, FIBER SIDING WHITE
TOTALS:			2143						

GENERAL WINDOW & DOOR NOTES 1. BEDROOM WINDOW SILL FINISHED HEIGHT MUST BE NO MORE THAN 44" A.F.F AND

- 1. BEDROOM WINDOW SILL FINISHED HEIGHT MUST BE NO MORE THAN 44" A.F.F AND MUST PROVIDE MINIMUM EGRESS OPENINGS OF 5.7 SF WITH HEIGHT DIMENSION NOT LESS THAN 24" AND WIDTH DIMENSION NOT LESS THAN 20". REFERENCE R310.1-R310.4.
- 2. VERIFY WINDOW ROUGH OPENINGS WITH MANUFACTURER.
- 3. OWNER AND/OR CONTRACTOR TO SELECT EXACT CLADDING AND INTERIOR CASING STYLE AND FINISHES, AND HARDWARE.
- 4. DOORS BETWEEN GARAGE AND LIVING AREA SHALL BE 1-3/4" THICK TIGHT FITTING SOLID CORE WITH A 60-MINUTE MIN. FIRE RATING. DOOR SHALL BE SELF-CLOSING.
- 5. EXTERIOR EXIT DOORS SHALL BE 36" MIN., NET CLEAR OPENING SHALL BE 32" MIN.. DOOR SHALL BE OPERABLE FROM INSIDE.
- 6. ANY GARAGE DOOR GLAZING SHALL BE TEMPERED.
- 7. ALL GLAZING WITHIN 18" OF THE FLOOR AND/OR WITHIN 24" OF ANY DOOR (REGARDLESS OF WALL PLANE) ARE TO HAVE SAFETY GLAZING.
- 8. ALL TUB AND SHOWER ENCLOSURES ARE TO BE GLAZED WITH SAFETY GLAZING.
- 9. DOOR AND WINDOW SIZES AND DIMENSIONS TO BE VERIFIED BY CONTRACTOR AND DOOR/WINDOW SALES REPRESENTATIVE PRIOR TO ORDERING AND INSTALLING.
- 10. THE "LABEL" COLUMN OF THE WINDOW SCHEDULE INDICATES THE SIZE AND TYPE IN THE FOLLOWING FORMAT: "WIDTH/HEIGHT/TYPE" = FEET-INCH WIDTH/FEET-INCH HEIGHT/WINDOW TYPE.FOR EXAMPLE, A WINDOW LABEL OF 2840DH IS A 2'-8" WIDE x 4'-0" TALL DOUBLE HUNG WINDOW.

THE FOLLOWING WINDOW TYPES INDICATE THE FOLLOWING: "AW" = SINGLE-AWNING, "FA" = DOUBLE-AWNING, "TA" = TRIPLE-AWNING, "SH" = SINGLE-HUNG, "DH" = DOUBLE-HUNG, "SC" = SINGLE-CASEMENT, "DC" = DOUBLE-CASEMENT, "TC" = TRIPLE CASEMENT, "FX" = FIXED, "LS" = LEFT SLIDING, "RS" = RIGHT SLIDING, "TS" = TRIPLE SLIDING, "HO" = SINGLE-HOPPER, "FH" = DOUBLE-HOPPER, "TH" = TRIPLE HOPPER, "LV" = SINGLE-LOUVER, "GL" = GLASS LOUVER, "PT" = PASS-THROUGH.

11. THE "LABEL" COLUMN OF THE DOOR SCHEDULE INDICATES THE FOLLOWING:
"WIDTH/HEIGHT/HINGE SIDE/INTERIOR OR EXTERIOR" = FEET-INCH WIDTH/FEETINCH HEIGHT, "L" = LEFT SWING, "R" = RIGHT SWING, "IN" = INTERIOR DOOR, "EX" =
EXTERIOR DOOR. FOR EXAMPLE, A DOOR SIZE OF 2868 IS 2'-8" WIDE AND 6'-8"
TALL.



NVISIONTEKBIM.COM INFO@NVISIONTEKBIM.COM CELL: 804.372.0991 RICHMOND, VA 23236

REVISIONS

DATE DESCRIPTION

BUILDER NOTICE

IT IS THE INTENT OF THE DESIGNER / DRAFTER LISTED IN THE TITLE BLOCK OF THESE DOCUMENTS THAT THESE DOCUMENTS ARE ACCURATE, PROVIDING LICENSED PROFESSIONALS CLEAR INFORMATION. EVERY ATTEMPT HAS BEEN MADE TO PREVENT ERROR. THE BUILDER AND SUBCONTRACTORS ARE REQUIRED TO REVIEW ALL THE INFORMATION CONTAINED IN THESE DOCUMENTS, PRIOR TO COMMENCEMENT OF ANY WORK. NVISIONTEK IS NOT RESPONSIBLE FOR ANY PLAN ERRORS, OMISSIONS, OR MISINTERPRETATIONS UNDETECTED AND NOT REPORTED WITHIN 3 DAYS AFTER FINAL SUBMISSION OF DRAWINGS.

VERIFY ALL STRUCTURAL ITEMS ON PLANS WITH LICENSED STRUCTURAL ENGINEER

IF THE GENERAL CONTRACTOR OR
ARCHITECT IS SHOWN ON THE COVER
SHEET, PLEASE USE THEM AS YOUR FIRST
POINT OF CONTACT BEFORE CONTACTING
NVISIONTEK, LLC. OTHERWISE, ANY
QUESTIONS CONCERNING THESE
DOCUMENTS SHALL BE DIRECTED TO
DUSTIN HETRICK AT NVISIONTEK, LLC, CELL:
(804) 372-0991, EMAIL:
DHETRICK@NVISIONTEKBIM.COM.

PROJECT NAME

UNION HILL AT 1308 N 26TH STREET

CLIENT(S)

CENTER CREEK HOMES
11 S 12TH STREET, SUITE

RICHMOND, VA, 23219 T: 804.999.4449

PROJECT ADDRESS

1308 N 26TH STREET RICHMOND, VA 23223

TITLE

WINDOW, DOOR, & ROOM FINISH SCHEDULES

DOCUMENT PHASE: PERMIT SET

PLOT DATE:

11/1/2021 9:57:08 AM

DRAWN BY:DUSTIN HETRICK

SCALE: SEE PLAN

SHEET

A5.2

BXUV.U336 - Fire-resistance Ratings - ANSI/UL 263

 $\underbrace{0}_{\underline{1}}$

Design/System/Construction/Assembly Usage Disclaimer

- Authorities Having Jurisdiction should be consulted in all cases as to the particular requirements covering the installation and use of UL
- Certified products, equipment, system, devices, and materials.
- Authorities Having Jurisdiction should be consulted before construction.
- Fire resistance assemblies and products are developed by the design submitter and have been investigated by UL for compliance with
- applicable requirements. The published information cannot always address every construction nuance encountered in the field.
 When field issues arise, it is recommended the first contact for assistance be the technical service staff provided by the product manufacturer noted for the design. Users of fire resistance assemblies are advised to consult the general Guide Information for each product category and each group of assemblies. The Guide Information includes specifics concerning alternate materials and alternate methods of construction.
- Only products which bear UL's Mark are considered Certified.

BXUV - Fire Resistance Ratings - ANSI/UL 263 Certified for United States BXUV7 - Fire Resistance Ratings - CAN/ULC-S101 Certified for Canada

<u>See General Information for Fire-resistance Ratings - ANSI/UL 263 Certified for United States</u>
<u>Design Criteria and Allowable Variances</u>

<u>See General Information for Fire Resistance Ratings - CAN/ULC-S101 Certified for Canada Design Criteria and Allowable Variances</u>

Design No. U336


December 03, 2020


Exposed to fire from separation Wall side only

Nonbearing Wall Rating — 2 Hr (Separation Wall, See Items 1, 2 and 3)
Bearing Wall Rating - 2 Hr (Protected Wall, See Items 4 and 4A)

Nonbearing Wall Rating - 2 Hr (Protected Wall, See Item 4B)
Finish Rating — 120 Min

* Indicates such products shall bear the UL or cUL Certification Mark for jurisdictions employing the UL or cUL Certification (such as Canada), respectively.

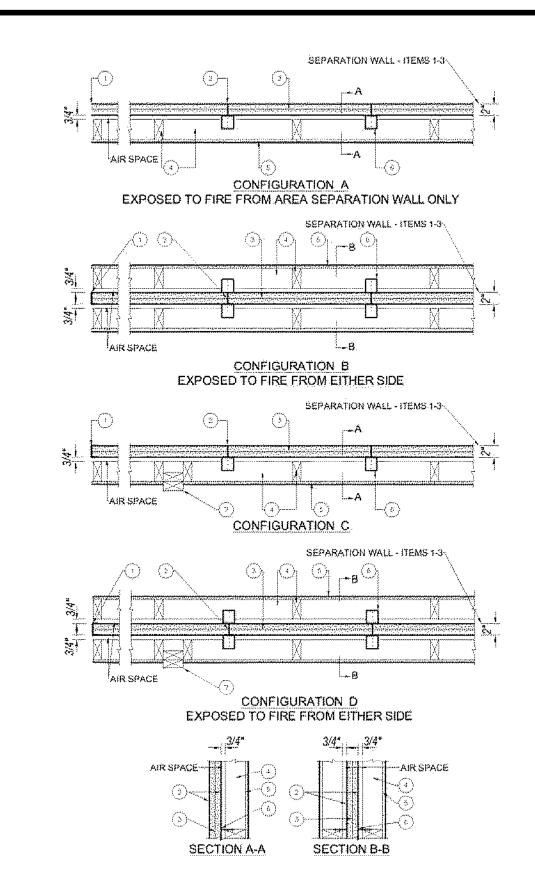

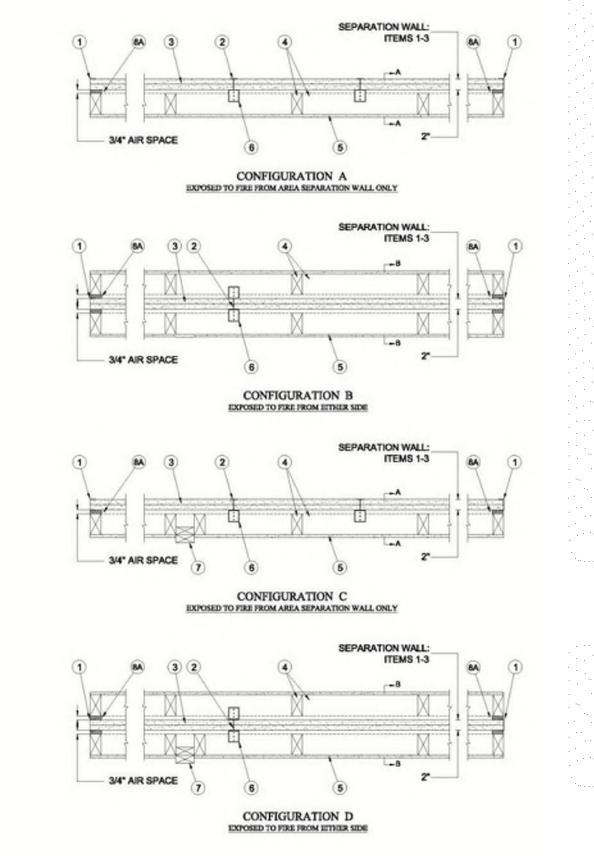

3/4* AIR SPACE SECTION A-A SECTION B-B

SEPARATION WALL: (Max Height - 66 ft)

1. Floor, Intermediate or Top Wall — 2 in. wide channel shaped with 1 in. long legs formed from No. 25 MSG gaiv steel, secured with suitable fasteners spaced 24 in. OC.

2. **Metal Studs** — Steel members formed from No. 25 MSG galv steel having "H" -shaped flanged spaced 24 in. OC; overall depth 2 in. and flange width 1-3/8 in.

3. **Gypsum Board*** — Two layers of 1 in. thick gypsum board liner panels, supplied in nom 24 in. widths. Vertical edges of panels friction fitted into "H" -shaped studs. **CGC INC** — Type SLX

UNITED STATES GYPSUM CO — Type SLX

USG BORAL DRYWALL SFZ LLC — Type SLX

USG MEXICO S A DE C V — Type SLX

PROTECTED WALL: (Bearing or Nonbearing Wall). When Bearing, Load Restricted for Canadian Applications — See Guide <u>BXUV7</u>.

4. **Wood Studs** — Nom 2 by 4 in, max spacing 24 in. OC. Studs cross braced at mid-height where necessary for clip attachment. Min 3/4 in. separation between wood framing and fire separation wall.

4A. **Steel Studs** — (As an alternate to Item 4, Not Shown) — For Bearing Wall Rating - Corrosion protected steel studs, min No. 20 MSG (0.0329 in., min bare metal thickness) steel or min 3-1/2 in. wide, min No. 20 GSG (0.036 in. thick) galv steel or No. 20 MSG (0.033 in. thick) primed steel, cold formed, shall be designed in accordance with the current edition of the Specification for the Design of Cold-Formed Steel Structural Members by the American Iron and Steel Institute. All design details enhancing the structural integrity of the wall assembly, including the axial design load of the studs, shall be as specified by the steel stud designer and/or producer, and shall meet the requirements of all applicable local code agencies. The max stud spacing of wall assemblies shall not exceed 24 in. OC. Studs attached to floor and ceiling tracks with 1/2 in. long Type S-12 steel screws on both sides of studs or by welded or bolted connections designed in accordance with the AISI specifications. Top and bottom tracks shall consist of steel members, min No. 20 MSG (0.0329 in., min bare metal thickness) steel or min No. 20 GSG (0.036 in. thick) galv steel or No. 20 MSG (0.033 in. thick) primed steel, that provide a sound structural connection between steel studs, and to adjacent assemblies such as a floor, ceiling, and/or other walls. Attached to floor and ceiling assemblies with steel fasteners spaced not greater than 24 in. O.C. Studs cross-braced with stud framing at midheight where necessary for clip attachment. Min 3/4 in. separation between steel framing and area separation wall. Finish rating has not been evaluated for Steel Studs.

4B **Steel Studs** — As an alternate to Items 4 and 4A, for use in Configuration B only, Not Shown) — For Nonbearing Wall Rating - Channel shaped, fabricated from min 25 MSG corrosion-protected steel, min 3-1/2 in. wide, min 1-1/4 in. flanges and 1/4 in. return, spaced a max of 24 in. OC. Studs to be cut 3/8 to 3/4 in. less than assembly height. Top and bottom tracks shall be channel shaped, fabricated from min 25 MSG corrosion-protected steel, min width to accommodate stud size, with min 1 in. long legs, attached to floor and ceiling with fasteners 24 in. OC max. Studs cross-braced with stud framing at midheight where necessary for clip attachment. Min 3/4 in. separation between steel framing and area separation wall. Finish rating has not been evaluated for Steel Studs.

5. **Gypsum Board** — Classified or Unclassified — Min 1/2 in. thick, 4 ft wide, applied either horizontally or vertically. Gypsum board attached to studs with 1-1/4 in. long steel drywall nails spaced 8 in. OC. Vertical joints located over studs. (Optional) Joints covered with paper tape and joint compound. Nail heads covered with joint compound.

6. **Attachment Clips** — Aluminum angle, 0.063 in. thick, 2 in. wide with 2 in. and 2-1/4 in. legs. Clips secured with Type S screws 3/8 in. long to "H" studs and with Type W screws 1-1/4 in. long to wood framing through holes provided in clip.

6A. Clip placement (Item 6) for separation walls up to 23 ft high. Space clips a max of 10 ft OC vertically between wood framing and "H"

6B. Clip placement (Item 6) for separation walls up to 44 ft high. Space clips as described in Item 6A for upper 24 ft. Remaining wall area below requires clips spaced a max 5 ft OC vertically between wood framing and "H" studs.

6C. Clip placement (Item 6) for separation walls up to 66 ft high: Space clips as described in Item 6A for upper 24 ft. Space clips as described in item 6B for next 20 ft. below the upper 24 ft. Remaining wall area below requires clips spaced a max of 40 in. OC vertically between wood framing and "H" studs

7. **Non-Bearing Wall Partition Intersection** — (Optional) — Two nominal 2 by 4 in. stud or nominal 2 by 6 in. stud nailed together with two 3in. long 10d nails spaced a max. 16 in. OC. vertically and fastened to one side of the minimum 2 by 4 in. stud with 3 in. long 10d nails spaced a max 16 in. OC. vertically. Intersection between partition wood studs to be flush with the 2 by 4 in. studs. The wall partition wood studs are to be framed with a second 2 by 4 in. wood stud fastened with 3 in. long 10d nails spaced a max. 16 in. OC. vertically. Maximum one non-bearing wall partition intersection per stud cavity, Non-bearing wall partition stud depth shall be at a minimum equal to the depth of the wall.

8. Caulking and Sealants* — (Optional – Intended for use as an air barrier – Not intended to be used as fireblocking) A bead of sealant applied around the partition perimeter, and at the interface between wood or steel framing and gypsum board panels to create an air barrier.

KNAUF INSULATION LLC — Type ECOSEAL^{IM} Plus

8A. Caulking and Sealants* — (Optional - Intended for use as an air barrier - Not intended to be used as fireblocking) - A bead of sealant applied around the partition perimeter in the 3/4 in. air space between wood framing (Item 4) and shaftliner panels (Item 3) to create an air barrier.

DUPONT DE NEMOURS, INC. — Great Stuff Gaps & Cracks, Great Stuff Pro Gaps & Cracks, Great Stuff Pro Window & Door

ICP ADHESIVES & SEALANTS INC — Handi-Foam Fireblock, Handi-Foam Fireblock West, and Fast Foam Fireblock

* Indicates such products shall bear the UL or cUL Certification Mark for jurisdictions employing the UL or cUL Certification (such as Canada), respectively.

Last Updated on 2020-12-03

The appearance of a company's name or product in this database does not in itself assure that products so identified have been manufactured under UL's Follow-Up Service. Only those products bearing the UL Mark should be considered to be Certified and covered under UL's Follow-Up Service. Always look for the Mark on the product

UL permits the reproduction of the material contained in the Online Certification Directory subject to the following conditions: 1. The Guide Information, Assemblies, Constructions, Designs, Systems, and/or Certifications (files) must be presented in their entirety and in a non-misleading manner, without any manipulation of the data (or drawings). 2. The statement "Reprinted from the Online Certifications Directory with permission from UL" must appear adjacent to the extracted material. In addition, the reprinted material must include a copyright notice in the following format: "© 2021 UL LLC"

NOTE: VERIFY ALL STRUCTURAL ITEMS ON PLANS WITH LICENSED STRUCTURAL ENGINEER.

nVisionTEK

NVISIONTEKBIM.COM INFO@NVISIONTEKBIM.COM CELL: 804.372.0991 RICHMOND, VA 23236

REVISIONS

DATE DESCRIPTION

BUILDER NOTICE

IT IS THE INTENT OF THE DESIGNER /
DRAFTER LISTED IN THE TITLE BLOCK OF
THESE DOCUMENTS THAT THESE
DOCUMENTS ARE ACCURATE, PROVIDING
LICENSED PROFESSIONALS CLEAR
INFORMATION. EVERY ATTEMPT HAS BEEN
MADE TO PREVENT ERROR. THE BUILDER
AND SUBCONTRACTORS ARE REQUIRED TO
REVIEW ALL THE INFORMATION CONTAINED
IN THESE DOCUMENTS, PRIOR TO
COMMENCEMENT OF ANY WORK.
NVISIONTEK IS NOT RESPONSIBLE FOR ANY
PLAN ERRORS, OMISSIONS, OR
MISINTERPRETATIONS UNDETECTED AND
NOT REPORTED WITHIN 3 DAYS AFTER FINAL

VERIFY ALL STRUCTURAL ITEMS ON PLANS WITH LICENSED STRUCTURAL ENGINEER

SUBMISSION OF DRAWINGS.

IF THE GENERAL CONTRACTOR OR
ARCHITECT IS SHOWN ON THE COVER
SHEET, PLEASE USE THEM AS YOUR FIRST
POINT OF CONTACT BEFORE CONTACTING
NVISIONTEK, LLC. OTHERWISE, ANY
QUESTIONS CONCERNING THESE
DOCUMENTS SHALL BE DIRECTED TO
DUSTIN HETRICK AT NVISIONTEK, LLC, CELL:
(804) 372-0991, EMAIL:
DHETRICK@NVISIONTEKBIM.COM.

PROJECT NAME

UNION HILL AT 1308 N 26TH STREET

CLIENT(S)

CENTER CREEK HOMES 11 S 12TH STREET, SUITE

RICHMOND, VA, 23219 T: 804.999.4449

PROJECT ADDRESS

1308 N 26TH STREET RICHMOND, VA 23223

TITLE

PARTY WALL UL336
ASSEMBLY
SPECIFICATIONS

DOCUMENT PHASE:

PERMIT SET

PLOT DA

PLOT DATE: 11/1/2021 9:57:13 AM

DRAWN BY:DUSTIN HETRICK


SCALE: SEE PLAN

SHEET

A5.3

16 OF 17

THE PAPER SIZE NEEDS TO BE 24" x 36" (ARCH D) TO SCALE PROPERLY

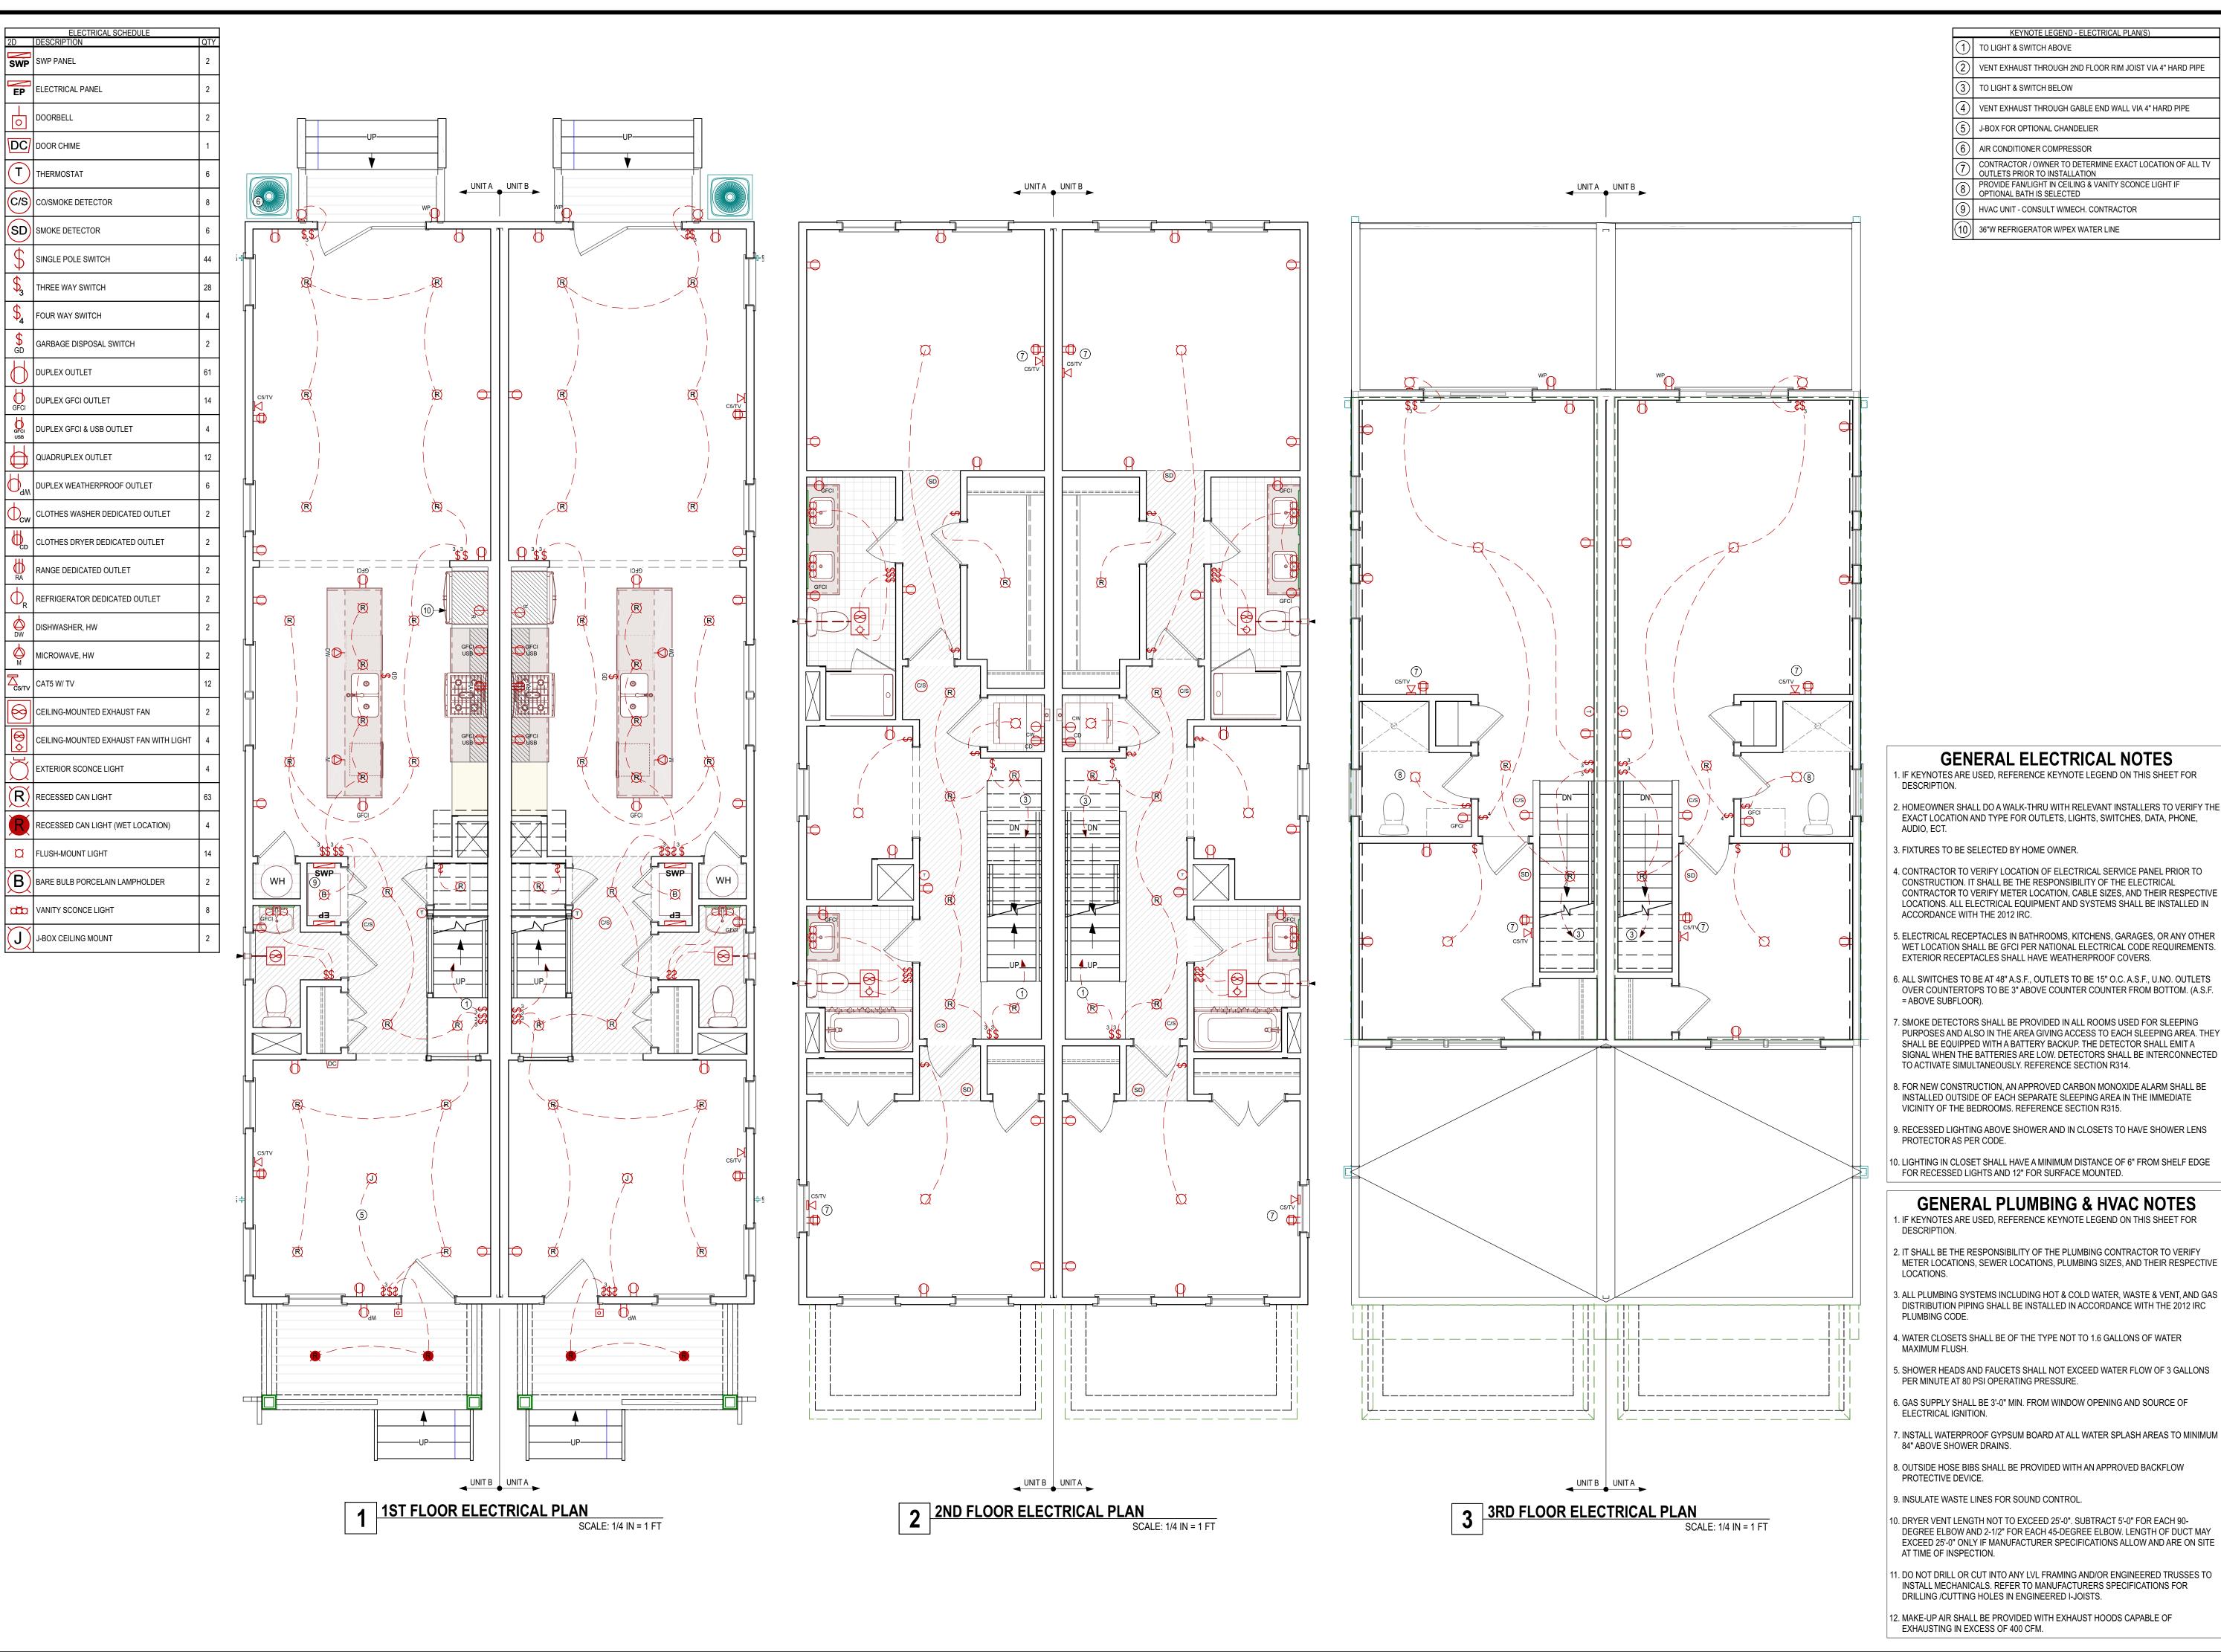

KEYNOTE LEGEND - ELECTRICAL PLAN(S)

TO LIGHT & SWITCH ABOVE

VENT EXHAUST THROUGH 2ND FLOOR RIM JOIST VIA 4" HARD PIPE

TO LIGHT & SWITCH BELOW

VENT EXHAUST THROUGH GABLE END WALL VIA 4" HARD PIPE

) J-BOX FOR OPTIONAL CHANDELIER

AIR CONDITIONER COMPRESSOR

CONTRACTOR / OWNER TO DETERMINE EXACT LOCATION OF ALL TV

OUTLETS PRIOR TO INSTALLATION PROVIDE FAN/LIGHT IN CEILING & VANITY SCONCE LIGHT IF OPTIONAL BATH IS SELECTED

HVAC UNIT - CONSULT W/MECH. CONTRACTOR

BIM SERVICES

NVISIONTEKBIM.COM INFO@NVISIONTEKBIM.COM CELL: 804.372.0991 RICHMOND, VA 23236

REVISIONS

DATE DESCRIPTION

BUILDER NOTICE

IT IS THE INTENT OF THE DESIGNER / DRAFTER LISTED IN THE TITLE BLOCK OF THESE DOCUMENTS THAT THESE DOCUMENTS ARE ACCURATE, PROVIDING LICENSED PROFESSIONALS CLEAR INFORMATION. EVERY ATTEMPT HAS BEEN MADE TO PREVENT ERROR. THE BUILDER AND SUBCONTRACTORS ARE REQUIRED TO REVIEW ALL THE INFORMATION CONTAINED IN THESE DOCUMENTS, PRIOR TO COMMENCEMENT OF ANY WORK. NVISIONTEK IS NOT RESPONSIBLE FOR ANY PLAN ERRORS, OMISSIONS, OR MISINTERPRETATIONS UNDETECTED AND

VERIFY ALL STRUCTURAL ITEMS ON PLANS WITH LICENSED STRUCTURAL ENGINEER

NOT REPORTED WITHIN 3 DAYS AFTER FINAL

SUBMISSION OF DRAWINGS.

IF THE GENERAL CONTRACTOR OR ARCHITECT IS SHOWN ON THE COVER SHEET, PLEASE USE THEM AS YOUR FIRST POINT OF CONTACT BEFORE CONTACTING *NVISIONTEK, LLC.* OTHERWISE, ANY QUESTIONS CONCERNING THESE DOCUMENTS SHALL BE DIRECTED TO DUSTIN HETRICK AT NVISIONTEK, LLC, CELL: (804) 372-0991, EMAIL: DHETRICK@NVISIONTEKBIM.COM.

PROJECT NAME

UNION HILL AT 1308 N **26TH STREET**

T: 804.999.4449

OVER COUNTERTOPS TO BE 3" ABOVE COUNTER COUNTER FROM BOTTOM. (A.S.F.

. SMOKE DETECTORS SHALL BE PROVIDED IN ALL ROOMS USED FOR SLEEPING PURPOSES AND ALSO IN THE AREA GIVING ACCESS TO EACH SLEEPING AREA. THEY SHALL BE EQUIPPED WITH A BATTERY BACKUP. THE DETECTOR SHALL EMIT A SIGNAL WHEN THE BATTERIES ARE LOW. DETECTORS SHALL BE INTERCONNECTED TO ACTIVATE SIMULTANEOUSLY. REFERENCE SECTION R314.

8. FOR NEW CONSTRUCTION, AN APPROVED CARBON MONOXIDE ALARM SHALL BE INSTALLED OUTSIDE OF EACH SEPARATE SLEEPING AREA IN THE IMMEDIATE VICINITY OF THE BEDROOMS. REFERENCE SECTION R315.

9. RECESSED LIGHTING ABOVE SHOWER AND IN CLOSETS TO HAVE SHOWER LENS PROTECTOR AS PER CODE.

10. LIGHTING IN CLOSET SHALL HAVE A MINIMUM DISTANCE OF 6" FROM SHELF EDGE FOR RECESSED LIGHTS AND 12" FOR SURFACE MOUNTED.

GENERAL PLUMBING & HVAC NOTES . IF KEYNOTES ARE USED, REFERENCE KEYNOTE LEGEND ON THIS SHEET FOR

2. IT SHALL BE THE RESPONSIBILITY OF THE PLUMBING CONTRACTOR TO VERIFY METER LOCATIONS, SEWER LOCATIONS, PLUMBING SIZES, AND THEIR RESPECTIVE

3. ALL PLUMBING SYSTEMS INCLUDING HOT & COLD WATER, WASTE & VENT, AND GAS DISTRIBUTION PIPING SHALL BE INSTALLED IN ACCORDANCE WITH THE 2012 IRC

4. WATER CLOSETS SHALL BE OF THE TYPE NOT TO 1.6 GALLONS OF WATER

5. SHOWER HEADS AND FAUCETS SHALL NOT EXCEED WATER FLOW OF 3 GALLONS PER MINUTE AT 80 PSI OPERATING PRESSURE.

6. GAS SUPPLY SHALL BE 3'-0" MIN. FROM WINDOW OPENING AND SOURCE OF

7. INSTALL WATERPROOF GYPSUM BOARD AT ALL WATER SPLASH AREAS TO MINIMUM 84" ABOVE SHOWER DRAINS.

8. OUTSIDE HOSE BIBS SHALL BE PROVIDED WITH AN APPROVED BACKFLOW PROTECTIVE DEVICE.

9. INSULATE WASTE LINES FOR SOUND CONTROL.

10. DRYER VENT LENGTH NOT TO EXCEED 25'-0". SUBTRACT 5'-0" FOR EACH 90-DEGREE ELBOW AND 2-1/2" FOR EACH 45-DEGREE ELBOW. LENGTH OF DUCT MAY EXCEED 25'-0" ONLY IF MANUFACTURER SPECIFICATIONS ALLOW AND ARE ON SITE AT TIME OF INSPECTION.

11. DO NOT DRILL OR CUT INTO ANY LVL FRAMING AND/OR ENGINEERED TRUSSES TO INSTALL MECHANICALS. REFER TO MANUFACTURERS SPECIFICATIONS FOR DRILLING /CUTTING HOLES IN ENGINEERED I-JOISTS.

12. MAKE-UP AIR SHALL BE PROVIDED WITH EXHAUST HOODS CAPABLE OF EXHAUSTING IN EXCESS OF 400 CFM.

CLIENT(S)

CENTER CREEK HOMES 11 S 12TH STREET, SUITE

RICHMOND, VA, 23219

PROJECT ADDRESS

1308 N 26TH STREET RICHMOND, VA 23223

ELECTRICAL PLANS

DOCUMENT PHASE:

PERMIT SET

PLOT DATE:

11/1/2021 9:57:14 AM

DRAWN BY: DUSTIN HETRICK


SCALE: SEE PLAN

SHEET

17 OF 17


NOTES: THIS PROPERTY IS LOCATED IN F.E.M.A. FLOOD ZONE "X". CURRENT OWNER: READY HOMES LLC ID 2021-20559

KYONG Y & MOON C KIM ID 2010-10973 TM# E00006200020

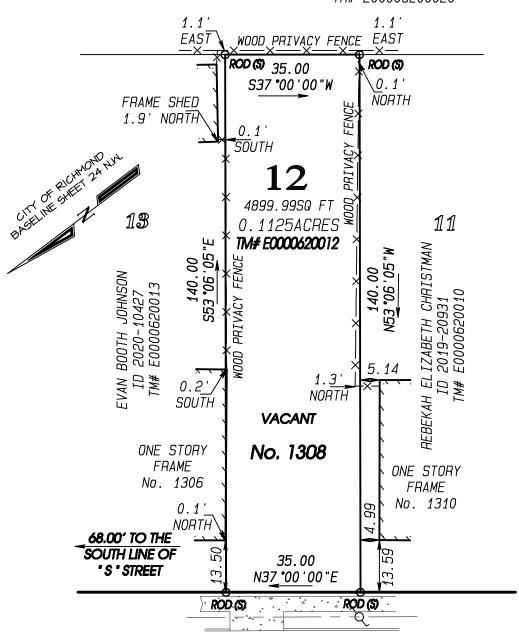

 $N. \quad 26^{TH} \quad STREET$

PLAT SHOWING IMPROVEMENTS ON LOT 12, SQUARE 37, "HECKLER'S PLAN", IN THE CITY OF RICHMOND, VIRGINIA.

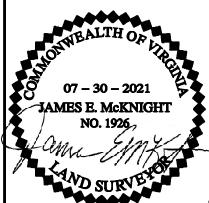

THIS IS TO CERTIFY THAT ON JULY 30, 2021, I MADE AN ACCURATE FIELD SURVEY OF THE PREMISES SHOWN HEREON; THAT THERE ARE NO ENCROACHMENTS BY IMPROVEMENTS EITHER FROM ADJOINING PREMISES OR FROM SUBJECT PREMISES UPON ADJOINING PREMISES, OTHER THAN AS SHOWN HEREON. THIS SURVEY IS BEING FURNISHED WITHOUT BENEFIT OF A TITLE REPORT. PREMISES SHOWN HEREON IS SUBJECT TO EASEMENTS OF RECORD OR OTHERWISE. TO THE BEST OF MY KNOWLEDGE AND BELIEF, THIS PLAT COMPLIES WITH THE MINIMUM STANDARDS ESTABLISHED BY THE VIRGINIA STATE BOARD OF ARCHITECTS, PROFESSIONAL ENGINEERS, AND LAND SURVEYORS.

SCALE: 1" = 25'



201 TWIN RIDGE LANE RICHMOND, VIRGINIA 23235 TELEPHONE (804) 320-2646

JOB NUMBER: 92063308