

# Commission for Architectural Review Application for Certificate of Appropriateness

900 E. Broad Street, Room 510 Richmond, VA 23219 | (804)-646-6569





Address:			
Historic District:			
Applicant Information Billing	g Contact	Owner Information	Billing Contact
Name:		Same as Applicant	
Email:		_ Name:	
Phone:		_ Email:	
Company:		Phone:	
Mailing Address:		Company:	
		Mailing Address:	
Applicant Type: Owner Agent	Lessee		
Architect Contractor			
Other (specify):		_ **Owner must sign at the	e bottom of this page**
Project Information			
Project Type: Alteration	Demolition	New Construction (Conce	eptual Review Required)
Project Description (attach additiona	al sheets if need	ded):	

# Acknowledgement of Responsibility

Compliance: If granted, you agree to comply with all conditions of the certificate of appropriateness (COA). Revisions to approved work require staff review and may require a new application and approval from the Commission of Architectural Review (CAR). Failure to comply with the conditions of the COA may result in project delays or legal action. The COA is valid for one (1) year and may be extended for an additional year, upon written request and payment of associated fee.

**Requirements:** A complete application includes all applicable information requested on checklists available on the CAR website to provide a complete and accurate description of existing and proposed conditions, as well as payments of the application fee. <u>Applications proposing major new construction, including additions, should meet with staff to review the application and requirements prior to submitting an application.</u> Owner contact information and signature is required. Late or incomplete applications will not be considered.

**Zoning Requirements:** Prior to Commission review, it is the <u>responsibility of the applicant</u> to determine if zoning approval is required an application materials should be prepared in compliance with zoning.

	Mosken	04/29/2022 <b>Date</b>
Signature of Owner _		Date

# Certificate of Appropriateness Application Instructions

In advance of the application deadline, please contact staff to discuss your project, application requirements, and if necessary, to make an appointment to meet with staff for a project consultation. The CAR website has additional project guidance and required checklists: <a href="https://www.rva.gov/planning-development-review/commission-architectural-review">www.rva.gov/planning-development-review/commission-architectural-review</a>

Staff Contact: (804)-646-6569 | alex.dandrige@rva.gov | alyson.oliver@rva.gov

#### Submission Instructions

Certain exterior work can be administratively approved by Staff. Please contact staff via email with the project address in the subject line. Submit the following items via email to staff:

- One (1) signed and completed application (PDF) property owner's signature required
- One (1) copy of supporting documentation, as indicated on appropriate checklist (PDF)
- Application fee, if required, will be invoiced via the City's Online Permit Portal. Payment of the fee must be received before the application will be scheduled. Please see fee schedule brochure available on the CAR website for additional information.
- Application deadlines are firm. All materials must be submitted by the deadline to be considered at the following Commission meeting. Designs must be final at the time of application; revisions will not be accepted after the deadline. Incomplete and/or late applications will not be placed on that month's agenda.
- A complete application includes a signed application form, related checklist, legible plans, drawings, elevations, material specifications, and payment of the required fee as described in Sec. 30-930.6(b).
- The Commission will not accept new materials, revisions, or redesigns at the meeting. Deferral until the following month's meeting may be necessary in such cases to allow for adequate review by staff, Commissioners, and public notice, if required.

## Meeting Schedule and Application Due Dates

- The CAR meets on the fourth Tuesday of each month, except for December when it meets on the third Tuesday.
- The hearing of applications starts at 4:00pm via Microsoft Teams. The owner and/or applicant is encouraged to attend the meeting.
- All applications are due at 12 noon the Friday after the monthly CAR meeting, except in December, when applications are due the following Monday. For a list of meeting dates and submission deadline dates for each meeting please visit <a href="https://www.rva.gov/planning-development-review/commission-architectural-review">www.rva.gov/planning-development-review/commission-architectural-review</a> or contact staff.
- Exception: Revisions to applications that have been deferred or conceptually reviewed at a CAR meeting can be submitted nine (9) business days after that meeting in order to be reviewed at the following meeting. Please contact staff to confirm this date.

#### Fees

- Full Demolition: \$1,500
- New construction/addition to a building other than for a single- or two-family dwelling or accessory building, including multi-family or mixed-use developments: \$500
- New construction/addition to a single- or two-family dwelling, or accessory building: \$250
- Amendments to previous certificates of appropriateness (COAs) concerning non-structural alterations, changes to signage, and changes to plans: \$150
- Extension of a certificate of appropriateness (COA): \$25



# **CERTIFICATE OF APPROPRIATENESS**

# ALTERATION AND ADDITION CHECKLIST

<u>Well in advance</u> of the COA application deadline contact staff to discuss your project, and if necessary, to make an appointment to meet with staff for a project consultation.

Complete all applicable sections and submit with the COA application form. Staff can assist you in determining what items are required for your scope of work. An incomplete application may cause delays in processing or may be deferred to the next agenda. Application materials <u>must</u> clearly represent current and proposed conditions. Refer to Standards for Rehabilitation outlined in Section 30.930.7(b) of the City Code, as well as, the *Richmond Old and Historic Districts Handbook and Design Review Guidelines*.

Text

PR	OPERTY ADDRESS: _		2317 M Street				
Вι	IILDING TYPE			AL	TERATIO	N T	YPE
X	single-family residence		garage		addition		<b>☆</b> roof
	multi-family residence		accessory structure	X	foundation		☐ awning or canopy
	commercial building		other	X	wall siding o	or cla	adding
	mixed use building			X	windows or	doo	rs 🔲 ramp or lift
	institutional building			X	porch or bal	lcon	y 🗆 other
WI	RITTEN DESCRIPTION						
×	property description, curren	t cor	nditions and any prior altera	atior	ns or addition	s	
×	proposed work: plans to cha	ange	any exterior features, and	or a	addition desc	ripti	on
X	current building material co	nditi	ons and originality of any m	nate	rials propose	d to	be repaired or replaced
X	proposed new material des	cript	ion: attach specification sh	eet	s if necessar	y	
PH	IOTOGRAPHS place on 8	3 ½ :	x 11 page, label photos wit	h de	escription and	d loc	cation (refer to photograph guidelines)
X	elevations of all sides						
	detail photos of exterior ele	men	ts subject to proposed wor	k			
X	historical photos as evidend	e fo	r restoration work				
DF	RAWINGS (refer to require	d dra	awing guidelines)				
X	current site plan	X	list of current windows and	d do	ors	X	current elevations (all sides)
X	proposed site plan	X	list of proposed window ar	nd d	oor	X	proposed elevations (all sides)
X	current floor plans		current roof plan				demolition plan
X	proposed floor plans		proposed roof plan				perspective and/or line of sight
X	legal "plat of survey"						

## Certificate of Appropriateness for 2317 M Street

## Property Description:

2317 M St. was built in 1853 by harness-maker William Salmon. It is a two-story, three-bay, frame house above a brick English basement. (This raised brick foundation has been parged and painted.)

The original house is Greek Revival with a hipped roof front porch that replaced a smaller porch, probably in the late '20s or early '30s.

Originally on the southeast corner was a two-story open porch, supported by brick piers at the basement level. Over the years, the space between the piers was enclosed with a variety of materials. The space thus created was partially incorporated into the house through existing doors.

Also enclosed at an unknown date was the first floor porch. The porch on the second floor is still open, although almost all of the original fabric has been lost. Another change to this porch system was the addition of a two-story set of wood stairs and landings to allow direct access to the second floor.

Other changes to the exterior include vinyl siding over the original clapboard on the first floor and vertical metal sheathing on the second floor. Windows on the front are original, with several "replacement" windows on the rear facade.

The applicant purchased the property at a tax auction in late 2021 at which time the house had been vacant for an indefinite period and was in serious disrepair, including significant structural rot that will require the removal of all siding materials to repair. The house never had central heat and the fireplaces had been abandoned in favor of stoves. but the two chimneys appear to be in relatively good repair above the roof line and will be retained.

#### Detailed scope of work:

#### 1.Main Roof

Replace the failed terne metal, standing seam roof with a standing seam steel roof. Retain and flash both existing chimneys, sealing the flues at the top.

The box gutter on the front facade will be rebuilt and returned to active use. New downspout(s) from it to be round 3" copper

There is no sign the rear facade ever had a built-in gutter so the existing aluminum gutter to be replaced with a 6" surface-mounted K style aluminum gutter with round 4' downspouts.

#### 2.Front Porch Roof

Replace failed flat lock terne metal with flat lock copper. Retain built-in gutter. New downspout(s) to be round 3" copper.

#### 3. Front Porch

Rebuild the existing front porch, retaining existing columns and pickets while replacing any failed elements with matching material. Replace the current decking with 1" tongue and groove material.

Replace failed brick steps with wood steps to match the original as seen in the attached photo. Add Richmond rail to these steps to code.

Repair existing brick porch piers with bricks and mortar to match existing.

#### 4. Side Porch (new)

Remove all existing exterior stairs and landings, which were later replacements. Build a new wooden side porch adjacent to the existing side door (# 102) with steps to the side alley. Richmond rail to code. See attached drawings.

5. Side Porch Roof over first floor door

Bracketed hood with copper roof. See attached photo.

## 6.Side Porches (original)

The house originally had side porches on the first and second floors. These porches were supported by brick piers at the basement level.

Basement level. At some point the area under the side porches was enclosed for a bathroom. The enclosure was done between the piers, variously in brick or wood. We propose removing all of the (largely failed) enclosing materials and re-enclosing with a new framing system. The original piers will be repaired or rebuilt with brick and mortar to match existing and the spaces between them parged and painted to match the rest of the existing foundation. This is on the sidewalk between the houses, and is not visible from the street.

First Floor. At some point the porch was enclosed for use as a kitchen. We propose rebuilding and re-enclosing it but in so doing making its origins as a porch clear with the use of pilasters, porch rails, and vertical elements. See attached drawing.

Second Floor. The porch is still open but at some point it became an outside entrance to the second floor. The decking was covered with roofing material and almost all of its original fabric is gone.

We propose rebuilding and enclosing this porch. In so doing we will make its origins as a porch clear with the use of pilasters, porch rails, and vertical elements See attached drawing.

#### 7.Siding

The second floor is clad in vertical metal strips of uncertain date while the first floor is clad in vinyl. We propose removing both claddings and any original clapboard underneath. Any salvageable clapboard will be re-installed, beginning with the front of the house. The remainder will be sided in matching wood clapboard. Applicants will file an exterior paint scheme at a later date, using the color palette of CAR.

## 8. Foundation/English Basement (exterior)

The original brick foundation has been parged and the parging painted. Masonry to be repaired as needed and repairs parged and painted to match the rest of the existing foundation.

#### 9.Doors (exterior)

Front door. Replace the later-added French door with a four-panel door, matching the existing door leading onto the side porch on the first floor, which has flat panels with applied molding on the outside. Original side lights will remain.

First Floor Side Door. Replace the door that was installed when this porch was enclosed with a new door with glass panels on the top. (**Pic of new door.**)

Basement Side door This will be a new door opening and will replace the (missing) door to the back yard. The same new door will be used as on the first floor. Note that neither of these doors are visible from the street.

#### 10.Windows


Front façade. Retain and repair all existing sash. Any required replacements shall match the original wooden sashes.

West facade There are no windows and none are proposed

East facade. The house originally had three windows, one in the rear room on each floor. On the second floor, we propose installing a window in the new outside wall (window 204). The wooden sash would match the rest of the sash on the first and second floors (6 over 6). This would be the only window in the east façade.

South façade. On the first floor replace the modern replacement window #103 with sash that matches the other windows on the first and second floors. At the basement level, replace the modern "replacement" window #004 with sash to match original windows on this level; add matching window at #005

11. HVAC units. There will be two units, one 30x30 and one 30x12. They will be located in the backyard at the SW corner of the house, 8" away from the house and 36" from the property line. The two units need to be 12" away from each other. Backyard is enclosed with a six foot wooden fence, and there is no alley.

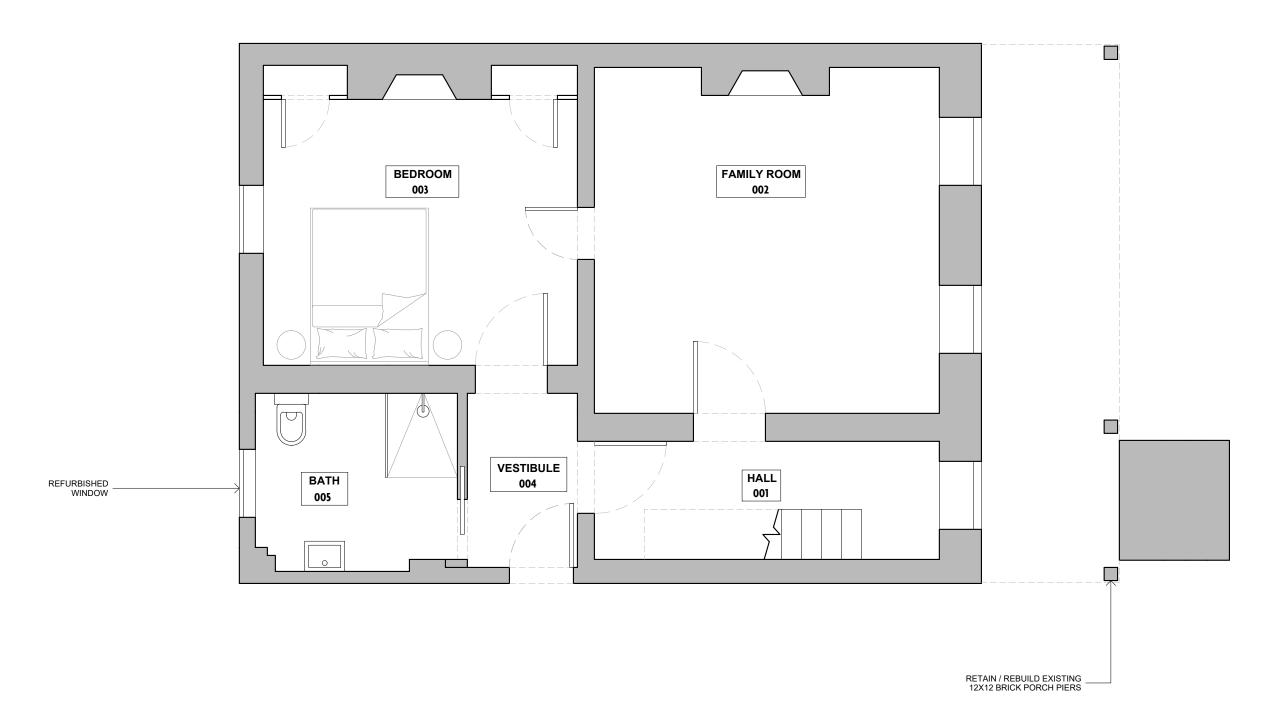

1. PROPOSED BASEMENT PLAN

.....1 5 10





2317 M Street Richmond, Virginia 23223

KEY PLAN:

REVISION:

NOTES:

6'-9" CEILING HEIGHT

PROJECT

2317 M STREET

DRAWING TITLE


PROPOSED BASEMENT PLAN

A110

PURPOSE OF ISSUE

PERMIT SET

SCALE DATE
1/4"=1'@11X17 23 MAR 2022

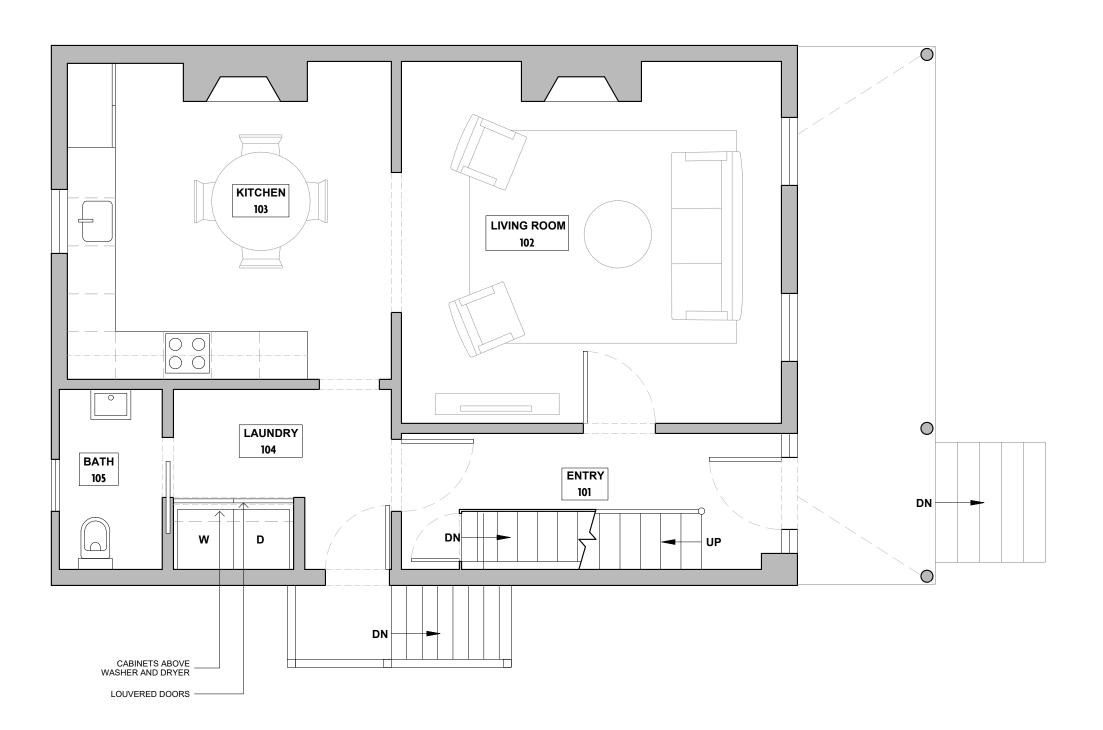

## 1. PROPOSED GROUND FLOOR PLAN

1 5 1





2317 M Street Richmond, Virginia 23223

KEY PLAN:

REVISION:

NOTES:

9'-1" CEILING HEIGHT

PROJECT

2317 M STREET

DRAWING TITLE


PROPOSED GROUND FLOOR PLAN

A111

PURPOSE OF ISSUE

PERMIT SET

SCALE DATE
1/4"=1' @ 11X17 23 MAR 2022

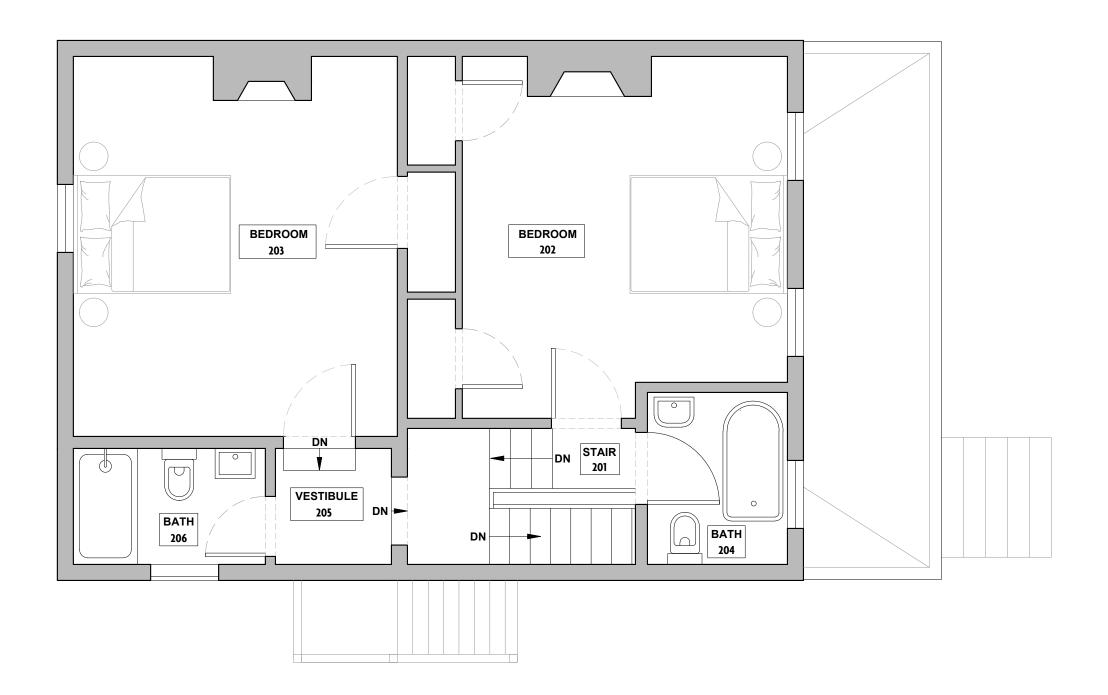

1. PROPOSED SECOND FLOOR PLAN

1 5





2317 M Street Richmond, Virginia 23223

KEY PLAN:

REVISION:

NOTES:

7'-6" CEILING HEIGHT

PROJECT

2317 M STREET

DRAWING TITLE

PROPOSED SECOND FLOOR PLAN

A112

PURPOSE OF ISSUE


PERMIT SET


SCALE DATE
1/4"=1'@11X17 23 MAR 2022



#### 1. PROPOSED NORTH ELEVATION


5 10

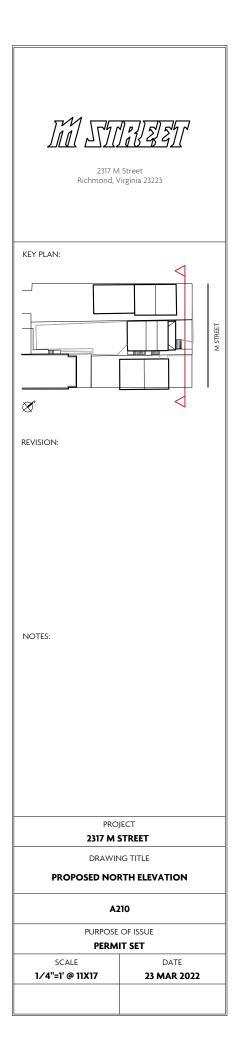

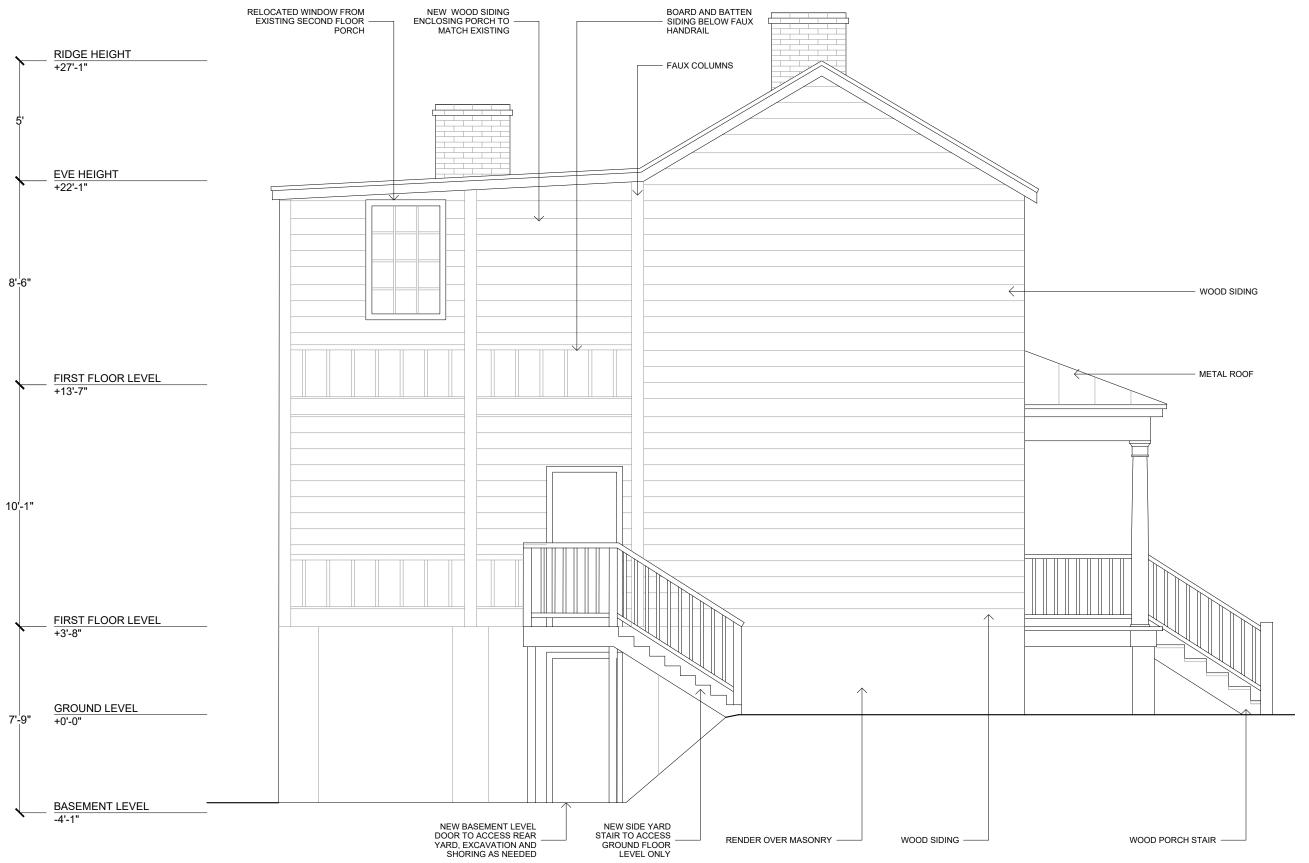



1. PROPOSED EAST ELEVATION

0 1 5 10

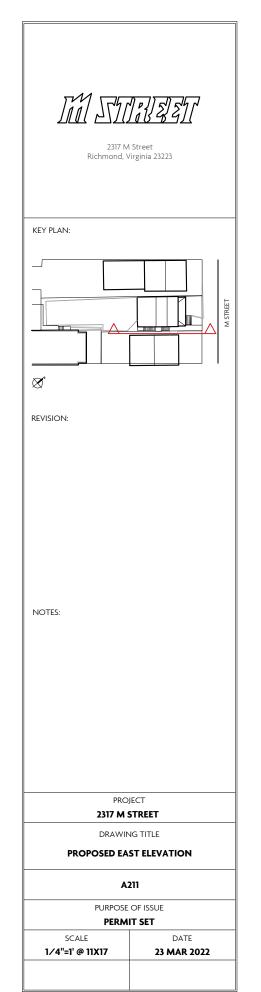




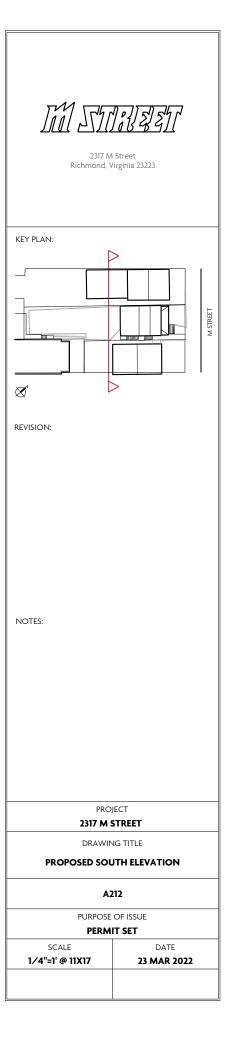


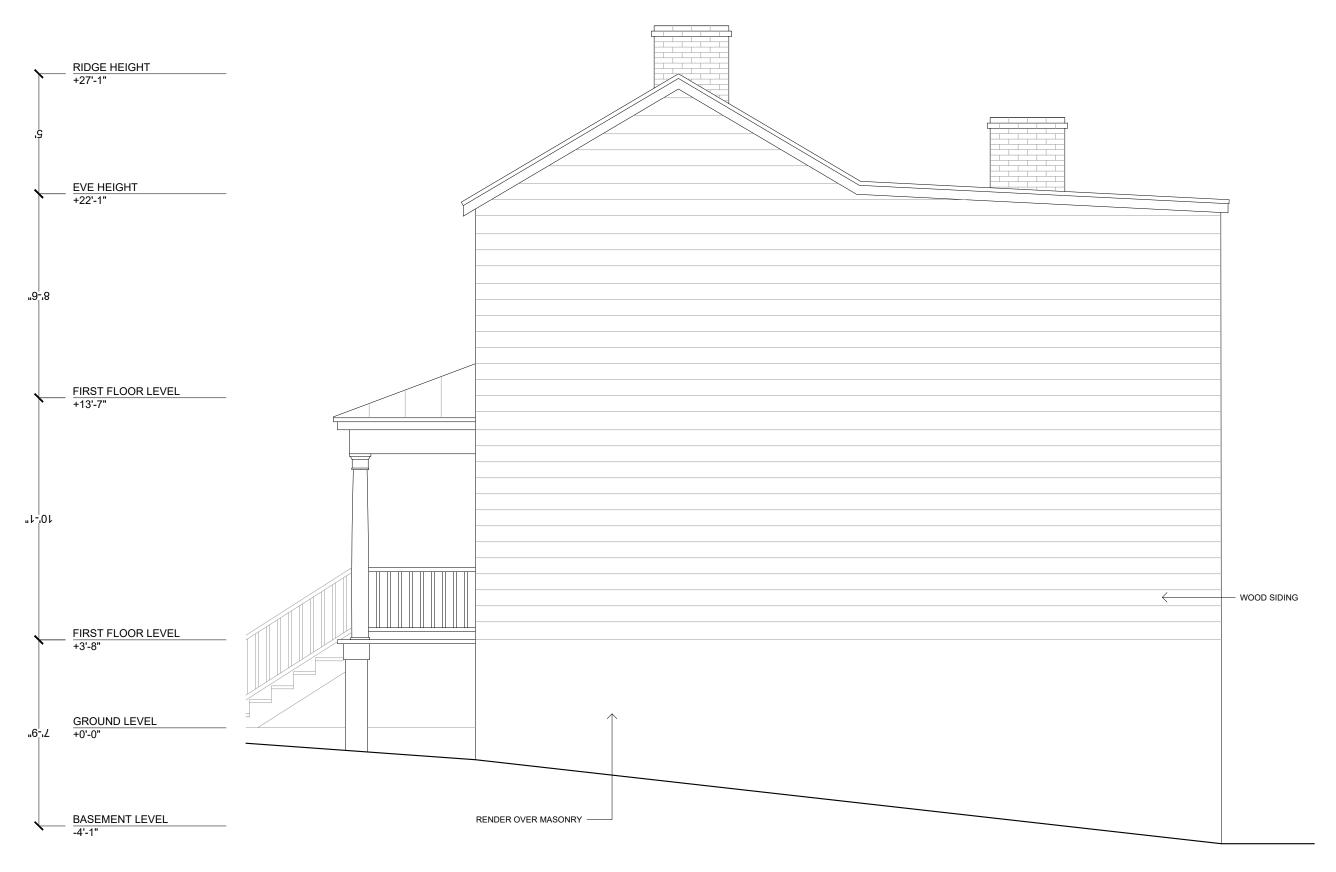


## 1. PROPOSED WEST ELEVATION

0 1 5

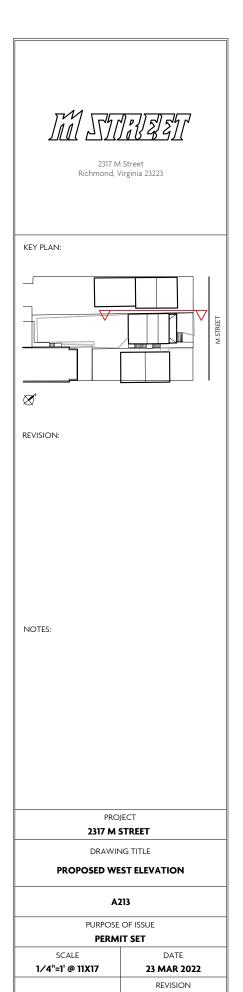

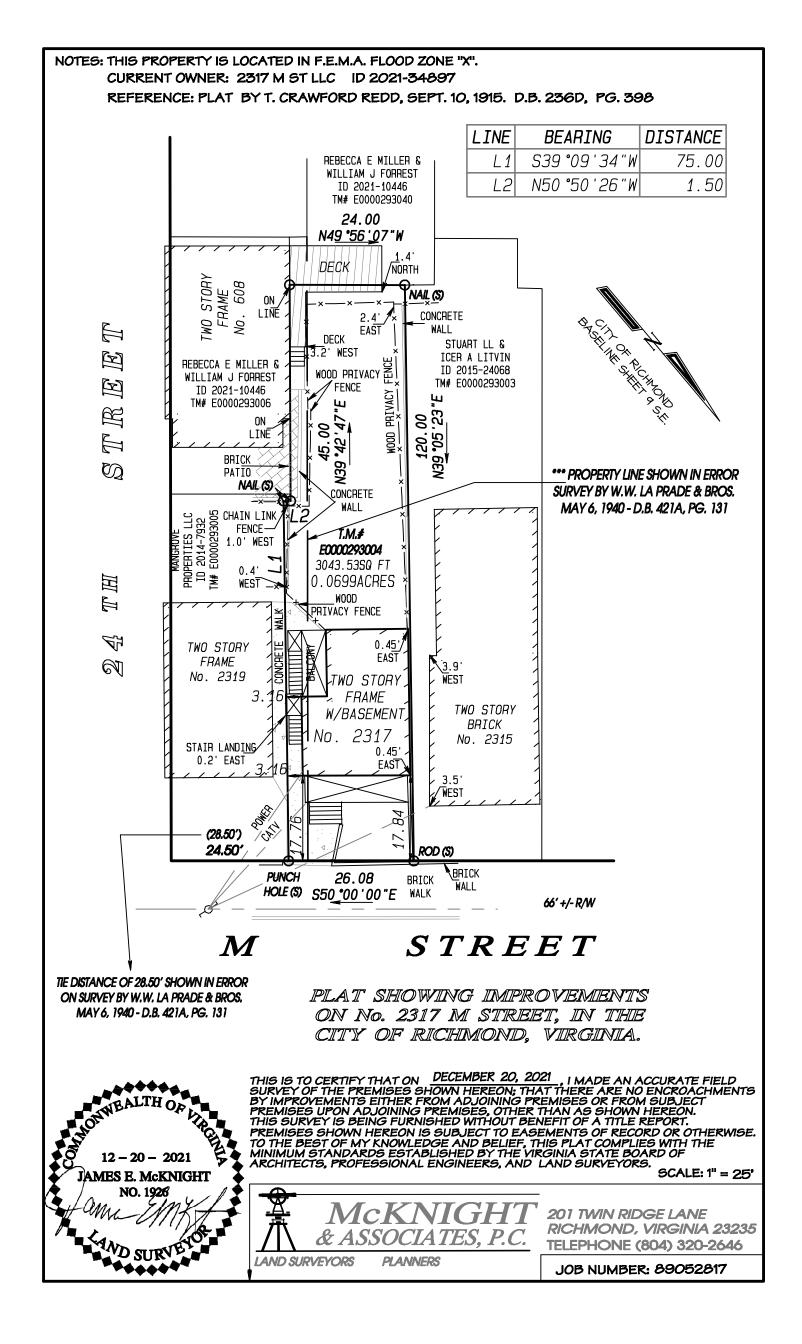

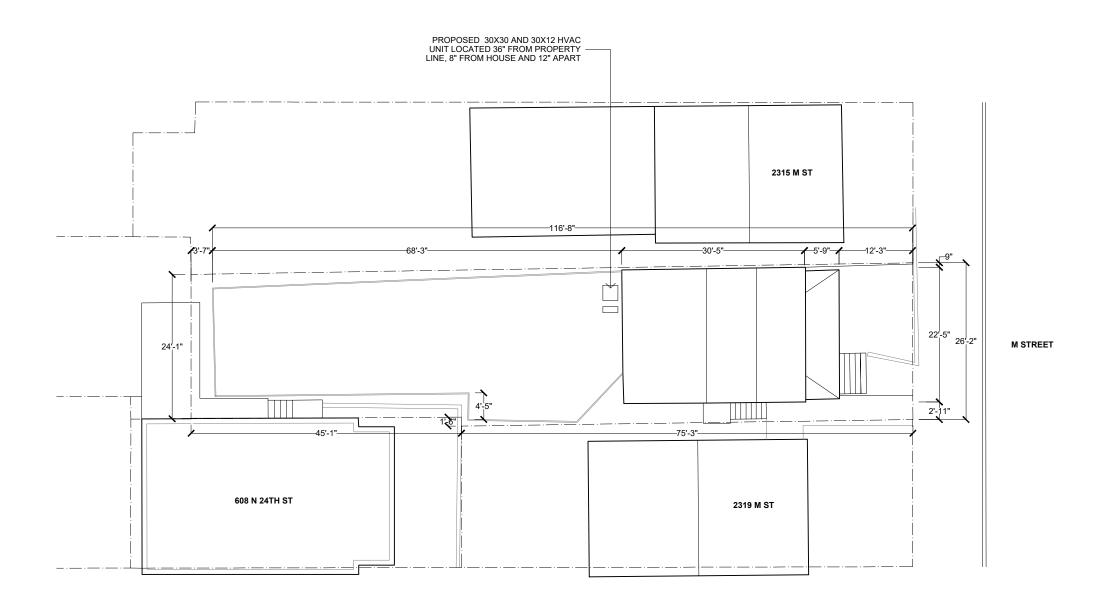

1. PROPOSED SITE PLAN

0 5 10 20 5



2317 M Street Richmond, Virginia 23223

KEY PLAN:

REVISION:

NOTES:

PROJECT

2317 M STREET

DRAWING TITLE

PROPOSED SITE PLAN

A002

PURPOSE OF ISSUE

SCALE DATE


1:16 @ 11X17 23 MAR 2022

DRAWN BY REVISION


CO -




1. EXISTING SITE PLAN

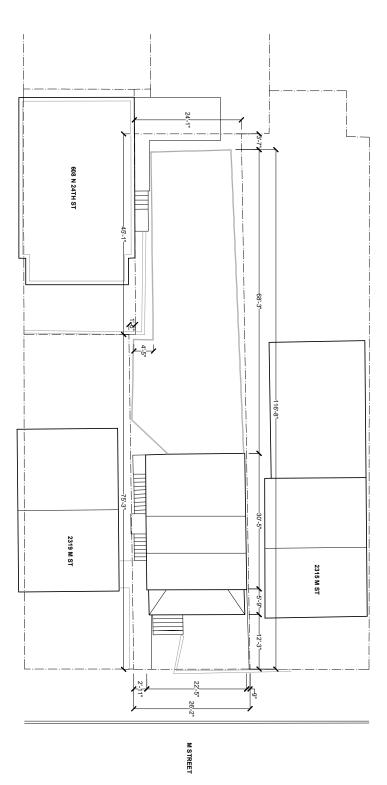


DRAWN BY	SCALE 1:16 @ 11X17	PURPOSE OF ISSUE	A001	DRAWING TITLE  EXISTING SITE PL	PROJECT 2317 M STREET	NOTES:	REVISION:	STATE Street Richmord, Vriginia 23222 KEY PLAN:	
REVISION -	DATE <b>22 JAN 2022</b>	OF ISSUE	)01	NG TITLE SITE PLAN	JECT STREET				

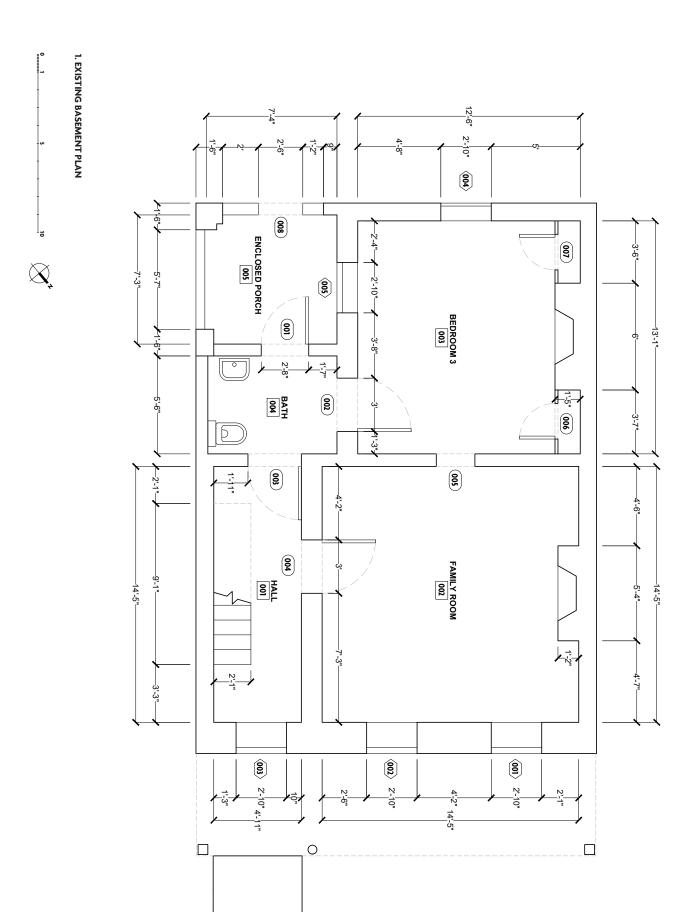

DRAWN BY	PURPOSE OF ISSUE	A100	DRAWING TITLE <b>EXISTING BASEMENT</b>	PROJECT 2317 M STREET	6-9" CELING HEIGHT	OTES:	KEY PLANE	JAM Street Richmond Vigina
DATE 22 JAN 2022 REVISION -	OFISSUE	8	G TITLE EMENT PLAN	TREET				\(\frac{1}{2}\frac{1}{

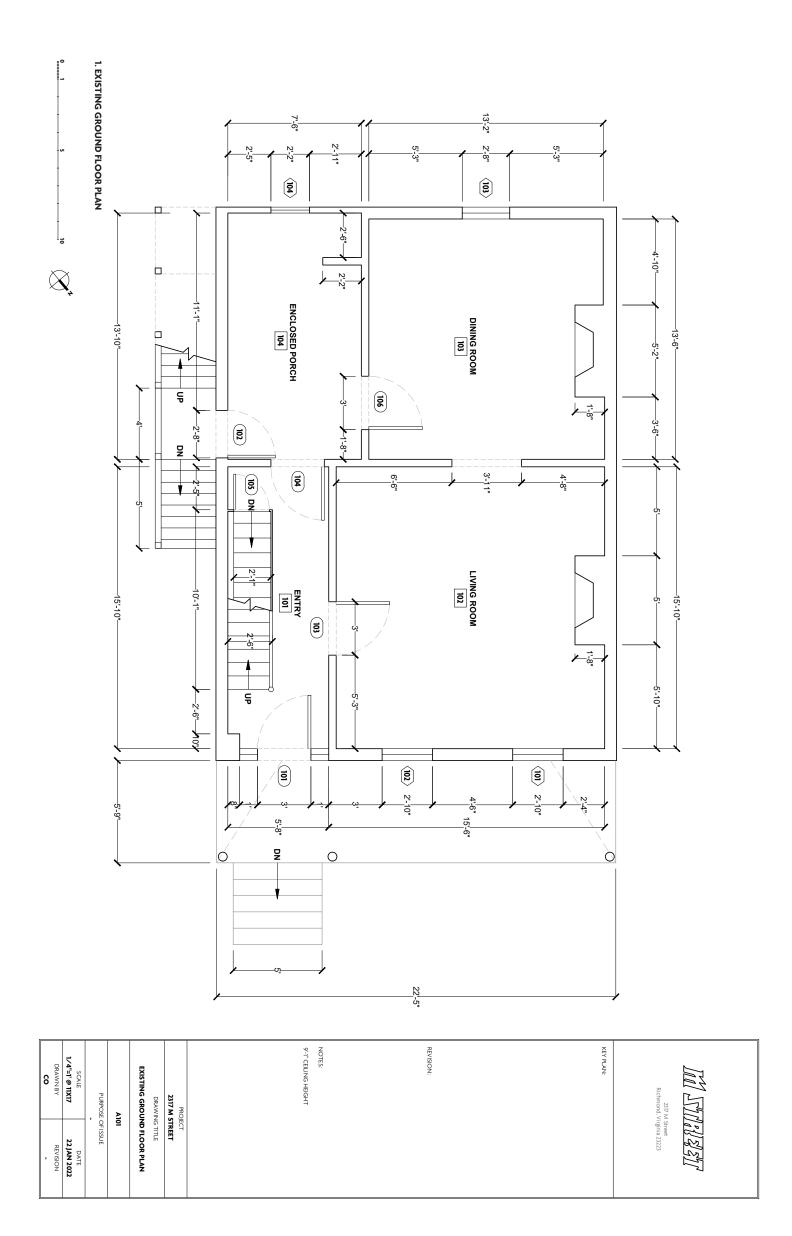

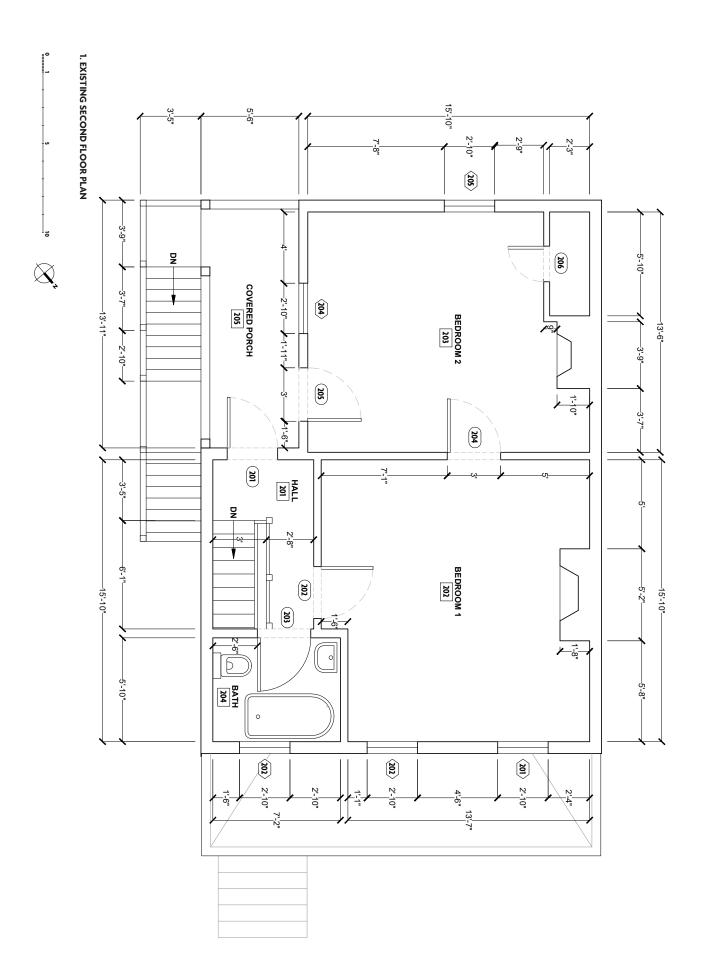


PURPOSE OF SCALE  1/4"=1 @ 11X17  DRAWN BY CO	PROJECT 2317 M STREET DRAWING TITLE EXISTING SECOND FLOO	6" CELLING HEIGH	REVISION:	KEY PLAN	Richmond, VI
IOPESSUE  DATE  22 JAN 2022  REVISION  REVISION	PROJECT 7 M STREET AWING TITLE ECOND FLOOR PLAN				\(\frac{\fin}}}{\fini}}}}}}}}}{\frac{\fra

Example of bracketed roof overhang at side door






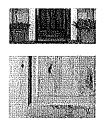





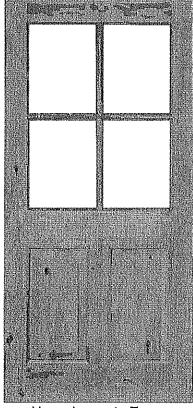


Hover Image to Zoom

36 in. x 80 in. Rustic Knotty Alder 4-Lite Clear Glass 2-Panel Unfinished Wood Front Door Slab

by Krosswood Doors

## Product Images

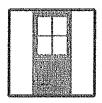













Front elevation
Shows existing aluminum and metal siding.
All windows on the front are original.



Rear Elevation
Second floor and basement level have original windows. Doorway at basement level is into a storage area, under the original first floor porch, already enclosed previously. Note hanging gutter at roof line.




East Elevation
Shows modern staircase to second floor, which will be removed, and replaced with stairs and landing at first floor side door.



West Elevation
Brick retaining wall to remain, metal and vinyl replaced with siding to match original.



Historic photos from the 1950's, showing wooden steps up to the current porch, and wooden siding.

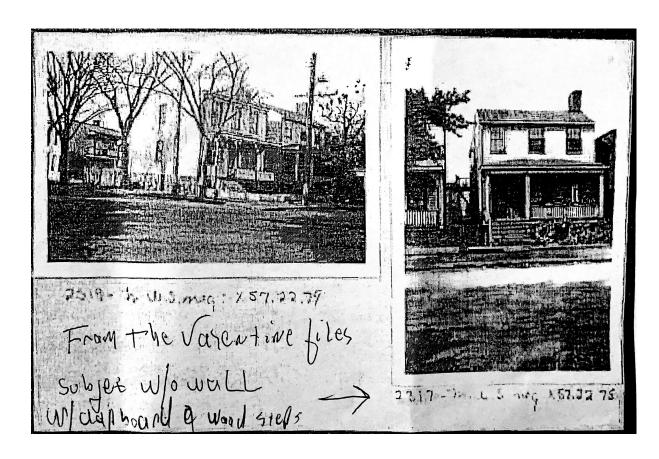

#### Windows:

- 001 Original window, restore
- 002 Original window, restore
- 003 Original window, restore
- 004 Original window, restore
- 008 Door missing, replace with original window 005
- 101 Original window, restore
- 102 Original window, restore
- 103 Replacement window (one over one) to be removed, replace with 6 over 6 wooden sash to match original
- 104 Replacement window (one over one) to be removed, replace with 6 over 6 wooden sash to match original
- 201 Original window, restore
- 202 Original window, restore
- 203 Original window, restore
- 204 Original window, remove, restore, and use for window 204 proposed on rear

#### Doors:

- 009 New Door: two panels in bottom, 4-lite above, see proposed spec. sheet
- 101 French door replacement existing, will replace with new four-panel wood door to match existing exterior door @102.
- 102 Original four panel door chopped off to fit irregular doorway. Replace with New Door: two panels in bottom, 4-lite above, see proposed spec. sheet
- 201 Four-Panel exterior door, restore and re-use as interior door.
- 205 Four-Panel exterior door, restore and re-use as interior door.