DOOR SCHEDULE

MARK	DESCRIPTION	QUAN
A	3'0" x 6'8" HM EXTERIOR DOOR	2
B	3'0" x 6'8" WOOD INTERIOR DOOR	7
C	2'8" X 6'8" WOOD INTERIOR DOOR	5
WIND	OW SCHEDULE	

MARK	DESCRIPTION	QUAN
(1)	2'0"x2'8" VINYL CLAD DH WINDOW	1
2	3'0"x4'6" VINYL CLAD DH WINDOW	8
3	3'0"x2'8" VINYL CLAD DH WINDOW	1

NOTES:

n the job site at all times and shall not be altered w

t does not approve any Electrical, Mechanical or Plumbing work. This ap

lying with manufacturer instructions, Virginia Uniform chmond regulations whether noted, implied or omitted

- DK M

DOORS AND WINDOWS ARE TO HAVE A U-FACTOR OF 0.35

A DOUBLE 2"x10" HEADER IS TO BE PROVIDED FOR ALL DOORS AND WINDOWS IN EXTERIOR AND BEARING WALLS EXCEPT WHERE NOTED.

ALL WINDOWS WITHIN 2 ft (HORIZONTALLY) OF A DOOR IS TO BE TEMPERED SAFETY GLASS.

GENERAL NOTES :


1. OWNER / APPLICANT

2. TAX PARCEL

- 3. ZONING
- 4. WATER SEWER
- 5. LAND AREA

GULNORA LLC 7534 WHITTINGTON DR CHESTERFIELD, VA 23225 S0080380025 R-5 - RESIDENTIAL (SINGLE FAMILY) **CITY WATER** CITY SEWER 0.366 ACRES


viewed per VA Residential Code 2015 ulation and Fenestration values Walls R-15 Crawl R-19 Attic R-38 UMAX = 0.35

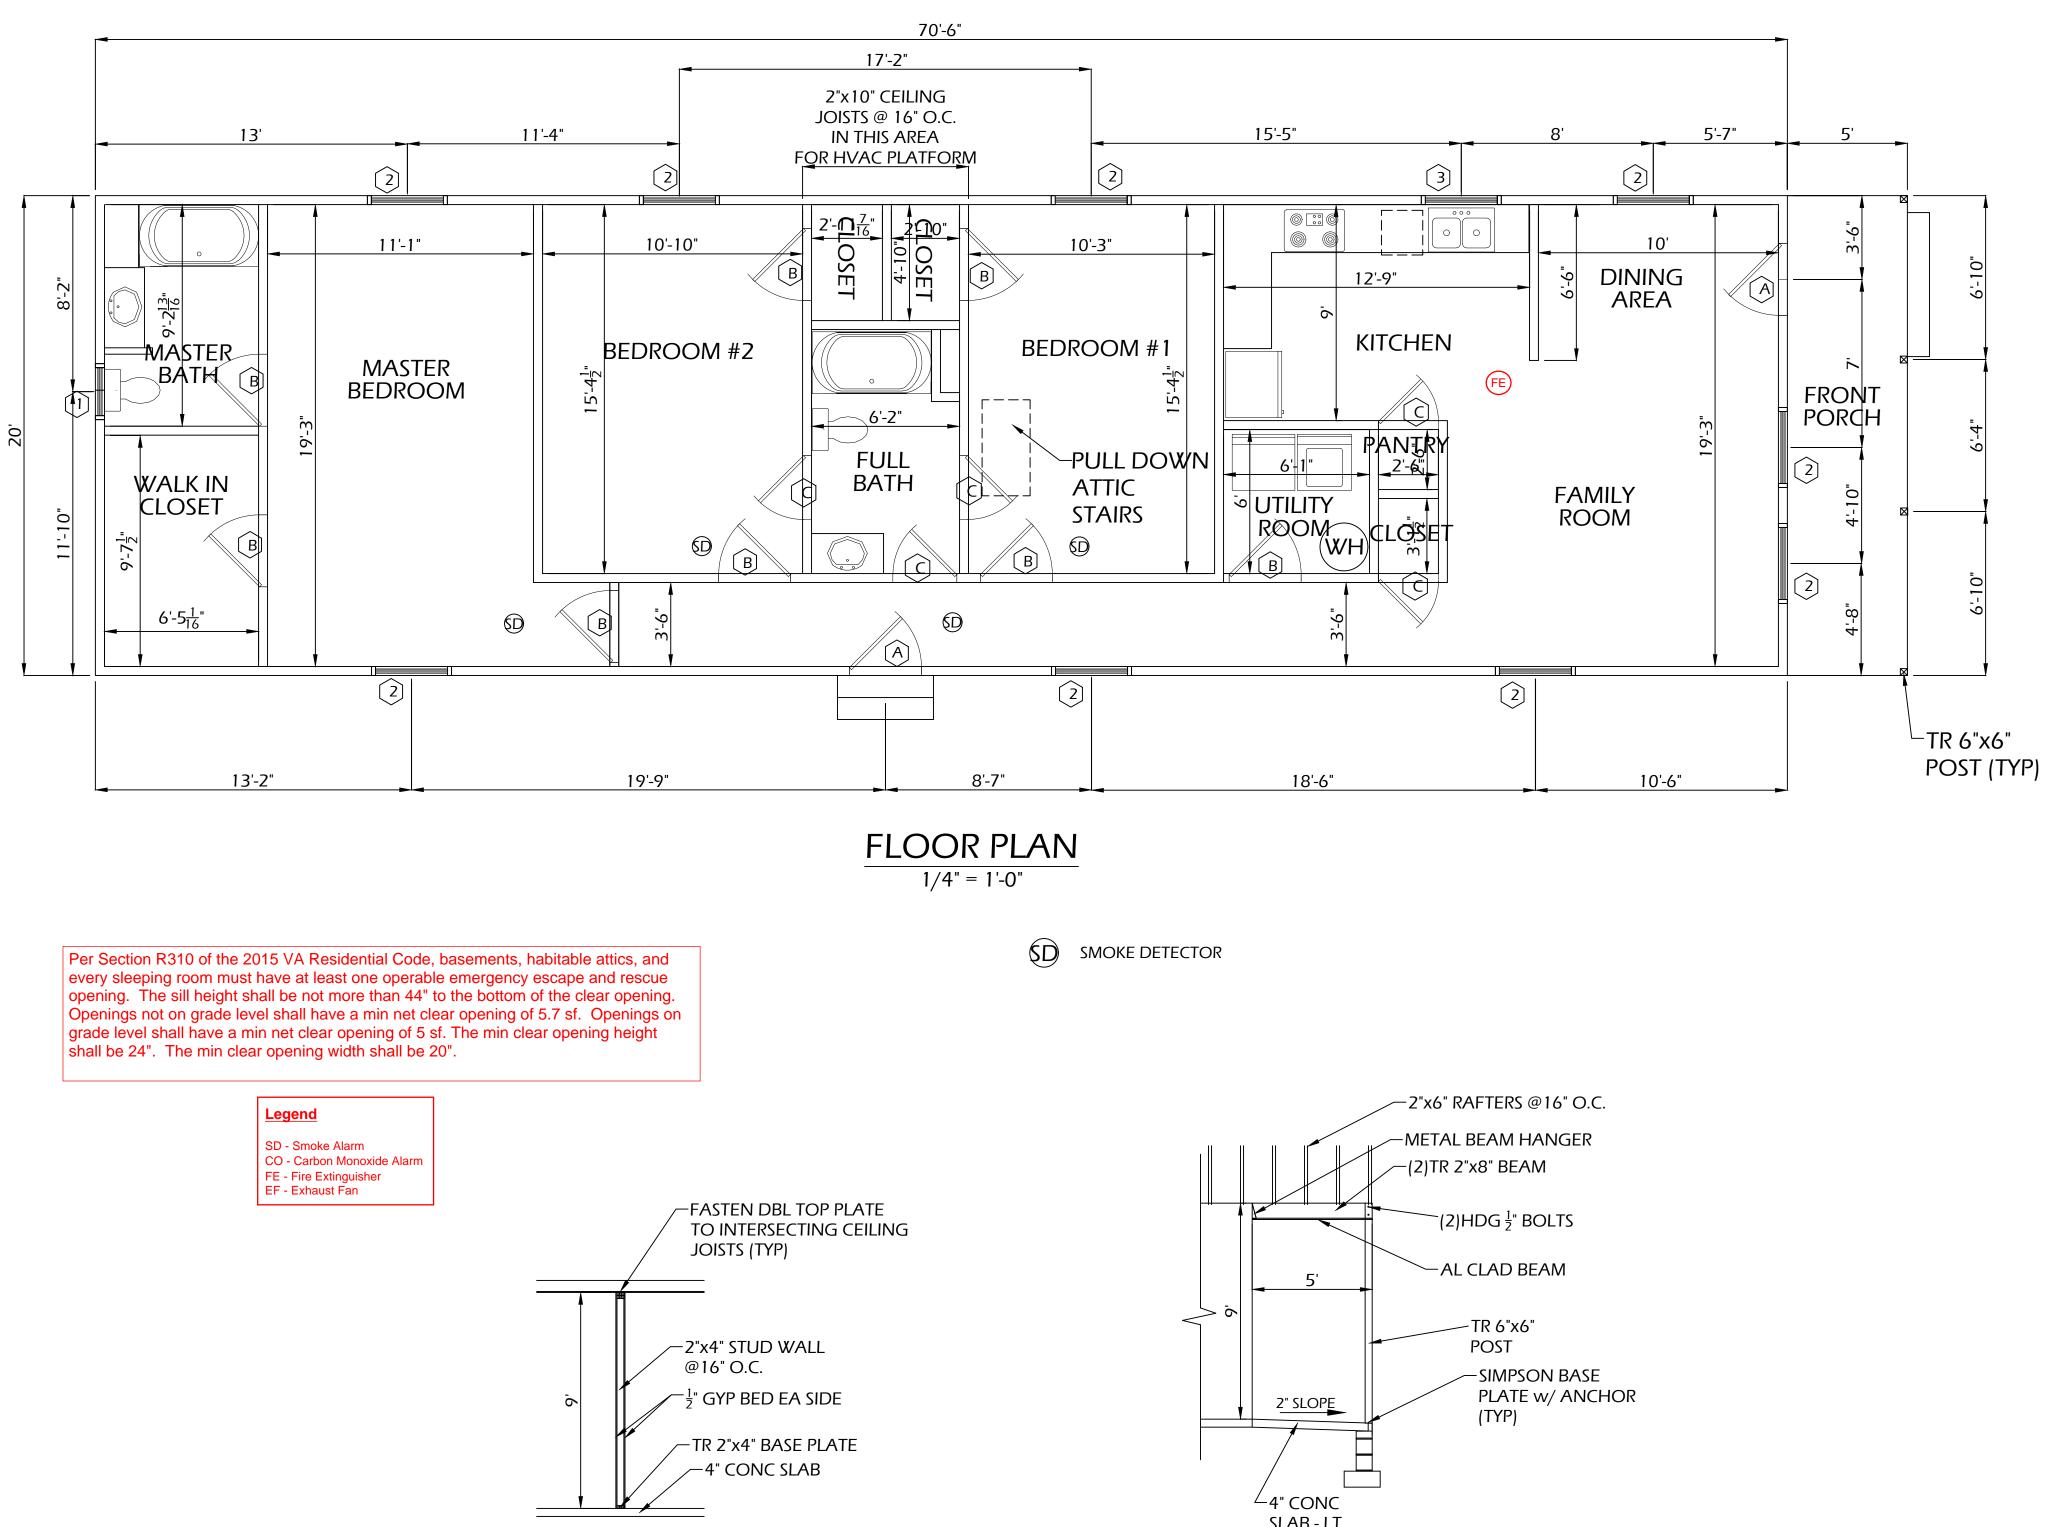

TYP PARTITION WALL DETAIL 1/4" = 1'-0"

ALL WORK TO BE IN COMPLIANCE WITH 2015 VCC / IRC

				SHEET TITLE		PROJECT NO.
					FLOOR PLAN	SCALE
					and ELEVATIONS	AS SHOWN Date 1/14/2020
				PROJECT		DRAWN BY
					HOUSE PLAN	
						JK
					·	DRAWING NO.
					GULNORA, LLC	
					1901 N PARHAM ROAD	$ \cap 11 $
					HENRICO, VA. 23228 (850) 319–2395	
					E-Mail: gulakamalovna@yahoo.com	1 OF 3 SHTS
NC	. DATE	BY	REVISION			

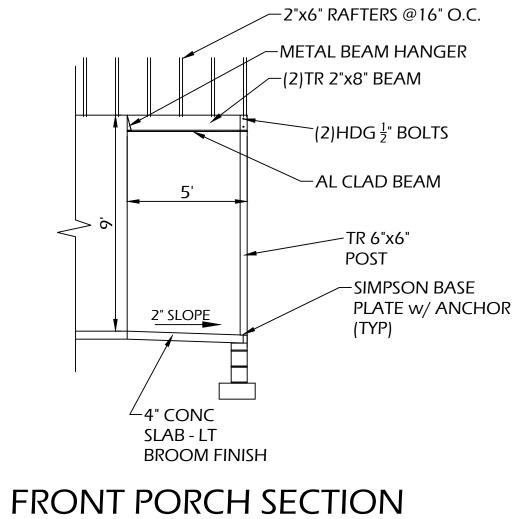

1/4" = 1'-0"

CONCRETE

This permit does not approve any Electrical, Mechanical or Plumbing work. This ap

kept on the job site at all times and shall not be altered without appro

- A. CONCRETE SHALL NOT BE PLACED ON FROZEN SOILS, OR UNDER CONDITIONS
- WHICH WILL ADVERSELY AFFECT STRENGTH.

DK M

- B. FOOTING SIZING ASSUMES A MINIMUM ALLOWABLE SOIL BEARING PRESSURE OF 1500 PSF. C. CONTRACTOR TO NOTIFY CONSTRUCTION MANAGER IMMEDIATELY IF
- UNSTABLE/UNSUITABLE SOIL CONDITIONS ARE ENCOUNTERED DURING EXCAVATION.
- D. CONCRETE SHALL BE MINIMUM 3000 PSI AT 28 DAYS COMPRESSIVE STRENGTH. CONCRETE SHALL BE AIR ENTRAINED IN ALL EXPOSED EXTERIOR APPLICATIONS. CONCRETE SLABS SHALL BE 4" THICK AND DO NOT REQUIRE WOVEN WIRE MESH
- REINFORCING UNLESS NOTED OTHERWISE. G. PROVIDE 4" #57 STONE BENEATH ALL NEW SLABS, UNLESS NOTED OTHERWISE.
- H. PROVIDE 6 MIL VAPOR BARRIOR BETWEEN THE SLAB AND STONE. I. ALL FOOTINGS MUST BE A MINIMUM OF 24" BELOW GRADE AND EXTEND TO UNDISTURBED SOIL OR PROPERLY COMPACTED FILL.

MASONRY


- A. CONCRETE MASONRY UNITS (CMU) SHALL MEET THE FOLLOWING STANDARDS: 1. HOLLOW LOAD BEARING: ASTM C-90
 - 2. SOLID LOAD BEARING: ASTM C-145
- 3. HOLLOW NON-LOAD BEARING: ASTM C-129 B. BRICK: TYPE, SIZE, AND BOND TO BE CHOSEN BY OWNER
- C. MORTAR SHALL BE ASTM C-270 TYPE S, AND NO ADMIXTURE WILL BE ALLOWED. COLOR AN JOINT TYPE TO BE CHOSEN BY OWNER.
- D. CONTRACTOR SHALL SUBMIT SAMPLES OF BRICK AND MORTAR TO THE CONSTRUCTION MANAGER FOR REVIEW AND APPROVAL PRIOR TO COMMENCEMENT OF CONSTRUCTION.
- E. CMU SHALL BE LAID IN RUNNING BOND WITH FLUSH JOINTS.
- F. CMU WALL REINFORCING SHALL BE HOT-DIPPED GALVANIZED TRUSS TYPE REINFORCING, 1" LESS THAN WALL THICKNESS, 16" OC VERTICALLY, LAPPED 6" AND WIRE TIED.
- G. PROVIDE ALL BRICK TIES, HORIZONTAL REINFORCEMENT, FOUNDATION VENTS, LINTELS, AND ACCESSORIES REQUIRED FOR A COMPLETE JOB. H. MASONRY FIREPLACES SHALL BE DESIGNED FOR PROPER AIR INTAKE, DRAW,
- AND CODE COMPLIANCE. INCLUDE DAMPER, CAPS, AND ALL OTHER ACCESSORIES REQUIRED FOR COMPLETE INSTALLATION.


WOOD FRAMING


- A. STRUCTURAL FRAMING ANDBLOCKING SHALL BE NO. 2 OR BETTER SOUTHERN YELLOW PINE (19% MAX MOISTURE CONTENT, f = 1200, E = 1,600,000), UNLESS NOTED OTHERWISE.
- B. STUDS SHALL BE GRADE-MARKED "STANDARD" OR BETTER.
- C. ALL FRAMING WHICH CONTACTS THE GROUND, MASONRY, OR CONCRETE SHALL BE PRESERVATIVE PRESSURE TREATED.
- D. LAMINATED VENEER LUMBER (LVL'S) SHALL BE TRUSJOIST'S 1.9E MICROLAM OR APPROVED EQUAL.
- E. LAMINATED STRAND LUMBER (LSL'S) SHALL BE TRUSJOIST'S 1.3E OR 1.5E TIMBERSTRAND OR APPROVED EQUAL.
- F. PARALLEL STRAND LUMBER (PSL'S) SHALL BE TRUSJOIST'S 2.0E PARALLAM OR APPROVED EQUAL.
- G. PRE-FAB. WOOD I-JOISTS SHALL BE TRUSJOIST'S TJI JOISTS OR APPROVED EQUAL.
- H. CONTRACTOR TO PROVIDE FRAME BLOCKING AND BRIDGING AS REQUIRED. I. JOIST AND BEAM DESIGN MAX. ALLOWABLE DEFLECTIONS SHALL BE AS FOLLOWED: 1. JOISTS = L/480 (LL)


2. BEAMS = L/360 (LL)

- J. FRAMING ACCESSORIES SHALL BE SIMPSON STRONG-TIE OR APPROVED EQUAL. K. SUBFLOORING SHALL BE APA RATED 3/4" STURD-I-FLOOR, T&G EXTERIOR
- EXPOSURE UNLESS NOTED OTHERWISE. .. SUBFLOORING SHALL BE ADHESIVE APPLIED AND NAILED IN PLACE PER
- MANUFACTURER'S RECOMMENDATIONS. M. SUBFLOOR/UNDERLAYMENT UNDER THINSET TIE SHALL BE A MIN. OF 1 1/4" TOTAL
- THICKNESS PER TCA RECOMMENDATIONS.
- N. ROOF SHEATHING SHALL BE APA SPAN-RATED 7/16" CDX UNLESS OTHERWISE NOTED O. WALL SHEATHING SHALL BE APA SPAN-RATED 51/2" OSB UNLESS OTHERWISE NOTED.
- P. DOUBLE STUDS AT ALL DOOR, WINDOWS, AND CASED OPENING JAMBS. O. FRAMER TO VERIFY DIMENSIONAL LAYOUT WITH CONSTRUCTION MANAGER PRIOR TO SETTING WALLS.

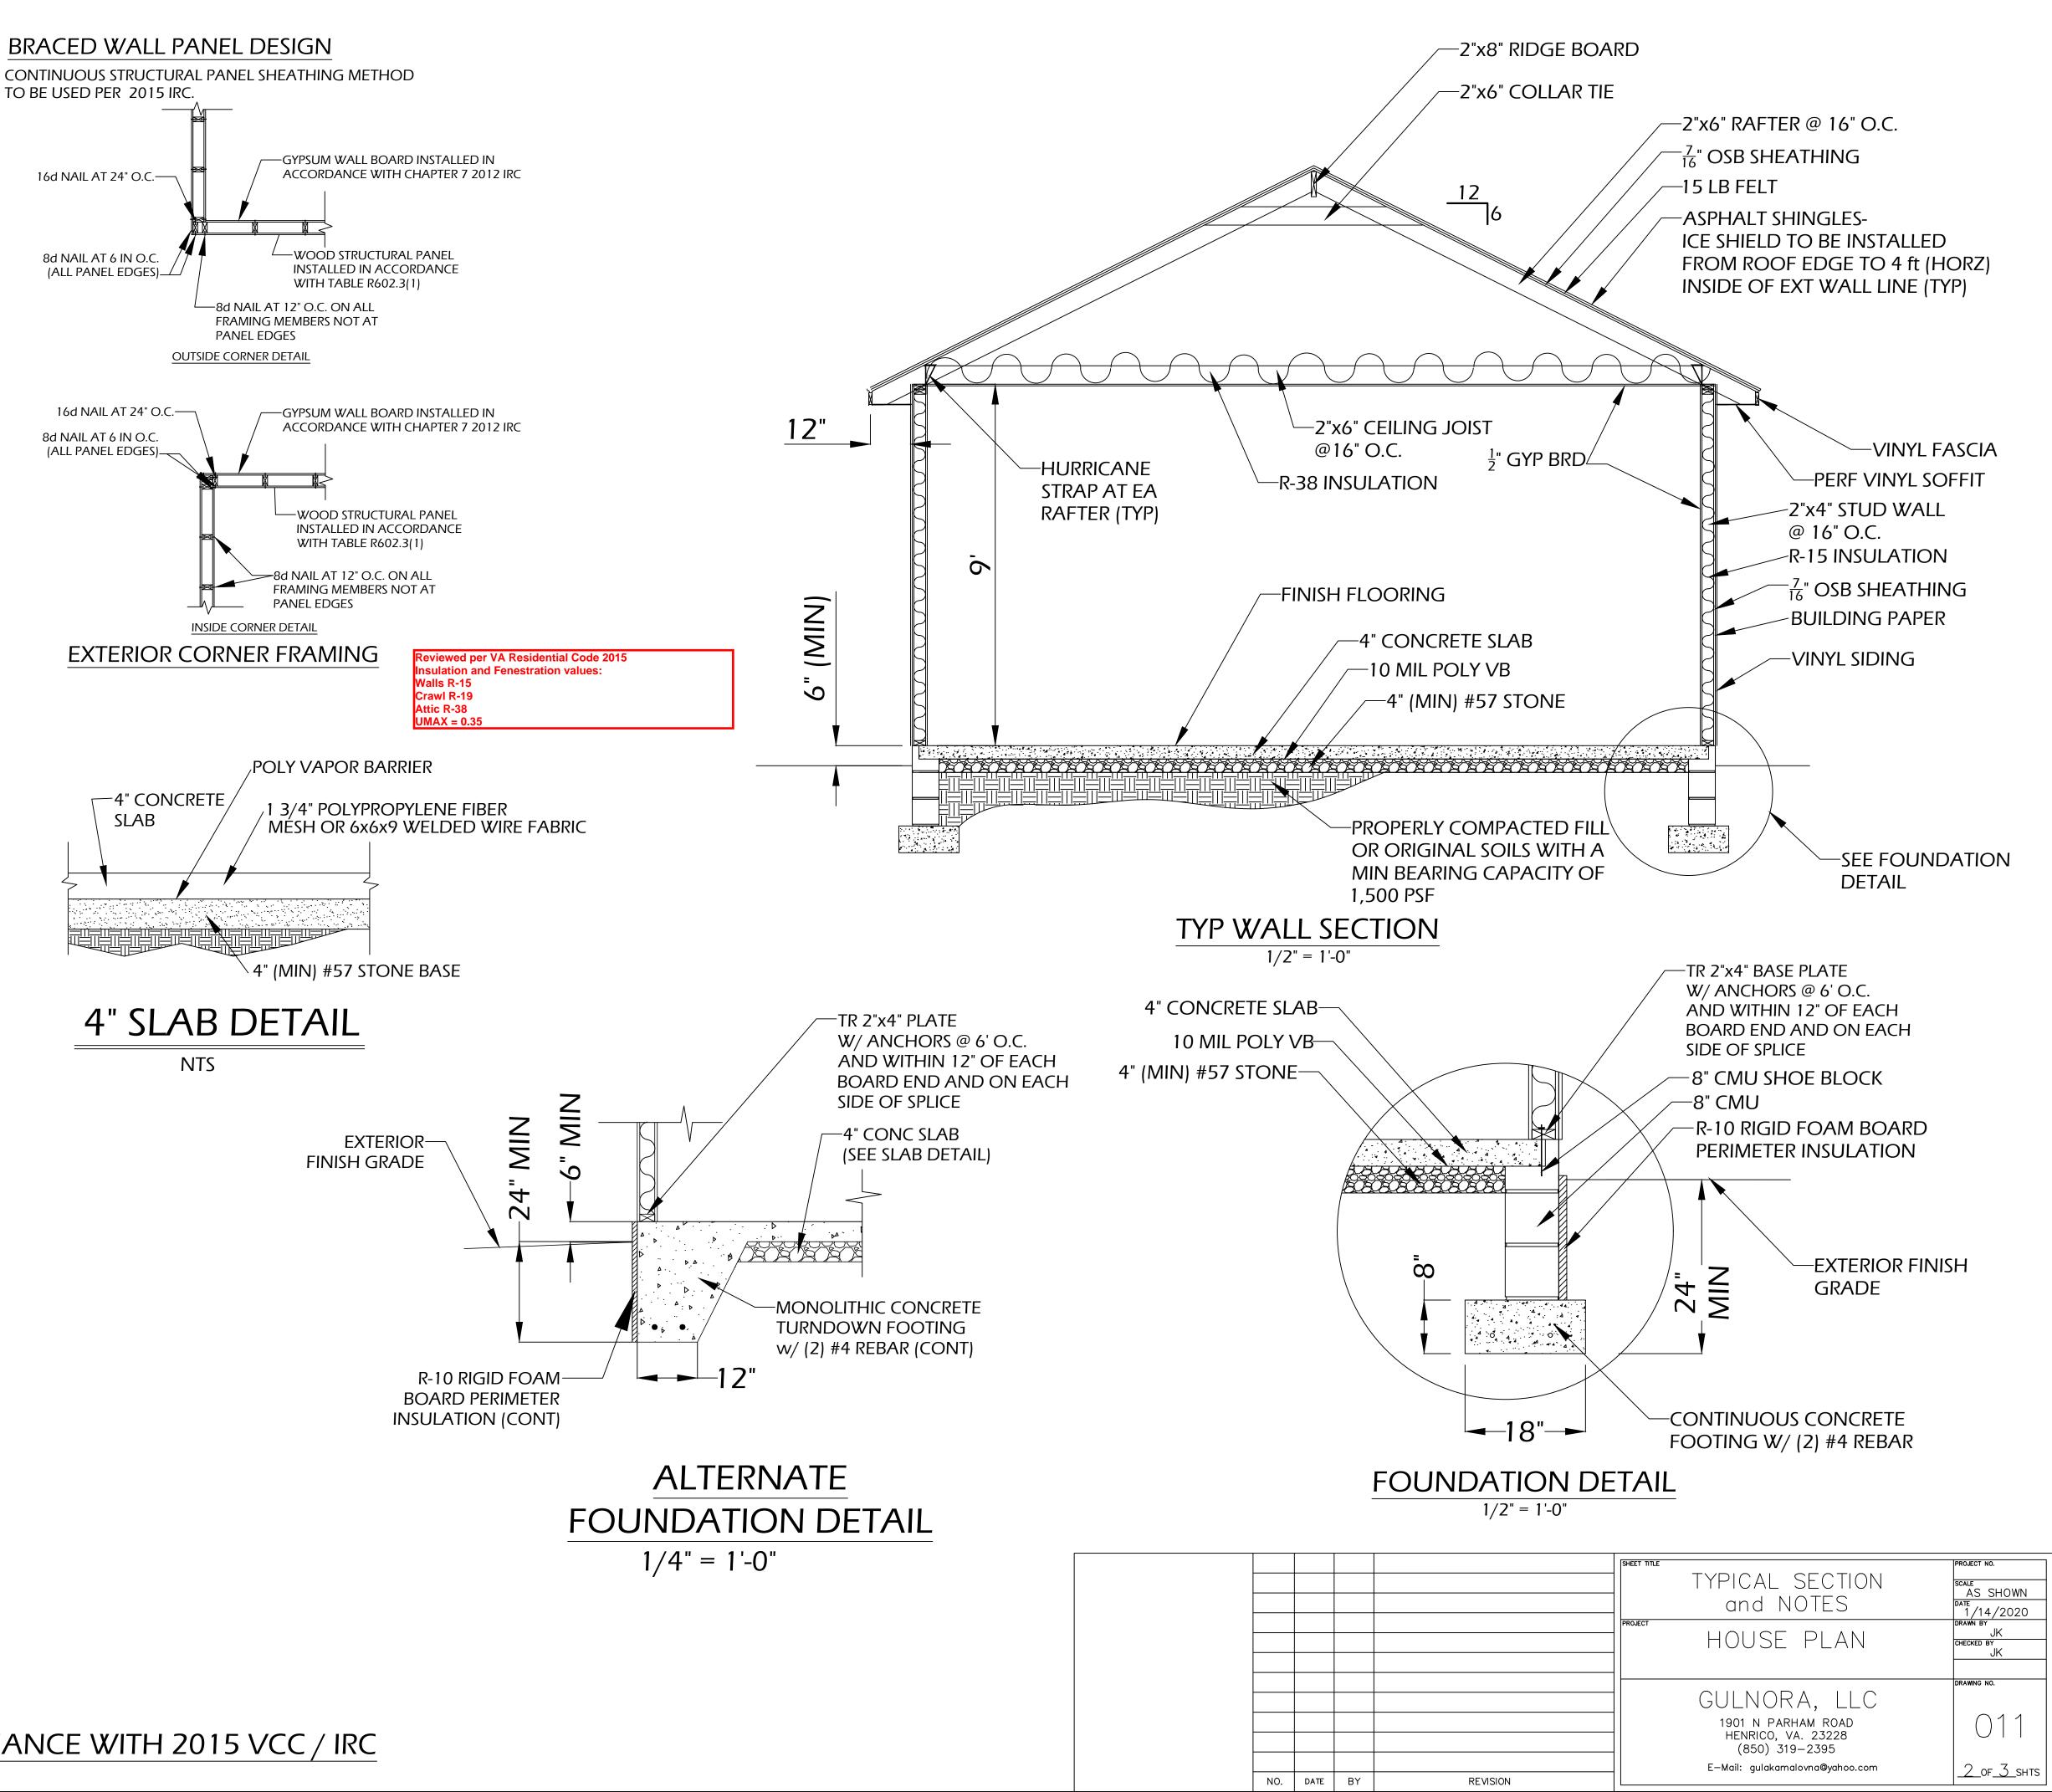

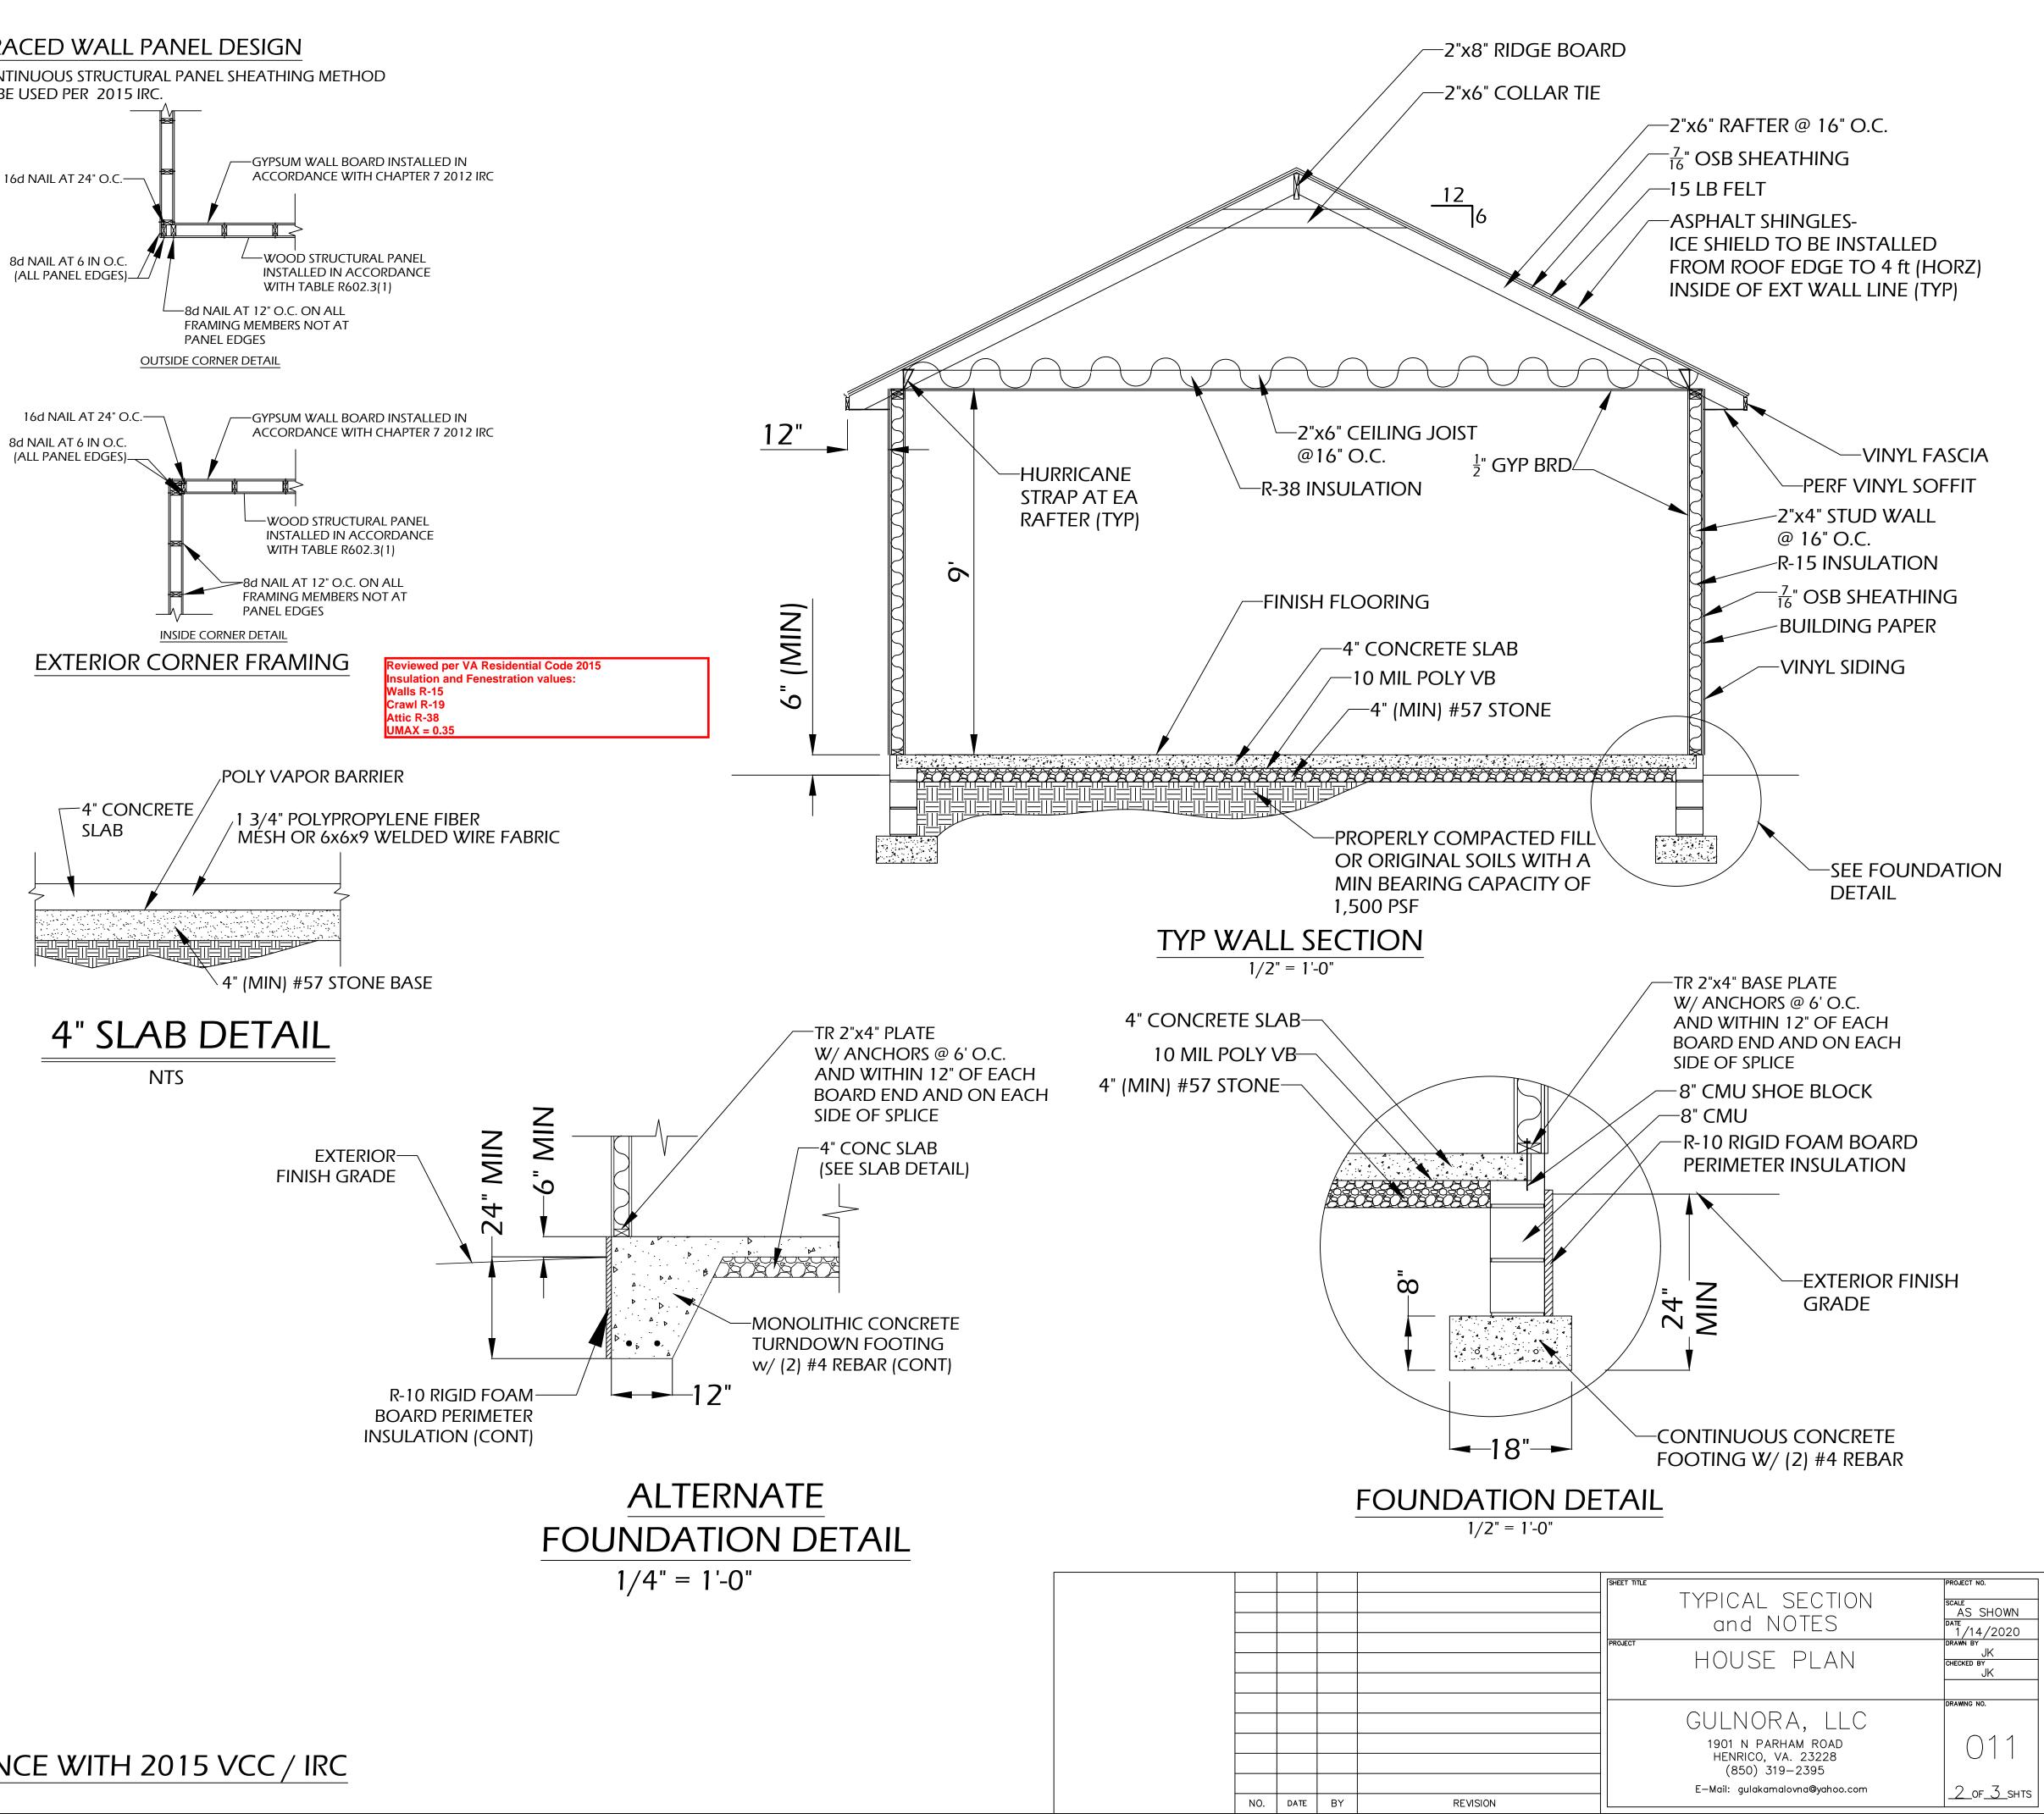

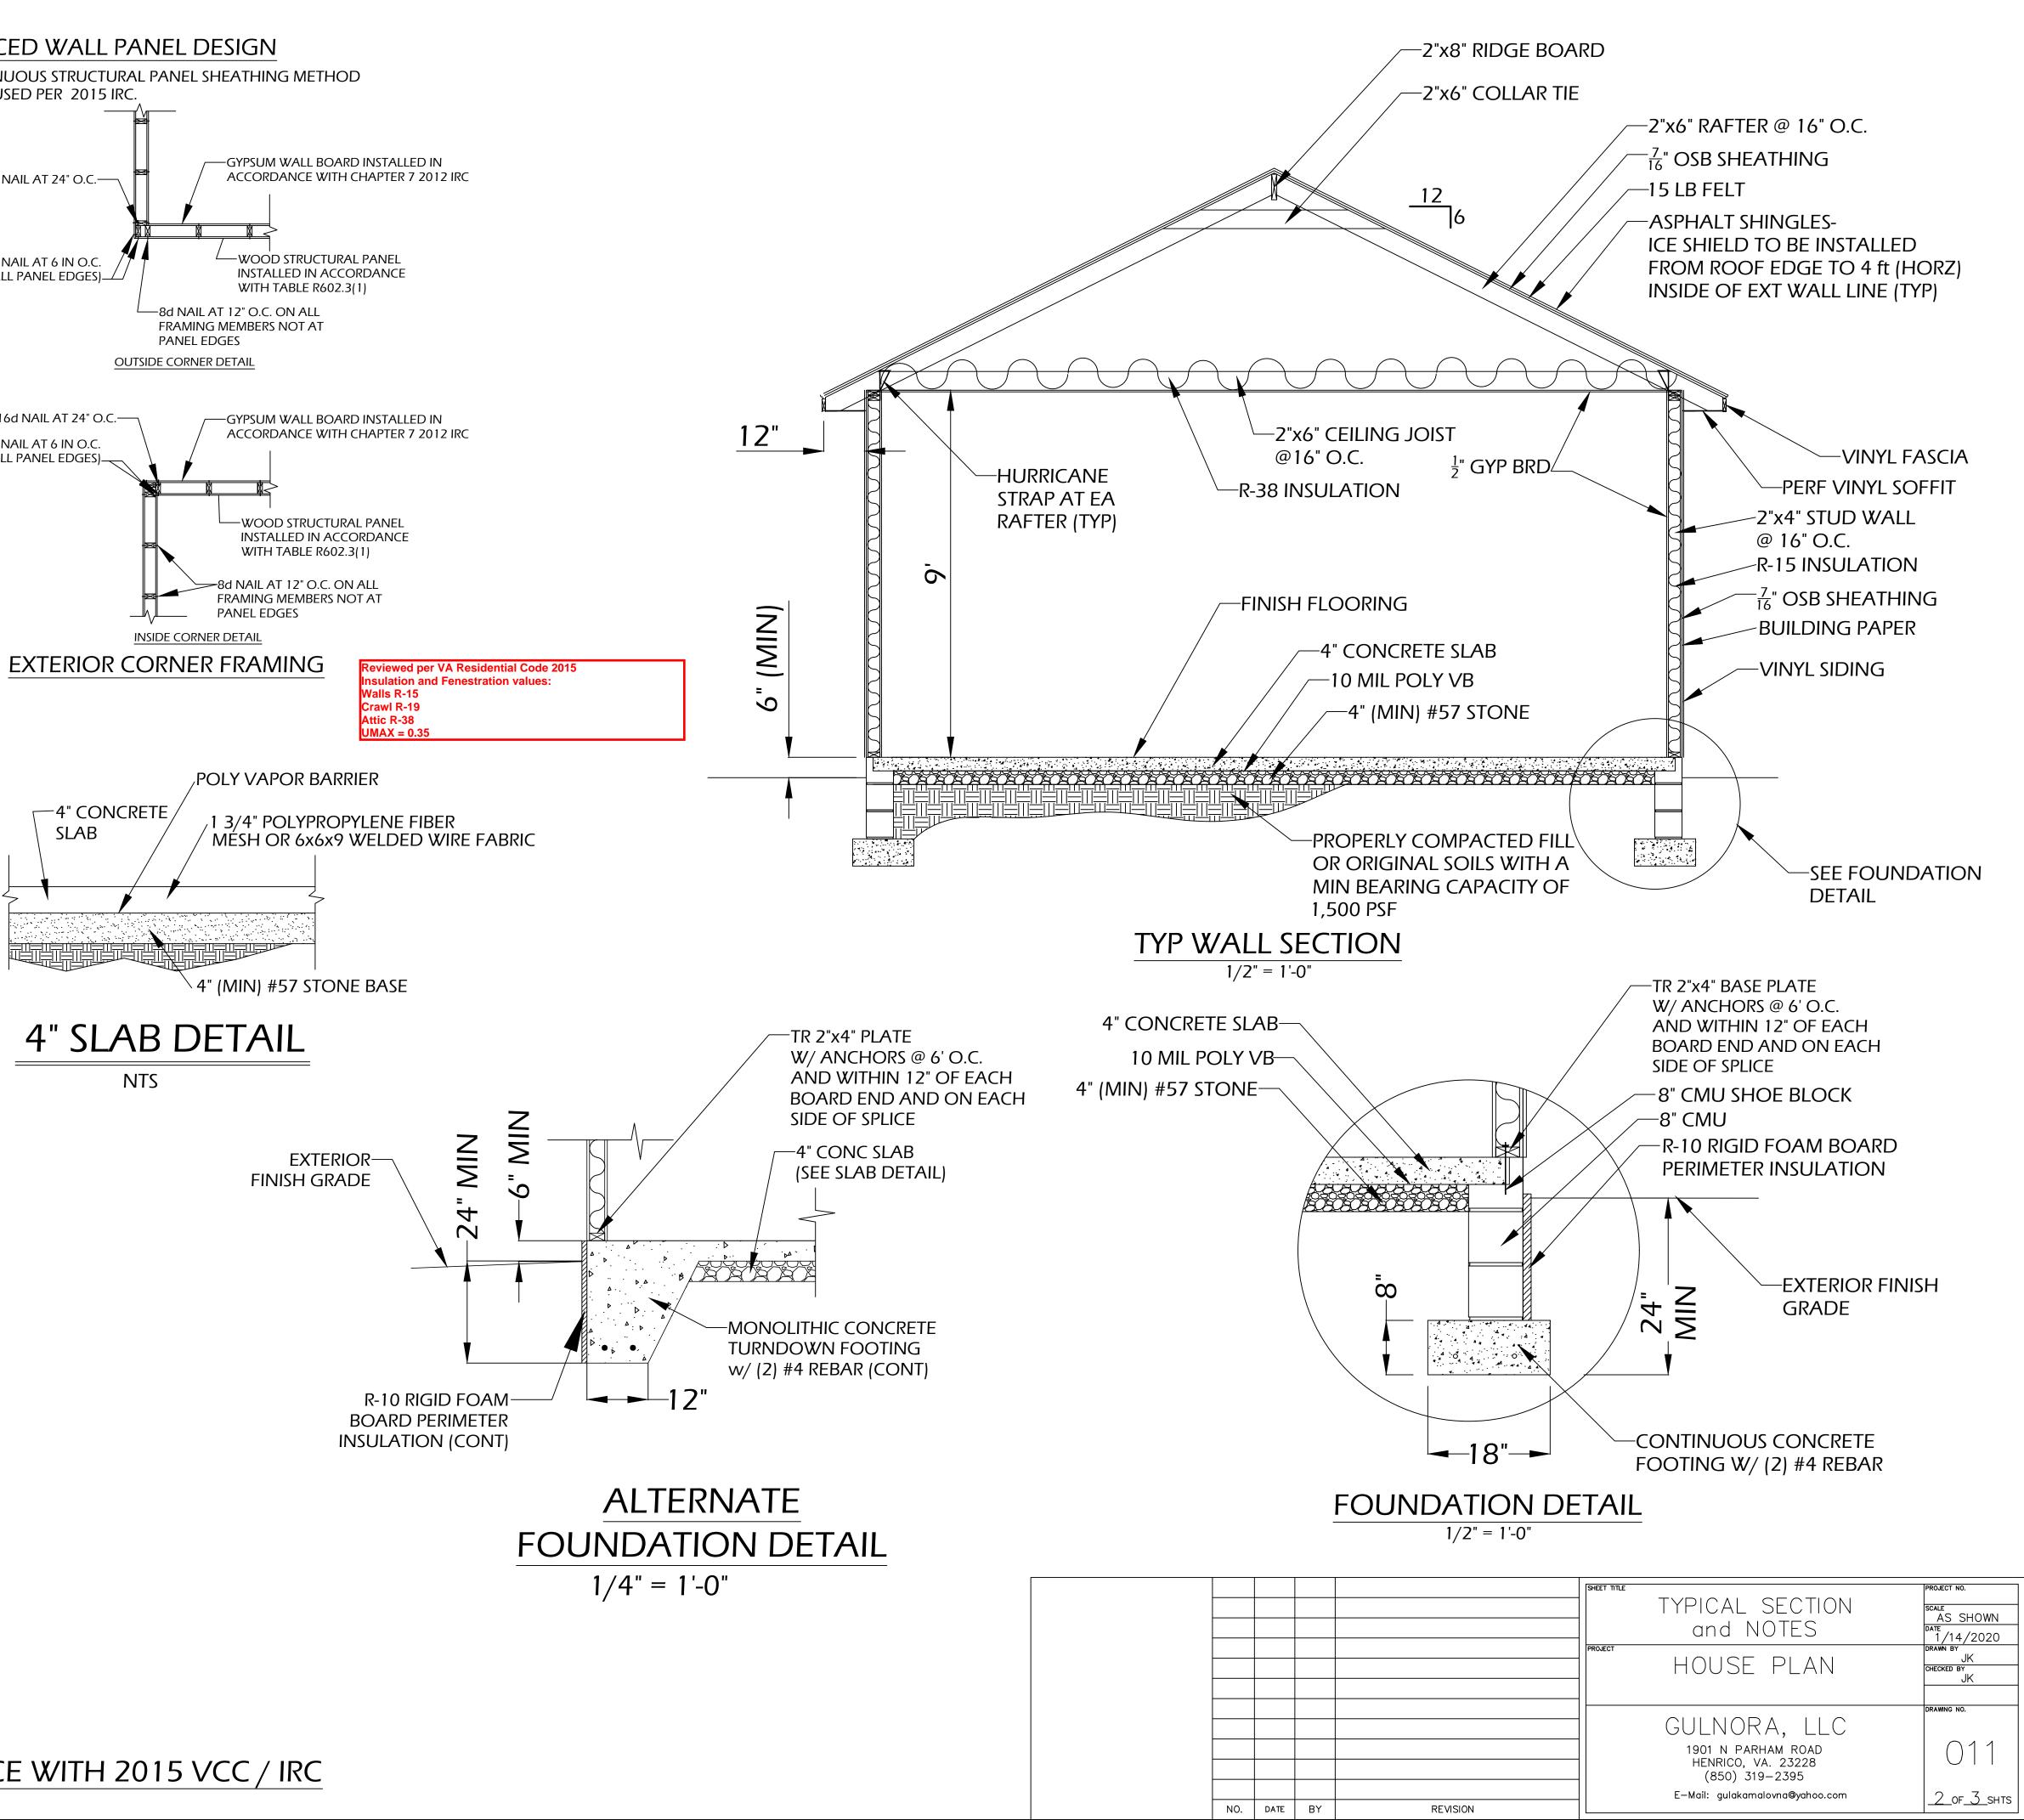

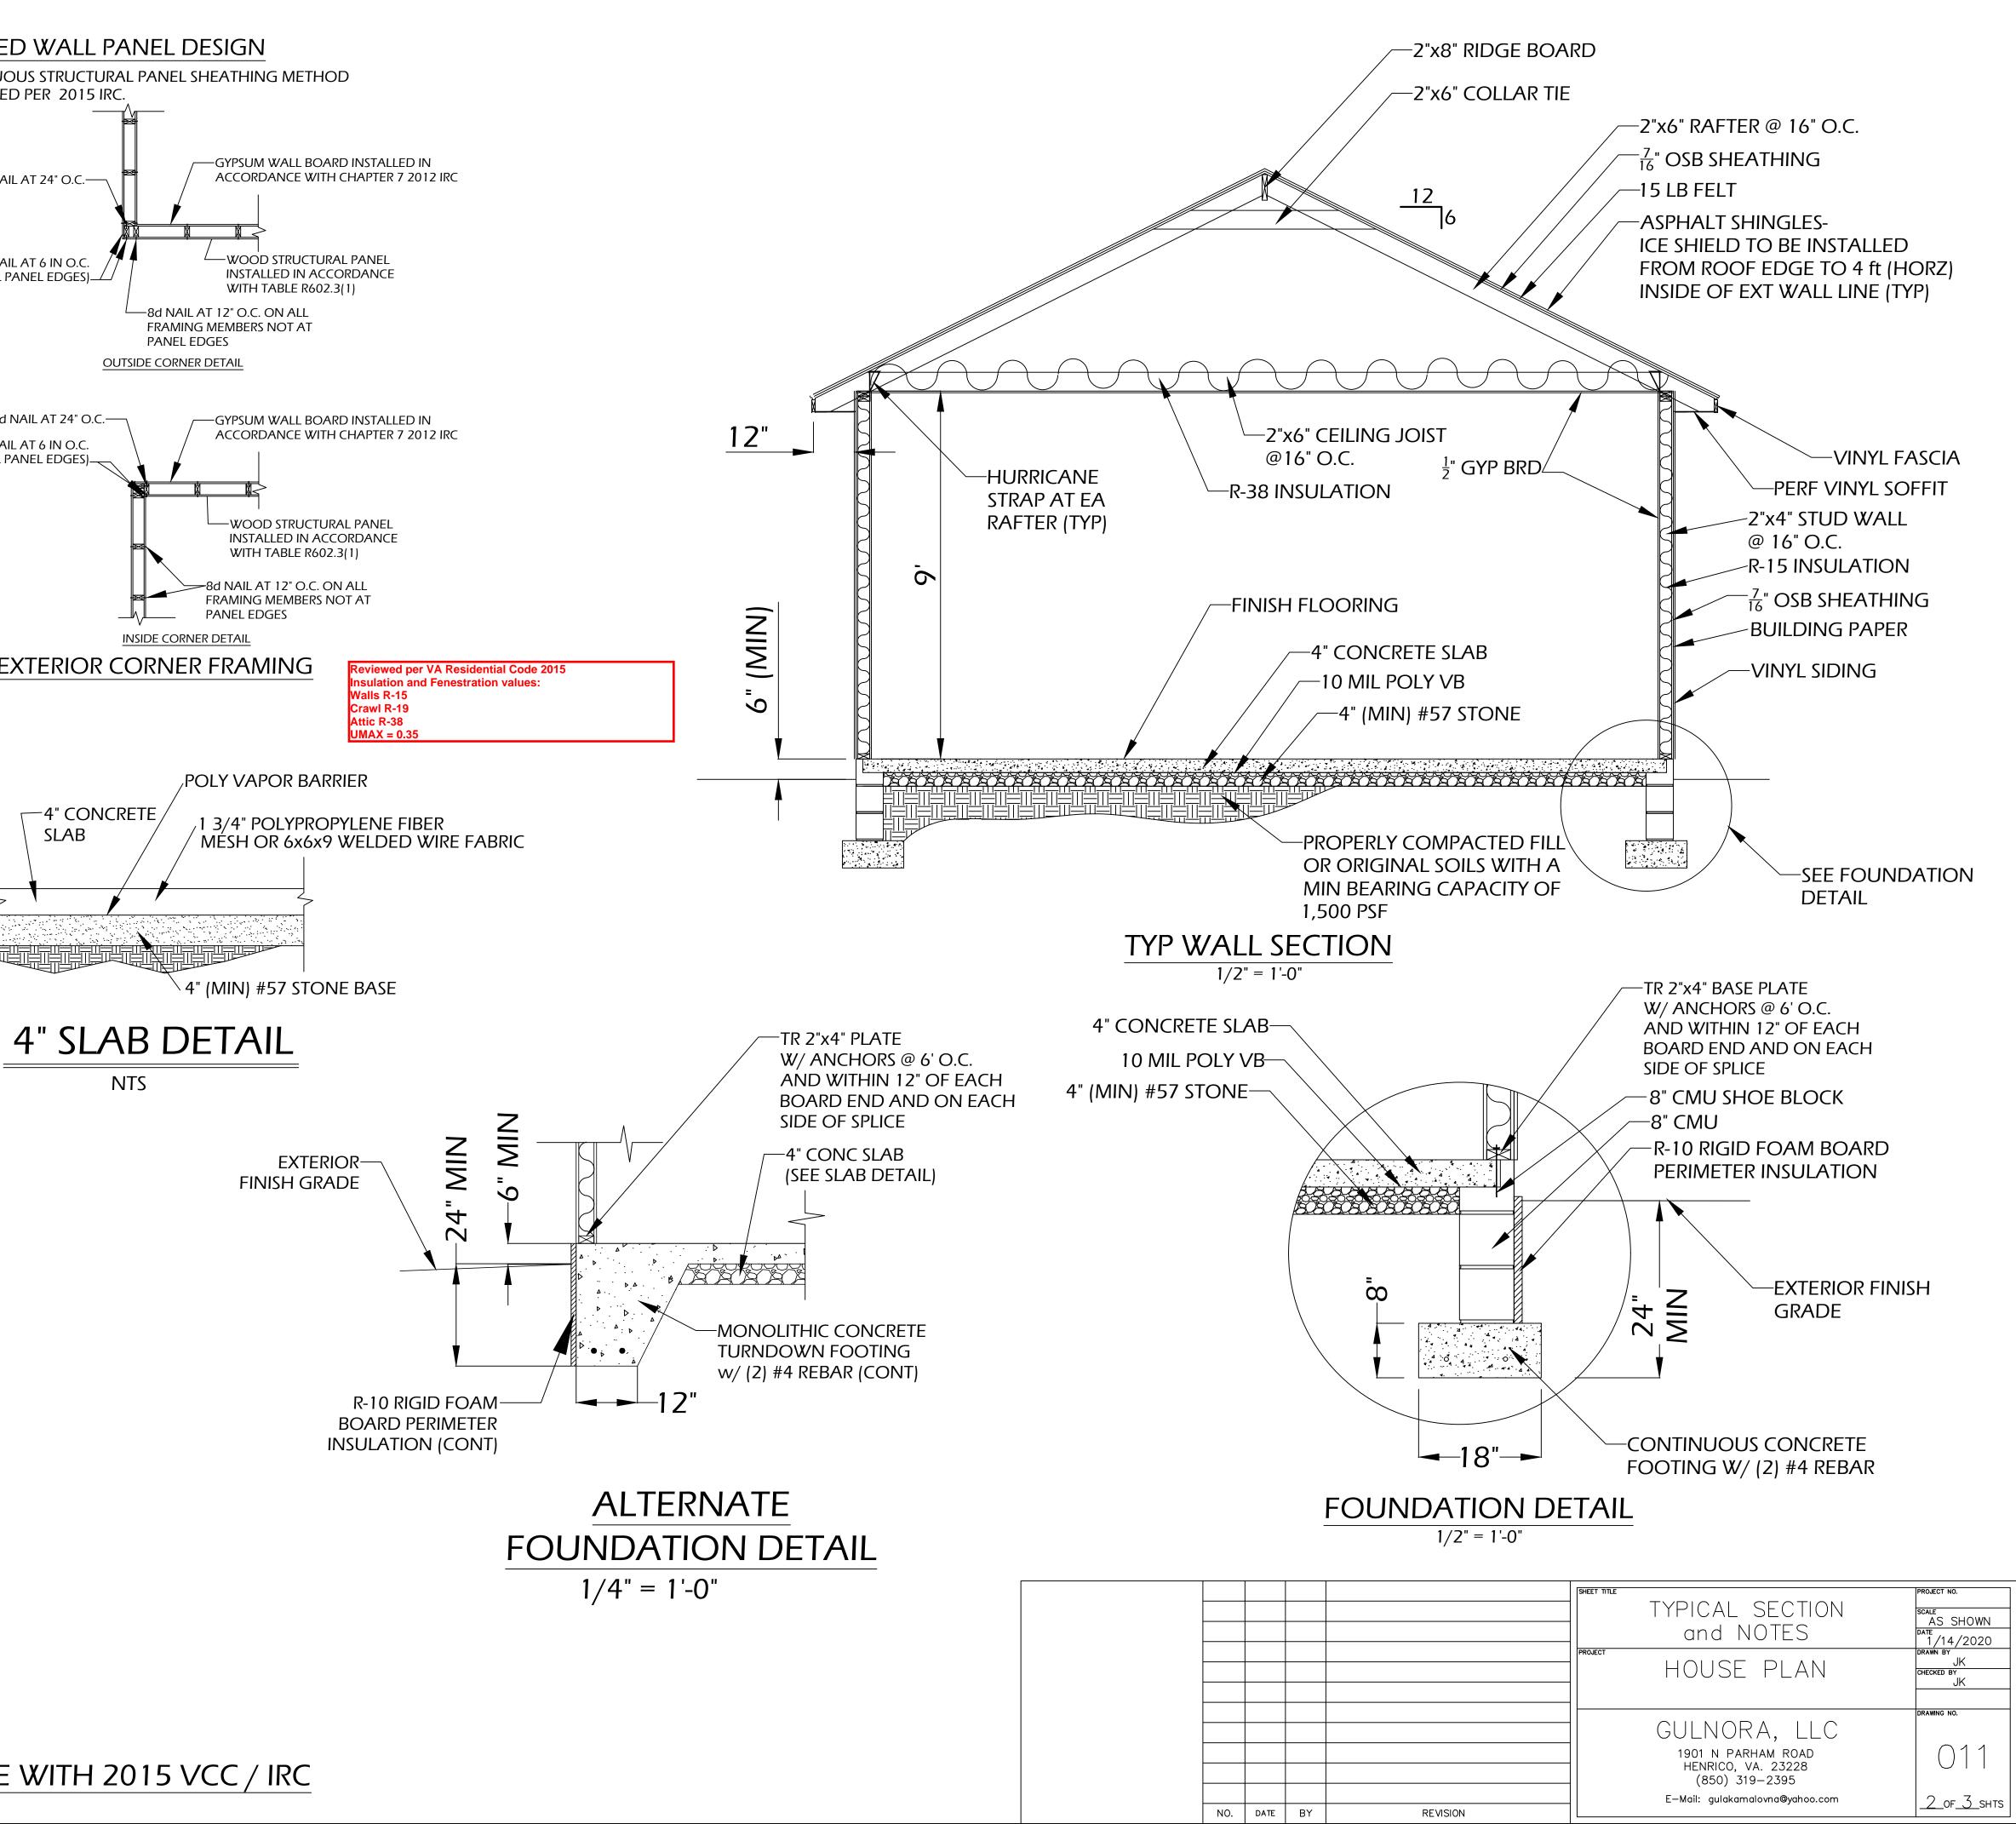


DESIGN LOADS

DESIGN FIRST FLOOR LIVE LOAD: 40 PSF DESIGN ROOF LIVE LOAD (SNOW) : 20 PSF ULTIMATE DESIGN WIND LOAD Vult (3 SEC GUST) : 115 MPH

ROOF FRAMING PLAN NOTES

A ALL HEADERS SHALL BE $2-2\times10$ UNLESS OTHERWISE NOTED ON PLAN CONTRACTOR SHALL PROVIDE 3 GANG STUDS (G.S.) MINIMUM UNDER В ALL BEAMS AND GIRDERS UNLESS OTHERWISE NOTED ON PLAN ALL EXTERIOR WALLS SHALL BE SHEARWALL "1" AS PER THE SHEAR WALL SCHEDULE UNLESS OTHERWISE NOTED

SHEAR WALL SCHEDULE						
MARK	SHEATHING	EDGE NAILING	FIELD NAILING	NAIL TYPE		
SW-1	7/16" OSB ONE SIDE	6	12	8d		
SW-2	7/16" OSB ONE SIDE	4	12	10d		

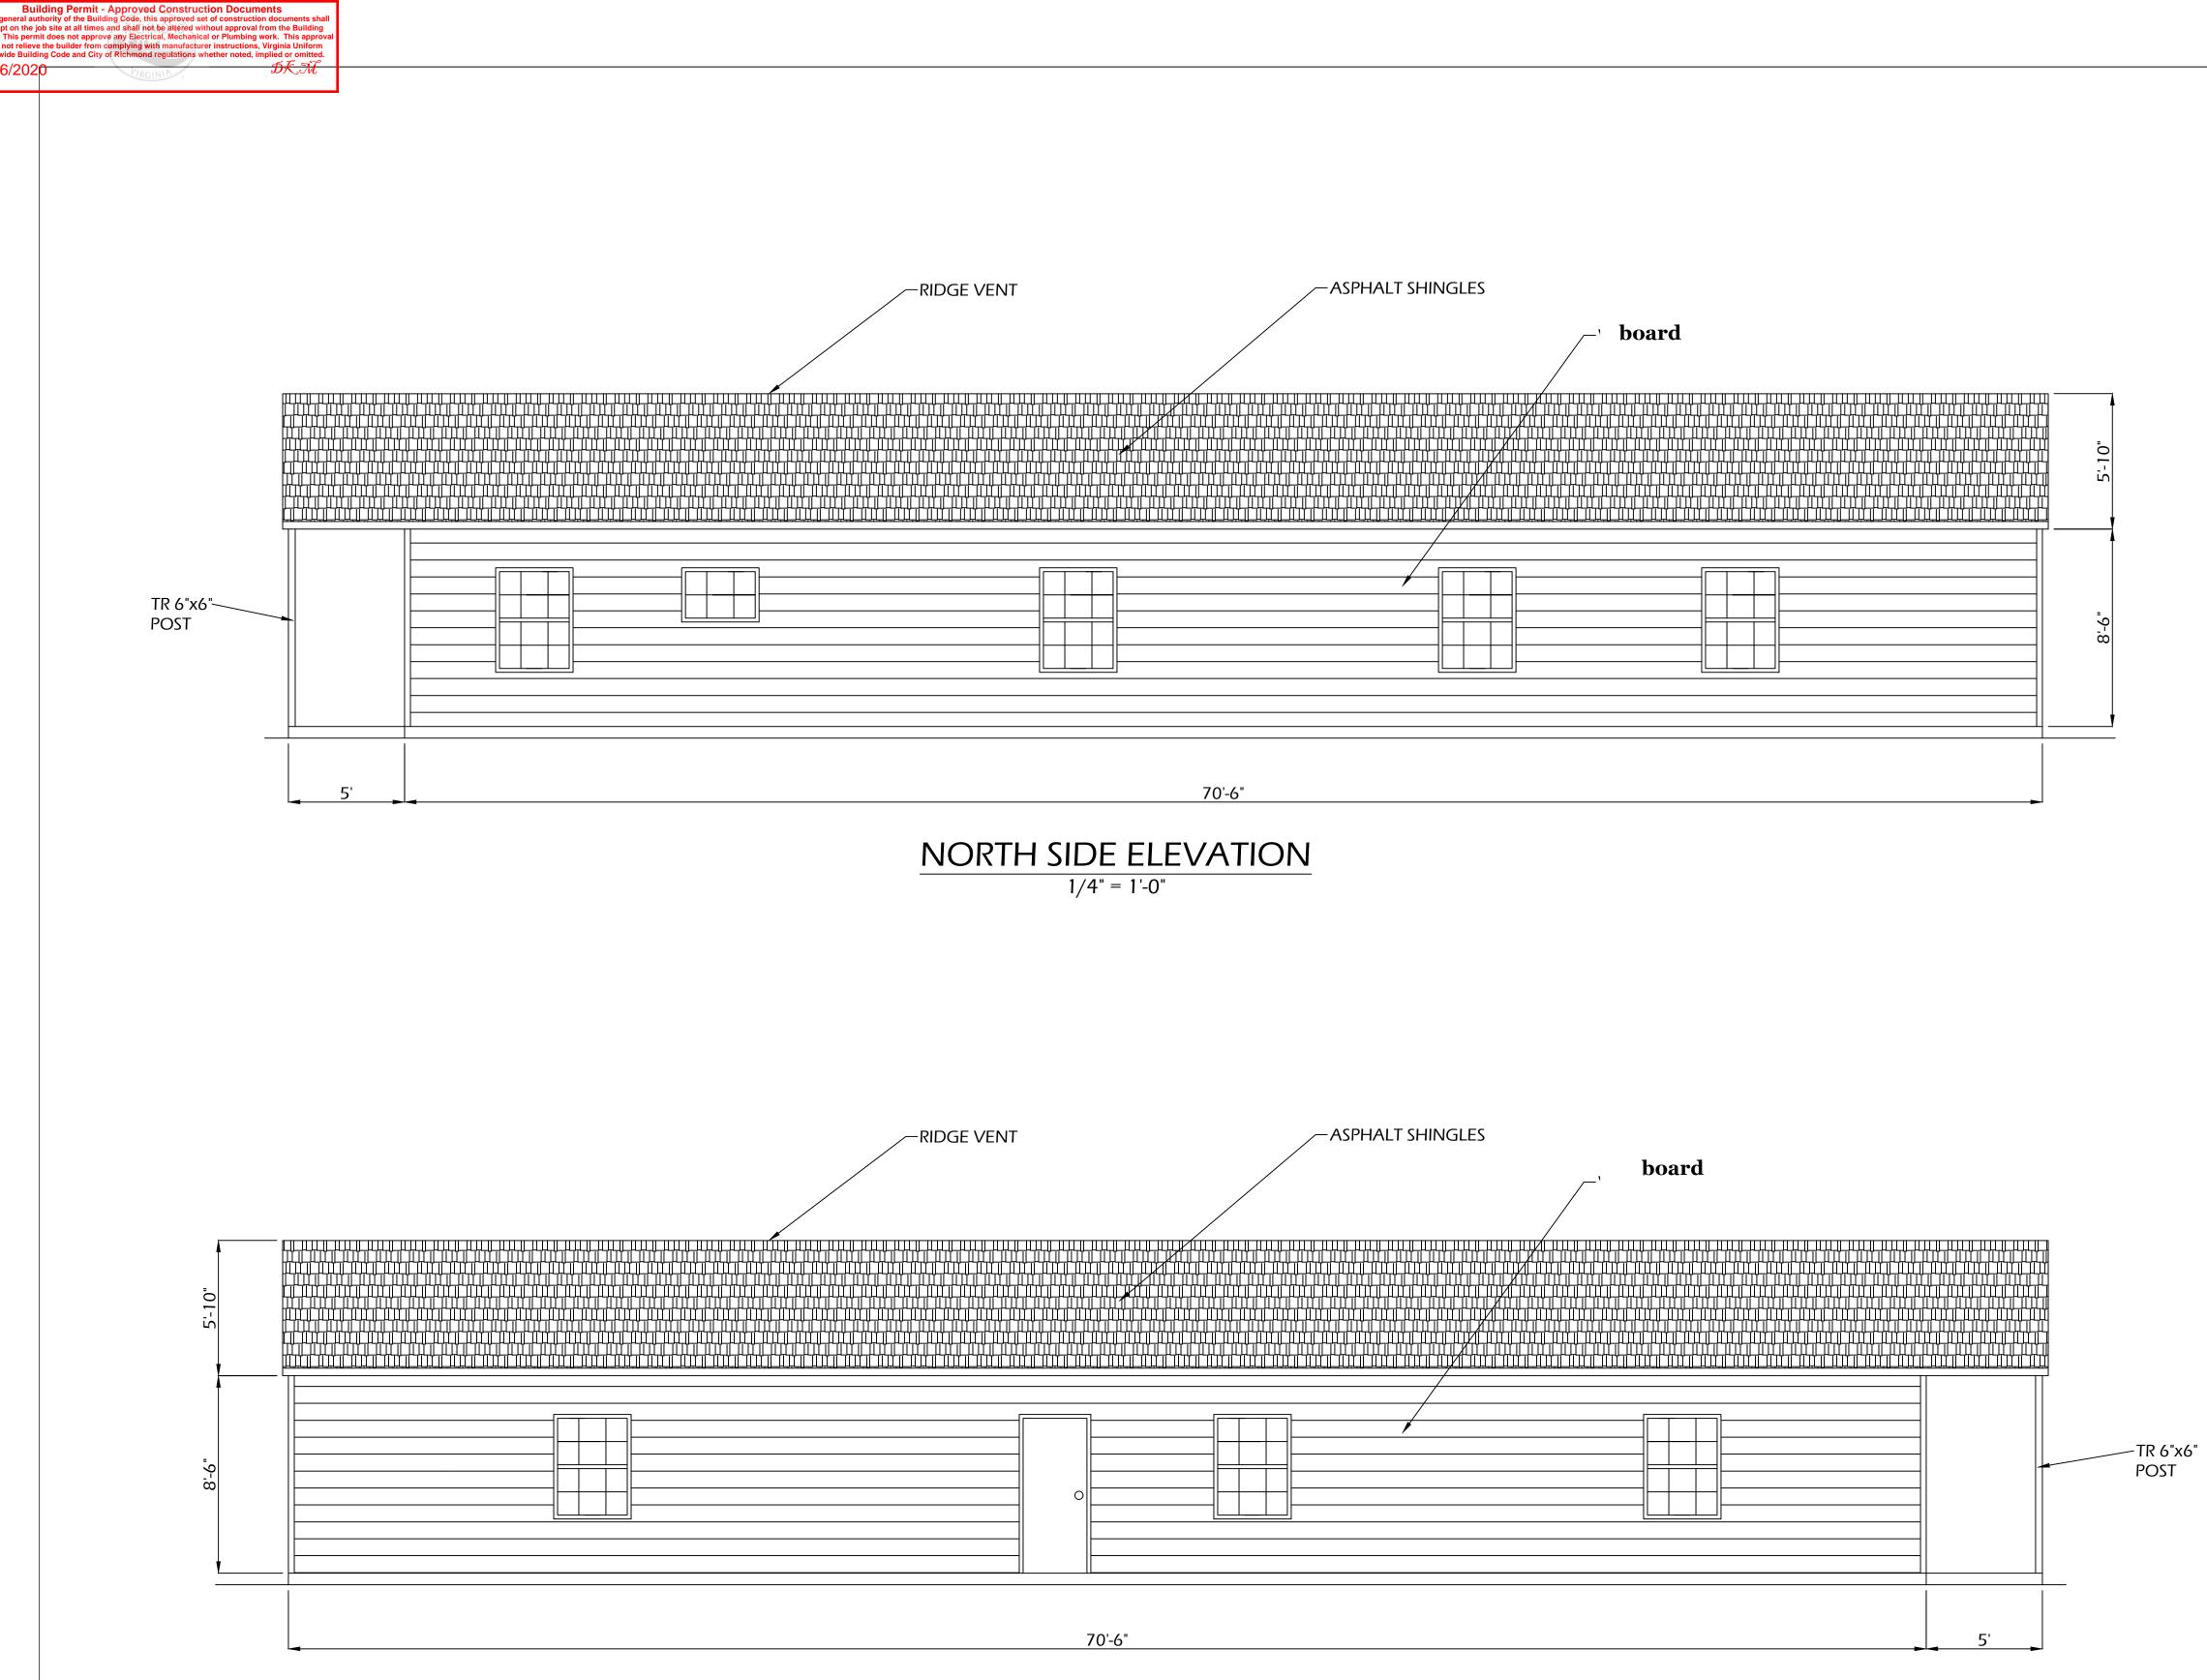

SOUTH SIDE ELEVATION

1/4" = 1'-0"

ALL WORK TO BE IN COMPLIANCE WITH 2015 VCC / IRC

