

## Commission of Architectural Review Certificate of Appropriateness Application

900 E. Broad Street, Room 510 Richmond, VA 23219 804-646-6569

Property (location of work)		D 00
Property Address: 2316 Burton st and 2318 Burton st		Current <u>Zoning</u> :R-63
Historic District: Union Hill		
Application is submitted for: (check one)		
☐ Alteration		
☐ Demolition		
■ New Construction		
Project Description (attach additional sheets if needed):		
Build single family attached townhouse dwelling		
Applicant/Contact Person: Stanislav Lobkov		·
Company:		
City: Richmond	State: VA	Zip Code: <u>23221</u>
	_State: VA	Zip Code: <u>2022 i</u>
Telephone: (347 )4469445 Email: stan.lv1988@gmail.com	-	
Billing Contact? Yes Applicant Type (owner, architect, etc.): Ow	ner	_
Durant - O Stanislav I obkov		
Property Owner: Stanislav Lobkov		
If Business Entity, name and title of authorized signee: Mailing Address: 4501 Patterson ave		
City: Richmond	Stato: VA	Zip Code: <sup>23221</sup>
Telephone: (347 ) 4469445	State.	Zip Code.
Email: stan.lv1988@gmail.com		
Billing Contact? Yes		_
**Owner must sign at the bottom of this page**		
owner must sign at the socion of this page		
Acknowledgement of Responsibility		
Compliance: If granted, you agree to comply with all conditions of the	certificate of an	propriateness (COA). Revisions to
approved work require staff review and may require a new applicatio		
Review (CAR). Failure to comply with the conditions of the COA may		
for one (1) year and may be extended for an additional year, upon wri		
To the (1) year and may be extended for an additional year, apon with	tterrrequest aria	r payment of associated rec.
Requirements: A complete application includes all applicable informa	tion requested or	n checklists available on the CAR websit
to provide a complete and accurate description of existing and propos	=	
Applications proposing major new construction, including additions, s		
requirements prior to submitting. Owner contact information and sign		
be considered.		арриот постирност оррание постинение
Zoning Requirements: Prior to Commission review, it is the responsib	oility of the applic	cant to determine if zoning approval is
required. Application materials should be prepared in compliance with		
Property Owner Signature:	ľ	Date: 11/27/2023

### Certificate of Appropriateness Application Instructions

Staff Contact: (804)-646-6569 | alex.dandridge@rva.gov

#### **Before You Submit**

In advance of the application deadline, please contact staff to discuss your project, application requirements, and if necessary, to make an appointment to meet with staff for a project consultation. The CAR website has additional project guidance and required checklists: <a href="https://www.rva.gov/planning-development-review/commission-architectural-review">www.rva.gov/planning-development-review/commission-architectural-review</a>.

Application deadlines are firm. All materials must be submitted by the deadline to be considered at the following Commission meeting. Designs must be final at the time of application; revisions will not be accepted after the deadline. Incomplete and/or late applications will not be placed on that month's agenda.

#### **Submission Requirements**

Please submit applications to staff via email with the project address in the subject line. Submit the following items via email to staff:

- One (1) signed and completed application (PDF) property owner signature required.
- Supporting documentation, as indicated on the <u>checklist</u>, which can be found under the 'Application Information' tab on the website.
- Payment of application fee, if required. <u>Payment of the fee must be received before the application will be</u>
   scheduled. An invoice will be sent via the City's Online Permit Portal. Please see <u>fee schedule</u> available on the CAR
   website for additional information.

A complete application includes a signed application form, legible plans, drawings, elevations, material specifications, and payment of the required fee as described in the City Code of Ordinances Sec. 30-930.6(b). The Commission will not accept new materials, revisions, or redesigns at the meeting. Deferral until the following month's meeting may be necessary in such cases to allow for adequate review by staff, Commissioners, and public notice, if required.

#### Meeting Information and Application Due Dates

- The Commission meets on the fourth Tuesday of each month, except for December when it meets on the third Tuesday.
- Application hearings start at 4:00pm. Meetings are held in person at City Hall in the 5<sup>th</sup> floor conference room.
   Participation via Microsoft Teams is available. It is strongly recommended that at least one person, either the owner or applicant, attend the meeting in person.
- All applications are due at 12 noon the Friday after the monthly CAR meeting, except in December, when
  applications are due the following Monday. For a list of meeting dates and submission deadline dates for each
  meeting please visit <a href="https://www.rva.gov/planning-development-review/commission-architectural-review">www.rva.gov/planning-development-review/commission-architectural-review</a> or contact staff.
- Revisions to applications that have been deferred or conceptually reviewed at a CAR meeting can be submitted nine (9) business days after that meeting in order to be reviewed at the following meeting. Please contact staff to confirm this date.
- New construction will be required to go through a conceptual review. The conceptual review is non-binding.
- Applicants are encouraged to reach out to any relevant civic associations and immediate neighbors for new construction or large-scale projects prior to submitting to the Commission of Architectural Review.

Gilliam Design, LLC.

	Sheet List
Sheet Number	Sheet Name
A1	COVER AND ELEVATIONS
A2	FOUNDATION AND FRAMING
A3	FIRST FLOOR AND FRAMING
A4	SECOND FLOOR AND FRAMING
A5	SECTIONS AND ROOF PLAN
A6	DETAILS
A7.1	WIND BRACING DIAGRAM-1ST FLOOR
A7.2	WIND BRACING DIAGRAM-2ND FLOOR


SQUARE FO	OTAGE-1 UNIT
Name	Area
1ST FLOOR	465 SF
2ND FLOOR	439 SF
FRONT PORCH	64 SF


1ST FLOOR 465 SF	Range	2ND FLOOR 439 SF
FRONT PORCH		
4 1ST FLOOR 1/8" = 1'-0"	5	2ND FLOOR 1/8" = 1'-0"


Door Sched	dule	
Level	Count	Mark
FOUNDATION	1	ACCESS
1ST FLOOR	1	3068
1ST FLOOR	1	3068
1ST FLOOR	1	2868
2ND FLOOR	1	2668
2ND FLOOR	1	2468
2ND FLOOR	1	2468
2ND FLOOR	1	2668
2ND FLOOR	1	2468
2ND FLOOR	1	2668
2ND FLOOR	1	2468
2ND FLOOR	1	2468
2ND FLOOR	1	2668
2ND FLOOR	1	2468
Grand total: 17		

Wine	dow Schedule	
Level	Count	Туре
ST FLOOR	1	3046
ST FLOOR	1	28x32
ST FLOOR	1	3046
ST FLOOR	1	28x32
ND FLOOR	1	3046



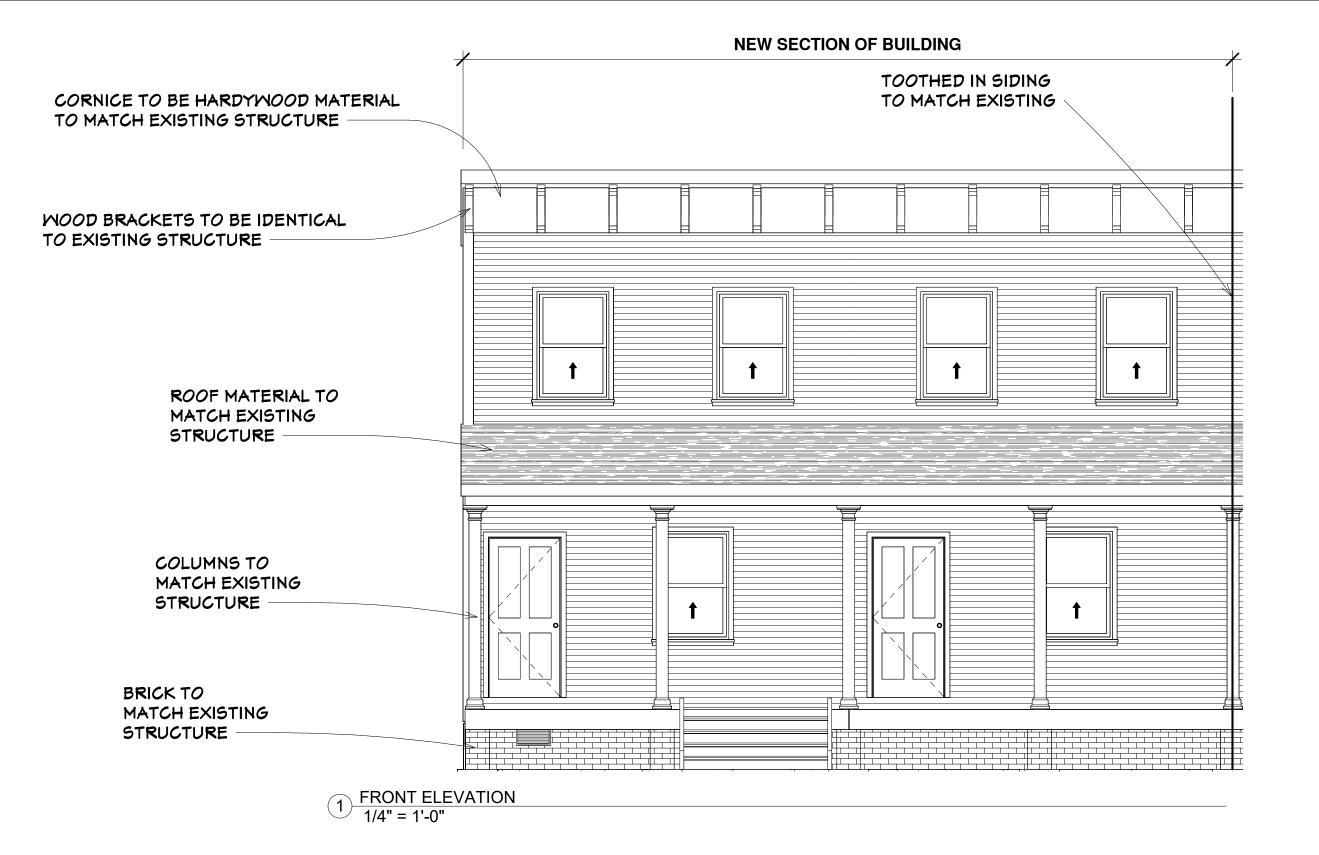


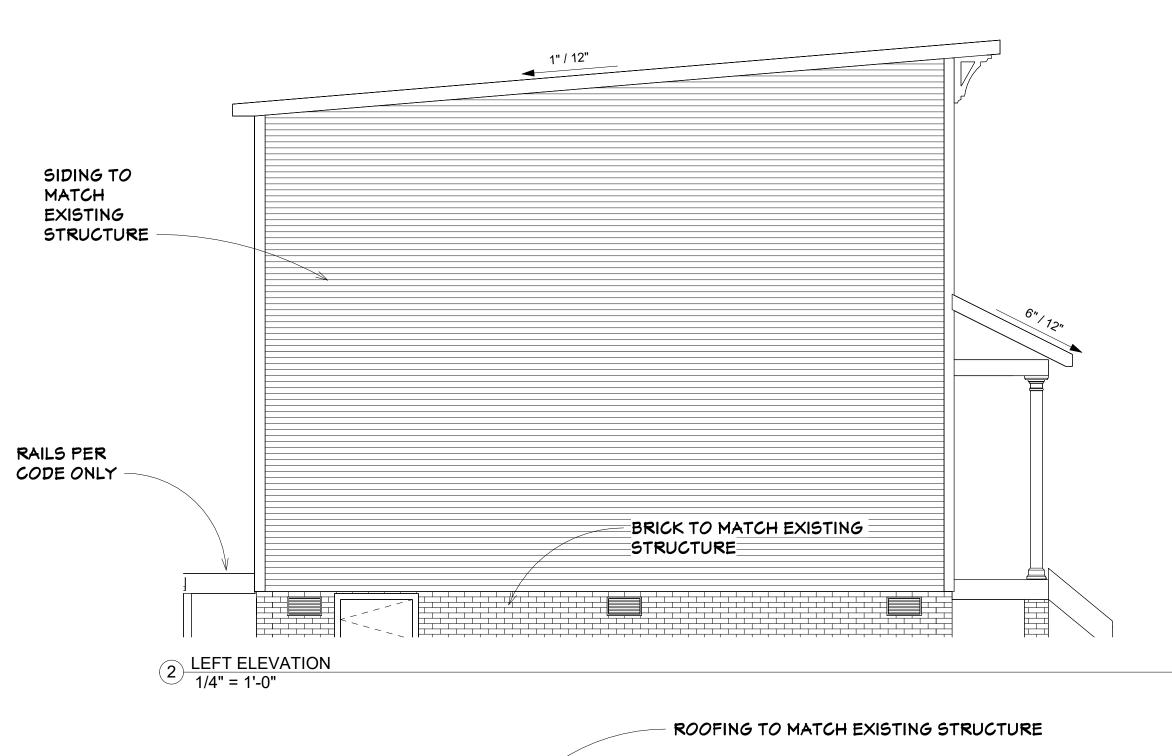

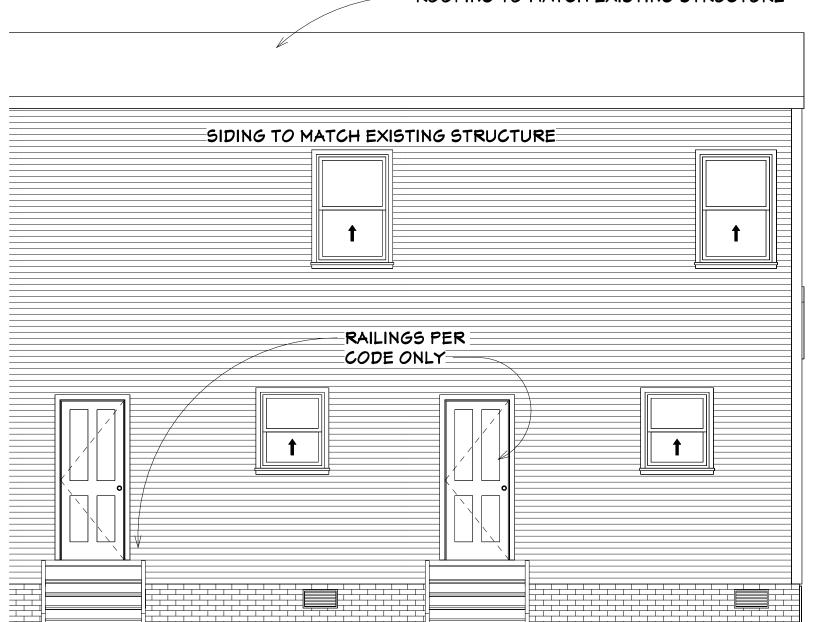



2316-BURTON-STREET




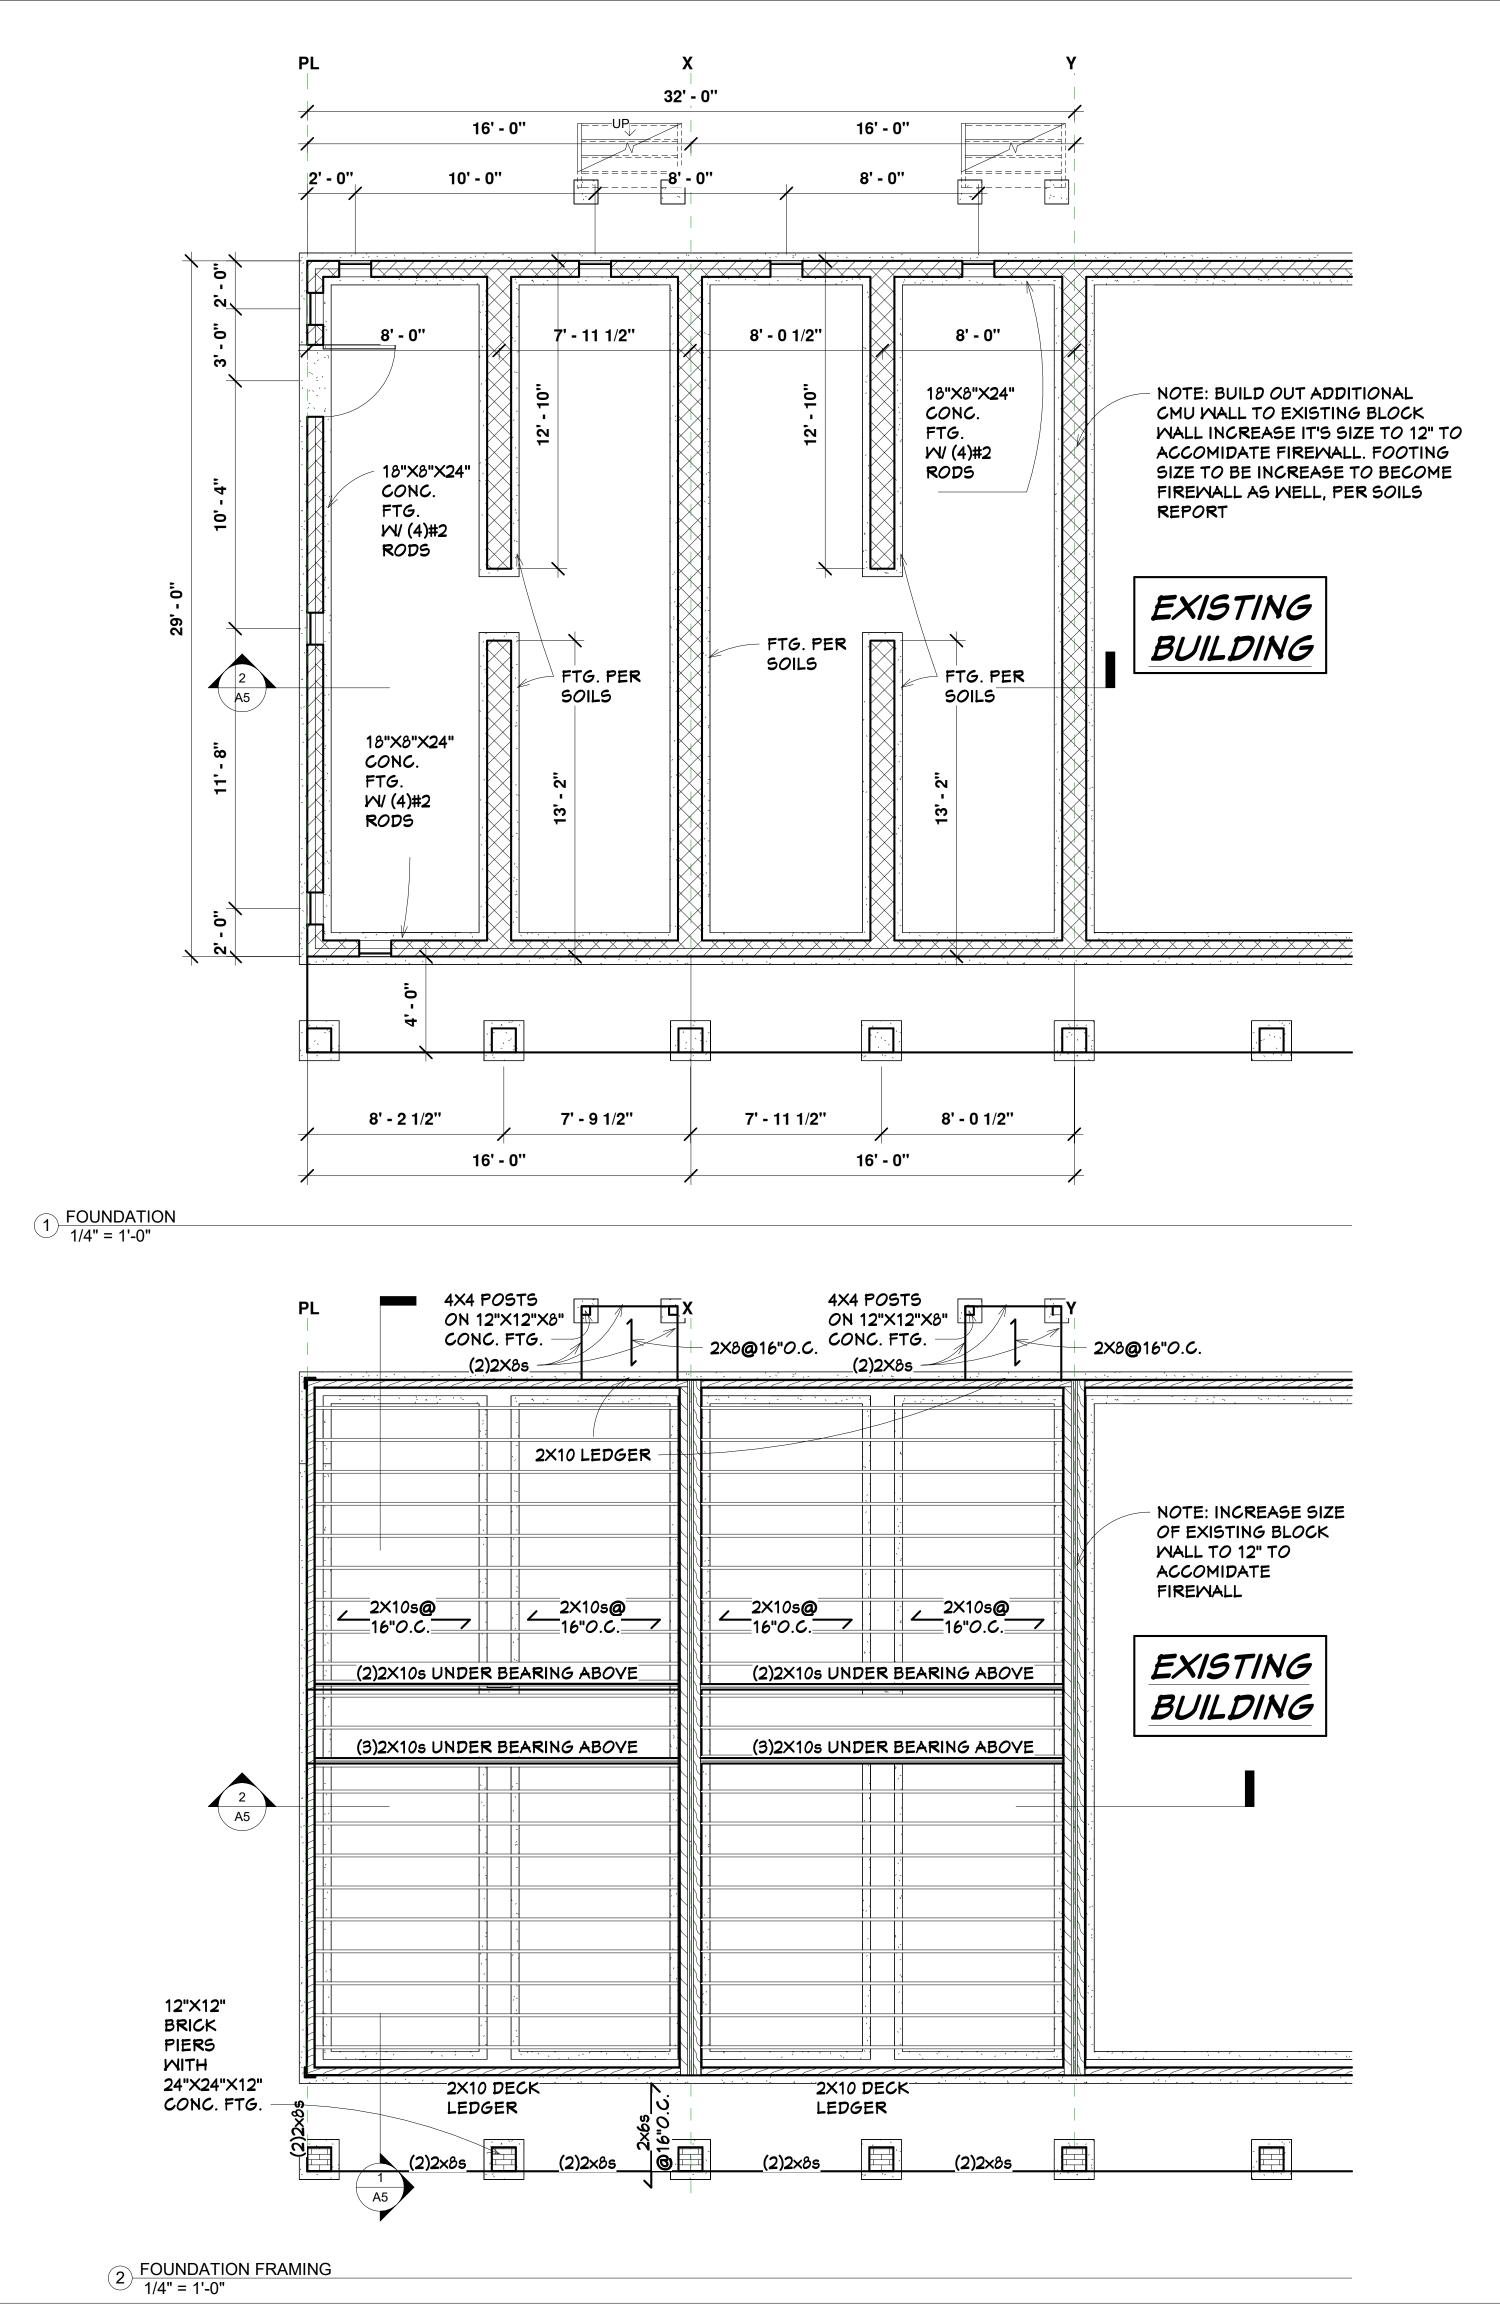



2316-BURTON-STREET

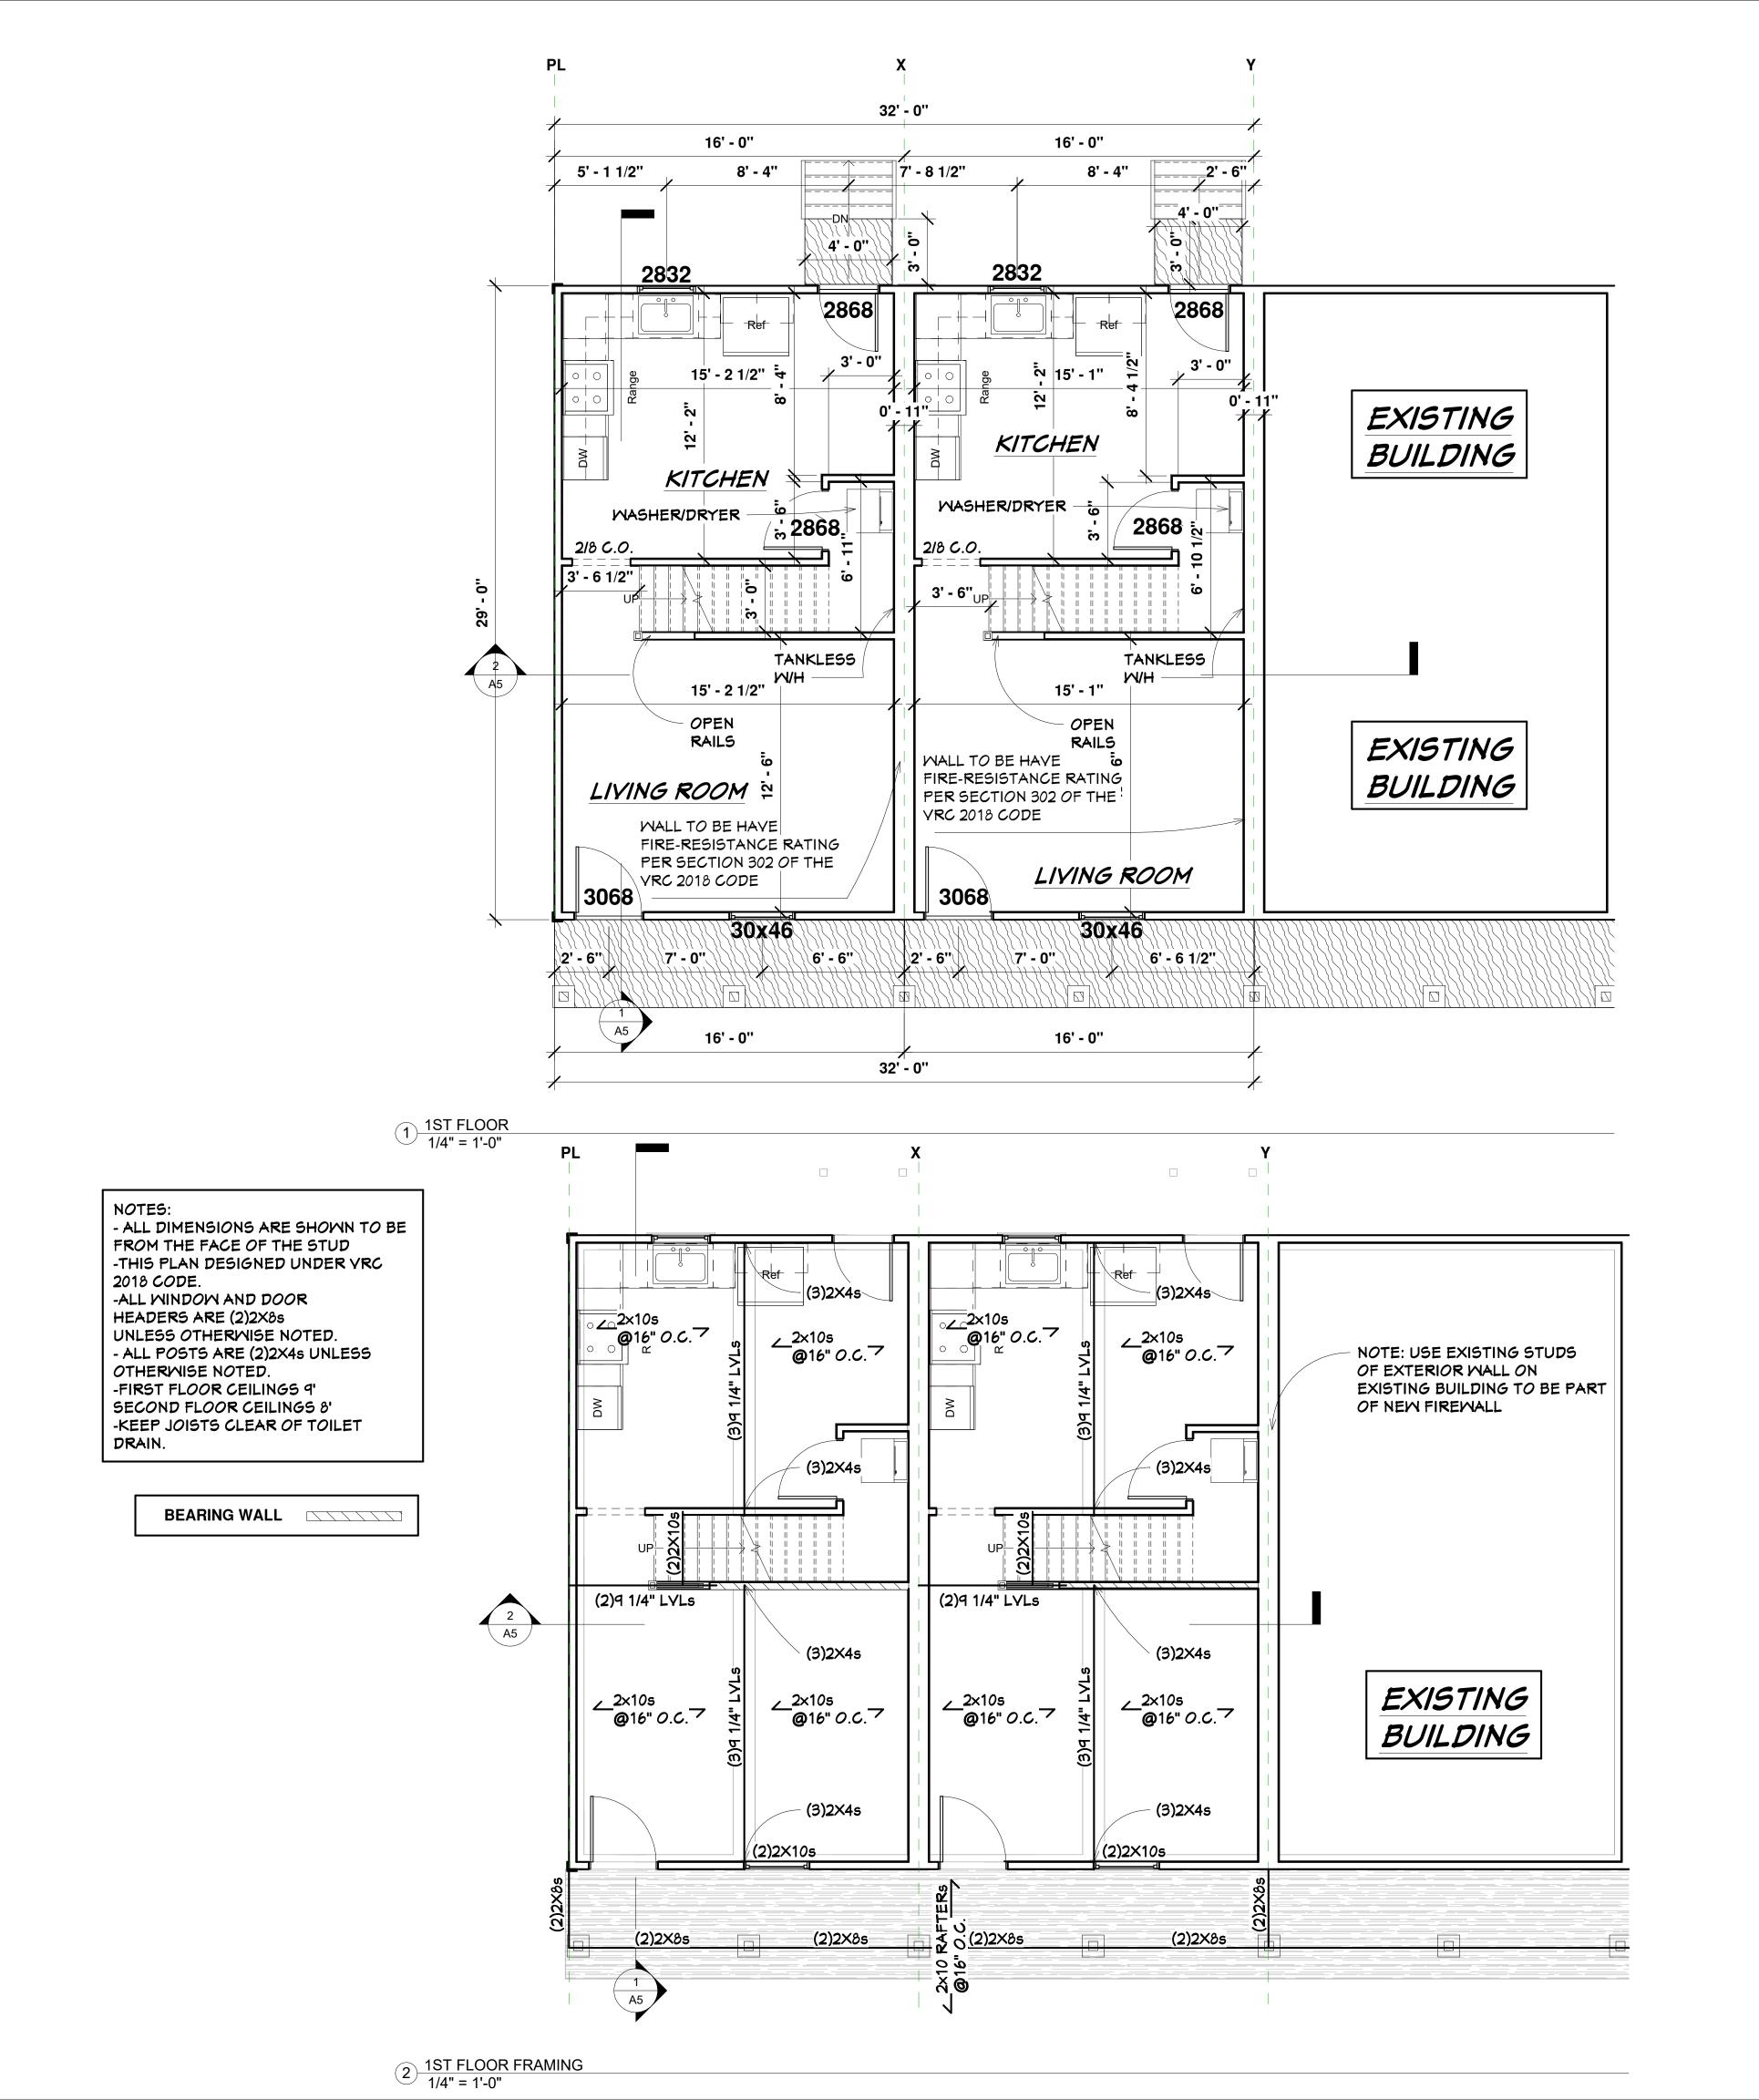

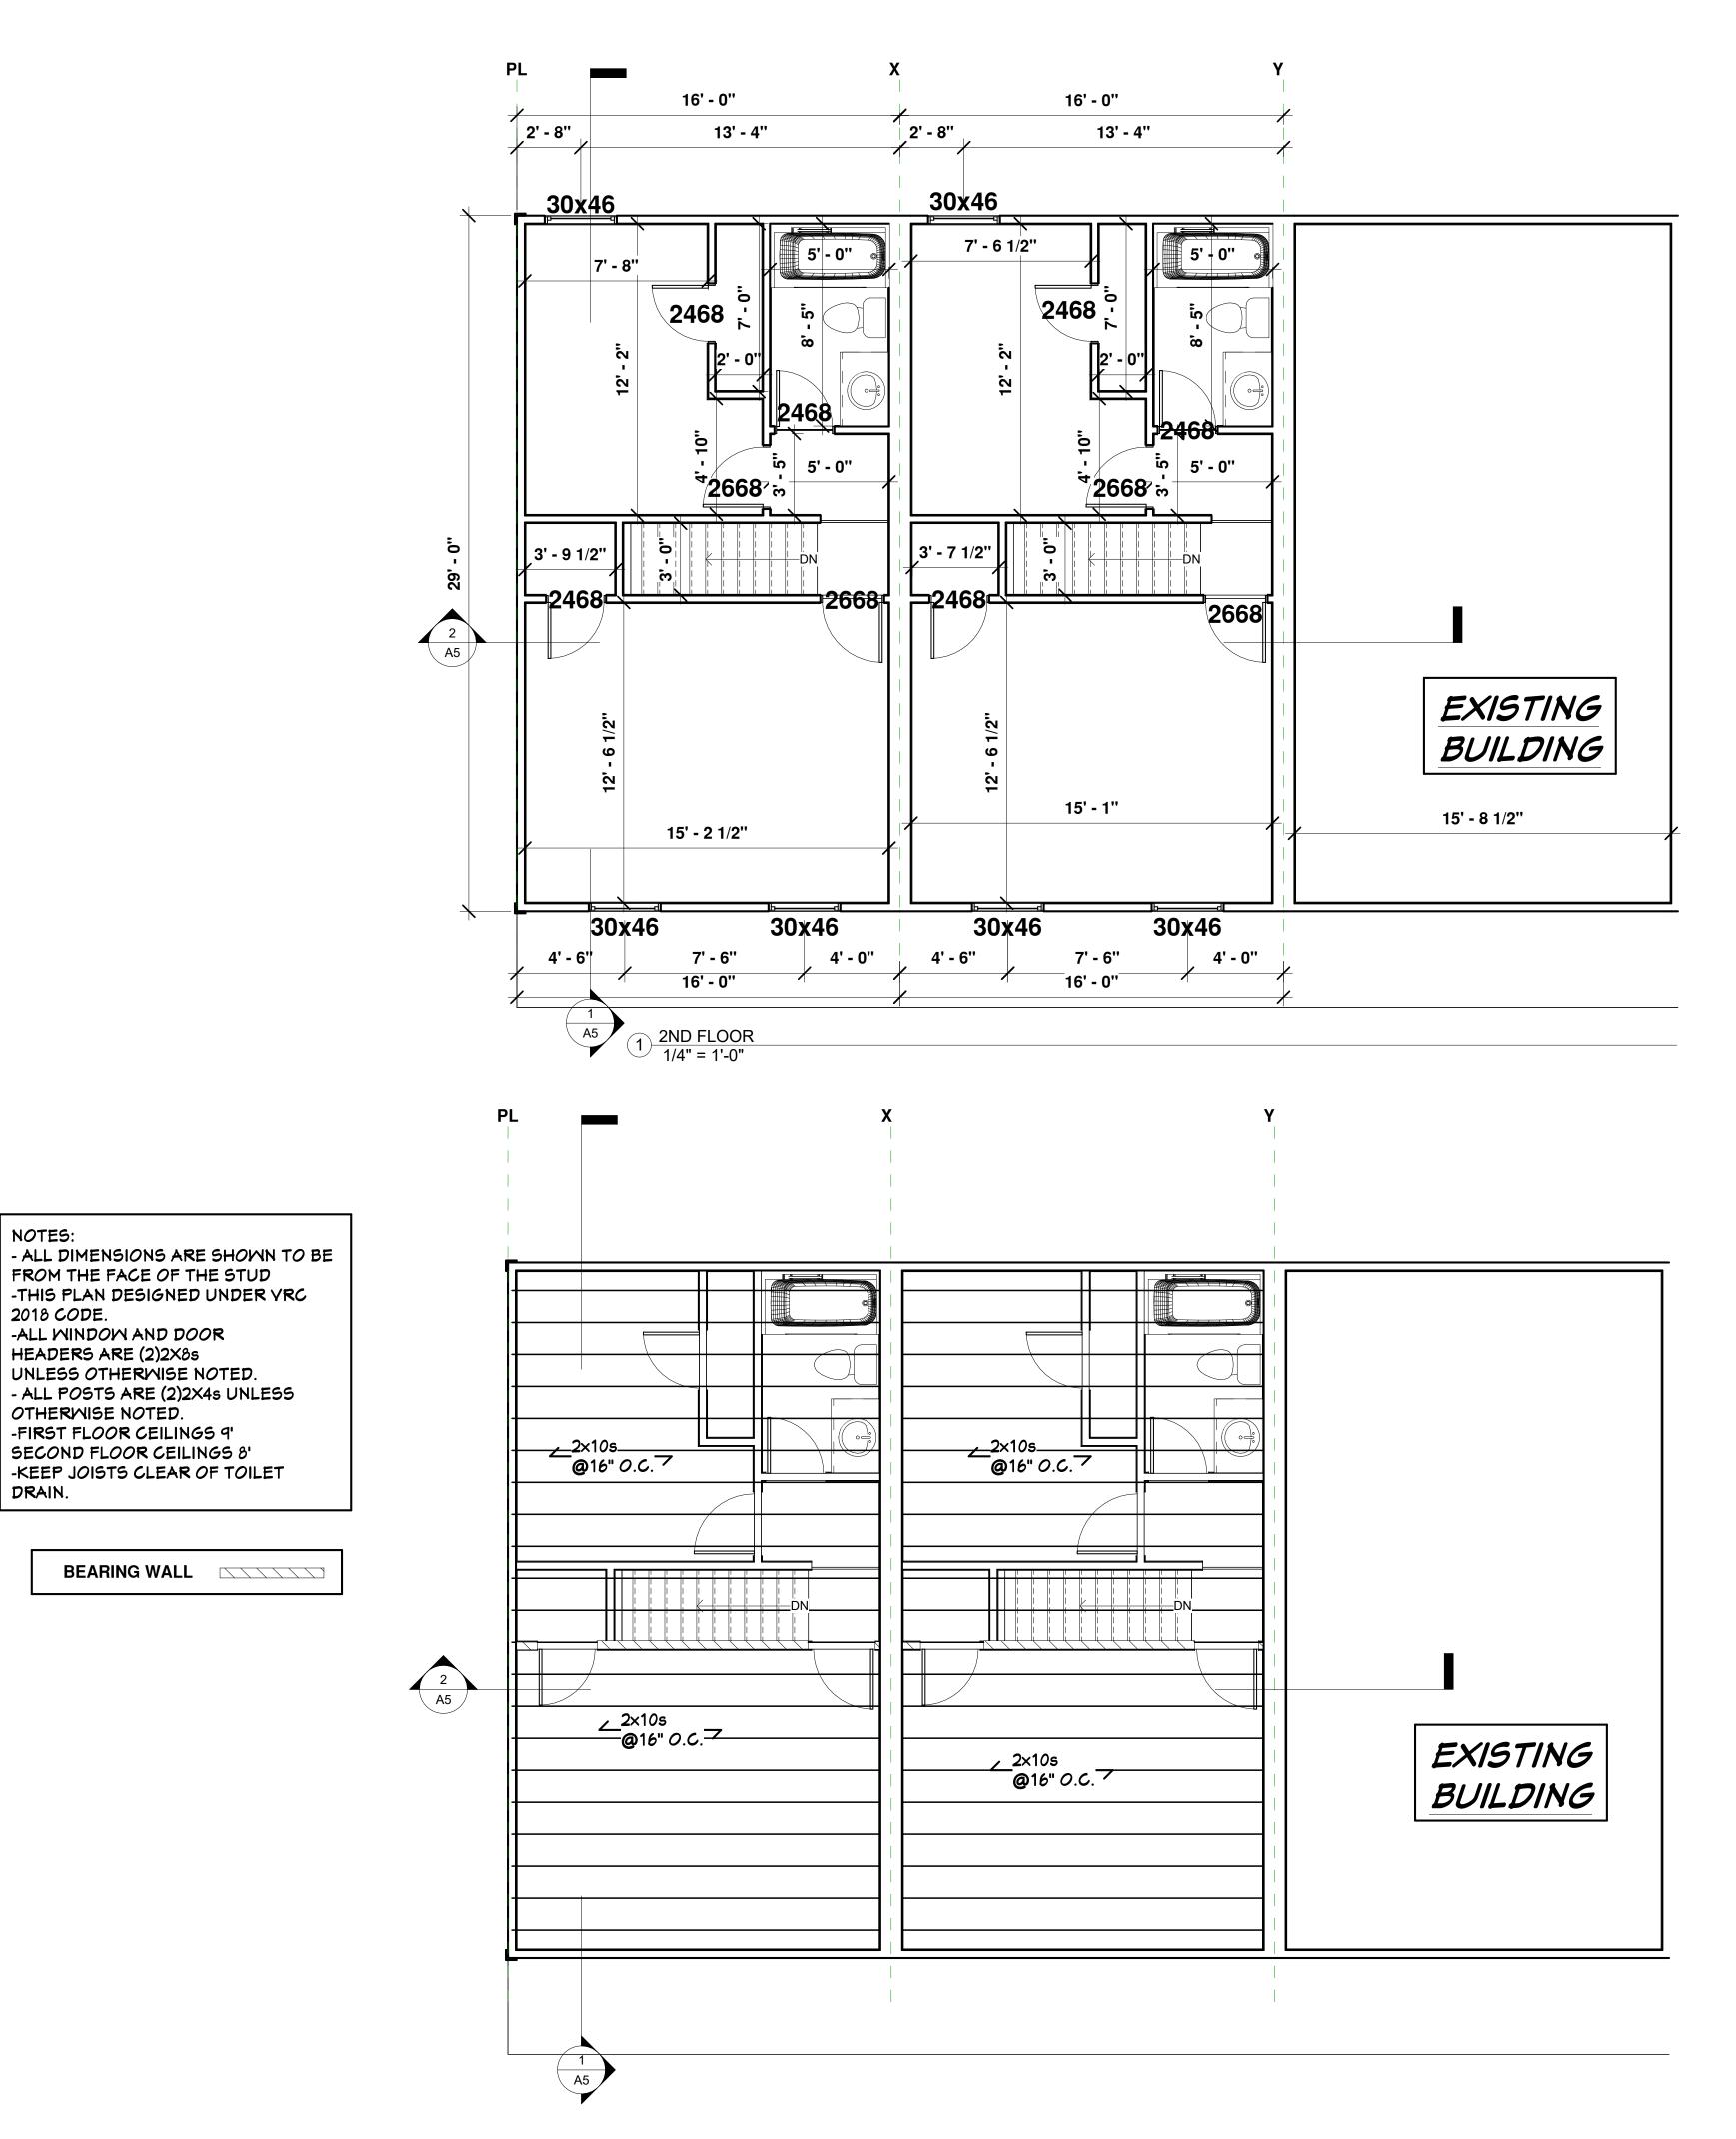

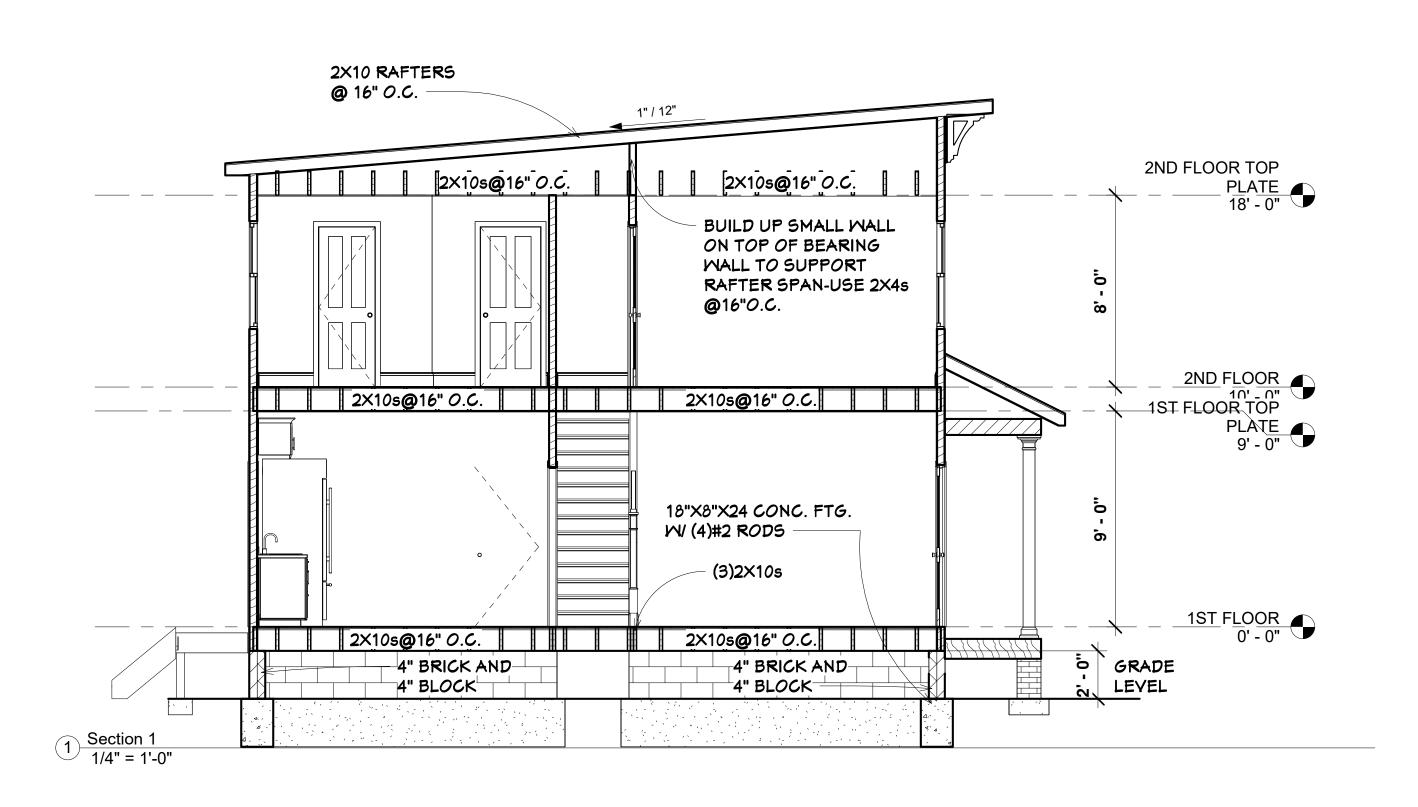


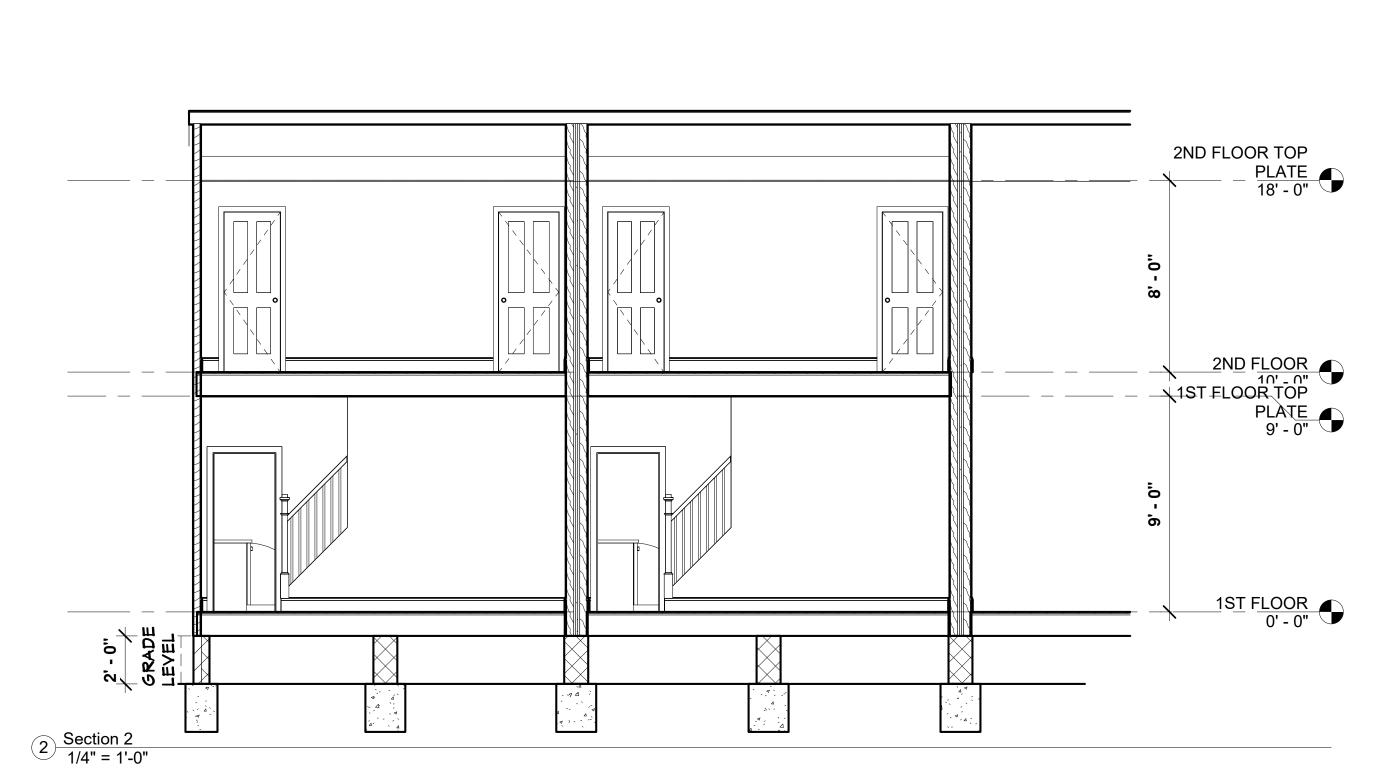

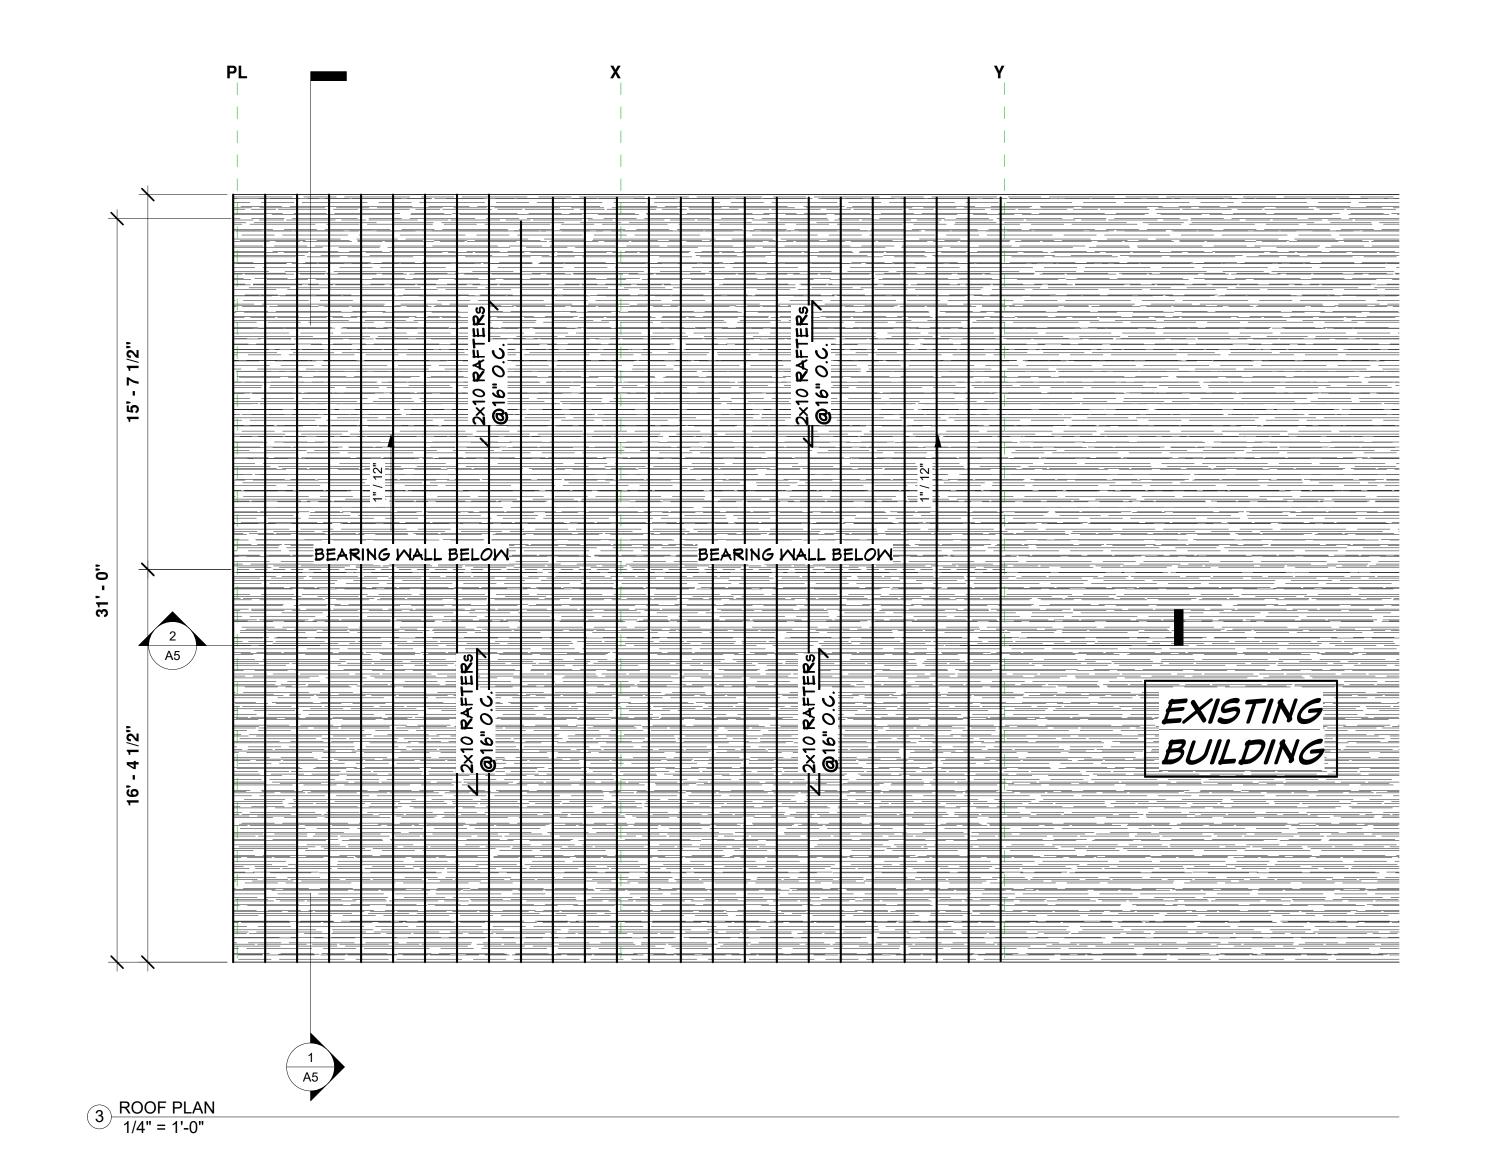


Gilliam Design, LLC.

- ASPHALT SINGLES

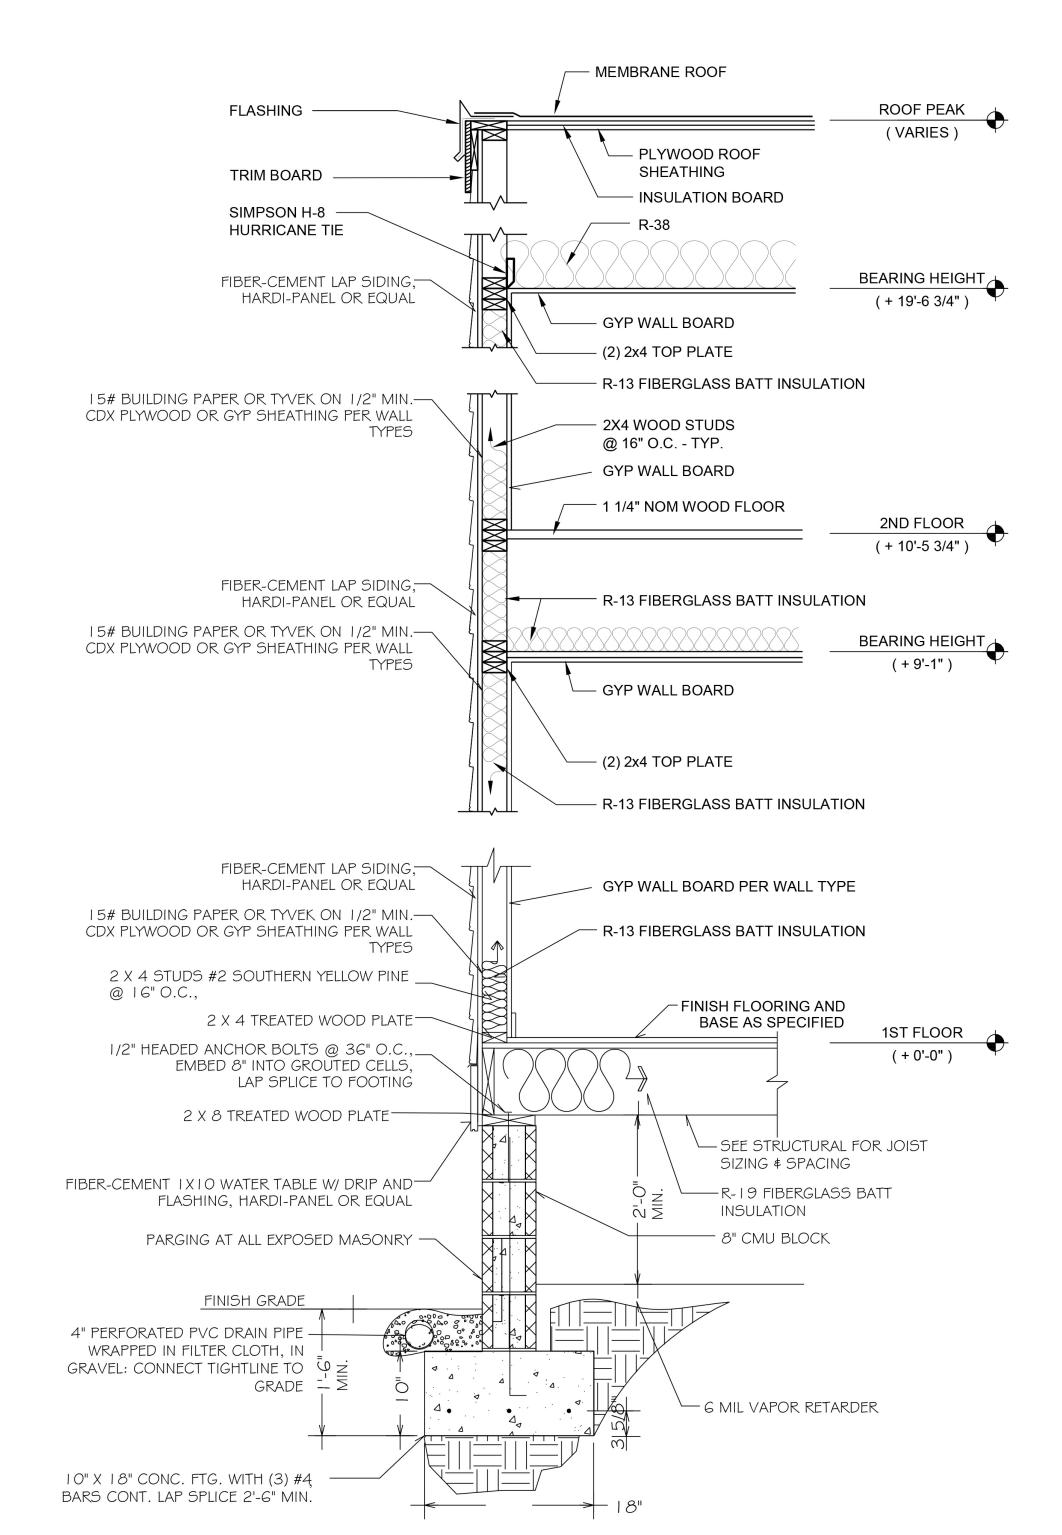


TYPICAL WALL SECTION SCALE: NTS

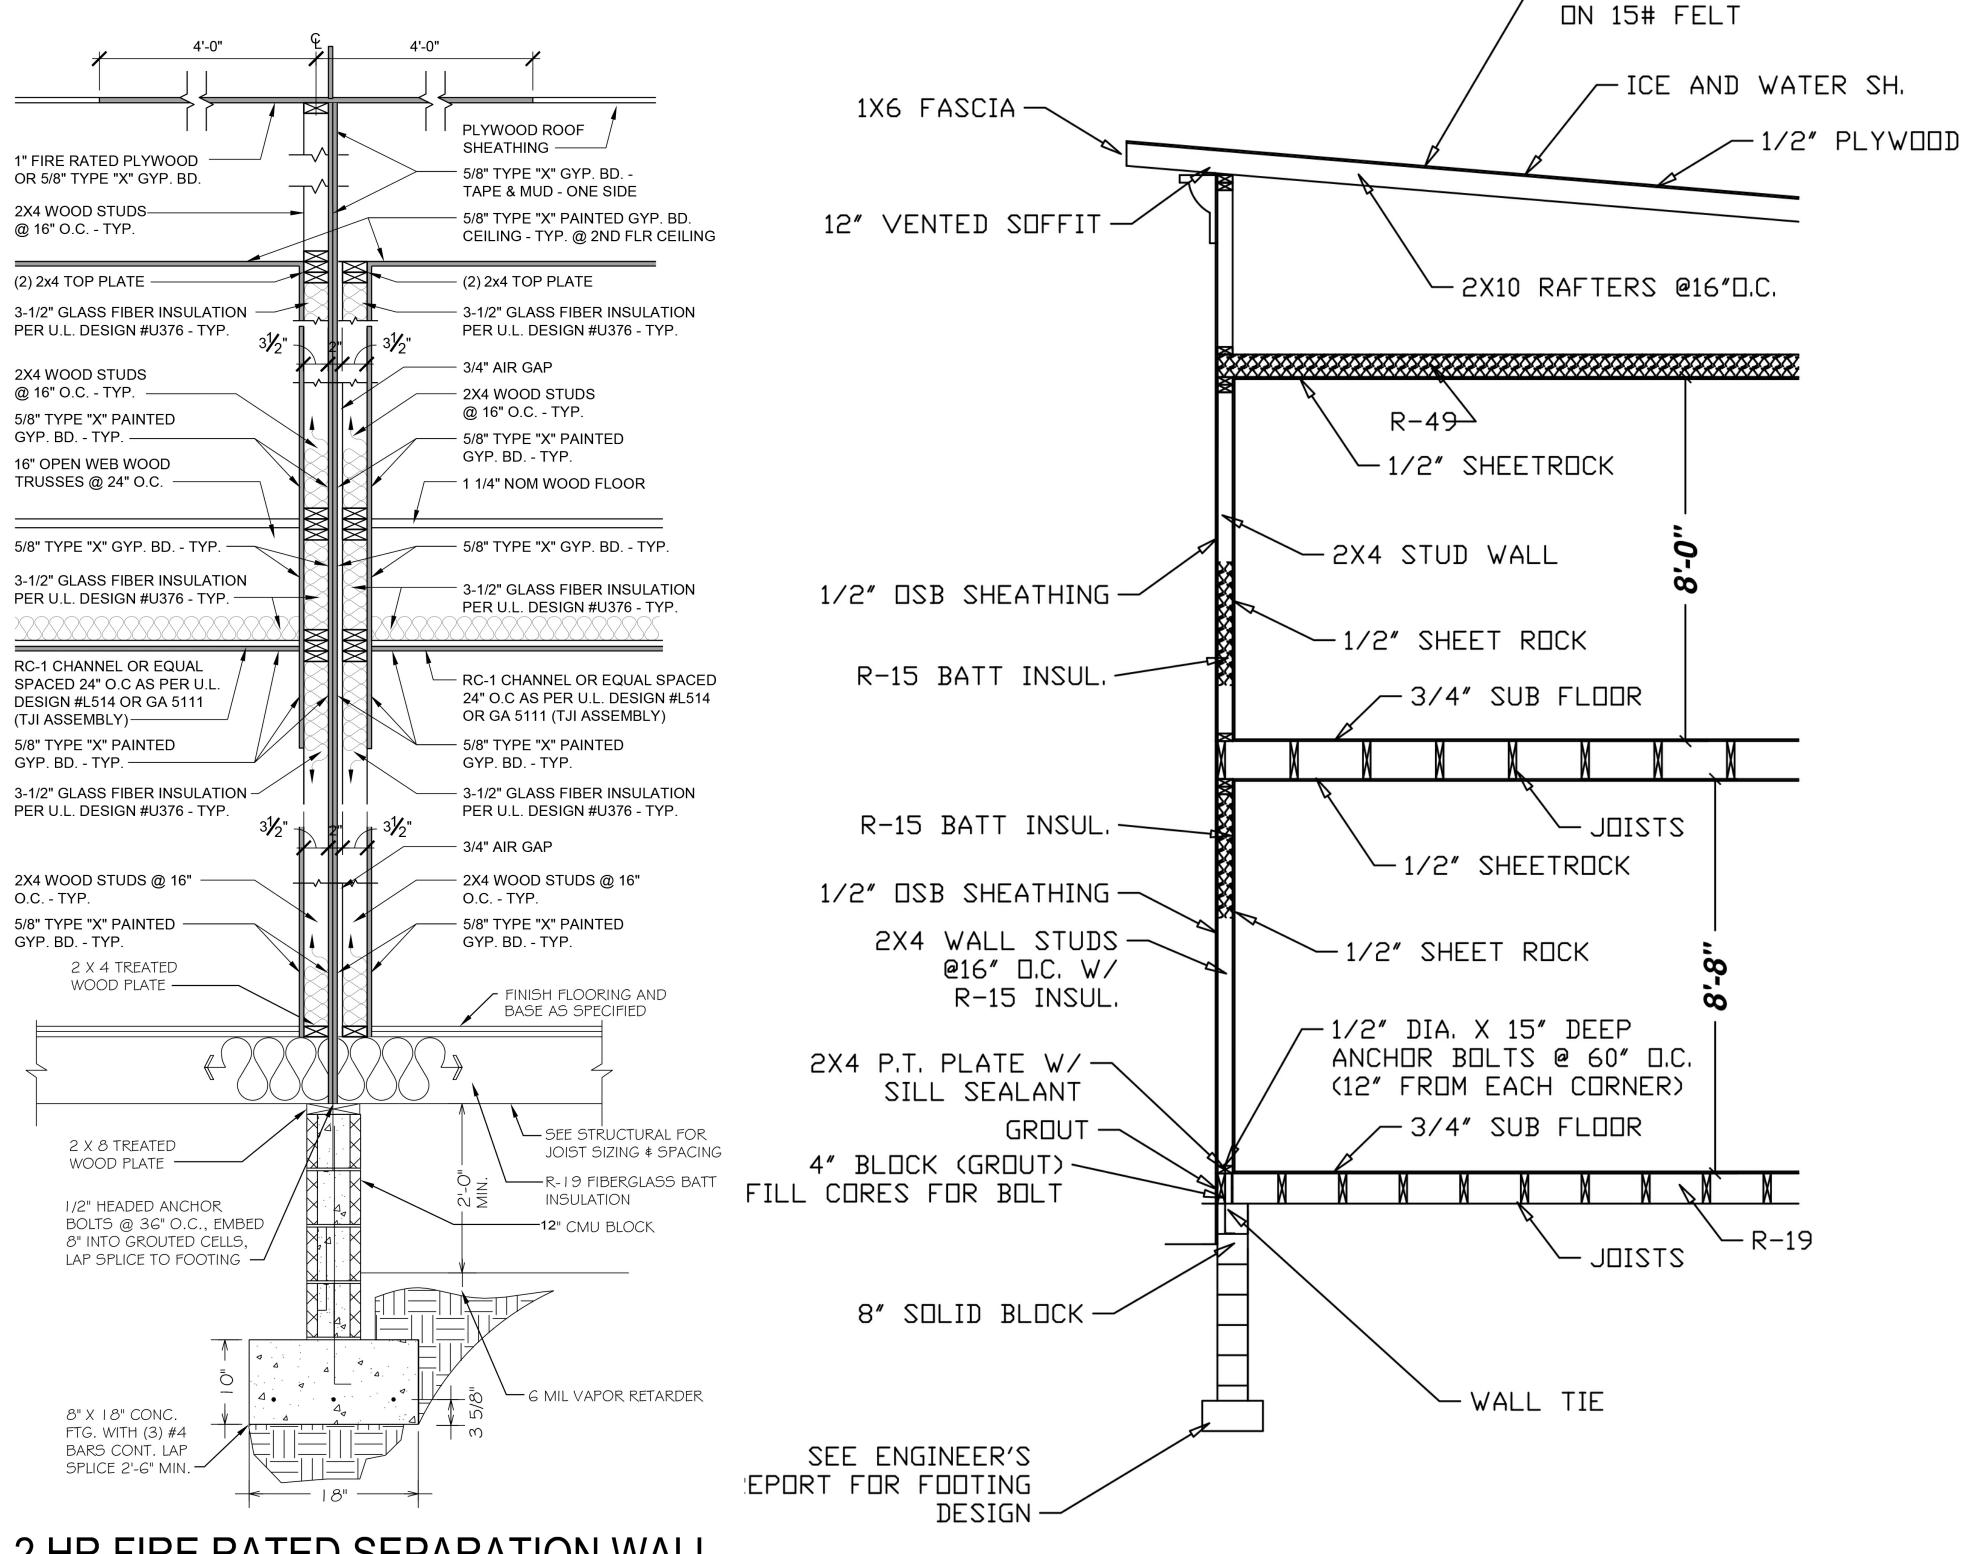

## 2 HR FIRE RATED SEPARATION WALL SCALE: NTS


# WALL SECTION SCALE N.T.S.

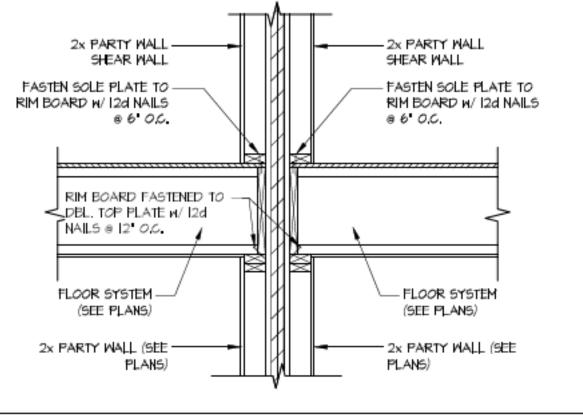

SHEAR TRANSFER DETAIL BYWN FLRS @ PARTY WALL

A6

2316-BURTON-STREET

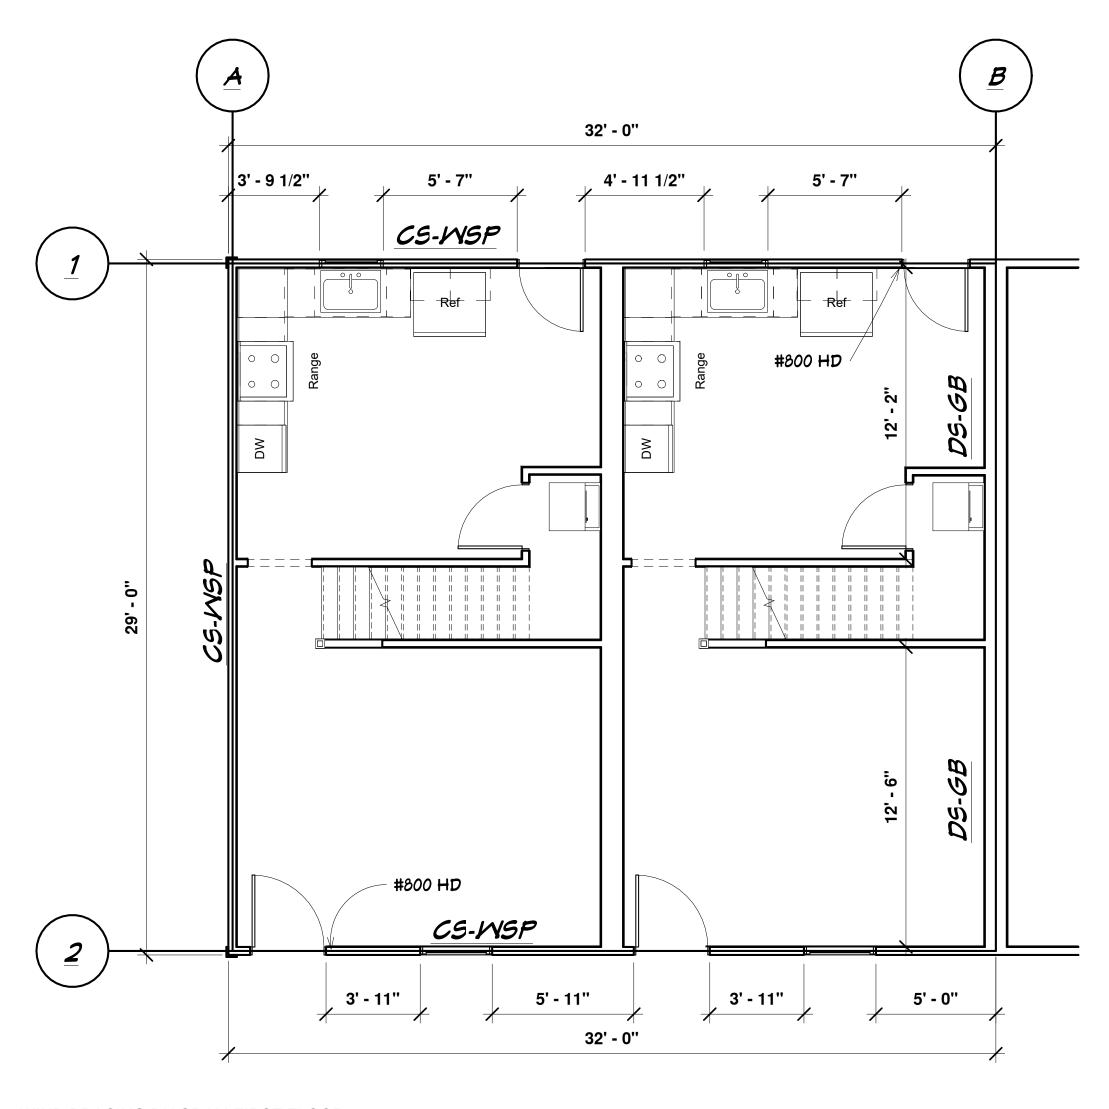

1) WIND BRACING DIAGRAM-FIRST FLOOR 1/4" = 1'-0"

## Classic Wall Bracing Worksheet


Jlt	imate Wind Speed	(mph)	13	30						
	BWL Designation	on	ľ	11	2		А		В	
N	o. of Floors above E	of Floors above BWL 1		1		1		1		
	BWP Method		CS-\	NSP	CS-V	S-WSP CS-WSP		G	GB	
Αι	erage BWL Spacin	3WL Spacing (ft) 29		9	29		32		32	
T	abular Requirement (ft)		11.15		11.15		12.20		24.40	
	Exposure		В	1.00	В	1.00	В	1.00	В	1.00
	Eave-to-Ridge H	t. (ft)	2.58	0.85	2.58	0.85	2.58	0.85	2.58	0.85
•	Max. Wall Ht. (	(ft)	9.00	0.95	9.00	0.95	9.00	0.95	9.00	0.95
III CIII C	No. of BWLs	ì	2	1.00	2	1.00	2	1.00	2	1.00
Adjust	Omit Interior Fin	ish?	No	1.00	No	1.00	No	1.00	No	1.00
1	Added Hold-dow	/ns?	No	1.00	No	1.00	No	1.00	No	1.00
	Joints Blocked	ქ?	Yes	1.00	Yes	1.00	Yes	1.00	Yes	1.00
	Fasteners @ 4" o	Fasteners @ 4" o.c.?		1.00	No	1.00	No	1.00	No	1.00
Re	equired BWP Lengt	h (ft)	9.0	00	9.0	00	9.85		.70	
		BWP	Method	Length	Method	Length	Method	Length	Method	Length
	Contributing	1	CS-WSP	3.75	CS-WSP	3.90	GB (ds)	29.00	GB (ds)	12.16
2	Length (ft)	2	CS-WSP	5.58	CS-WSP	5.91			GB (ds)	12.50
	WSP=actual SFB=actual	3	CS-WSP	4.91	CS-WSP	3.91				
Actual	GB(ss)=0.5xactual GB(ds)=actual	4	CS-WSP	5.58	CS-WSP	5.00				
Ţ	CS-PF=1.5xactual PFG=1.5xactual	5								
	PFH=4' ABW=4'	6								
		7								
ļ	Actual BWP Length	(ft)	19.82		18.72		29.00		24.66	
	Actual ≥ Required	?	PA	SS	PA	SS	PA	SS	PASS	
	BWPs ≤ 20' Apart	?	Y	es	Ye	es	Y	es	Y	es
	≥ 2 Panels in BWL	.?	Y	es	Ye	es	Y	es	Y	es
	BWP 10' from End	s?	Y	es	Ye	es	Y	es	Y	es
	Continuous Sheathi	ng	End 1	End 2	End 1	End 2	End 1	End 2	End 1	End 2
	End Conditions  BWL Compliance	,	3 PA	<u>4</u>	5 PA	3	3 PA	3	3 PA	3 SS
BWL Compliance		PASS		PASS		IA	PASS		PASS	



4*TE REVISE* /2024 10:18:0

2316-BURTON-STREET

A7.

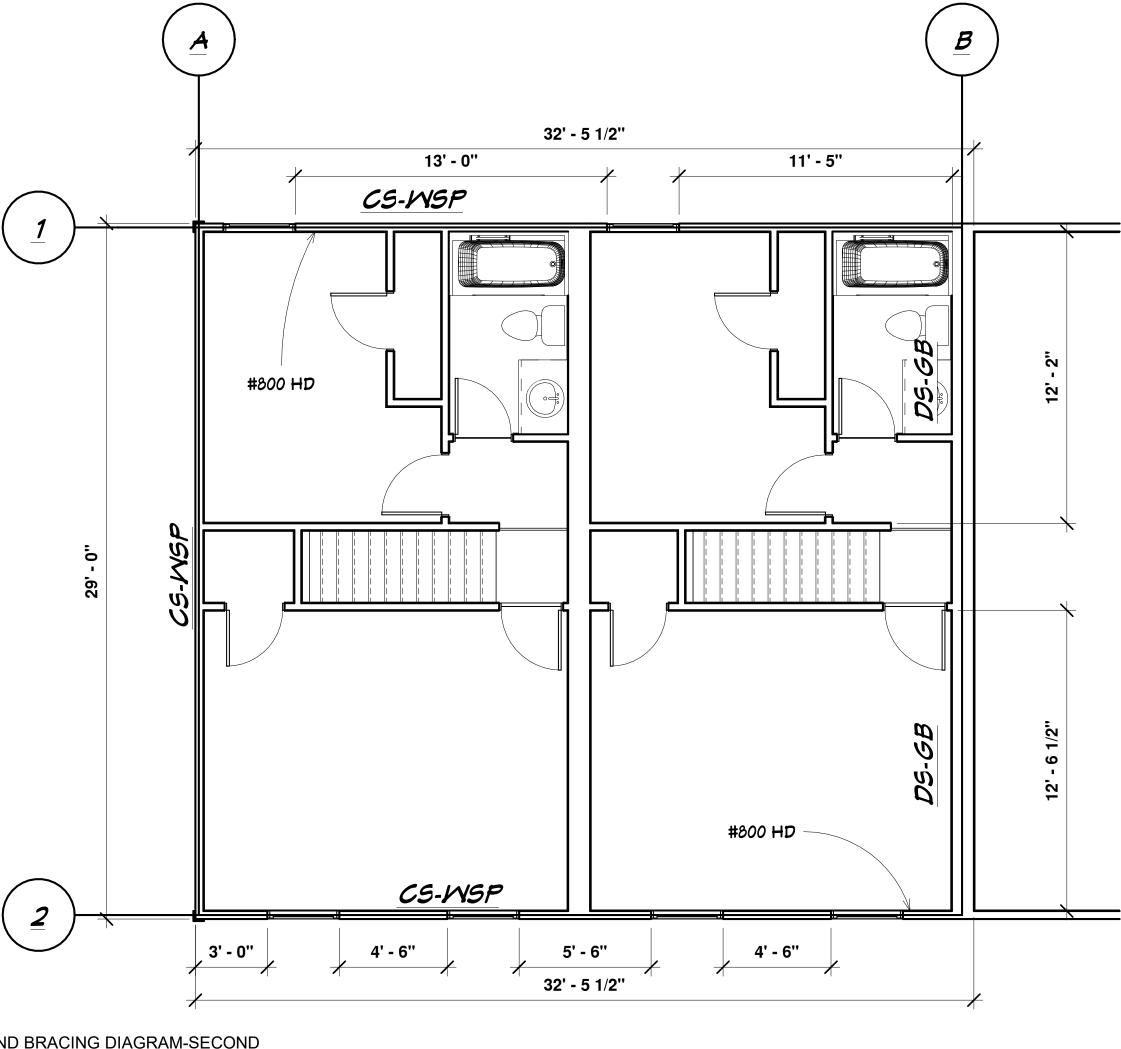

WIND BRACING DIAGRAM-SECOND

FLOOR

1/4" = 1'-0"

## Classic Wall Bracing Worksheet

Ulti	imate Wind Speed	(mph)	13	30						
	BWL Designation	on	1	ly .	2		Α		В	
N	No. of Floors above BWL		0		0		0		0	
	BWP Method		CS-V	WSP	CS-V	VSP CS-WSP		GB		
Αv	verage BWL Spacing (ft)		29		29		32		32	
Ta	bular Requirement (ft)		5.80		5.80		6.30		12.70	
	Exposure		В	1.00	В	1.00	В	1.00	В	1.00
	Eave-to-Ridge H	t. (ft)	2.58	0.70	2.58	0.70	2.58	0.70	2.58	0.70
020	Max. Wall Ht.	(ft)	8.00	0.90	8.00	0.90	8.00	0.90	8.00	0.90
Adjustments	No. of BWLs	6	2	1.00	2	1.00	2	1.00	2	1.00
\djust	Omit Interior Fin	ish?	No	1.00	No	1.00	No	1.00	No	1.00
ď	Added Hold-dow	/ns?	No	1.00	No	1.00	No	1.00	No	1.00
,	Joints Blocked	d?	Yes	1.00	Yes	1.00	Yes	1.00	Yes	1.00
	Fasteners @ 4" o.c.?		No	1.00	No	1.00	No	1.00	No	1.00
Re	equired BWP Lengt	h (ft)	3.6	3.65 3.97		8.00				
_						· · · · · · · · · · · · · · · · · · ·				
110		BWP	Method	Length	Method	Length	Method	Length	Method	Length
	Contributing	BWP 1	Method CS-WSP	Length 13.00	Method CS-WSP	Length 3.00	Method CS-WSP	Length 29.00	Method GB (ds)	Length 12.16
6	Contributing Length (ft)	BWP 1 2	1	200 201		-				
BWPs	Length (ft)  WSP=actual  SFB=actual	1	CS-WSP	13.00	CS-WSP	3.00			GB (ds)	12.16
ctual BWPs	Length (ft)  WSP=actual  SFB=actual  GB(ss)=0.5xactual  GB(ds)=actual	2	CS-WSP	13.00	CS-WSP	3.00			GB (ds)	12.16
Actual BWPs	Length (ft)  WSP=actual  SFB=actual  GB(ss)=0.5xactual  GB(ds)=actual  CS-PF=1.5xactual  PFG=1.5xactual	2 3	CS-WSP	13.00	CS-WSP CS-WSP	3.00 4.50 5.50			GB (ds)	12.16
Actual BWPs	Length (ft)  WSP=actual  SFB=actual  GB(ss)=0.5xactual  GB(ds)=actual  CS-PF=1.5xactual	1 2 3 4	CS-WSP	13.00	CS-WSP CS-WSP	3.00 4.50 5.50			GB (ds)	12.16
Actual BWPs	Length (ft)  WSP=actual  SFB=actual  GB(ss)=0.5xactual  GB(ds)=actual  CS-PF=1.5xactual  PFG=1.5xactual  PFH=4'	1 2 3 4 5	CS-WSP	13.00	CS-WSP CS-WSP	3.00 4.50 5.50			GB (ds)	12.16
	Length (ft)  WSP=actual  SFB=actual  GB(ss)=0.5xactual  GB(ds)=actual  CS-PF=1.5xactual  PFG=1.5xactual  PFH=4'	1 2 3 4 5 6	CS-WSP	13.00	CS-WSP CS-WSP	3.00 4.50 5.50 4.50		29.00	GB (ds)	12.16
	Length (ft)  WSP=actual  SFB=actual  GB(ss)=0.5xactual  GB(ds)=actual  CS-PF=1.5xactual  PFG=1.5xactual  PFH=4'  ABW=4'	1 2 3 4 5 6 7 (ft)	CS-WSP	13.00	CS-WSP CS-WSP CS-WSP	3.00 4.50 5.50 4.50	CS-WSP	29.00	GB (ds)	12.16 12.50
	Length (ft)  WSP=actual SFB=actual GB(ss)=0.5xactual GB(ds)=actual CS-PF=1.5xactual PFG=1.5xactual PFH=4' ABW=4'  Actual BWP Length	1 2 3 4 5 6 7 (ft)	CS-WSP  CS-WSP  24. PA	13.00	CS-WSP CS-WSP CS-WSP  17.	3.00 4.50 5.50 4.50	CS-WSP  29  PA	29.00	GB (ds) GB (ds)	12.16 12.50
	Length (ft)  WSP=actual SFB=actual GB(ss)=0.5xactual GB(ds)=actual CS-PF=1.5xactual PFG=1.5xactual PFH=4' ABW=4'  Actual BWP Length  Actual ≥ Required	1 2 3 4 5 6 7 (ft)	CS-WSP  CS-WSP  24. PA	13.00 11.41 .41 .SS	CS-WSP CS-WSP CS-WSP  17. PA	3.00 4.50 5.50 4.50 50 SS	CS-WSP  29. PA	29.00 .00 .SS	GB (ds) GB (ds)	12.16 12.50 .66 SS
	Length (ft)  WSP=actual SFB=actual GB(ss)=0.5xactual GB(ds)=actual CS-PF=1.5xactual PFG=1.5xactual PFH=4' ABW=4'  Actual BWP Length  Actual ≥ Required  BWPs ≤ 20' Apart	1 2 3 4 5 6 7 (ft)	CS-WSP  CS-WSP  24. PA	13.00 11.41 .41 .SS	CS-WSP CS-WSP CS-WSP  17. PA	3.00 4.50 5.50 4.50 50 SS	CS-WSP  29  PA  Ye	29.00 .00 .SS	GB (ds) GB (ds)  24. PA	12.16 12.50 .66 .SS
-	Length (ft)  WSP=actual SFB=actual GB(ss)=0.5xactual GB(ds)=actual CS-PF=1.5xactual PFG=1.5xactual PFH=4' ABW=4'  Actual BWP Length  Actual ≥ Required BWPs ≤ 20' Apart ≥ 2 Panels in BWL  BWP 10' from End  Continuous Sheath	1 2 3 4 5 6 7 (ft) ?	CS-WSP  CS-WSP  24. PA  Ye  Ye  End 1	13.00 11.41 .41 .SS .es .es .es	CS-WSP CS-WSP CS-WSP  17. PA	3.00 4.50 5.50 4.50 50 SS es es es End 2	CS-WSP  29. PA  Ye  Ye  End 1	29.00 .00 .SS .es .es .es	GB (ds) GB (ds)  GB (ds)  24. PA  Ye  Ye  End 1	12.16 12.50 66 SS es es End 2
-	Length (ft)  WSP=actual SFB=actual GB(ss)=0.5xactual GB(ds)=actual CS-PF=1.5xactual PFG=1.5xactual PFH=4' ABW=4'  Actual BWP Length  Actual ≥ Required  BWPs ≤ 20' Apart ≥ 2 Panels in BWL  BWP 10' from End	1 2 3 4 5 6 7 (ft) 1? 1? 1? 1? 1? 1. 2 1. 2 1. 2 1. 2 1. 2	CS-WSP  CS-WSP  24  PA  Ye  Ye  End 1  5	13.00 11.41 .41 .SS .es	CS-WSP CS-WSP CS-WSP  17. PA Ye Send 1 1	3.00 4.50 5.50 4.50 50 SS es	CS-WSP  29. PA  Ye  Ye  Show the second of t	29.00 .00 .SS .es	GB (ds) GB (ds) GB (ds)  24. PA Ye  Ye  End 1 3	12.16 12.50 .66 .SS .es



2316-BURTON-STREET

A7.2