# NEW TWO-FAMILY RESIDENCE 909 NORTH 27TH STREET

## RICHMOND, VIRGINIA

#### LIST OF DRAWINGS

E-101

TITLE COVER SHEET / SITE / BUILDING DATA FLOOR PLANS / A-101 FRAMING PLANS A-102 STRUCTURAL NOTES FRAMING DETAILS BRACED WALL PANEL PLANS / DETAILS A-103 **BUILDING ELEVATIONS** A-201 DOOR / WINDOW SCHEDULES **BUILDING ELEVATIONS** A-202 WALL SECTION / U.L. DESIGNS A-301

#### **BUILDING DATA - 909 N. 27TH STREET**

ELECTRICAL POWER AND LIGHTING

CONSTRUCTION OF A NEW TWO-FAMILY, ATTACHED, SCOPE OF WORK: APPLICABLE CODES: 2012 VIRGINIA RESIDENTIAL CODE, PART 1 VA USBC R−63 <u>1</u> **ZONING DISTRICT:** 15 FEET, MAXIMUM (NON-CONFORMING) SETBACKS - FRONT: 3 FEET, MINIMUM 5 FEET, MINIMUM **REAR:** CONSTRUCTION TYPE: VB (WOOD FRAME, UNPROTECTED) USE GROUP: R-3, TWO FAMILY RESIDENCE BUILDING AREAS: FIRST FLOOR 1ST FLOOR: 800 SQ FT (26.76% OF LOT AREA) SECOND FLOOR 2ND FLOOR: 800 SQ FT TOTAL LOT AREA: 2,990 SQ FT (NON-CONFORMING) FIRE RATED ASSEMBLIES: • SIDE EXTERIOR WALLS CLOSER THAN 5'-0" TO ANY LOT LINE SHALL BE ONE HOUR FIRE RATED CONSTRUCTION FLOOR ASSEMBLY SEPARATING DWELLING UNITS SHALL BE ONE HOUR FIRE RATED CONSTRUCTION • FIRST FLOOR STAIRWAY ENCLOSURE WALLS SHALL BE ONE HOUR FIRE RATED CONSTRUCTION ALL MECHANICAL, ELECTRICAL AND PLUMBING WORK SHALL BE DESIGN/BUILD. PERMIT DRAWINGS FOR THOSE AREAS OF WORK SHALL BE SUBMITTED BY THE DESIGNATED TRADE.

#### **GENERAL NOTES**

CONTRACTOR SHALL CONFORM TO THE 2012 VIRGINIA RESIDENTIAL CODE FOR ONE AND TWO FAMILY DWELLINGS, PART 1 OF THE VAUSBC AS ADOPTED BY THE COMMONWEALTH OF VIRGINIA.

2. CONTRACTOR SHALL VERIFY ALL DIMENSIONS AND SITE CONDITIONS BEFORE STARTING CONSTRUCTION.

3. CONTRACTOR SHALL CAULK, FLASH OR OTHERWISE MAKE THE BUILDING WEATHERTIGHT.

4. CONTRACTOR SHALL CAULK ALL GAPS BETWEEN DISSIMILAR MATERIALS.

5. ALL WOOD SILLS THAT ARE WITHIN 8" OF EXPOSED EARTH OR ON CONCRETE SLABS SHALL BE PRESSURE PRESERVATIVE TREATED.

6. ALL HOSE BIBBS SHALL BE FREEZE PROOF AND HAVE A BACKFLOW PREVENTER. 7. RUN ALL TOILET FANS AND EXHAUST VENTS TO AN APPROVED EXTERIOR

8. 8" MIN. REQUIRED BETWEEN FINISH GRADE AND BOTTOM OF SIDING. 9. CONTRACTOR SHALL COORDINATE PLACEMENT OF ROOF TRUSSES AND INSTALLATION OF ATTIC ACCESS DOORS.

10. ALL FIXED GLAZING WITHIN 18" OF FLOOR OR 12" OF DOORS SHALL BE TEMPERED GLASS OR SAFETY GLAZED.

11. SEALED AND SIGNED SHOP DRAWINGS ARE REQUIRED FOR PRE-ENGINEERED WOOD ROOF TRUSSES, GIRDERS AND BEAMS.

12. HVAC CONTRACTOR SHALL RUN ALL CONDENSATE DRAINS TO AN APPROVED LOCATION.

13. ALL EXPOSED GUTTERS, DOWNSPOUTS AND FLASHING TO BE PRE-FINISHED. 14. INSULATE ALL WALL AROUND BATHROOMS/TOILETS WITH 3 1/2" UNFACED BATT

15. SHELVING AND SHELF AND RODS TO BE BRACED AT 4'-0" O.C. MAX. 16. VERIFY FRAMING/CONSTRUCTION DIMENSIONS PRIOR TO INSTALLATION OF CABINETS, TUBS, HVAC EQUIPMENT AND OTHER BUILT-IN FIXTURES OR EQUIPMENT.

17. SILL PLATE ANCHORAGE - 1/2" DIAMETER X 18" LONG ANCHOR BOLTS AT 6'-0" O.C. MAXIMUM AT ALL EXTERIOR WALLS AND 12" MAXIMUM FROM CORNERS. INSTALL THE ANCHOR BOLTS IN SOLID GROUTED CMU CAVITIES - NOT IN THE MORTAR


18. INSULATE ALL PIPING AT EXTERIOR WALLS.

19. PROVIDE RECESSED BOX WITH VALVE TO AREA BEHIND REFRIGERATOR FOR

20. ELECTRICAL CONTRACTOR SHALL SUPPLY AND INSTALL ALL EQUIPMENT NECESSARY TO CONTROL EXISTING GROUND FAULT CURRENT AT THE SITE.

21. ALL WASHING MACHINES AND WATER HEATERS TO BE SET IN A PLASTIC OVERFLOW PAN WITH A DRAIN TO AN EXTERIOR OR APPROVED DISCHARGE.

22. GENERAL CONTRACTOR IS REQUIRED TO COORDINATE UNDER CUTTING OF DOOR WITH THE HVAC CONTRACTOR FOR ADEQUATE RETURN AIR FLOW.

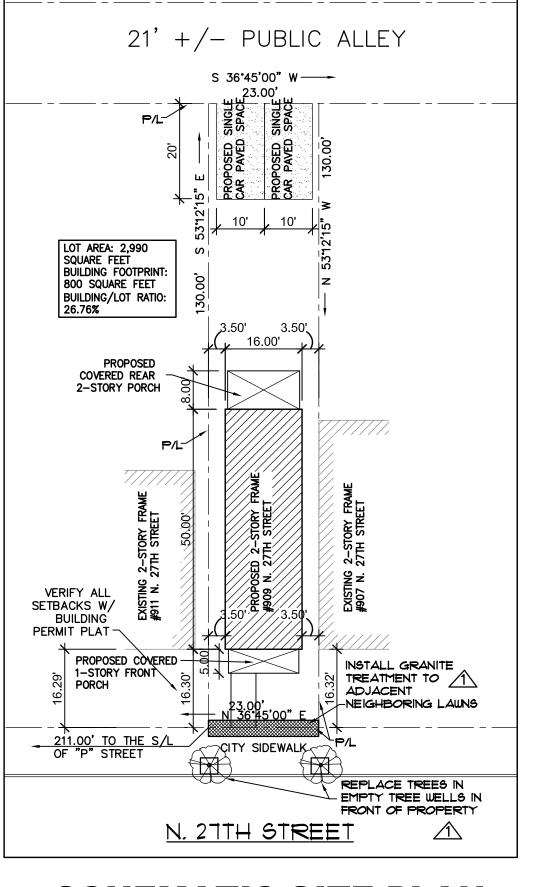

#### SCHEMATIC SITE PLAN

NOTE: DATA FOR THIS SCHEMATIC SITE PLAN WAS DERIVED FROM A DRAWING TITLED "SURVEY AND PLAT OF THE PROPERTY KNOWN AS #909 N. 27TH STREET IN THE CITY OF RICHMOND, VA". DATED: 01/05/16, BY EDWARDS, KRETZ, LOHR & ASSOCIATES, PLLC, LAND SURVEYORS - PLANNERS.

23. ONLY GALVANIZED NAILS AND OTHER CONNECTORS TO BE USED IN EXTERIOR WOOD FENCES, RAILS, STAIRS, ETC.

24. CLOTHES DRYER EXHAUST SHALL COMPLY WITH THE VA. CONSTRUCTION CODE.

25. ALL DIMENSIONS SHOWN ARE ACTUAL, AND ARE TO THE FACE OF STUDS OR TO


FACE OF MASONRY OR CONCRETE. CONTRACTOR TO COORDINATE ACTUAL LAY-OUT IN

26. AT WOOD STUD EXTERIOR CORNERS (WHERE TWO INSULATED WALLS INTERSECT) - REFER TO DETAIL C2/A102.

27. WHERE INTERIOR PARTITIONS INTERSECT AN EXTERIOR INSULATED WALL, A LADDER T-WALL FRAMED CORNER SHALL BE CONSTRUCTED, REFER TO DETAIL C3/A102.

28. ALL HEADERS SHALL BE INSULATED WITH 1/2" FOAM BETWEEN.

29. THE GENERAL CONTRACTOR IS TO BECOME FAMILIAR WITH ALL EXISTING CONDITIONS OF THE BUILDING AND SHOULD VERIFY THE LOCATIONS OF UTILITIES SUCH AS GAS, WATER, AND ELECTRIC WHICH MAY BE CONCEALED BEFORE PROCEEDING WITH THE WORK. 30. ALL EXISTING UNDERGROUND UTILITIES SHALL BE LOCATED AND VERIFIED BY THE GENERAL CONTRACTOR BEFORE ANY WORK. THIS INCLUDES SANITARY LINES, DRAIN FIELD ( IF ANY ), POWER LINE, TELEPHONE AND CABLE LINES, IRRIGATION LINES AND SPRINKLER HEADS. CONTACT "MISS UTILITY" BY DIALING 811 OR OTHER UTILITY AGENCIES AS APPROPRIATE.

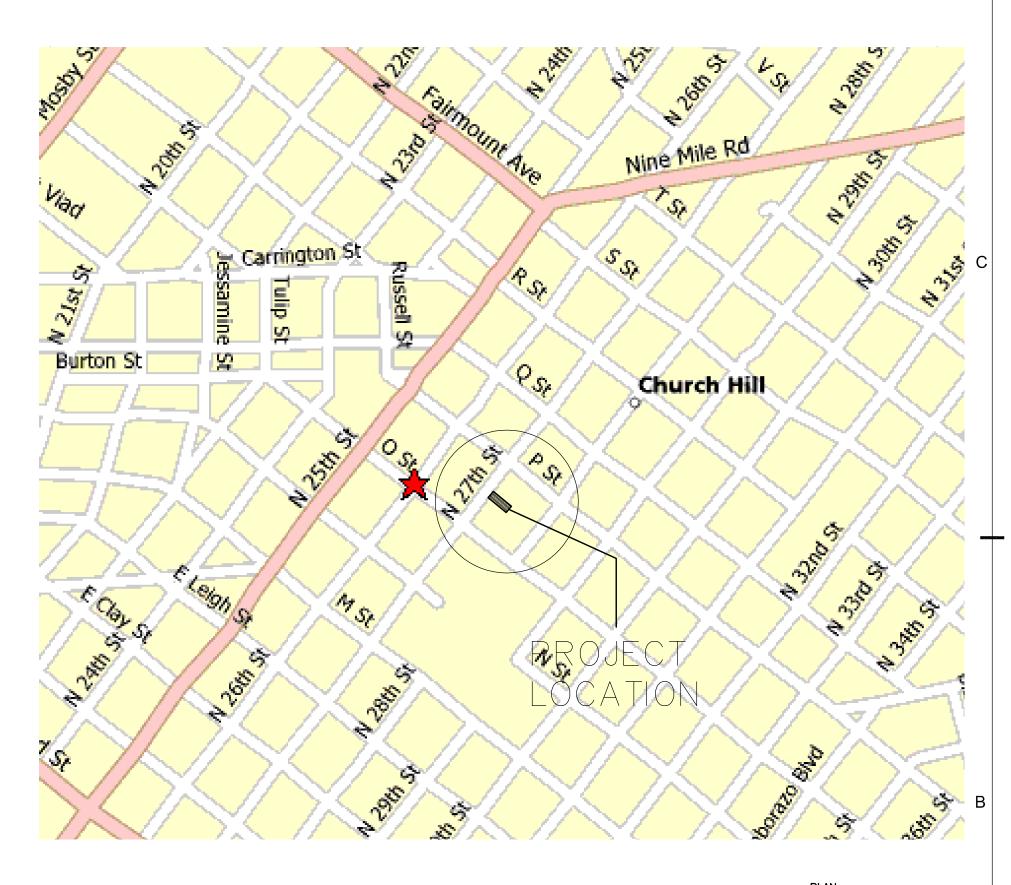


#### **LOCATION MAP**

### LEGEND

BRICK (IN SECTION)


C. M. U. (PLAN/SECTION)

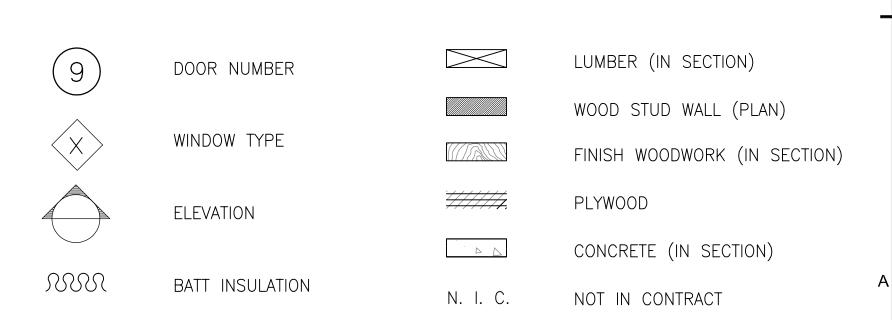

PERMIT SET

OUT TO OUT

UNLESS NOTED OTHERWISE

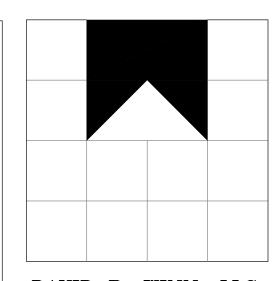

DAVID R. WINN, LLC residential design

10132 BERRYMEADE PLACE GLEN ALLEN, VIRGINIA 23060


11.17.17 ZONING/TREES/ GRANITE TRIMT 02.15.17 | PERMIT SET mark | date | description

> 2017-0001 ch'kd: A001.DWG cad #:


sheet title **COVER SHEET** 


A-001


1 of 7 sheet C COPYRIGHT 2017

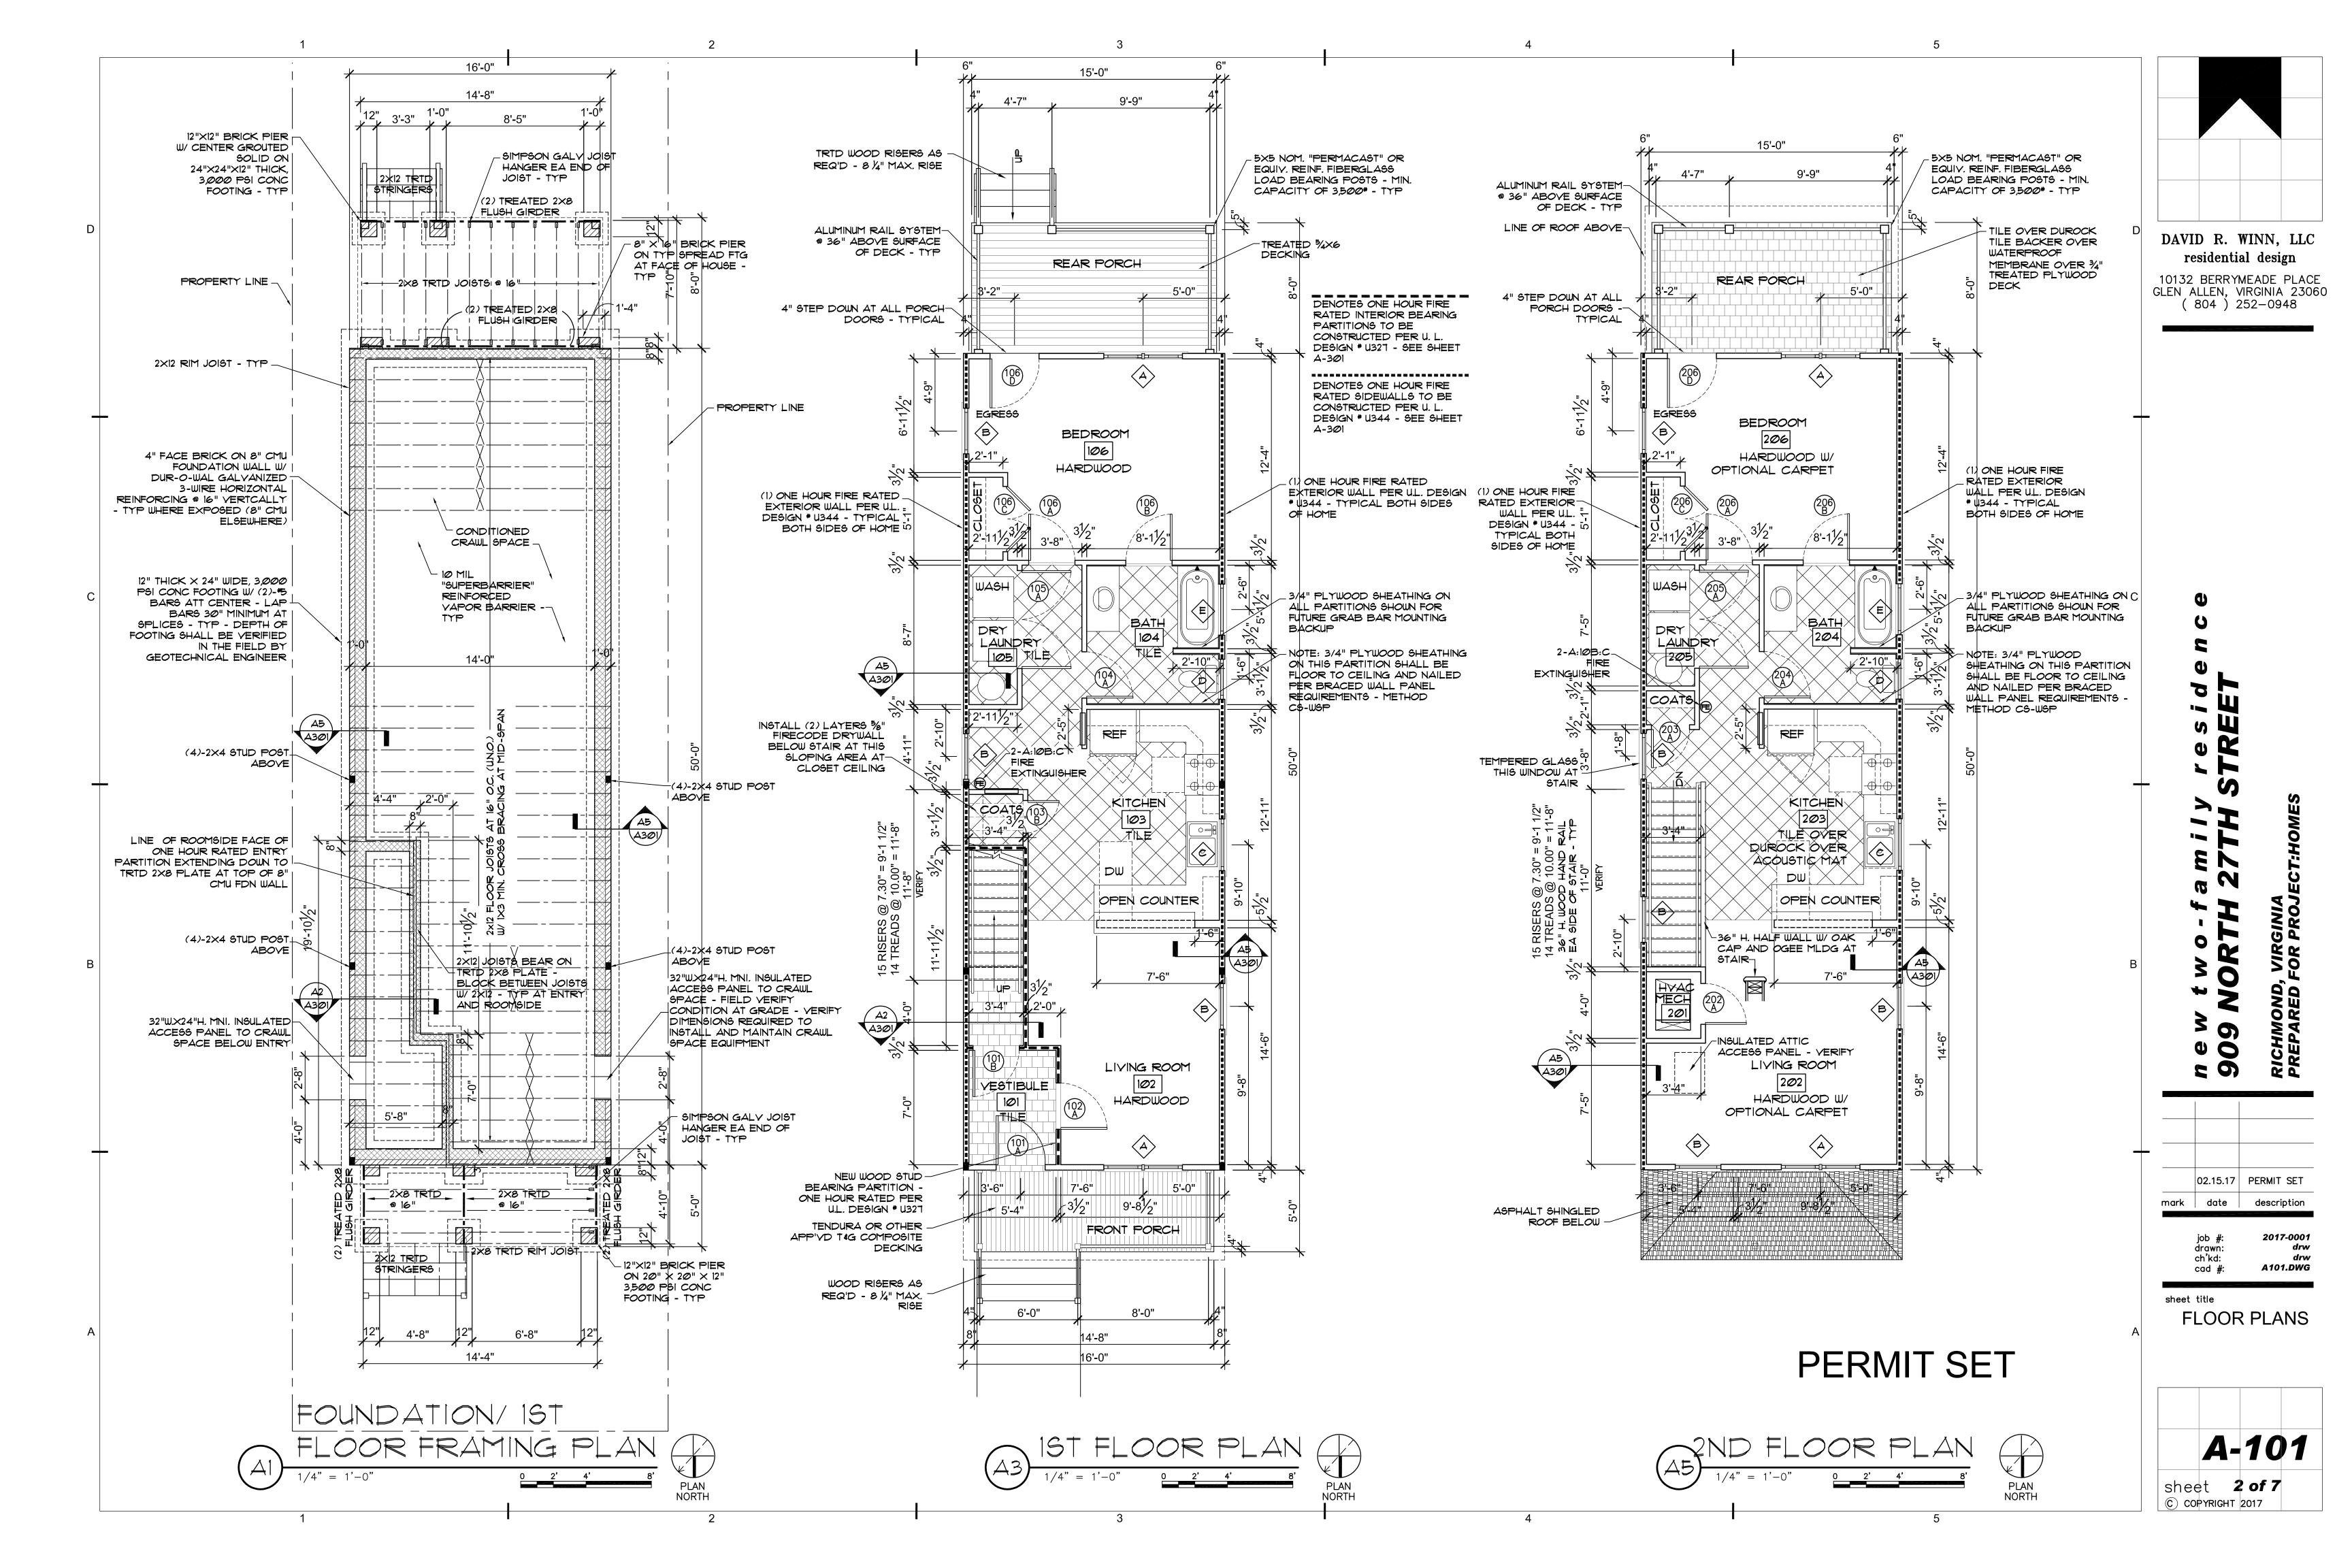


STRUCTURAL NOTES 4. FOR ALL CONCRETE WORK: CONFORM TO ALL APPLICABLE SECTIONS - CONCRETE MASONRY UNITS: ASTM C90, TYPE N, MIN. COMPRESSIVE TREAT FOUNDATION SOIL FOR INSECTS AS REQUIRED BY OF ACI 318 AND ACI 301, CODE-CURRENT EDITIONS STRENGTH OF 1900 PSI, f'm = 1500 PSI BUILDING CODE, WITH A WARRANTED PROFESSIONAL PEST THE DESIGN INDICATED ON THESE DRAWINGS PRESUMES THAT THE - FACE BRICK: AS SELECTED BY PROJECT: HOMES. CONTROL COMPANY, USING TREATMENT PRODUCTS WHICH ARE 5. FOR ALL STRUCTURAL MASONRY CONSTRUCTION: CONFORM TO ALL STRUCTURE IS TO BE FOUNDED ON NATURAL, UNDISTURBED SOIL OR ENVIRONMENTALLY APPROVED AS SAFE. APPLICABLE SECTIONS OF ACI 530.1, CODE-CURRENT EDITION. - MASONRY MORTAR: ASTM C270, TYPE 9 COMPACTED STRUCTURAL FILL HAVING A SAFE ALLOWABLE BEARING PRESSURE OF 2000 PSF. IT IS THE OWNER'S RESPONSIBILITY TO HAVE 6. DESIGN LOADS PRESERVATIVE TREAT ALL WOOD IN CONTACT WITH MASONRY OR CONCRETE - ANCHOR BOLTS: ASTM A307 / A36 ( MILD STEEL ) THIS VALUE VERIFIED BY COMPETENT GEOTECHNICAL PERSONNEL. OR WOOD USED FOR EXTERIOR WEATHER EXPOSURE (ACQ). GROUND SNOW LOAD: 20 PSF - STRUCTURAL SAWN LUMBER: 2X6 OR GREATER: # 2 SOUTHERN YELLOW PINE, MC 19 TREATMENT SHALL BE ENVIRONMENTALLY APPROVED AS SAFE. DESIGN CODES: 2012 YIRGINIA RESIDENTIAL CODE MIN. ROOF LIVE LOAD: 20 PSF 2×4'S: # 2 SPF WIND SPEED / EXPOSURE: Vuit = 115 MPH, Vasd = 89 MPH / EXPOSURE B 2. IT SHALL BE THE CONTRACTOR'S RESPONSIBILITY TO PROPERLY BRACE ALL FOUNDATION AND FOOTING WORK SHALL BE PERFORMED TO FLOOR SYSTEM DESIGN IS BASED ON RESIDENTIAL LIVING AREA LIVE LOAD = 40 PSF - PLYWOOD AND OSB: APA RATED SHEATHING, 32/16 EXPOSURE 1 COMPLY WITH CHAPTER 4 OF 2012 VIRGINIA RESIDENTIAL CODE. AND SHORE ALL NEW OR EXISTING CONSTRUCTION TO SAFELY RESIST ALL LOADING CONDITION MINIMUM, WITH LL/DEFLECTION = L/360 MAXIMUM ALL EXTERIOR PLYWOOD OR OSB WALL SHEATHING SHALL BE NAILED PER REASONABLE LOADS TO WHICH THE NEW CONSTRUCTION MAY BE SUBJECTED THE REQUIREMENTS FOR BRACED WALL PANELS -NEW FOUNDATION WALL SHALL BE 4" FACE BRICK ON 8" CMU BACKUP MASONRY UNTIL PERMANENT BRACING AND SUPPORT IS IN PLACE. 1. PROVIDE FULL STUD SUPPORT UNDER BEARING SURFACES OF ROOF RAFTERS. METHOD CS-WSP ( CONTINUOUS SHEATHING-WOOD STRUCTURAL PANEL) WALL WITH FULLY MORTARED OR GROUTED COLLAR JOINT AS NOTED. INSTALL DOUBLE STUDS AT ALL WINDOW AND DOOR LINTELS. 3. <u>MATERIALS:</u> - 8d COMMON NAIL @ 6" O.C. ALONG PANEL EDGES AND 12" O.C. AT DAVID R. WINN, LLC SOLID CMU BLOCK UNITS AT ALL BEARING POINTS WITHIN WALLS AND AT INSIDE CORNERS. INTERMEDIATE STUD SUPPORTS. - CONCRETE: MINUMUM 28 DAY COMPRESSIVE STRENGTH - 3000 PSI 8. VERIFY ALL FLOOR, JOIST AND RAFTER BEARING ELEVATIONS W/ OWNER IN THE BALANCED EARTH FILL EACH SIDE OF WALL. GROUT CORES OF residential design SLUMP OF 2" - 4" ALL PIERS SOLID. ALLOW MASONRY TO SET 24 HRS. MIN. - PLATE CONNECTED WOOD TRUSSES: PER LATEST REQUIREMENTS OF THE MAX. AGGREGATE SIZE = 3/4" BEFORE PLACING GROUT/COREFILL 10132 BERRYMEADE PLACE TRUSS PLATE INSTITUTE ( TPI ). 9. PROVIDE AND INSTALL HURRICANE TIES AS MANUFACTURED BY "SIMPSON - GROUT/COREFILL: ASTM C476, 9"-11" SLUMP, 3000 PSI MIN GLEN ALLEN, VIRGINIA 23060 STRONG TIE" AT ROOF RAFTER BEARINGS. ANCHOR BOLTS SHALL BE PLACED WITHIN THE FULLY GROUTED CORE OF THE CMU -- LAMINATED VENEER LUMBER (LVL): AS MANUFACTURED BY WEYERHAEUSER COMPRESSIVE STRENGTH. ( 804 ) 252-0948 NOT THE COLLAR JOINT. HAVING THE FOLLOWING MINIMUM PROPERTIES: E=1.9ES PSI, Fb=2600 PSI, - REINFORCING STEEL: BARS - ASTM A615, GRADE 60 10. PROVIDE WOOD LINTELS AT ALL WOOD FRAMED WINDOW AND DOOR OPENINGS WWF - ASTM A185 Fyh= 285 PSI, Fc=750 PSI AS SHOWN ON THE DRAWINGS. (2)-2×8 BOXED BEAM SIMPSON H2.5 HURRICANE (2) TREATED 2X8 FLUSH GIRDER TIE AT EACH RAFTER BEARING 2X6 LEDGER - BOLTED TO WOOD STUD WALL W/ SIMPSON GALY JOIST-(2)-1/4"X5" HIGH CAPACITY 2×6 CEILING JOISTS AND HANGER EA END OF "LEDGER-LOK" LAG SCREWS TRTD 2×8 @ 16" W/ 3/4" TRTD ROOF RAFTERS @ 24" O.C. W/ %" -5/8" FIRE RATED GYP JOIST - TYP SIMPSON H2.5 HURRICANE TIE PLYWOOD DECKING FOR! AT EACH STUD FOR PORCH APA RATED ROOF SHEATHING SHEATHING ( IF REQ'D ) AT EACH TRUSS BEARING MEMBRANE/TILE BASE- TYP CEILING JOIST SUPPORT 2X8 LEDGER - SCREWED TO WOOD ½" OSB EXTERIOR HARDIPLANK SIDING STUD WALL W/ (2)-1/4"X5" HIGH CAPACITY "LEDGERLOK" LAG SHEATHING -SCREWS AT EACH STUD FOR PORCH SCAB 2X6 RAFTER TO END OF BLOWN IN CELLULOSE INSULATION RAFTER SUPPORT - 2X6 LEDGER AT TOP CHORD OF EACH MAIN ROOF TRUSS AND CEILING JOISTS ATTACHED SIMILARLY TRUSS EXTENSION NAIL W/ (4) 160 NAILS MIN. FOR CORNICE -YERIFY GYPSUM WALL BOARD - VERIFY THICKNESS AND NAILING REQUIRED WITH WALL SECTIONS INSULATED 'T LINTEL SCHEDULE GABLE TRUSS AT <u>LIA</u> = (2) 1.75"×11.25" 1.9E LYL LINTEL W/ SIDEWALLS 3-2×4 JACK STUDS EA END - MIN. <u>L1 = (2) 1.75"×9.25"</u> 1.9E LYL LINTEL W/ - COORDINATE FLOOR TRUSS 2-2×4 JACK STUDS JOIST LOCATIONS WITH 2ND EA END - MIN. FLOOR PLUMBING DRAIN LINES SPACE TRUSSES AS  $L2 = (2) 2 \times 8 LINTEL MIN.$ REQ'D FOR HYAC <u>L3</u> = (2) 2×6 LINTEL MIN. RETURN AT CEILING - VERIFY SIZE AND  $L4 = (2) 1.75" \times 3.625"$ -8d COMMON NAIL @ 6" O.C. ON EXACT LOCATION TYL LINTEL MIN. (RIP LYL CONTINUOUS WOOD ALL PANEL EDGES W/ MECHANICAL STRUCTURAL PANEL 1.75"×7.25" IN HALF) -HOLD LINTEL TIGHT -ORIENTATION OF STUD MAY DWGS BRACED WALL LINE TO UNDERSIDE OF VARY ----DOUBLE TOP PLATE GYPSUM WALL BOARD INSTALLED IN TO HOLD WINDOW 16d NAIL @ 12" O.C. ACCORDANCE W/ IRC CHAPTER T AT BATH AS HIGH AS POSSIBLE (3)-2×4 JACK STUD POST EA SIDE OF PRE-ENGINEERED GIRDER TRUSSES AND <sup>L</sup>CONTINUOUS WOOD STRUCTURAL THIS WINDOW-8d COMMON NAIL @ 6" (3)-2×4 POST HANGERS PER TRUSS PANEL BRACED WALL LINE CARRIES ROOF (3)-2×4 POST BELOW O.C. ON ALL PANELS -BELOW EA GIRDER TRUSS END CONT GIRDER TRUSS GIRDER TRUSS AT ROOF DESIGNER/MFGR EDGES SO COMMON NAIL @ 12" O.C. ON LOAD CONT TO CARRIES TO FOUNDATION TO BEARING AT ALL INTERMEDIATE SUPPORTS BEARING AT LEAR - VERIFY BEARING FOUNDATION FOUNDATION (3)-2×4 POST BELOW EA GIRDER CONTINUOUS SHEATHING TRUSS END CONT TO BEARING AT (2)- 11.25", 1.9E LVL-FOUNDATION FLUSH BEAM HEADER -(2) - 11.25", 1.9E LYL TRIMMER OUTSIDE CORNER DETAIL HANGERS TO LYL (FASTENED TOGETHER PER OND, RED TRIMMERS TO BE MANUFACTURER DESIGNED AND RECOMMENDATIONS) AT EACH PROVIDED BY LVL END OF STAIR OPENING. SUPPLIER (COORDINATE WITH STAIR) I HOUR FIRE RATED EXTERIOR WALL MIN. HANGER CAPACITY = 0 EXTENDS TO ROOF 2 KIPS AT EA END OF DECK - TYP GIRDER 3-2×4 POST BELOW EA END OF OPEN WEB TRIMMERS TO SOLID SPACE TRUSSES AS BLOCKING TO REQ'D FOR HYAC FOUNDATION WALL - TYP RETURN AT CEILING I HOUR FIRE RATED - VERIFY SIZE AND EXTERIOR WALL SIMPSON JOIST HANGER EXACT LOCATION EXTENDS TO ROOF AT EACH JOIST AS W/ MECHANICAL DECK - TYP CONT 14" RIM BOARD AT PERIMETER PER 02.15.17 | PERMIT SET MFGR'S INSTRUCTIONS date description PRE-ENGINEERED 22"X28" ATTIC-ROOF TRUSSES AT ACCESS SCUTTLE -2017-0001 24" O.C.|W/ 5/8" APA VERIFY LOCATION 32/16 SPAN RATED DERSIRED SIMPSON H2.5 HURRICANE ch'kd: SHEATHING - TYP —(2)- 1.75"×11.25" 1.9E LYL LINTEL TIE AT EACH TRUSS A102.DWG cad #: AT EACH IST FLOOR PORTAL BEARING (3)-2×4 POST MIN EA-FRAME EXTENDING TO EACH END OF LYL FRONT RIDGE/ RELATIVE CORNER sheet title PORTAL FRAME LINTEL SLOPING TRUSS 2ND FLR AND ROOF MANSARD THIS AREA - SEE <sup>A</sup>FRAMING PLANS 2X8 LEDGER - SCREWED TO WOOD ELEVATIONS STUD WALL W/ (2)-1/4"X5" HIGH 2 2XB CEILING JOISTS AND STRUCTURAL NOTES CAPACITY "LEDGERLOK" LAG ROOF RAFTERS @ 16" SCREWS AT EACH STUD FOR PORCH PERMIT SET O.C. W/ 5/8" APA 32/16 5X5 NOM. "PERMACAST" OR RAFTER SUPPORT - 2X6 LEDGER AT EQUIY. REINF. FIBERGLASS PLYWOOD SHEATHING CEILING JOISTS ATTACHED SIMILARLY PORCH ROOF LOAD BEARING POSTS BELOW BELOW - MIN. CAPACITY OF (2)-2×10 B0×ED BEAM SIMPSON H2.5 HURRICANE TIE 3,500# - TYP AT EA RAFTER BEARING - TYP A-102 PLAN sheet 3 of 7 NORTH C COPYRIGHT 2017

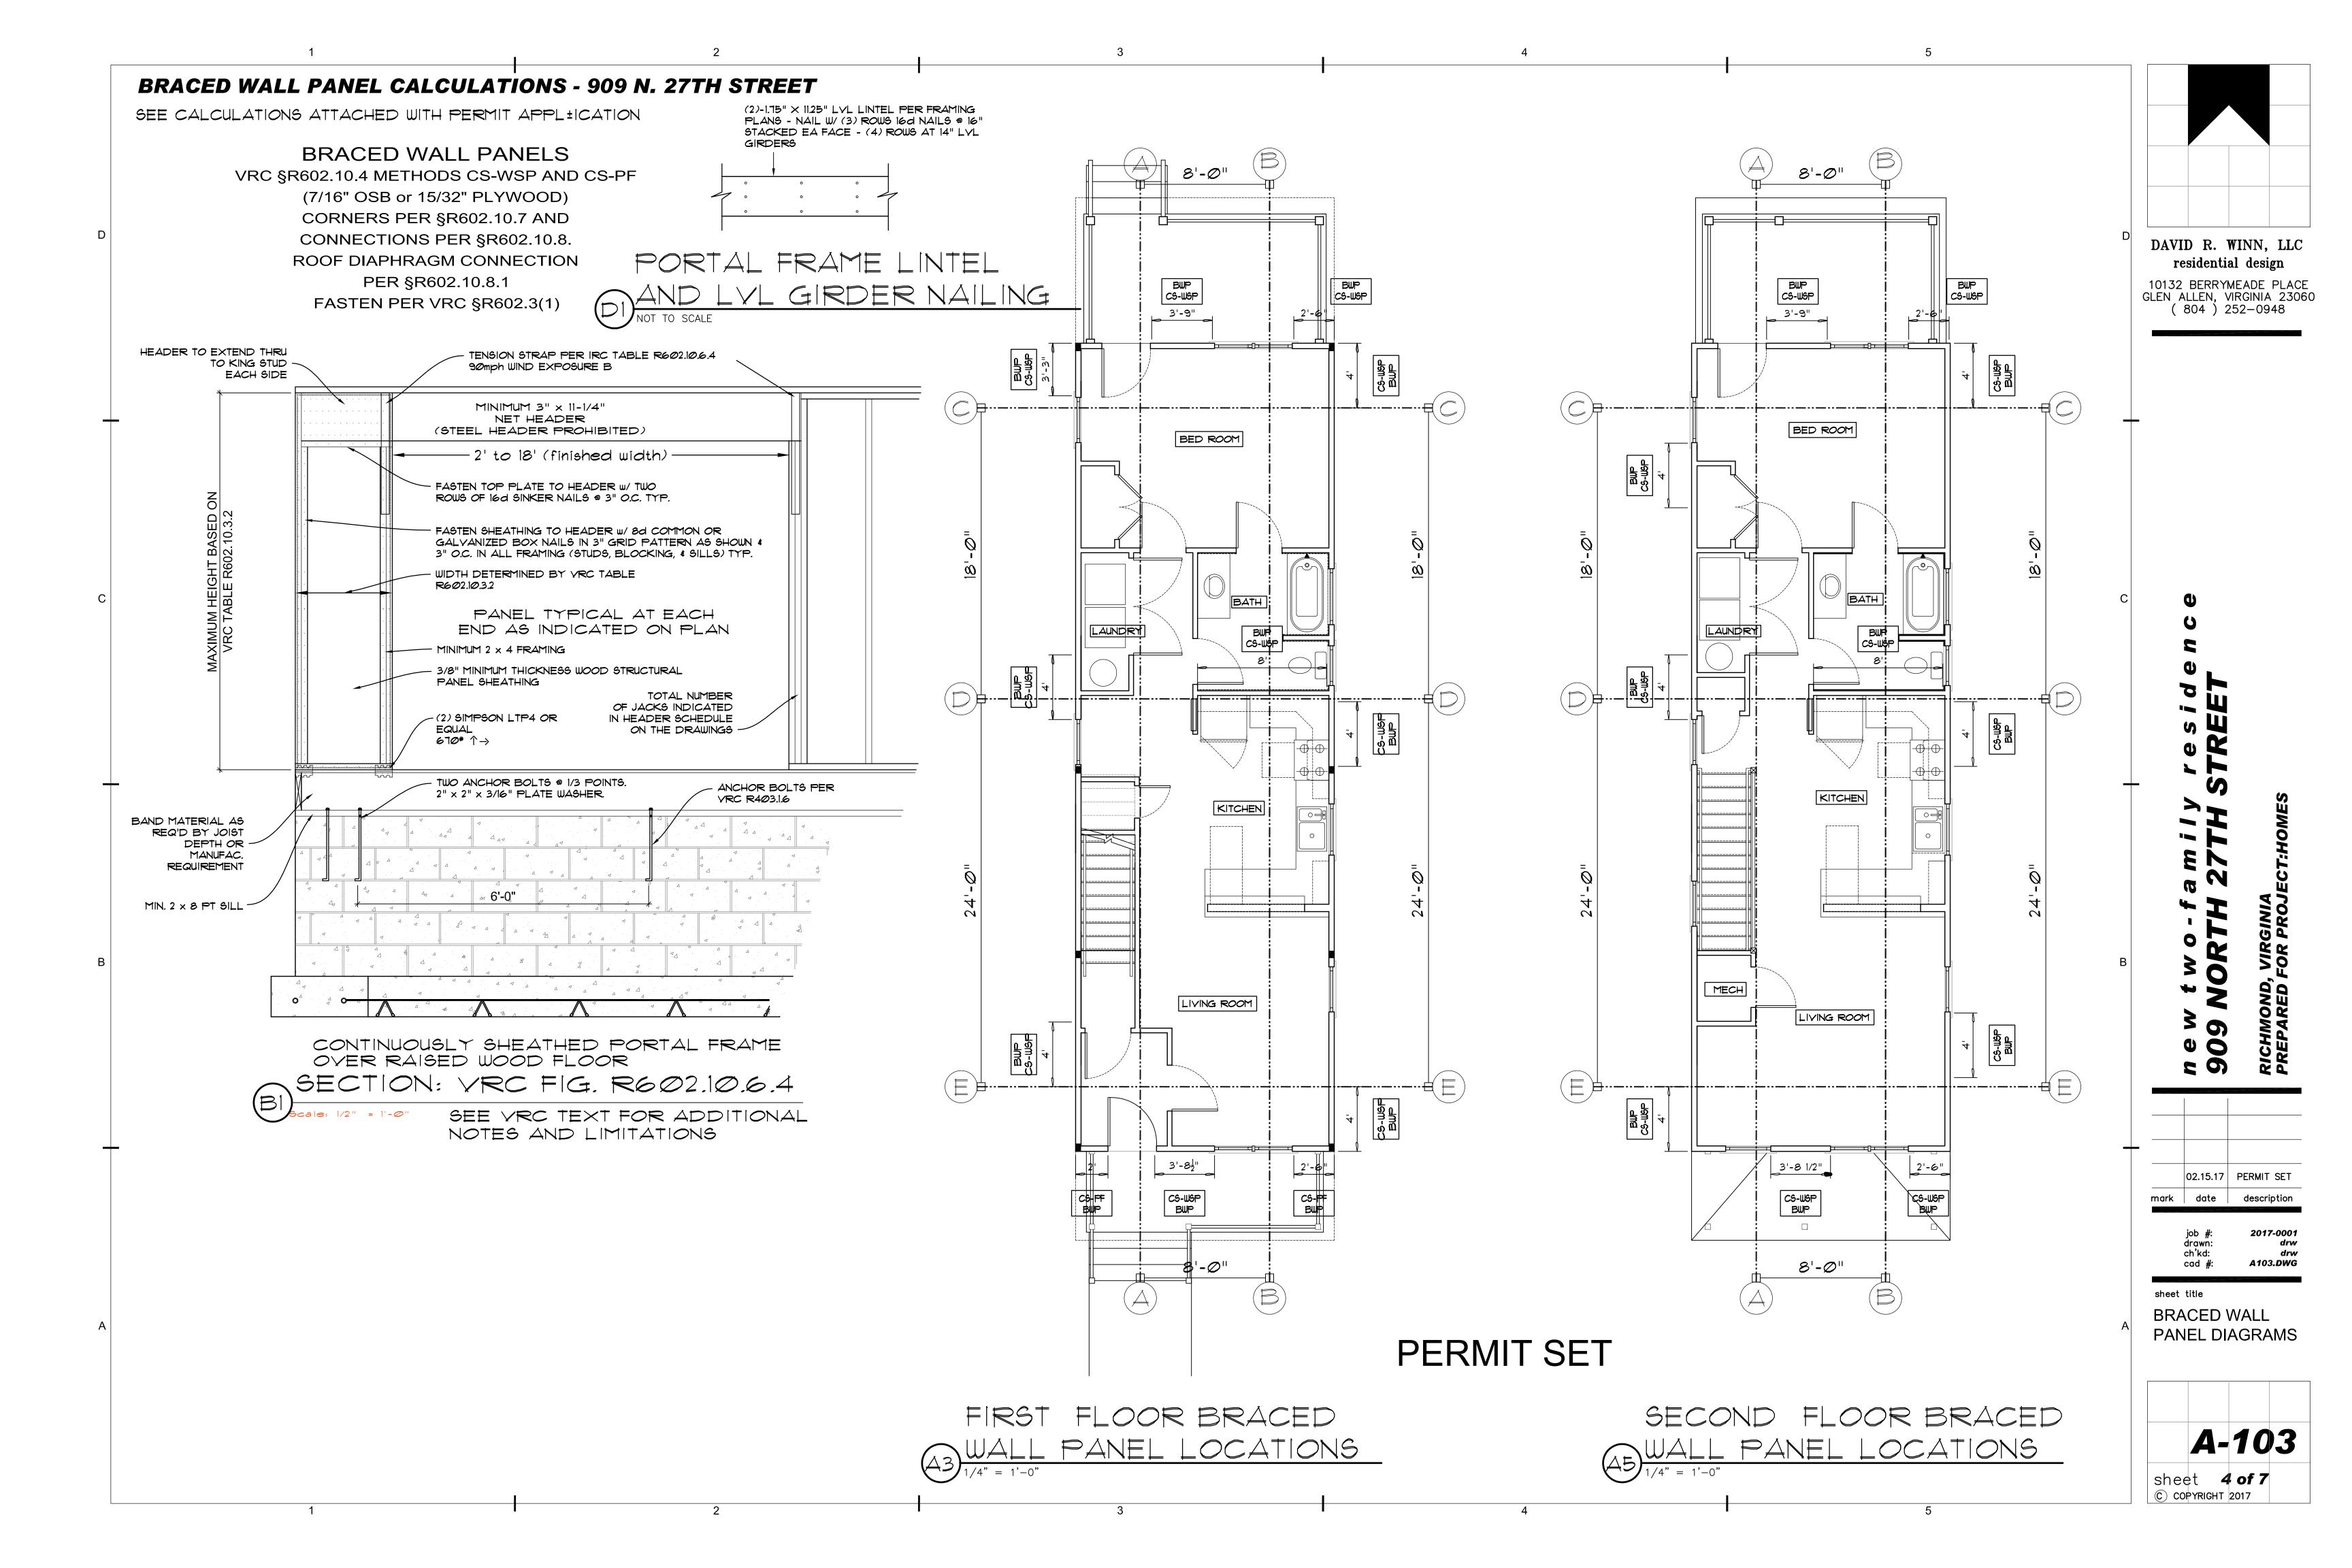


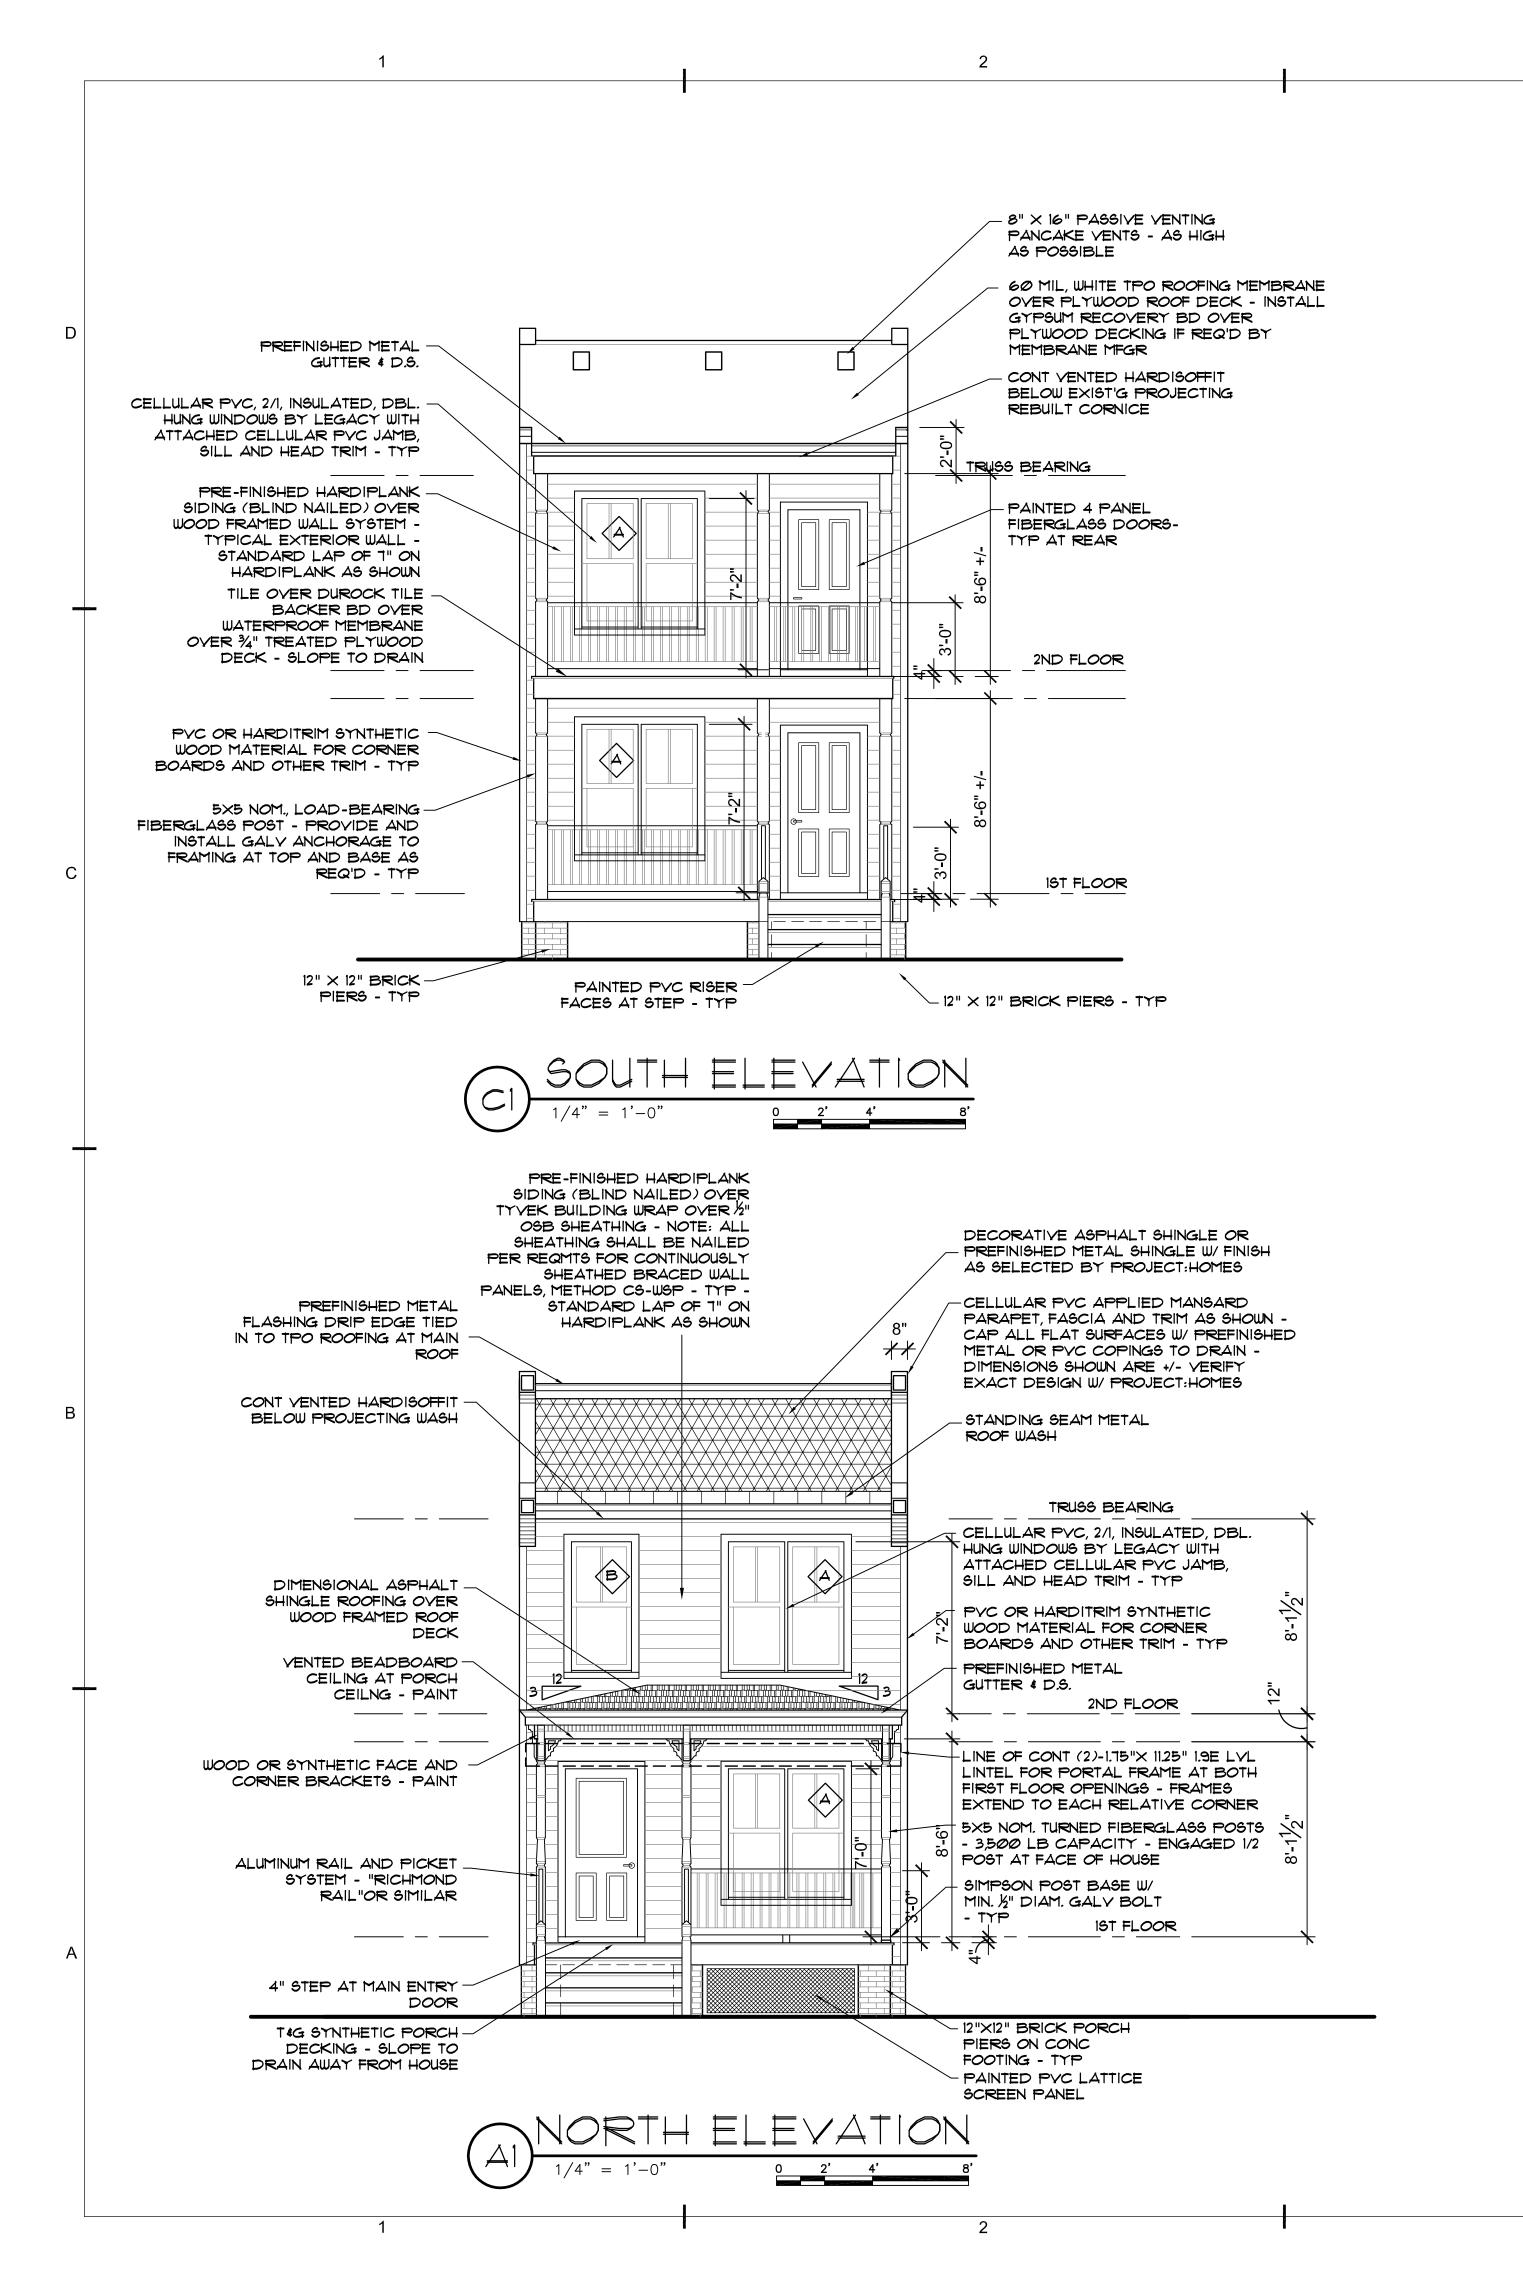

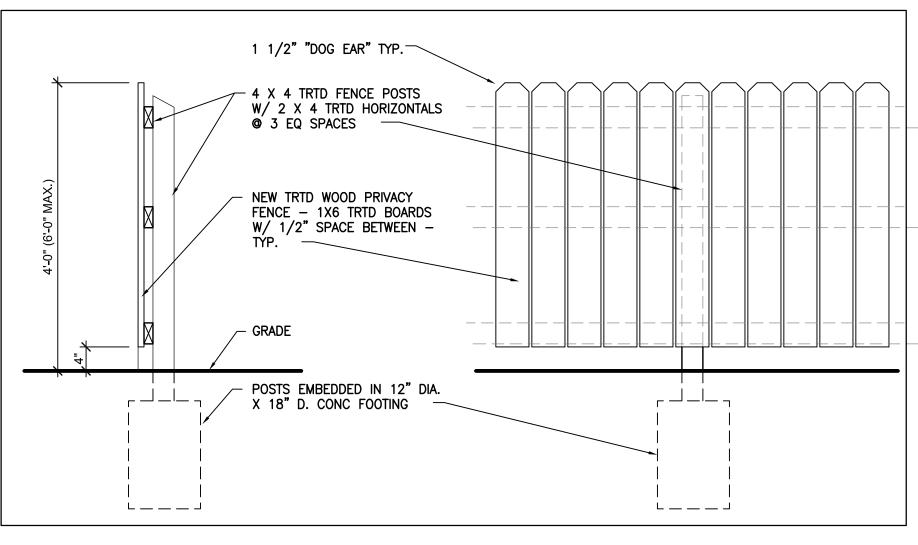

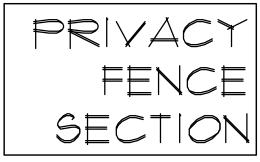

3/4" = 1'-0"

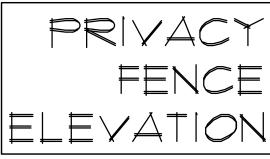

3/4" = 1'-0"

#### WINDOW SCHEDULE - 909 N. 27TH STREET SIZE ( ROUGH OPENING ) DETAIL NOTES CONTRACTOR TO VERIFY THK JAMB SILL NO. UNITWXH WD HGT HEAD 49.25" 4 1/2" CELLULAR PVC PR 2'-4" X 5'-2" 59.625" INSULATED - LOW 'E' ARGON FILLED DBL HUNG INSULATED - LOW 'E' ARGON FILLED 4 1/2" CELLULAR PVC TEMPERED GLASS AT STAIR 2'-8" X 5'-2"" 65.25" DBL HUNG MUST MEET EGRESS REQUIREMENT INSULATED - LOW 'E' ARGON FILLED 4 1/2" CELLULAR PVC 3'-0" X 3'-2" DBL HUNG HOLD SILL ABV COUNTER BACKSPLASH 4 1/2" CELLULAR PVC INSULATED - LOW 'E' ARGON FILLED 2'-4" X 3'-10" 30" 49.25" DBL HUNG TEMPERED GLASS AT BATHS INSULATED - LOW 'E' ARGON FILLED TEMPERED GLASS AT BATHS 4 1/2" CELLULAR PVC SLIDER

#### WINDOW NOTES:

- 1. ALL WINDOW UNITS SHALL BE PROVIDED WITH INSECT SCREENS
- 2. ALL WINDOWS WILL BE PROVIDED WITH AND HAVE INSTALLED 5/4 X 4 "HARDITRIM" OR "AZEK" CELLULAR PVC TRIM AT EXTERIOR JAMBS, HEAD AND SILL.

MOUNTED INBOARD AND OUTBOARD OF THE INSULATED GLASS UNIT.

- PROVIDE TEMPERED SAFETY GLAZING IN ALL WINDOWS LOCATED IN HAZARDOUS LOCATIONS
  PER IRC 2012, SECTION R308.4. PROVIDE TEMPERED GLAZING IN ALL BATHROOM WINDOWS. SEE PLANS.
- 4. THE WINDOWS SHOWN ON THE DRAWINGS AND SCHEDULED ARE BASED ON LEGACY, CELLULAR PVC SASH & FRAME, "DOUBLE HUNG SERIES 180", SIMULATED 2/0 DOUBLE HUNG WINDOW PRODUCT TILT SASH UNITS, SPACER BAR BETWEEN THE GLASS AND MUNTINS


		000	DR	S	CH	E	)U	LE	<b>=</b> - :	909	N.	<b>277</b>	H S	STREET
		DOOR							FRA	ME				
FIRST FLOOR	MARK -	SIZE								DETAIL			FIRE RATING	NOTES
		WD	HGT	THK	MATL	TYPE	MATL	TYPE	DEPTH	HEAD	JAMB	THRSH	LABEL	
	101A	3'-0"	6'-8"	1-3/4"	GL FG	2PAN'L 1/2 GL	WD		VERIFY			ALUM.	-	MAIN ENTRY (1ST FLOOR) - INSULATED HALF GLASS LITE / 2 RAISED PANELS
	101B	3'-0"	6'-8"	1-3/4"	НМ	4PAN'L	НМ		VERIFY			ALUM.	45 MIN	MAIN ENTRY (2ND FLOOR APT)
	102A	3'-0"	6'-8"	1-3/4"	НМ	4PAN'L	НМ		VERIFY			ALUM.	45 MIN	MAIN ENTRY (1ST FLOOR APT)
	103B	2'-0"	6'-8"	1-3/8"	COMP.	4PAN'L	WD		4 1/2"			-	-	COAT CLOSET
	104A	2'-10"	6'-8"	1-3/8"	COMP.	4PAN'L	WD		4 1/2"			-	-	BATHROOM
	105A	PR 2'6"	6'-8"	1-3/8"	COMP.	4PAN'L	WD		4 1/2"			-	-	LAUNDRY
	106A	2'-10"	6'-8"	1-3/8"	COMP.	4PAN'L	WD		4 1/2"			-	-	BEDROOM
	106B	2'-10"	6'-8"	1 <del>-3</del> /8"	COMP.	4PAN'L	WD		4 1/2"			-	-	BATHROOM
	106C	PR 2'-0"	6'-8"	1-3/8"	COMP.	4PAN'L	WD		4 1/2"			-		BEDROOM CLOSET
	106D	3'-0"	6'-8"	1-3/4"	FG	4PAN'L	WD		VERIFY			ALUM.	_	INSULATED EXTERIOR DOOR

风	202A	2'-8"	6'-8"	1-3/8"	СОМР.	4PAN'L	WD	4 1/2"		-	-	PASSAGE - MECH CLOSET
18	203A	2'-4"	6'-8"	1-3/8"	COMP.	4PAN'L	WD	4 1/2"		-	-	COAT CLOSET
<u> </u>	204A	2'-10"	6'-8"	1-3/8"	COMP.	4PAN'L	WD	4 1/2"		1	-	BATHROOM
) F	205A	PR 2'6"	6'-8"	1-3/8"	COMP.	4PAN'L	WD	4 1/2"		ı	•	LAUNDRY
	206A	2'-10"	6'-8"	1-3/8"	COMP.	4PAN'L	WD	4 1/2"		ı	•	BEDROOM
00	206B	2'-10"	6'-8"	1-3/8"	COMP.	4PAN'L	WD	4 1/2"		ı	•	BATHROOM
EC	206C	PR 2'-0"	6'-8"	1-3/8"	COMP.	4PAN'L	WD	4 1/2"		ı	•	BED CLOSET
S	206D	3'-0"	6'-8"	1-3/4"	FG	4PAN'L	WD	VERIFY		ALUM.	•	INSULATED EXTERIOR DOOR

DOOR NOTES

- 1. ALL DOOR HARDWARE TO HAVE LEVER OPERATORS, OR ADA COMPLIANT
- FG = INSULATED FIBERGLASS FACED DOOR HM = INSULATED HOLLOW METAL DOOR & FRAME, ONE HOUR FIRE RATED

PERMIT SET

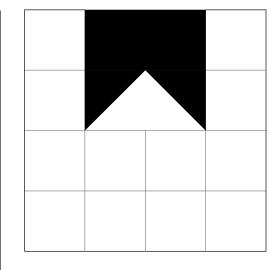

DAVID R. WINN, LLC residential design

10132 BERRYMEADE PLACE GLEN ALLEN, VIRGINIA 23060 ( 804 ) 252-0948

> family residence H 27TH STREET

RICHMOND, VIRGINIA


02.15.17 PERMIT SET
mark date description

job #: 2017-0001 drawn: drw ch'kd: drw cad #: A201.DWG

sheet title
ELEVATIONS /
DOOR &
WINDOW SCHED.

A-201

sheet **5 of 7** © COPYRIGHT 2017

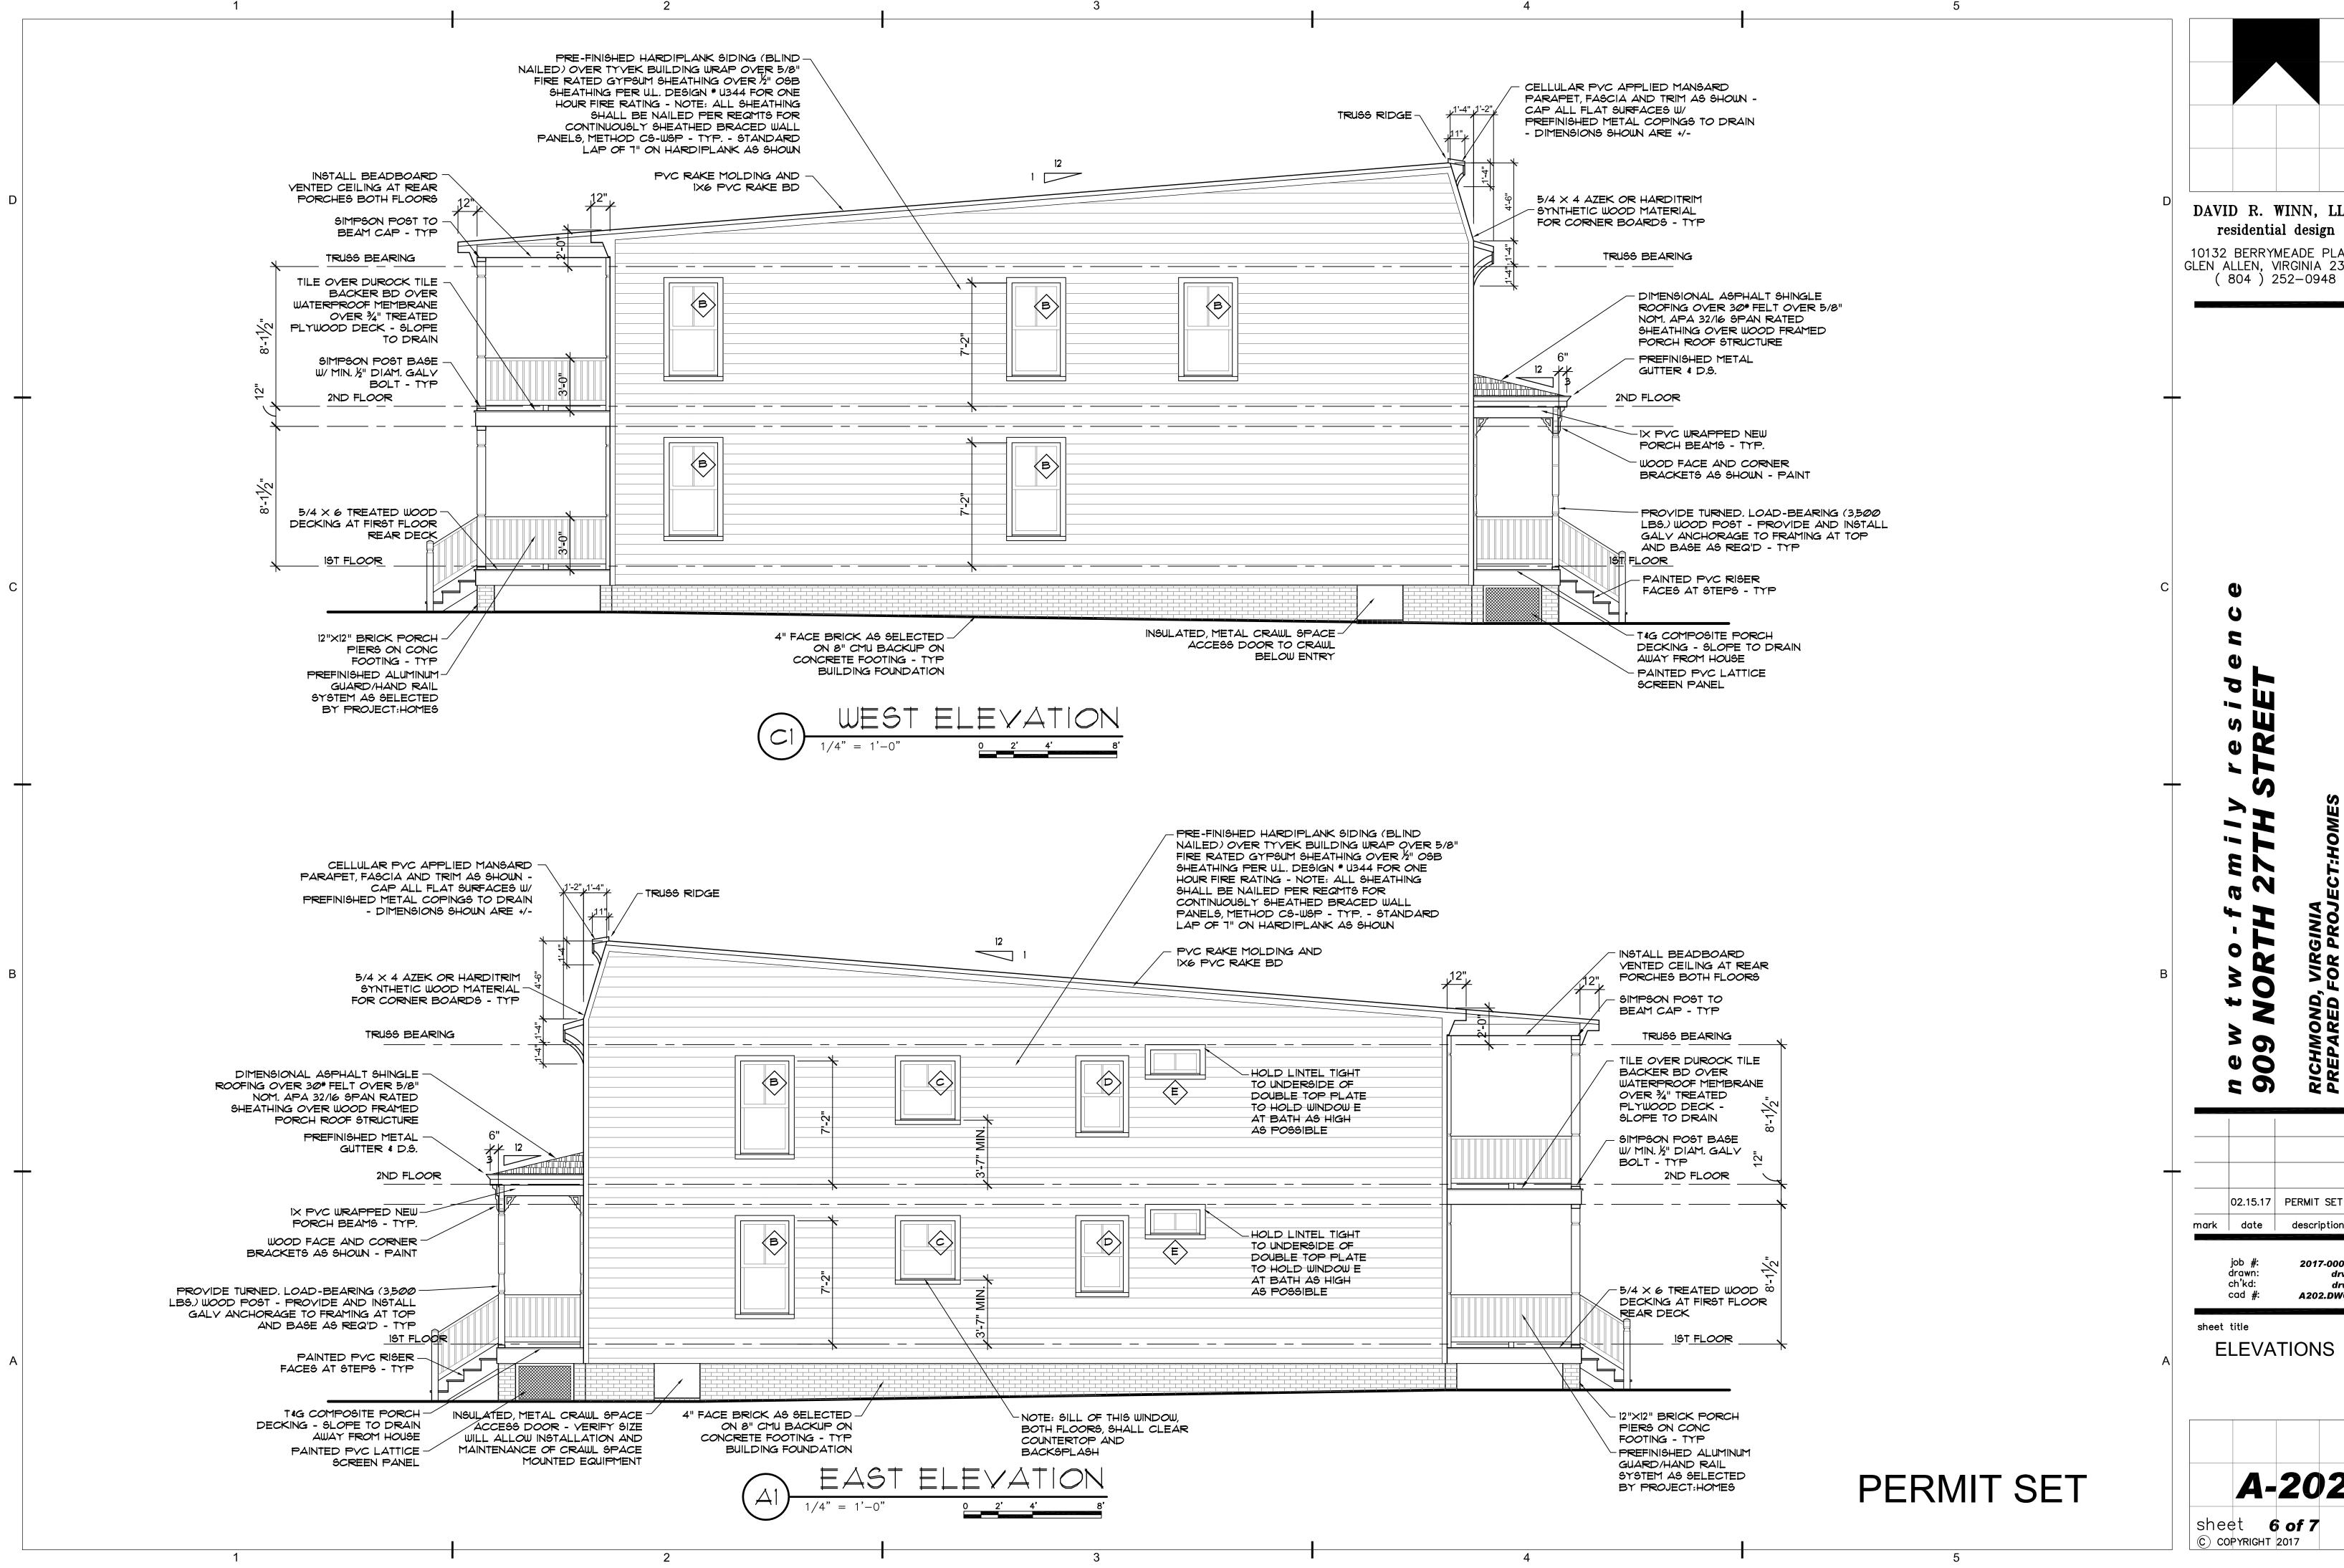

DAVID R. WINN, LLC residential design


10132 BERRYMEADE PLACE GLEN ALLEN, VIRGINIA 23060


02.15.17 | PERMIT SET description

> 2017-0001 A202.DWG

**ELEVATIONS** 

A-202

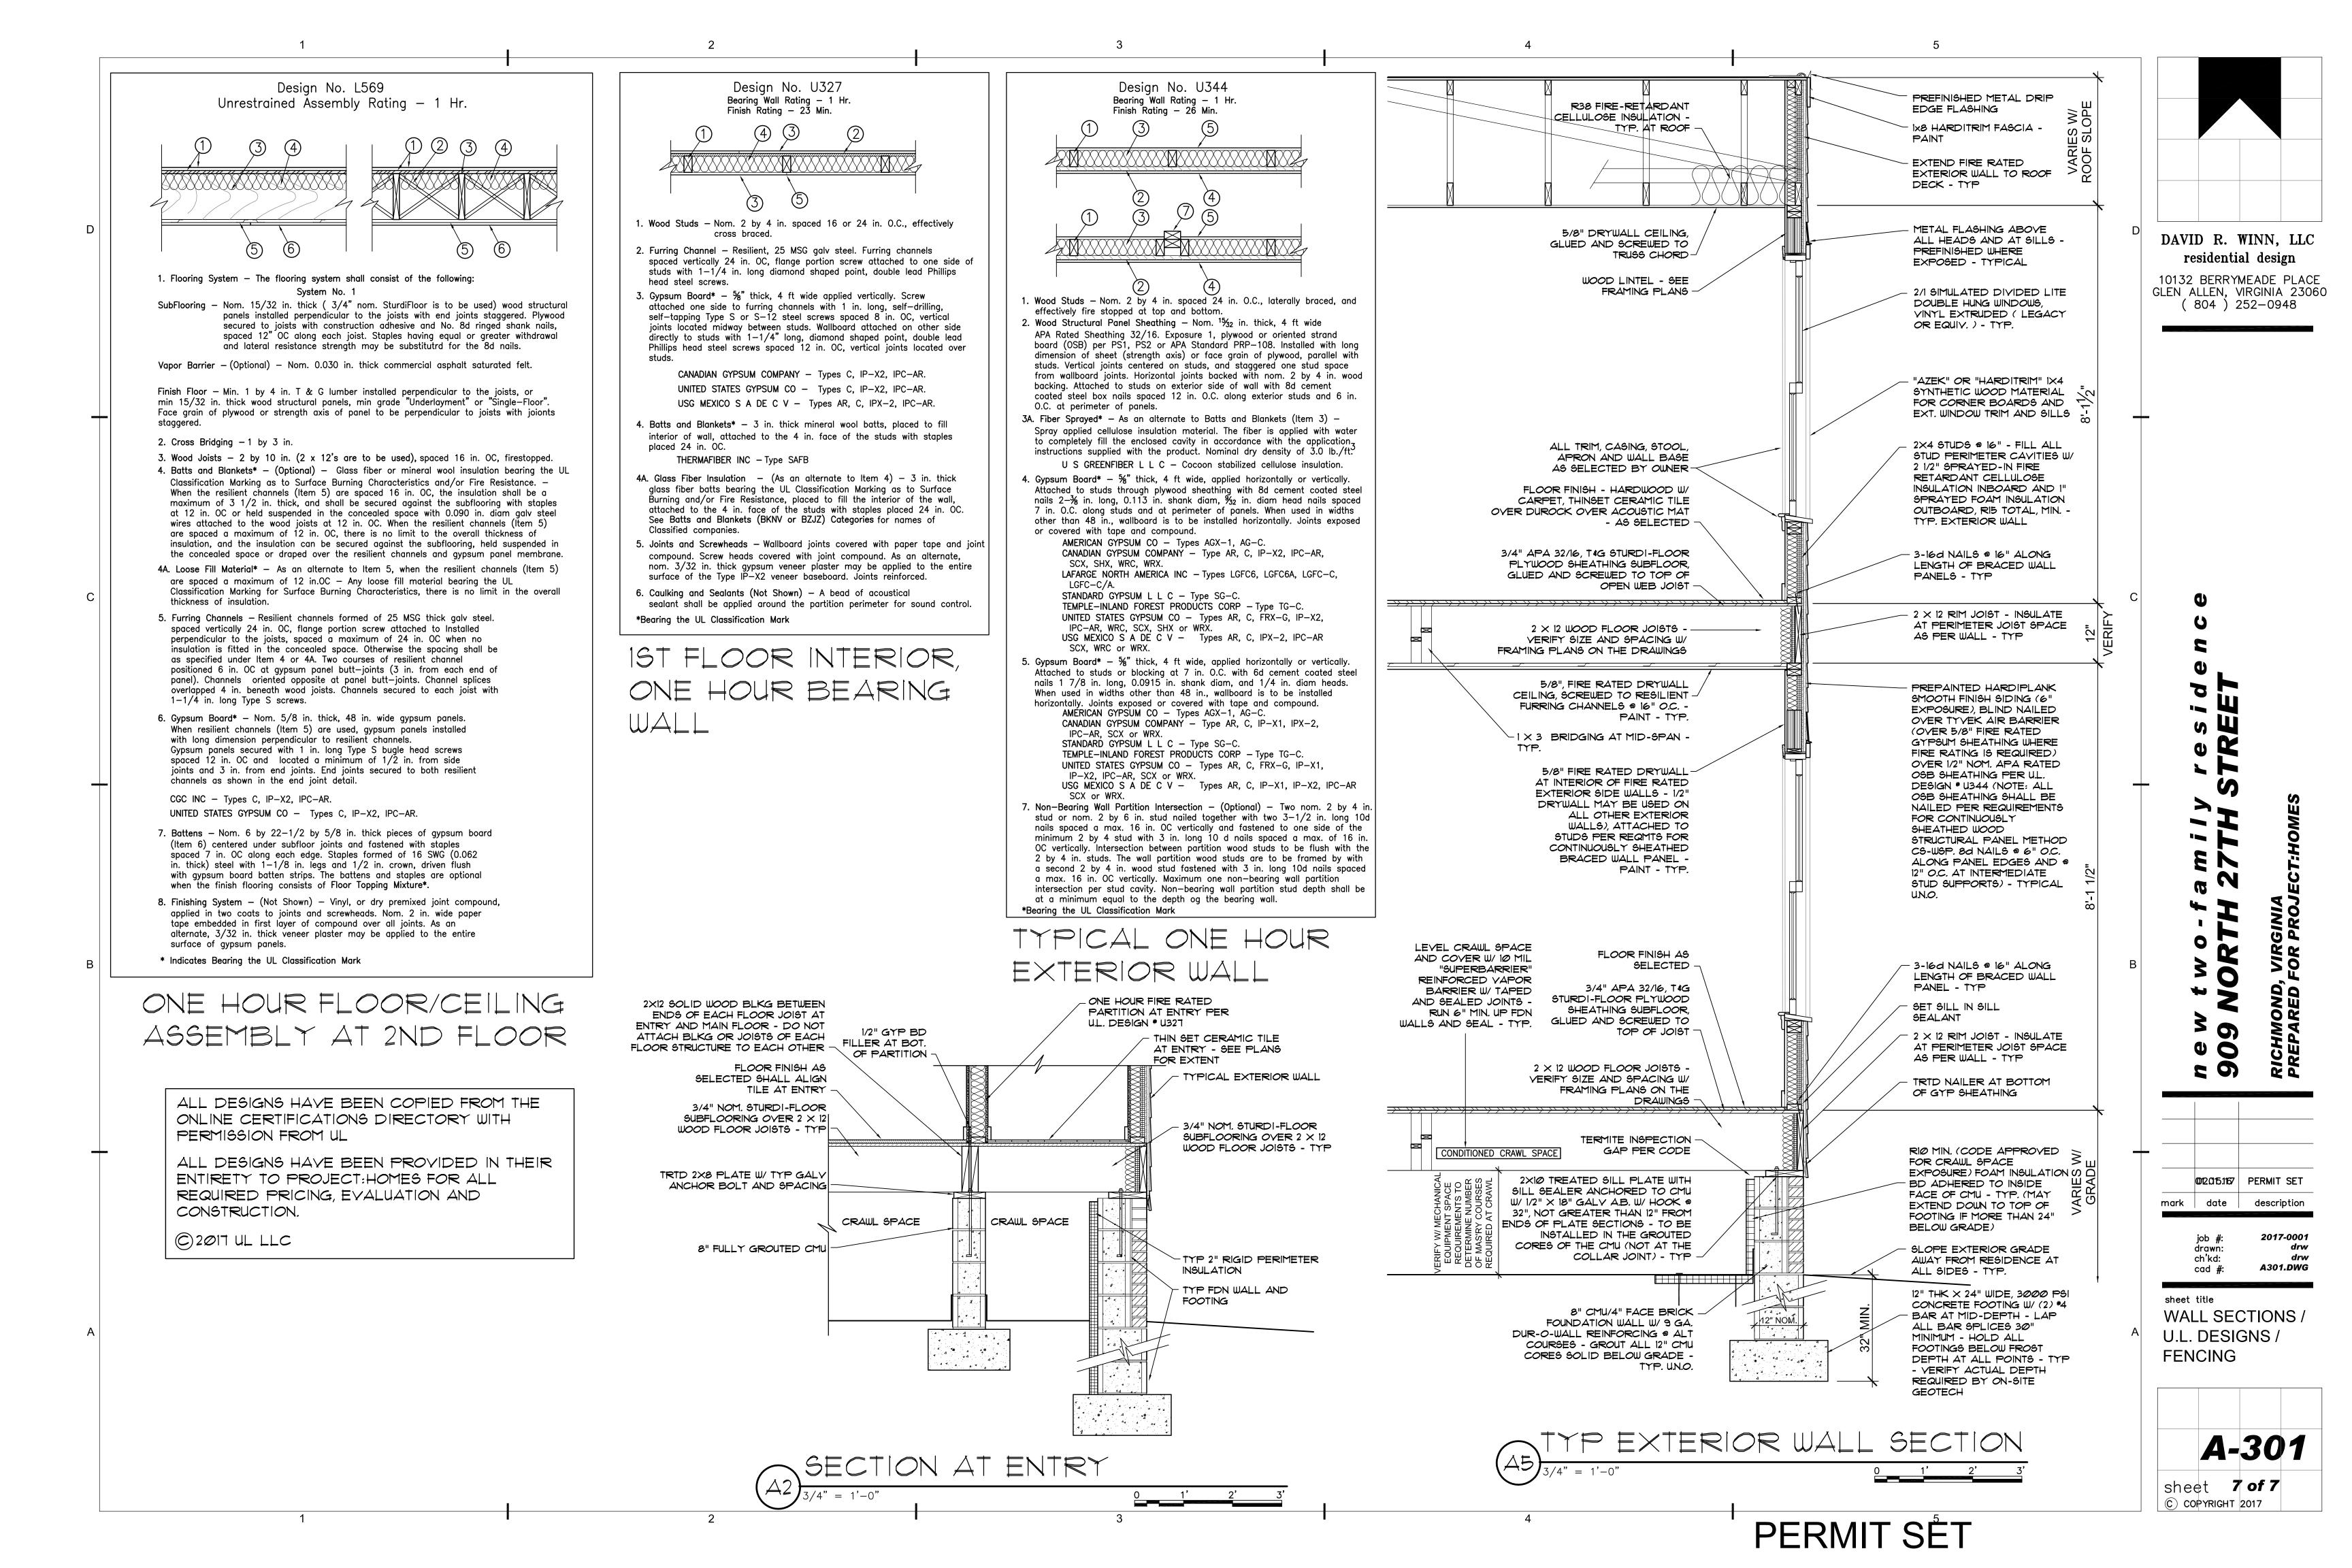

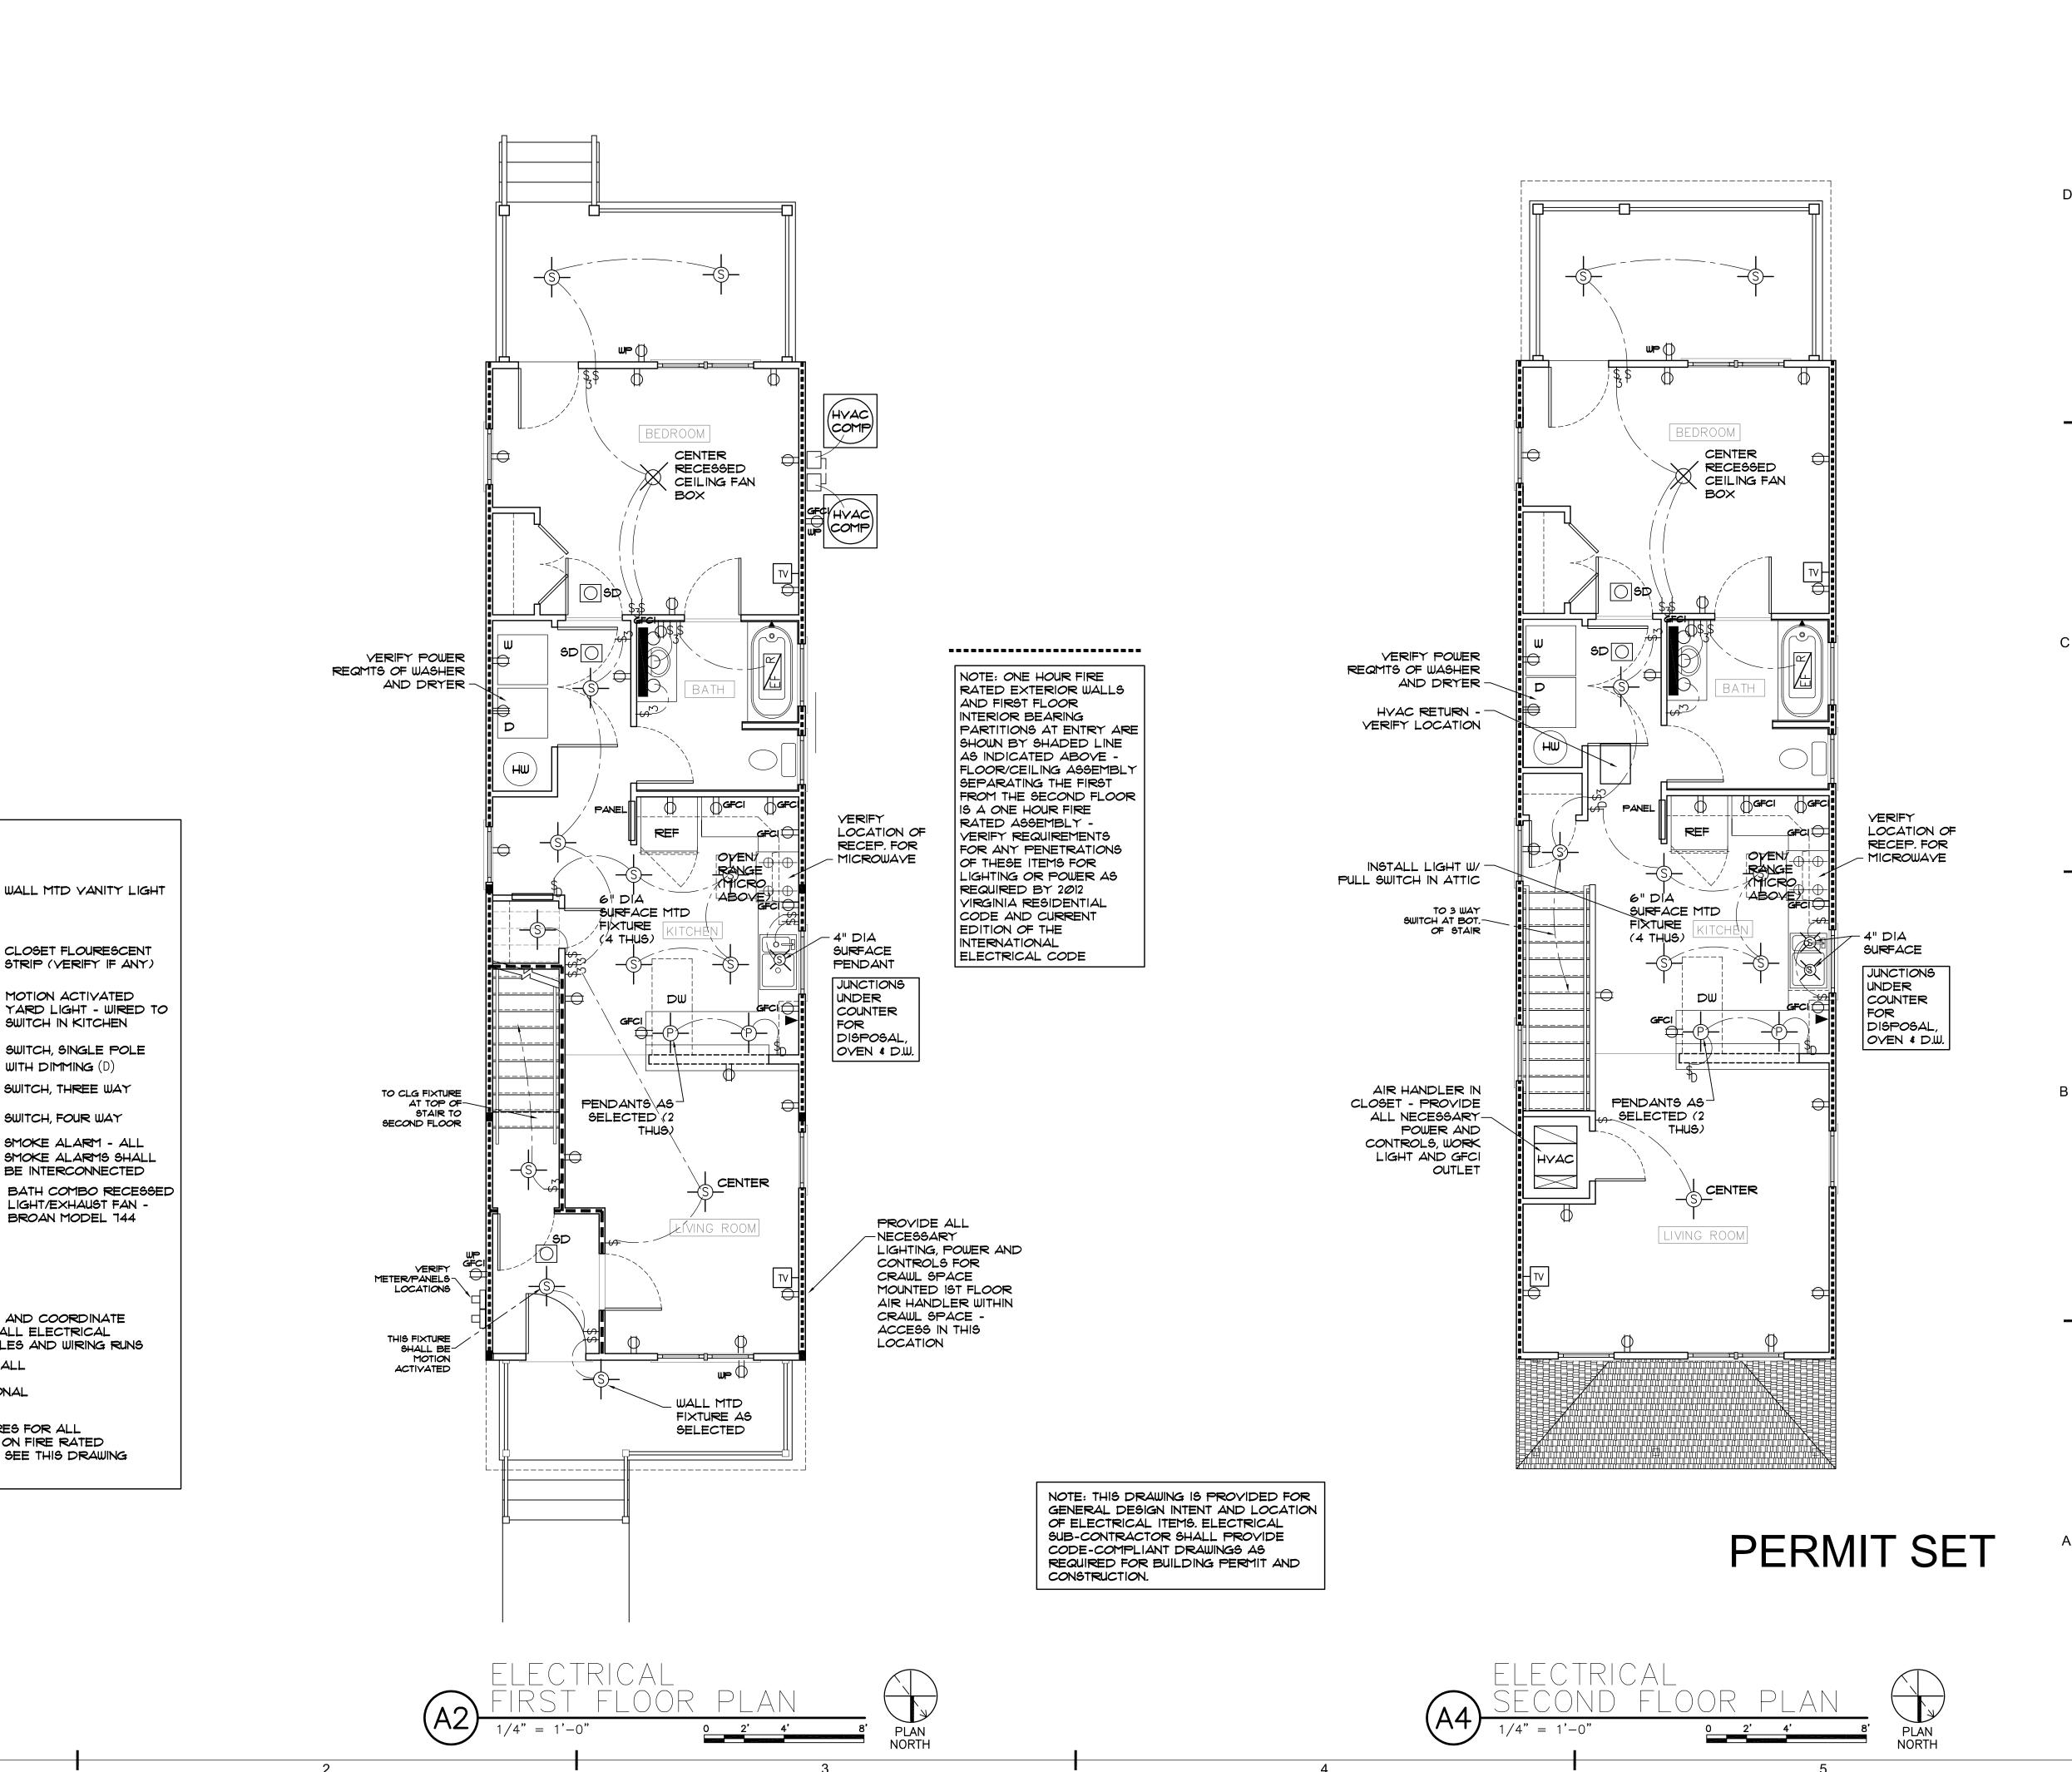

**ELECTRICAL LEGEND** 

COAXIAL TELEVISION

SURFACE MTD LIGHT W/

RATED RECESSED BOX

CEILING OR WALL

RECESSED LIGHT

PENDANT LIGHT

TELEPHONE RECEPTACLE

CEILING FAN/LIGHT W/ RATED

RECESSED CEILING BOX -

SWITCH LIGHT AND FAN SEPARATELY - TYP

DUPLEX RECEPTACLE

DUPLEX RECEPTACLE

INTERRUPTION CIRCUIT

DUPLEX RECEPTACLE

INTERRUPTION CIRCUIT

NOTE: ELECTRICAL SUBCONTRACTOR SHALL VERIFY AND COORDINATE

DEVICES INCLUDING FIXTURES, SWITCHES, RECEPTACLES AND WIRING RUNS

WITH PROJECT: HOMES THE LOCATION AND TYPE OF ALL ELECTRICAL

NOTE: ALL ELECTRICAL WORK SHALL COMPLY WITH ALL

RESIDENTIAL CODE AND CURRENT ED. OF THE NATIONAL

NOTE: PROVIDE FIRE RATED BOXES AND ENCLOSURES FOR ALL

ELECTRICAL COMPONENTS THAT MUST BE LOCATED ON FIRE RATED

WALLS OR FIRE RATED FLOOR/CEILING ASSEMBLY - SEE THIS DRAWING

APPLICABLE PROVISIONS OF THE 2012 VIRGINIA

ON GROUND FAULT

IN WATER PROOF

ENCLOSURE

ELECTRICAL CODE

AND ARCHITECTURAL.

220 YOLT RECEPTACLE

ON GROUND FAULT

CLOSET FLOURESCENT STRIP (VERIFY IF ANY)

MOTION ACTIVATED

SWITCH IN KITCHEN

WITH DIMMING (D)

SWITCH, THREE WAY

SWITCH, FOUR WAY

SMOKE ALARM - ALL

SMOKE ALARMS SHALL

BE INTERCONNECTED

LIGHT/EXHAUST FAN -BROAN MODEL 144

SWITCH, SINGLE POLE

CABLE

—(S)—

DAVID R. WINN, LLC residential design

10132 BERRYMEADE PLACE GLEN ALLEN, VIRGINIA 23060 ( 804 ) 252-0948

02.15.17 | PERMIT SET mark date description

0

2017-0001 drawn: ch'kd: E101.DWG cad #:

sheet title **ELECTRICAL PLANS** 

E-101 sheet 1 of 1

© COPYRIGHT 2017