

#### COMMISSION OF ARCHITECTURAL REVIEW

#### APPLICATION FOR CERTIFICATE OF APPROPRIATENESS

PROPERTY (local	tion of work)	Date/time rec'd:			
Address 509 W 22nd St, Richmond, Virginia, 23225			Rec'd by:		
	oringhill City and Old Histor	Application #: Hearing date:			
APPLICANT INF	ORMATION				
Name James Pop	olin		Phone 888-781-7074x1109		
Company ION Do	eveloper LLC		Email permits@ionsolar.com		
Mailing Address 4	801 N University Ave Ste 9	900	<u>Applicant Type</u> : ☐ Owner ☐ Agent		
P	rovo, UT 84604		<ul><li>☐ Lessee ☐ Architect ☒ Contractor</li><li>☐ Other (please specify):</li></ul>		
OWNER INFORI	MATION (if different from a	bove)			
Name Daniel Kra	nft		Company		
Mailing Address 5	09 W 22nd St, Richmond, \	Virginia, 23225	Phone (804) 687-2019		
,			Email brainiacdk@gmail.com		
PROJECT INFOR	MATION				
Review Type:	☐ Conceptual Review	☐ Final Review			
Project Type:	☑ Alteration	☐ Demolition	☐ New Construction (Conceptual Review Required)		
Project Description: (attach additional sheets if needed)  Installation of solar panels on existing residential roof. 2.56 kW system (8 panels).					
	F on onlying 10010	1001. <b>2.0</b> 0 II	2) 2.2.2.2. (O Paniero).		

#### **ACKNOWLEDGEMENT OF RESPONSIBILITY**

**Compliance:** If granted, you agree to comply with all conditions of the COA. Revisions to approved work require staff review and may require a new application and CAR approval. Failure to comply with the COA may result in project delays or legal action. The COA is valid for one (1) year and may be extended for an additional year, upon written request.

**Requirements:** A complete application includes all applicable information requested on checklists to provide a complete and accurate description of existing and proposed conditions. <u>Applicants proposing major new construction</u>, including <u>additions</u>, should meet with Staff to review the application and requirements prior to submitting an application. Owner contact information and signature is required. Late or incomplete applications will not be considered.

**Zoning Requirements:** Prior to Commission review, it is the responsibility of the applicant to determine if zoning approval is required and application materials should be prepared in compliance with zoning.



Date 8/28/2019

## CERTIFICATE OF APPROPRIATENESS APPLICATION INSTRUCTIONS

In advance of the application deadline please contact staff to discuss your project, application requirements, and if necessary, to make an appointment to meet with staff for a project consultation in the office or on-site. The Commission of Architectural Review website has additional project guidance and forms:

http://www.richmondgov.com/CommissionArchitecturalReview/index.aspx

Division of Planning and Preservation 804.646.6335 Carey.Jones@Richmondgov.com

#### **SUBMISSION INSTRUCTIONS**

Submit the following items to the Division of Planning and Preservation, Rm. 510, 900 E. Broad Street:

- One (1) signed and completed application <u>property owners signature required</u>
- Eleven (11) copies of supporting documentation, as indicated on appropriate check-list, collated and stapled
- All plans and elevations should be printed <u>11x17</u> and all text easily legible
- One digital copy of the application and supporting documentation, depending on size emailed to staff or saved to a thumb drive or CD and delivered with the application materials.
- Applications are due by 12 PM (noon) on the deadline date (see table below).
- <u>Exception</u>: revisions to items deferred, denied or presented conceptually at the previous Commission meeting are due one week after the application due date. Please contact staff to confirm this date.
- Application deadlines are firm. All materials must be submitted by the deadline to be considered at the
  following Commission meeting. Designs must be final at the time of application; revisions will not be
  accepted after the deadline. Incomplete and/or late applications will not be placed on the agenda.
- The Commission will <u>not</u> accept new materials, revisions, or redesigns at the meeting. Deferral until the
  following month's meeting may be necessary in such cases to allow for adequate review by staff,
  Commissioners, and public notice if required.

#### **MEETING SCHEDULE AND DUE DATES**

• Commission meetings start at 3:30 PM in the 5th floor conference room of City Hall, 900 E. Broad Street. The owner and/or applicant is *encouraged to attend* the meeting.

2019 Commission Meeting Date	Application Deadline (Friday at noon unless otherwise noted)
January 22 <sup>nd</sup>	December 28 <sup>th</sup> , 2018
February 26 <sup>th</sup>	January 25 <sup>th</sup>
March 26 <sup>th</sup>	March 1 <sup>st</sup>
April 23 <sup>rd</sup>	March 29 <sup>th</sup>
May 28 <sup>th</sup>	April 26 <sup>th</sup>
June 25 <sup>th</sup>	May 31 <sup>st</sup>
July 23 <sup>rd</sup>	June 28 <sup>th</sup>
August 27 <sup>th</sup>	July 26 <sup>th</sup>
September 24 <sup>th</sup>	August 30 <sup>th</sup>
October 22 <sup>nd</sup>	September 27 <sup>th</sup>
November 26 <sup>th</sup>	October 25 <sup>th</sup>
December 17 <sup>th</sup>	November 22 <sup>nd</sup>





TOTAL AREA OF ROOF(S) USED: 405.09FT2 TOTAL AREA OF ARRAYS: 140.800000FT<sup>2</sup> 34.76%

#### SCOPE OF WORK:

THE SYSTEM CONSISTS OF A 2.56 KW DC (1.92 KW AC) ROOF-MOUNTED PHOTOVOLTAIC POWER SYSTEM OPERATING IN PARALLEL WITH THE UTILITY GRID. THERE ARE (8) SILFAB SOLAR SLA-320M MODULES AND (8) ENPHASE IQ7-60-2-US MICRO-INVERTERS, MOUNTED ON THE BACK OF EACH PV MODULE, CONNECTING TO THE UTILITY GRID THROUGH THE EXISTING MAIN LOAD CENTER. ELECTRICAL MODIFICATIONS WILL BE MADE TO THE MAIN LOAD CENTER.

INTERCONNECTION METHOD: LOAD-SIDE BREAKER

**ROOF MATERIAL:** COMPOSITE SHINGLE

PROJECT WILL COMPLY WITH THE 2014 NEC, 2015 IRC, 2015 IBC, 2015 IFC, AND 2015 VA UNIFORM STATEWIDE BUILDING CODES. ALL CONDUIT WILL BE PAINTED TO MATCH THE EXISTING STRUCTURE.

AC DISCONNECT LOCATED NEXT TO OR WITHIN 10 FEET OF MAIN SERVICE PANEL(LINE OF SIGHT MAINTAINED).



4801 N UNIVERSITY AVE, #900 PROVO, UT 84604 (888) 781-7074

509 W 22ND STREET RICHMOND, VA 23225



LICENSED ELECTRICAL CONTRACTOR COMPANY:
ION DEVELOPER LLC,
DAVID CONRAD
CLASSIFICATION:
ELECTRICAL CONTRACTOR,
CLASS & & AES | TRADESMAN MELE
LICENSE NUMBER:

SYSTEM SIZE: 2.56 kW DC 1.92 kW AC 8 MODULES


DATE: 8/29/2019

DRAWN BY: JCC

ADDITIONAL NOTES:

SCALE: 1" = 20'-7"

COVER PV 1.0

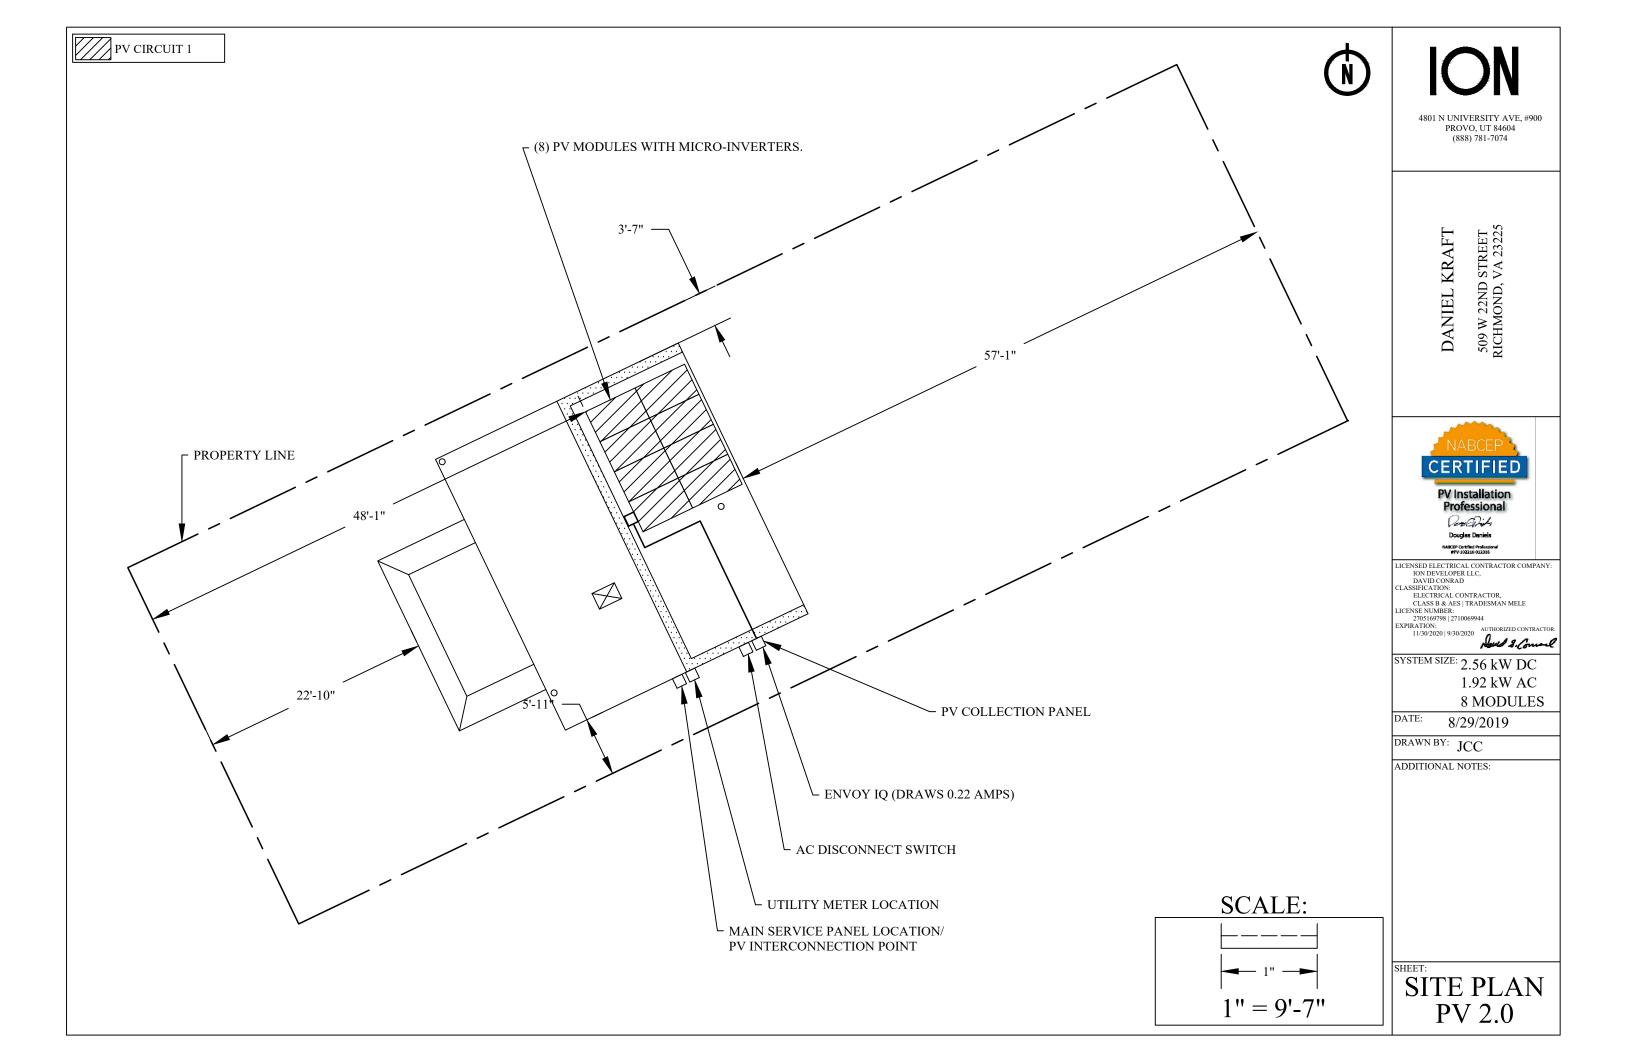

ALL WIRING WILL BE PROPERLY SUPPORTED BY DEVICES OR MECHANICAL MEANS DESIGNED AND LISTED FOR SUCH USE AND WIRING WILL BE PERMANENTLY AND COMPLETELY HELD OFF OF THE ROOF SURFACE

ALL ARRAY SUPPORTS/MOUNTS SHALL BE STAGGERED FROM ONE ROW OF RACKING TO THE NEXT SUCH THAT NOT ALL SUPPORTS/MOUNTS DISTRIBUTE LOAD ONTO THE SAME TRUSSES



4801 N UNIVERSITY AVE, #900 PROVO, UT 84604 (888) 781-7074

DANIEL KRAFT

509 W 22ND STREET RICHMOND, VA 23225



LICENSED ELECTRICAL CONTRACTOR COMPANY:
ION DEVELOPER LLC,
DAVID CONRAD
CLASSIFICATION:
ELECTRICAL CONTRACTOR,
CLASS & & AES | TRADESMAN MELE
LICENSE NUMBER:

2705169798 | 2710069944 EXPIRATION: 11/30/2020 | 9/30/2020

SYSTEM SIZE: 2.56 kW DC 1.92 kW AC 8 MODULES

DATE: 8/29/2019

DRAWN BY: JCC

ADDITIONAL NOTES:


2" X 6" RAFTER SYSTEM 20" ON CENTER

CANTILEVERS WILL BE NO MORE THAN 24"


ATTACHMENT POINTS WILL BE NO MORE THAN 4' APART, STAGGERED

FIRE CODE OFFSET

ROOF PLAN PV 3.0

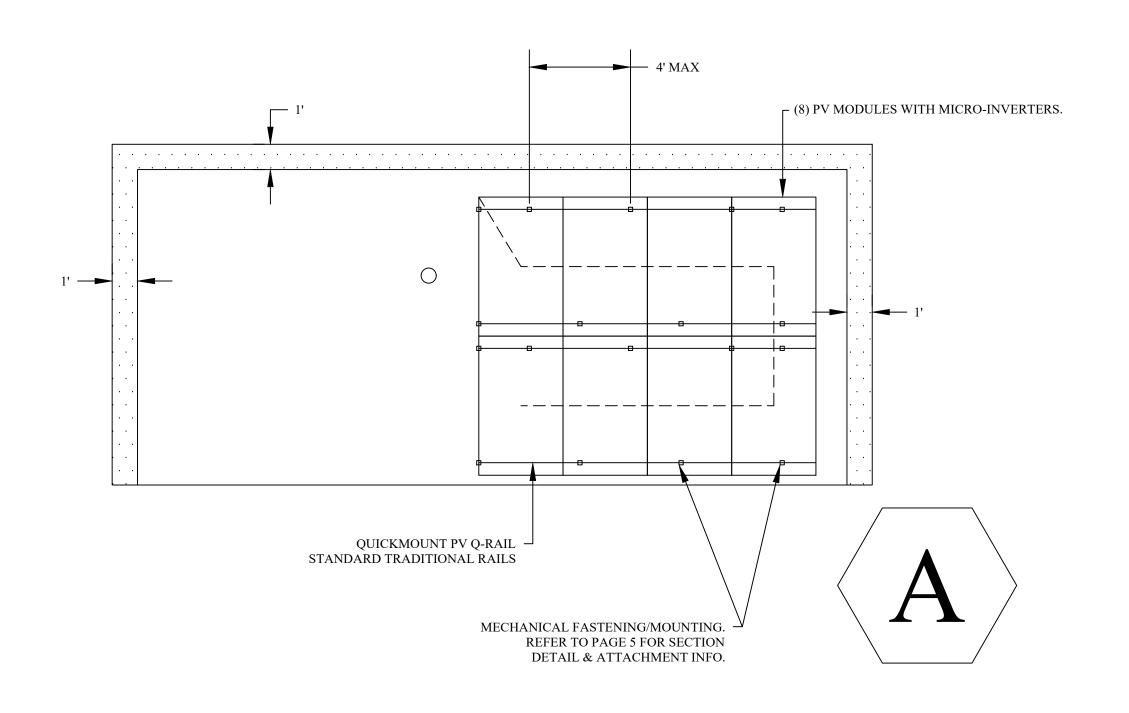

ROOF SECTION DATA								
ROOF SECTION	A	В	С	D	Е	F	G	Н
MODULES	8							
TILT	39							
AZIMUTH	244							
SOLAR ACCESS AVG.	99.00%							

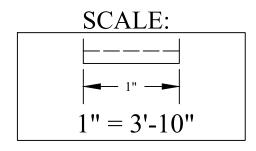

WEATHER DATA				
HIGH TEMP, 2% AVG.	34 °C			
MIN DESIGN TEMP	-13 °C			
GROUND SNOW LOAD	20 psf			
WIND SPEED	115 mph			

- 1. HIGH TEMPERATURE 2% AVERAGE BASED ON ASHRAE HIGHEST MONTH 2% DRY BULB TEMPERATURE FOR ASHRAE LOCATION MOST SIMILAR TO INSTALLATION LOCATION
- 2. MINIMUM DESIGN TEMPERATURE BASED ON ASHRAE MINIMUM MEAN EXTREME DRY BULB TEMPERATURE FOR ASHRAE LOCATION MOST SIMILAR TO INSTALLATION LOCATION
- 3. ALTERNATE POWER SOURCE PLACARD SHALL BE PERMANENTLY ATTACHED TO A/C DISCONNECT
- 4. ELECTRICAL INSTALL SHALL COMPLY WITH 2014 NATIONAL ELECTRICAL CODE
- 5. ALL SOLAR MODULES, EQUIPMENT, AND METALLIC COMPONENTS SHALL BE BONDED
- 6. IF THE EXISTING MAIN SERVICE DOES NOT HAVE VERIFIABLE GROUNDING ELECTRODE, IT IS THE PV CONTRACTOR'S RESPONSIBILITY TO INSTALL A SUPPLEMENTAL GROUNDING ELECTRODE
- 7. EACH MODULE SHALL BE GROUNDED PER MANUFACTURER INSTRUCTIONS AND APPROVED METHODS

- 8. PV INSTALLATION SHALL NOT OBSTRUCT ANY PLUMBING, MECHANICAL OR BUILDING ROOF VENTS
- 9. CONNECTORS THAT ARE NOT READILY
  ACCESSIBLE AND THAT ARE USED IN THE
  CIRCUITS OPERATING AT OR OVER 30V AC OR
  DC SHALL REQUIRE A TOOL FOR OPERATING
  AND ARE REQUIRED TO BE MARKED "DO NOT
  DISCONNECT UNDER LOAD" OR "NOT FOR
  CURRENT INTERRUPTING"
- 10. THIS SYSTEM IS IN FULL COMPLIANCE WITH
  2014 NATIONAL ELECTRIC CODE AND STATE OF
  VIRGINIA AMENDMENTS FOR PHOTOVOLTAIC
  INSTALLATION, AND ARTICLE 690 OF THE
  NATIONAL ELECTRIC CODE (NEC NFPA 70)
- 11. BUILDING CONSTRUCTION TYPE: TYPE V
- 12. BUILDING OCCUPANCY TYPE: R3



4801 N UNIVERSITY AVE, #900 PROVO, UT 84604 (888) 781-7074

ANIEL KRAFT

509 W 22ND STREET RICHMOND, VA 23225



LICENSED ELECTRICAL CONTRACTOR COMPANY:
ION DEVELOPER LLC,
DAVID CONRAD
CLASSIFICATION:
ELECTRICAL CONTRACTOR,
CLASS B & AES | TRADESMAN MELE

CLASS B & AES | TRADESMAN MEI LICENSE NUMBER: 2705169798 | 2710069944

EXPIRATION: 11/30/2020 | 9/30/2020 AUTHORIZED CO

2 56 kW DC

SYSTEM SIZE: 2.56 kW DC 1.92 kW AC 8 MODULES


DATE: 8/29/2019

DRAWN BY: JCC

ADDITIONAL NOTES:

SHEET:

LOCATION NOTES PV 4.0

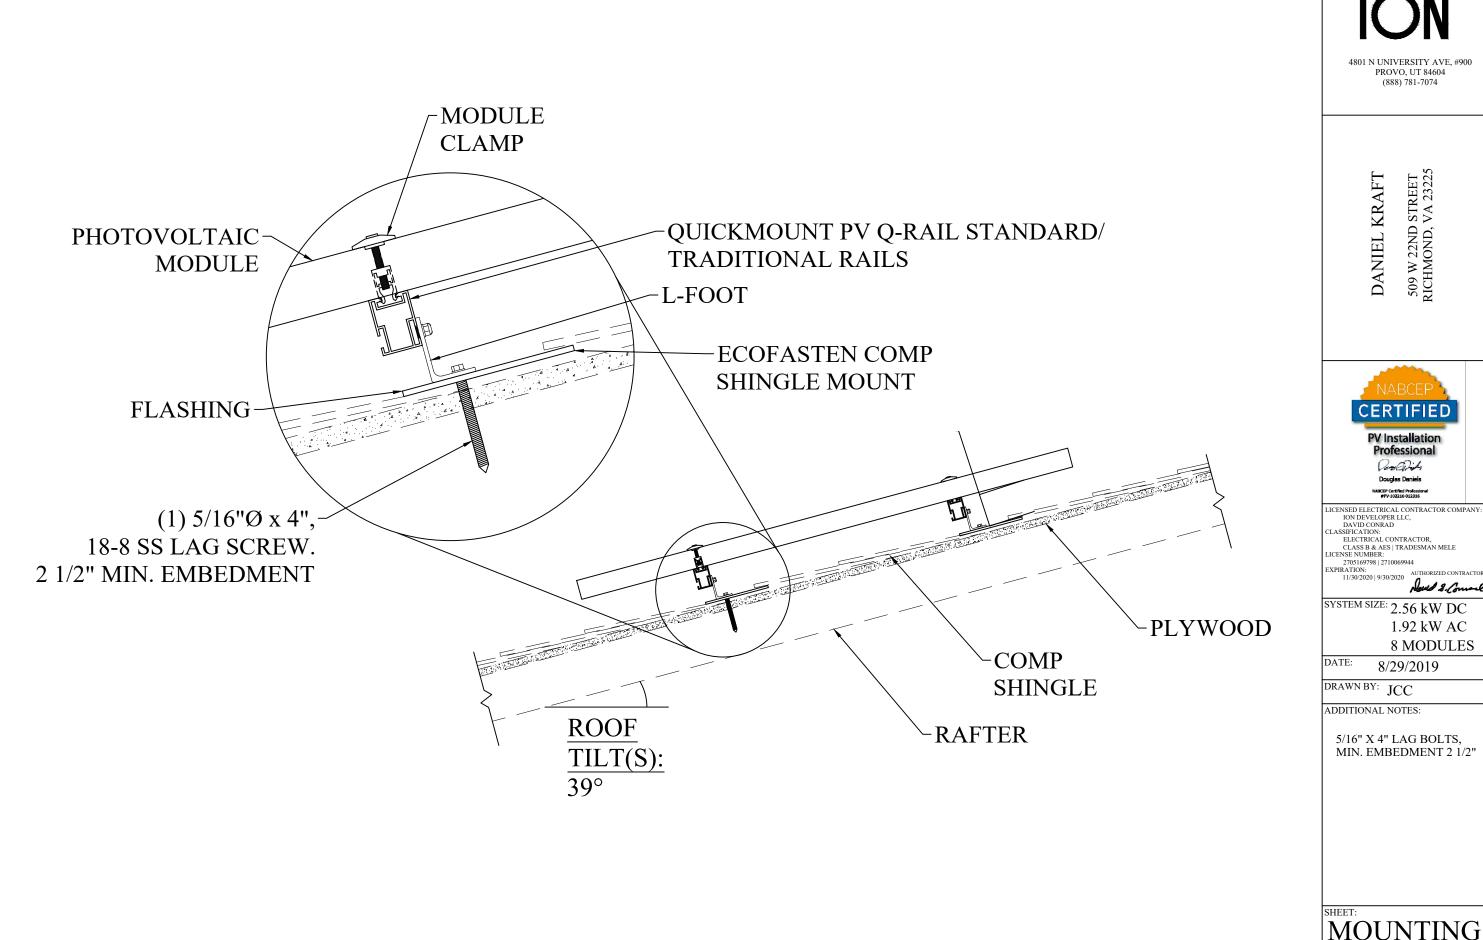

MOUNTING PV 5.0

#### THIS PV SYSTEM WILL HAVE THE FOLLOWING MARKINGS:

- 1 -- MATERIALS USED FOR MARKINGS WILL BE WEATHER RESISTANT. THE UNDERWRITERS LABORATORIES MARKING AND LABELING SYSTEM 969 (UL969) WILL BE USED AS STANDARD TO DETERMINE WEATHER RATING.
- 2 -- MARKING STATING "CAUTION: SOLAR ELECTRIC SYSTEM CONNECTED" WILL BE PLACED AT THE MAIN SERVICE DISCONNECT.
- 3 -- MARKING STATING "WARNING: PHOTOVOLTAIC POWER SOURCE" WILL BE PLACED ALONG DIRECT CURRENT CONDUIT, RACEWAYS, ENCLOSURES, CABLE ASSEMBLIES, AND JUNCTION BOXES.
- 4 -- THE MARKING WILL BE MADE TO THE FOLLOWING SPECIFICATIONS:
- **RED BACKGROUND**
- WHITE LETTERING
- MINIMUM 3/8" LETTER HEIGHT
- ALL CAPITAL LETTERS
- ARIAL OR SIMILAR FONT, NON-BOLD
- REFLECTIVE, WEATHER RESISTANT MATERIAL SUITABLE FOR THE ENVIRONMENT (DURABLE ADHESIVE MATERIALS MAY MEET THIS REQUIREMENT)
- 5 -- MARKING WILL BE PLACED ON ALL INTERIOR AND EXTERIOR CONDUIT, RACEWAYS, ENCLOSURES, CABLE ASSEMBLIES, AND JUNCTION BOXES TO ALERT THE FIRE SERVICE TO AVOID CUTTING THEM. MARKINGS WILL BE PLACED ON ALL EXTERIOR DC CONDUIT, RACEWAYS, ENCLOSURES, AND CABLE ASSEMBLIES EVERY 10 FEET, AT TURNS AND ABOVE AND/OR BELOW PENETRATIONS AND ALL DC COMBINER AND JUNCTION BOXES.





ICENSED ELECTRICAL CONTRACTOR CO!
ION DEVELOPER LLC,
DAVID CONRAD
LASSIFICATION:
ELECTRICAL CONTRACTOR,
CLASS B & AES | TRADESMAN MELE
(CRESS ELIA DEL).

SYSTEM SIZE: 2.56 kW DC 1.92 kW AC 8 MODULES

DATE: 8/29/2019

DRAWN BY: JCC

ADDITIONAL NOTES:

SHEET:

SYSTEM MARKINGS

PV 6.0

## **PV SOLAR BREAKER**

DO NOT RELOCATE
THIS OVERCURRENT
DEVICE

23-S

DO NOT RELOCATE THIS OVERCURRENT DEVICE

PHOTOVOLTAIC SOLAR BREAKER



SOLAR ELECTRIC CIRCUIT BREAKER IS BACKFED

NEXT TO ALL SOLAR BREAKERS (DIFFERENT STYLES TO MEET LOCAL CODES)




NEC 690.17 (4) SERVICE PANEL - AC DISCONNECT - SUB PANEL THIS ELECTRIC SYSTEM
IS ALSO SERVED BY A
PHOTOVOLTAIC SYSTEM

\*\*WARNING \*\*
THIS SERVICE METER
IS ALSO SERVED BY A
PHOTOVOLTAIC SYSTEM

LOCAL CODES
MAIN SERVICE PANEL AND METER



PANEL WITH SOLAR BACKFED BREAKER

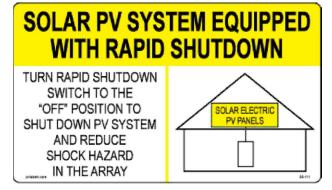

NEC 690.56(C)(1)(A)

LABEL PLACED FOR PV SYSTEMS THAT SHUT DOWN THE ARRAY AND CONDUCTORS LEAVING THE ARRAY LEVEL (AFTER THE MICRO-INVERTER OUTPUT TERMINALS)

LOCATED NO MORE THAN 3 FT. AWAY FROM THE SERVICE DISCONNECTING MEANS TO WHICH THE PV SYSTEMS ARE CONNECTED AND AT ALL IDENTIFIED RAPID SHUTDOWN SWITCHES IF NOT IN THE SAME LOCATION

### PHOTOVOLTAIC SYSTEM COMBINER PANEL DO NOT ADD LOADS

COMBINER PANEL OR SOLAR LOAD CENTER

## MAIN SOLAR SYSTEM AC DISCONNECT


AC DISCONNECT



SOLAR REC METER



NEC 690.64 & NEC 705.12 (D)(4) SERVICE PANEL

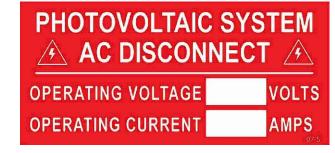

NEC 690.54 AC DISCONNECT



DANIEL KRAFT 509 W 22ND STREET RICHMOND, VA 23225

NABCEP
CERTIFIED

PV Installation
Professional

Douglas Daniels

NABCEP

NABLEP

NABLE

LICENSED ELECTRICAL CONTRACTOR COMPANY
ION DEVELOPER LLC,
DAVID CONRAD
CLASSIFICATION:
ELECTRICAL CONTRACTOR,
CLASS B & AES | TRADESMAN MELE
LICENSE NUMBER:
2705169798 | 2710069944
FXPIR ATION:

SYSTEM SIZE: 2.56 kW DC

1.92 kW AC 8 MODULES

DATE: 8/29/2019

DRAWN BY: JCC


ADDITIONAL NOTES:

SHEET:

LABELS & SIGNAGE PV 7.0

PV MODULE SPECIFICATIONS					
MODULE MAKE AND MODEL SILFAB SLA 320M					
MAXIMUM POWER (DC)	320	WATTS			
MAX POWER-POINT VOLTAGE (VMPP)	33.7	VOLTS			
MAX POWER-POINT CURRENT (IMPP)	9.50	AMPS			
OPEN CIRCUIT VOLTAGE (VOC)	40.45	VOLTS			
SHORT CIRCUIT CURRENT (ISC)	9.96	AMPS			
TEMPERATURE COEFFICIENT VOC	-0.3	%/°C			
MAXIMUM SYSTEM VOLTAGE	1000V DC (UL)				

MICRO-INVERTER SPECIFICATIONS					
INVERTER MAKE AND MODEL	ENPHASE IQ7-60-2-U	IS .			
RATED OUTPUT POWER (AC)	240	WATTS			
NOMINAL OUTPUT VOLTAGE (AC)	240	VOLTS			
MAX OUTPUT CURRENT (AC)	1	AMPS			
MAX INPUT VOLTAGE (DC)	48	VOLTS			
MAX INPUT CURRENT (DC)	15	AMPS			
MAX OCPD RATING (AC)	20	AMPS			
MAX NUMBER OF PANELS PER CIRCUIT	16				

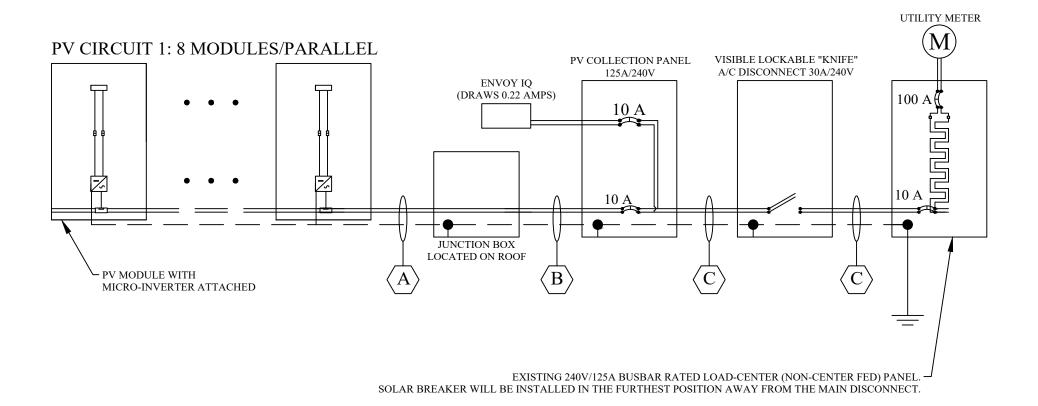

AC PHOTOVOLTAIC SYSTEM RATINGS					
MAX AC OPERATING CURRENT	8	AMPS			
MAX AC OPERATING VOLTAGE	240	VOLTS			

\*ROMEX/MC CABLE WILL BE RAN THROUGH THE ATTIC WHERE POSSIBLE

	RACEWAY AND CONDUCTOR SCHEDULE							
TAG	CONDUCTOR TYPE	MINIMUM WIRE SIZE	# OF CONDUCTORS	RACEWAY / CABLE TYPE	MINIMUM CONDUIT SIZE			
	ENPHASE Q-CABLE (USE-2)	12	2	USE-2 / FREE AIR	EDEE AID			
A	BARE COPPER (EGC)	6	1	BARE / FREE AIR	FREE AIR			
В	THWN-2 OR NM (ROMEX/MC) *	10	2	EMT OR ROMEWAYS CARLE	3/4"			
	THWN-2 OR NM (ROMEX/MC) (EGC)	10	1	EMT OR ROMEX/MC CABLE				
С	THWN-2	10	3	F) (T	3/4"			
	THWN-2 (EGC)	10	1	EMT				

4801 N UNIVERSITY AVE, #900 PROVO, UT 84604 (888) 781-7074

DANIEL KRAFT

509 W 22ND STREET RICHMOND, VA 23225



LICENSED ELECTRICAL CONTRACTOR COMPANY:
ION DEVELOPER LLC,
DAVID CONRAD
CLASSIFICATION:
ELECTRICAL CONTRACTOR,
CLASS & & AES | TRADESMAN MELE
LICENSE NUMBER:
2705169798 | 2710069944
EXPIRATION:
11/30/2020 | 9/30/2020

SYSTEM SIZE: 2.56 kW DC 1.92 kW AC 8 MODULES

DATE: 8/29/2019

DRAWN BY: JCC

ADDITIONAL NOTES:

SHEET:

1-LINE EL 1.0

1. THE ENPHASE IQ6, IQ7, M250, M215 (M215-60-2LL-SXX-IG), AND C250 FOURTH GENERATION MICROINVERTERS MEET THE REQUIREMENTS OF THE NATIONAL ELECTRICAL CODE ARTICLE 690.35 FOR UNGROUNDED PHOTOVOLTAIC POWER SYSTEMS. NEC 690.35 ALLOWS FOR PHOTOVOLTAIC POWER SYSTEMS TO BE INSTALLED WITH UNGROUNDED PHOTOVOLTAIC SOURCE AND OUTPUT CIRCUITS. SYSTEMS THAT MEET THE REQUIREMENTS OF NEC 690.35 ARE EXEMPT FROM THE SYSTEM GROUNDING REQUIREMENTS OF NEC 690.41 SYSTEM GROUNDING.


2. NEC ARTICLE 690.43 EQUIPMENT
GROUNDING SPECIFIES THAT ALL
EXPOSED NON-CURRENT-CARRYING

METAL PARTS OF PV MODULE FRAMES, ELECTRICAL EQUIPMENT, AND CONDUCTOR ENCLOSURES SHALL BE PROVIDED WITH EQUIPMENT GROUNDING. 690.43(C) STRUCTURE AS EQUIPMENT GROUNDING CONDUCTOR ALLOWS FOR EQUIPMENT TO BE USED AS THE EQUIPMENT GROUNDING CONDUCTOR IN A PHOTOVOLTAIC SYSTEM. SPECIFICALLY, "DEVICES LISTED AND IDENTIFIED FOR GROUNDING THE METALLIC FRAMES OF PV MODULES OR OTHER EQUIPMENT SHALL BE PERMITTED TO BOND THE EXPOSED METAL SURFACES OR OTHER EQUIPMENT TO MOUNTING SURFACES." THE DEVICES LISTED AND IDENTIFIED FOR GROUNDING THE EQUIPMENT MAY BE STAND-ALONE GROUNDING COMPONENTS

OR UL-2703 LISTED MOUNTING HARDWARE. IN AN ENPHASE MICROINVERTER SYSTEM, IF THE MICROINVERTERS AND MODULES ARE BONDED TO THE RACKING ASSEMBLIES WITH THE USE OF LISTED AND APPROVED GROUNDING CLIPS OR GROUNDING COMPONENTS, THE EQUIPMENT GROUNDING CONDUCTOR PROVIDED TO THE MICROINVERTERS THROUGH THE ENPHASE ENGAGE CABLE MAY ALSO BE USED TO GROUND THE OTHER PHOTOVOLTAIC SYSTEM COMPONENTS.



DANIEL KRAFT 509 W 22ND STREET RICHMOND, VA 23225

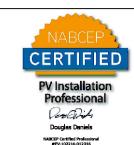

LICENSED ELECTRICAL CONTRACTOR COMPANY:
ION DEVELOPER LLC,
DAVID CONRAD
CLASSIFICATION:
ELECTRICAL CONTRACTOR,
CLASS & & AES | TRADESMAN MELE

LICENSE NUMBER: 2705169798 | 2710069944

AUTHORIZED CONTRAC

SYSTEM SIZE: 2.56 kW DC 1.92 kW AC 8 MODULES

DATE: 8/29/2019

DRAWN BY: JCC

ADDITIONAL NOTES:

SHEET:

ELECTRICAL NOTES

EL 2.0

# ELECTRICAL PHOTOS



4801 N UNIVERSITY AVE, #900 PROVO, UT 84604

ANIEL KRAFT

509 W 22ND STREET RICHMOND, VA 23225



LICENSED ELECTRICAL CONTRACTOR COMPANY:
ION DEVELOPER LLC,
DAVID CONRAD
CLASSIFICATION:
ELECTRICAL CONTRACTOR,
CLASS & AES | TRADESMAN MELE
LICENSE NUMBER:
2755 (4700) 1710 (470)

2705169798 | 2710069944 EXPIRATION: 11/30/2020 | 9/30/2020

Jul 3. Commel

SYSTEM SIZE: 2.56 kW DC 1.92 kW AC 8 MODULES

DATE: 8/29/2019


DRAWN BY: JCC

ADDITIONAL NOTES:

SHEET


ELECTRICAL PHOTOS

PV 8.0

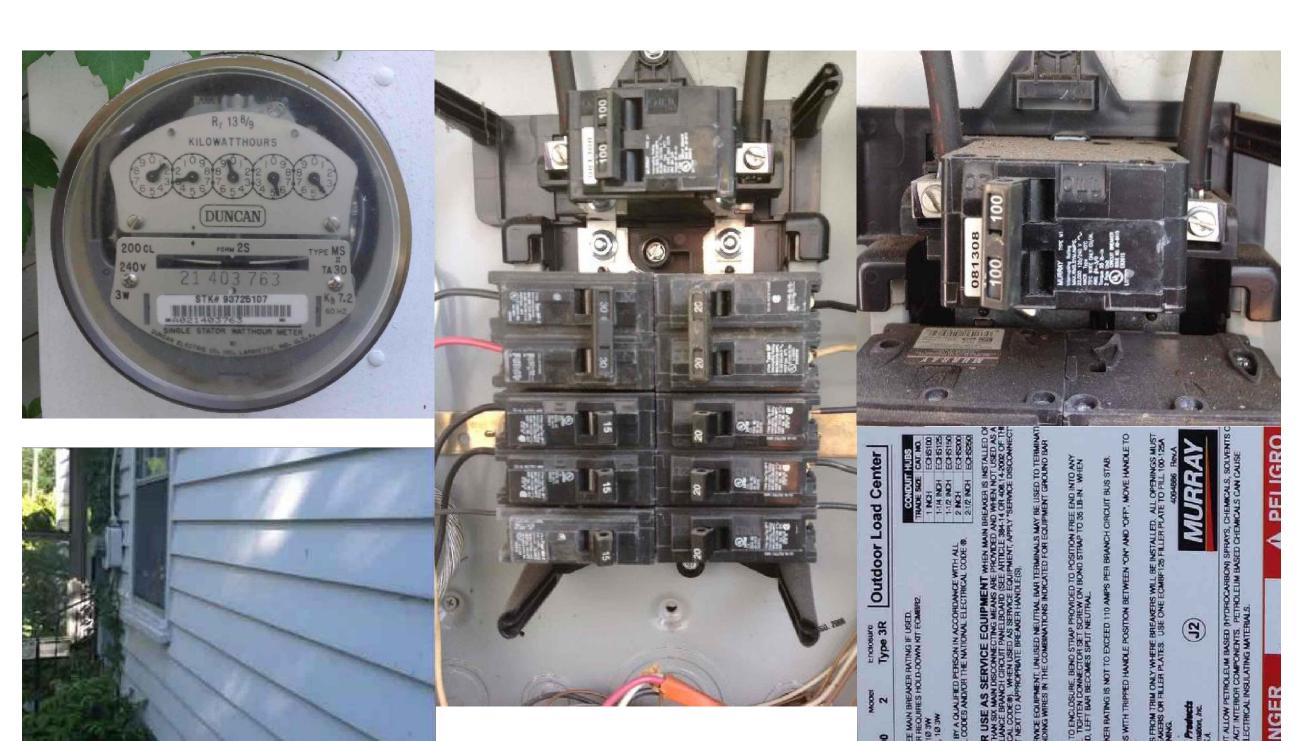



509 W 22ND STREET RICHMOND, VA 23225 DANIEL KRAFT

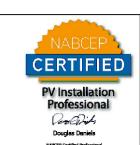

LICENSED ELECTRICAL CONTRACTOR COMPANY:
ION DEVELOPER LLC,
DAVID CONRAD
CLASSIFICATION:
ELECTRICAL CONTRACTOR,
CLASS & ASE | TRADESMAN MELE
LICENSE NUMBER:
2705169798 | 2710069944
EXPIRATION:
11/30/2020 | 9/30/2020

SYSTEM SIZE: 2.56 kW DC 1.92 kW AC 8 MODULES

DATE: 8/29/2019

DRAWN BY: JCC

ADDITIONAL NOTES:

ELEVATION VIEW PV 9.0

