

City of Richmond Department of Planning & Development Review


Location, Character, and Extent

LOCATION: E. 4th St. and Maury St.


COUNCIL DISTRICT: 6

PROPOSAL: Final location, character, and extent review of traffic operation and safety improvements at

Maury Street and I-95 interchange.

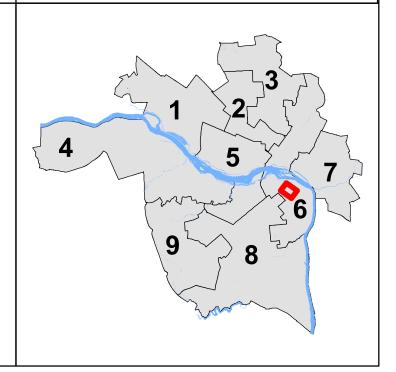

For questions, please contact Josh Son at 646-3741 or joshua.son@richmondgov.com

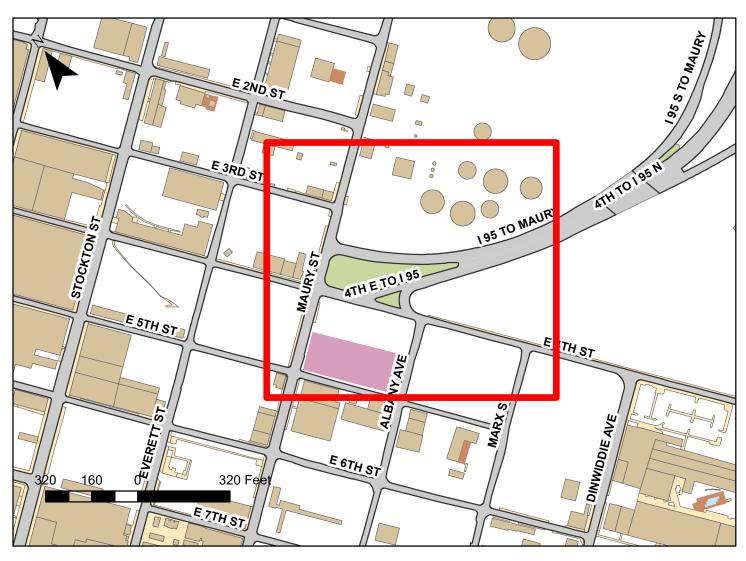



Application for Urban Design Committee Review

Department of Planning and Development Review Planning & Preservation Division 900 E. Broad Street, Room 510 Richmond, Virginia 23219 | (804) 646-6335 www.richmondgov.com/CommitteeUrbanDesign



Application Type (select one)		Review Type (select one)
Location, Character, & Extent Section 17.05 Other:	Encroachment Design Overlay District	Conceptual Final
Project Information		Submission Date:
Project Name:		
Project Address:		
Applicant Information (a City repre:	sentative must be the applicant, w	ith an exception for encroachments)
Name:	Email:	
City Agency:		Phone:
Main Contact (if different from Appl		
Company:		Phone:
Email:		

Submittal Deadlines

All applications and support materials must be filed no later than 21 days prior to the scheduled meeting of the Urban Design Committee (UDC). Please see the schedule on page 3 as actual deadlines are adjusted due to City holidays. Late or incomplete submissions will be deferred to the next meeting.

Filing

Applications can be mailed or delivered to the attention of "Urban Design Committee" at the address listed at the top of this page. It is important that the applicant discuss the proposal with appropriate City agencies, Zoning Administration staff, and area civic associations and residents prior to filing the application with the UDC.

Submittal Deadlines

The UDC is a ten member committee created by City Council in 1968 whose purpose is to advise the City Planning Commission (CPC) on the design of projects on City property or right-of-way. The UDC provides advice of an aesthetic nature in connection with the performance of the duties of the Commission under Sections 17.05, 17.06, and 17.07 of the City Charter. The UDC also advises the Department of Public Works in regards to private encroachments in the public right-of-way.



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Submssion Requirements

- •An electronic copy (PDF preferred) of all application materials, which can be emailed, or delivered by FTP or USB.
- •Three (3) copies of the application cover sheet and all support materials (see below).
- •Plan sheets should be 11" x 17", folded to 8 1/2" x 11". If it is not possible to scale plans to these dimensions, please provide one set of larger, scaled plans.
- •All applications must include the attached cover sheet and the following support materials, as applicable to the project, based on Review Type:

Conceptual Review:

- •A detailed project narrative which includes the following: purpose of the project, project background, project budget and funding sources, description of construction program and estimated construction start date (description should also provide information on the surrounding area to provide context).
- •A site plan for the project indicating site characteristics which include: building footprints, parking areas, pedestrian routes, recreation areas, open areas, and areas of future expansion.
- •A set of floor plans and elevations, as detailed as possible.
- •A landscaping plan which shows the general location and character of plant materials and notes any existing tree to be removed.

Final Review:

- •A detailed project narrative which includes the following: purpose of the project, project background, project budget and funding sources, description of construction program, and estimated construction start date (description should also provide information on the surrounding area to provide context).
- •A site plan for the project indicating site characteristics which include: building footprints, parking areas, pedestrian routes, recreation areas, open areas, and areas of future expansion.
- •A set of floor plans and elevations, as detailed as possible.
- •A landscaping plan that includes a complete plant schedule, the precise location of all plant materials, and a landscape maintenance analysis. The plant schedule must show number, size and type of each planting proposed. If existing trees are to be removed, their size, type, and location must be noted on the landscape plan.
- •The location of all lighting units should be noted on a site plan, including wall-mounted, site, and parking lot lighting. Other site details such as benches, trash containers, and special paving materials should also be located. Include specification sheets for each item.
- •Samples of all proposed exterior building materials, including but not limited to brick, mortar, shingles, siding, glass, paint, and stain colors. When an actual sample cannot be provided, a product information sheet that shows the item or a photo of an existing item may be substituted.

Review and Processing

- •Once an application is received, it is reviewed by Staff, who compiles a report that is sent to the UDC.
- A copy of the report and the meeting agenda will be sent to the applicant prior to the meeting.
- •At the UDC meeting, the applicant or a representative should be present or the application may be deferred to the next regularly scheduled meeting. It is also strongly suggested that a representative of the City Agency which will have final responsibility for the item be present at the meeting (if the applicant and the representative are not the same).
- •Once the UDC recommends action on the application, it is automatically placed on the agenda for the next City Planning Commission (CPC) meeting. Exceptions to this are encroachment applications, recommendations for which are forwarded to the Department of Public Works.
- •At the CPC meeting, the applicant or a representative should be present, or the application may be deferred to the next regularly scheduled meeting.

last revised 6/10/2019



Application for Urban Design Committee Review

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Regular meetings are scheduled on the Thursday after the first Monday of each month at 10:00 a.m. in the 5th floor conference room of City Hall, 900 E. Broad Street. Special meetings are scheduled as needed.

Meeting Schedule 2019

Submission Deadline						
November 15, 2018						
December 13, 2018						
January 17, 2019						
February 14, 2019						
March 14, 2019						
April 11, 2019						
May 16, 2019						
June 13, 2019						
July 11, 2019**						
August 15, 2019						
September 12, 2019						
October 17, 2019						
November 14, 2019						

UDC Meeting	CPC meeting to follow UDC
December 6, 2018	December 17, 2018
January 10, 2019	January 22, 2019 ¹
February 7, 2019	February 19, 2019 ²
March 7, 2019	March 18, 2019
April 4, 2019	April 15, 2019
May 9, 2019	May 20, 2019
June 6, 2019	June 17, 2019
July 3, 2019**	July 15, 2019
August 8, 2019	August 19, 2019³
September 5, 2019	September 16, 2019
October 10, 2019	October 21, 2019
November 7, 2019	November 18, 2019
December 5, 2019	December 16, 2019

¹ Monday, January 21, 2019 is a City of Richmond Holiday.

The Richmond Urban Design Committee is a ten member advisory committee created by City Council in 1968. Its purpose is to advise the City Planning Commission on the design of City projects. The Urban Design Committee reviews projects for appropriateness in "location, character, and extent" and for consistency with the City's Master Plan and forwards recommendations to the City Planning Commission. The Urban Design Committee also advises the Department of Public Works in regards to private encroachments in the public right-of-way.

For more information, please contact the Planning and Preservation Division staff at (804) 646-6335 or the Secretary to the Urban Design Committee at (804) 646-3741 or at joshua.son@richmondgov.com.

² Monday, February 18, 2019 is a City of Richmond Holiday.

³ This August CPC Meeting may be canceled. If so, the meeting would be Tuesday, September 3, 2019.

^{**} Moved forward to account for Independence Day

Date: February 11, 2020

I-95 at Maury Street Interchange Improvement

Virginia Department of Transportation VDOT UPC # 109321

LOCATION:

Intersection of I-95 Ramps and Maury Street / 4th Street.

ESTIMATED PROJECT COST:

Based on 90% Plans

PE \$1,087,500
RW \$1,882,795
CN \$6,220,955
Total \$9,191,250

FUNDING SOURCE:

Project fully funded through Smart Scale.

PROJECT SCHEDULE


Design: Started Winter 2016
Right-of-Way: Started Summer 2018
Advertisement for Construction: Expected July 2020
Completion of Construction: Expected July 2021

PROJECT DESCRIPTION:


This project will provide a gateway with improved traffic operation and safety to the historic Manchester Industrial District for all users by constructing a single lane roundabout on Maury Street at the bottoms of the I-95 Ramps. Two existing traffic signals on Maury Street at East 4th Street and at I-95 Off-Ramp will be eliminated. The roundabout is expected to significantly reduce the vehicle queuing during peak hours on both the I-95 Off-Ramp and Maury Street approaches. In addition to the roundabout, the project scope includes pedestrian and bicycle enhancements, lighting, and landscaping. This project involves both right-of-way acquisitions and utility relocations.

The idea of installing a roundabout at this location came up in the "I-95, Maury, and Hull Street Area Transportation Study" for the City of Richmond in 2011. In 2015 the Richmond Regional Transportation Planning Organization RRTPO submitted the "EI-95 and Maury Street Freight Interchange Improvements" for the House Bill 2 Program. The program name was later changed to be called the "Smart Scale" program.

Funding for the project was made available in FY2017 through Federal and State Smart Scale funds. PE was authorized on October 14, 2016 and all funds will become available in FY2022. The Virginia Department of Transportation (VDOT) is responsible for the project development and construction. No funding is required from the City in this project. Once construction is complete, VDOT will be responsible to maintain the I-95 on and off ramps while the City will maintain the rest.

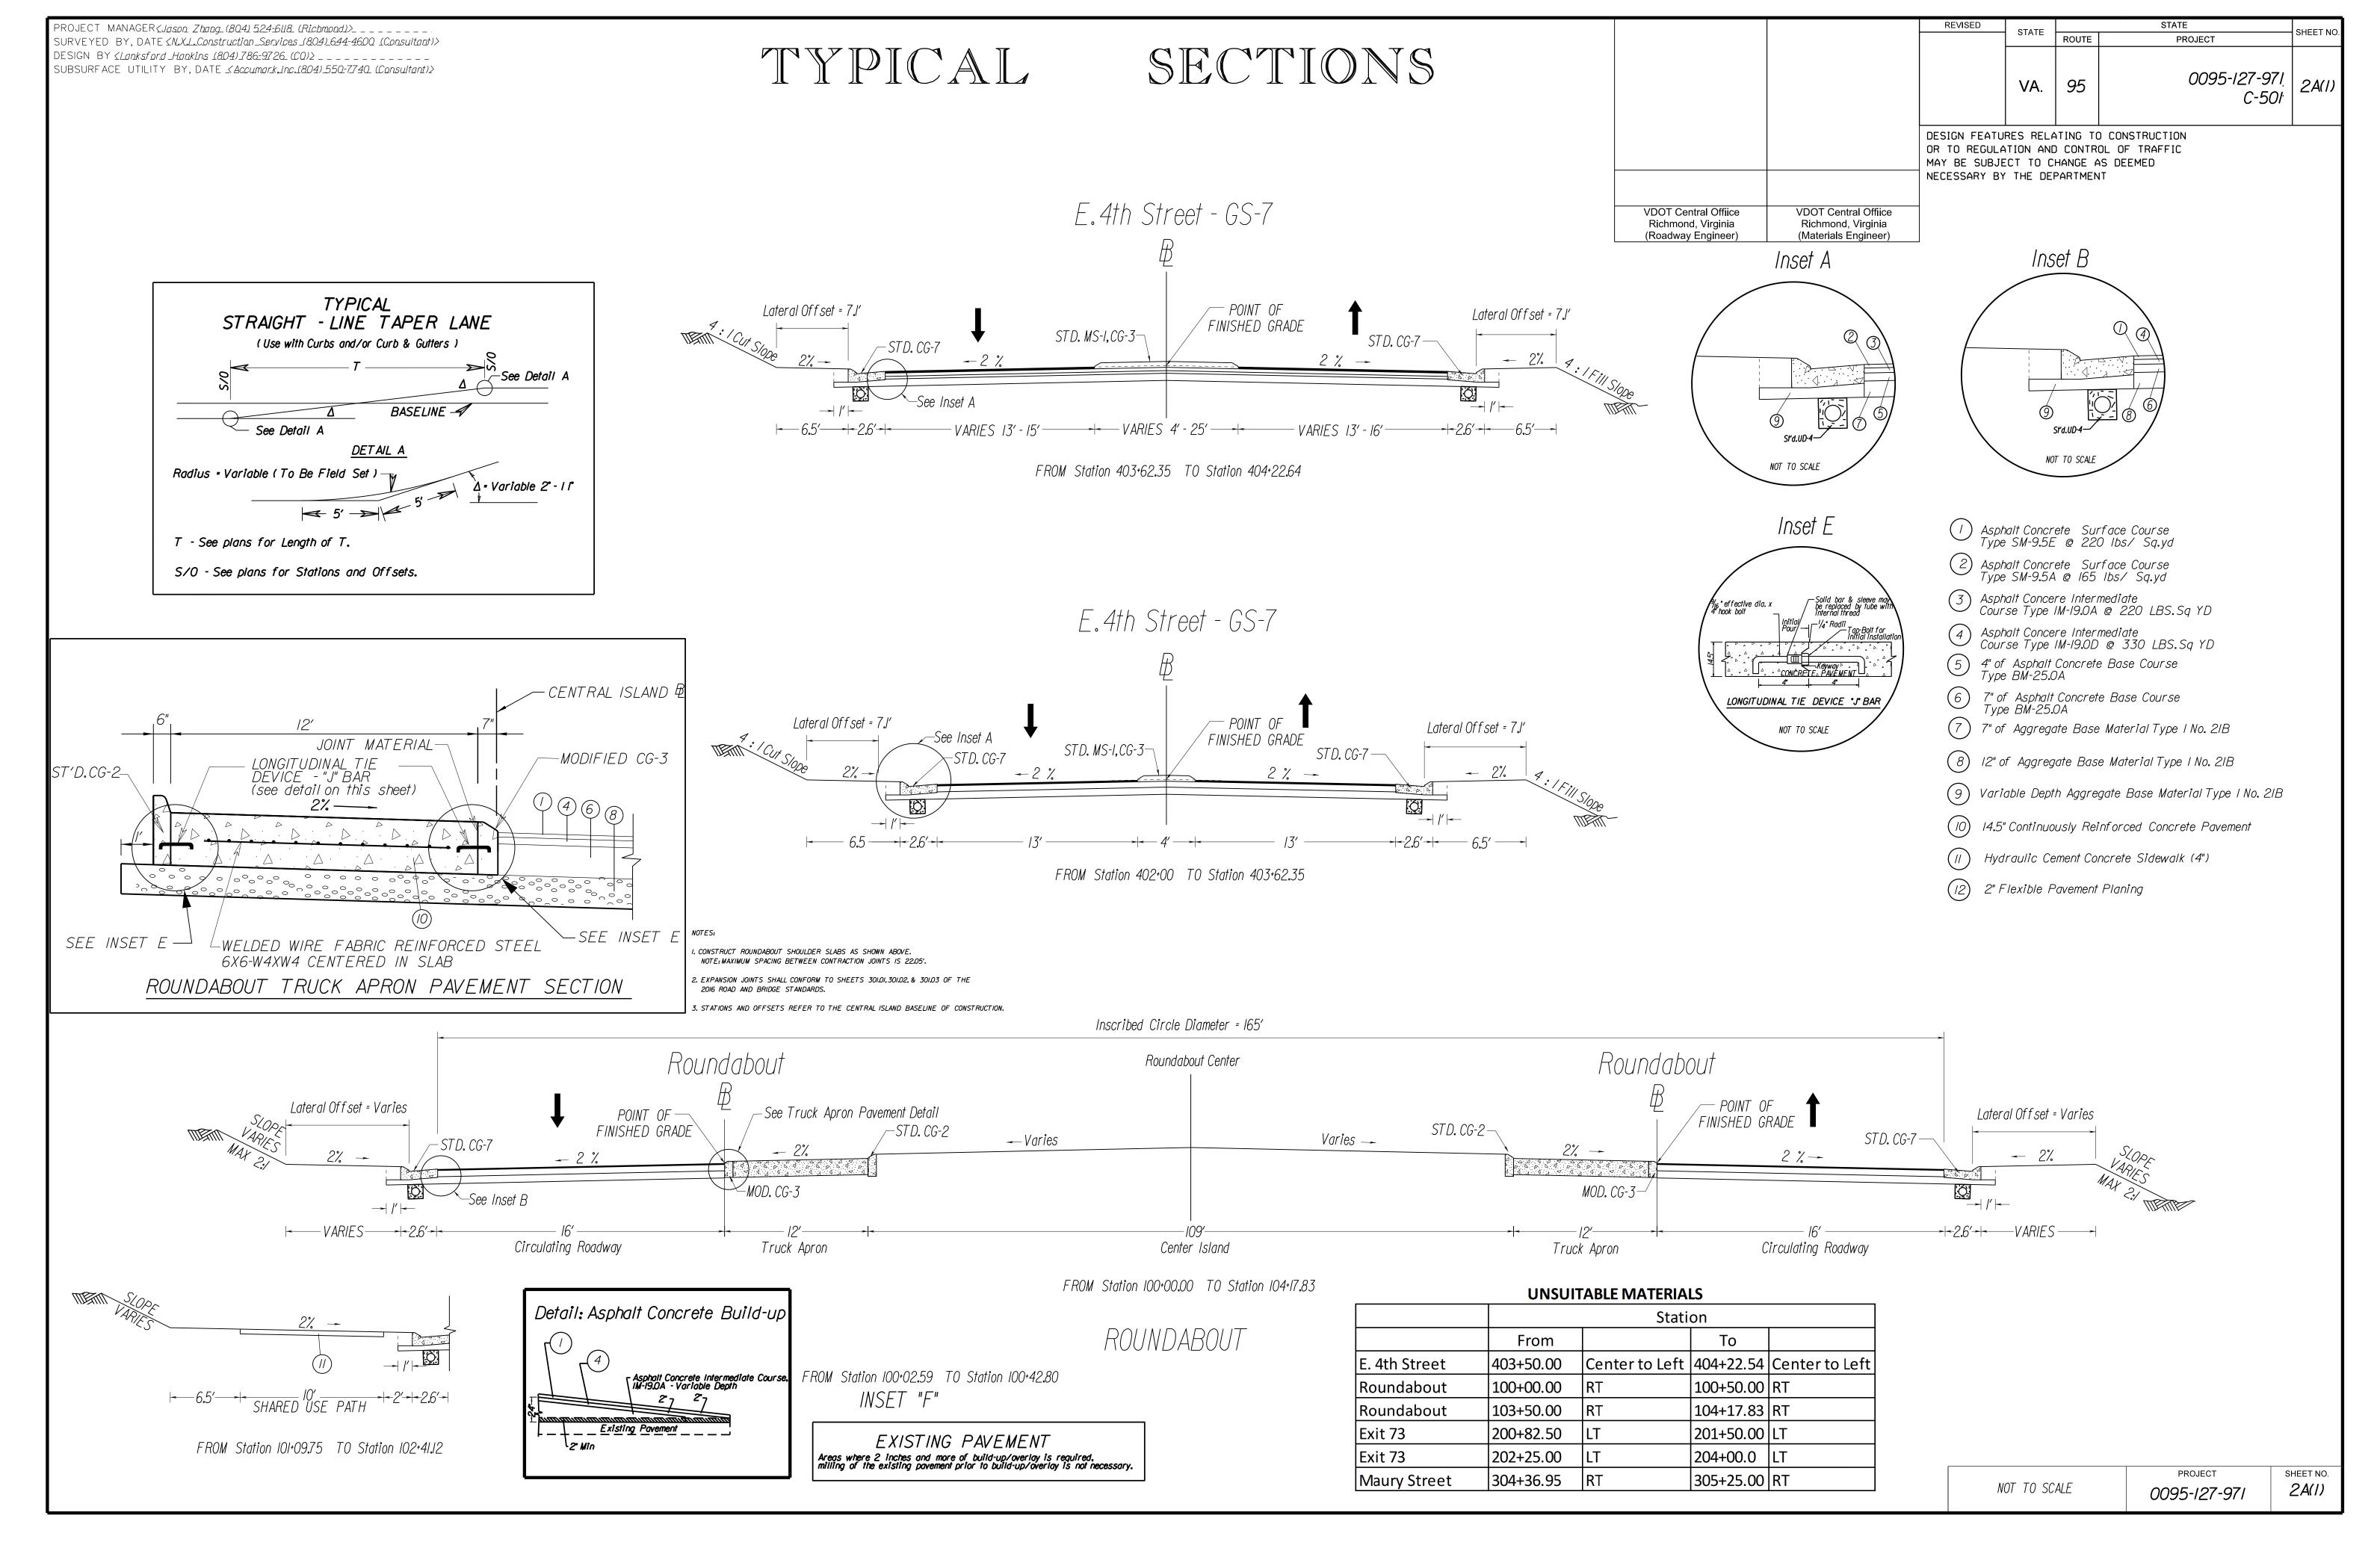

0095-127-971

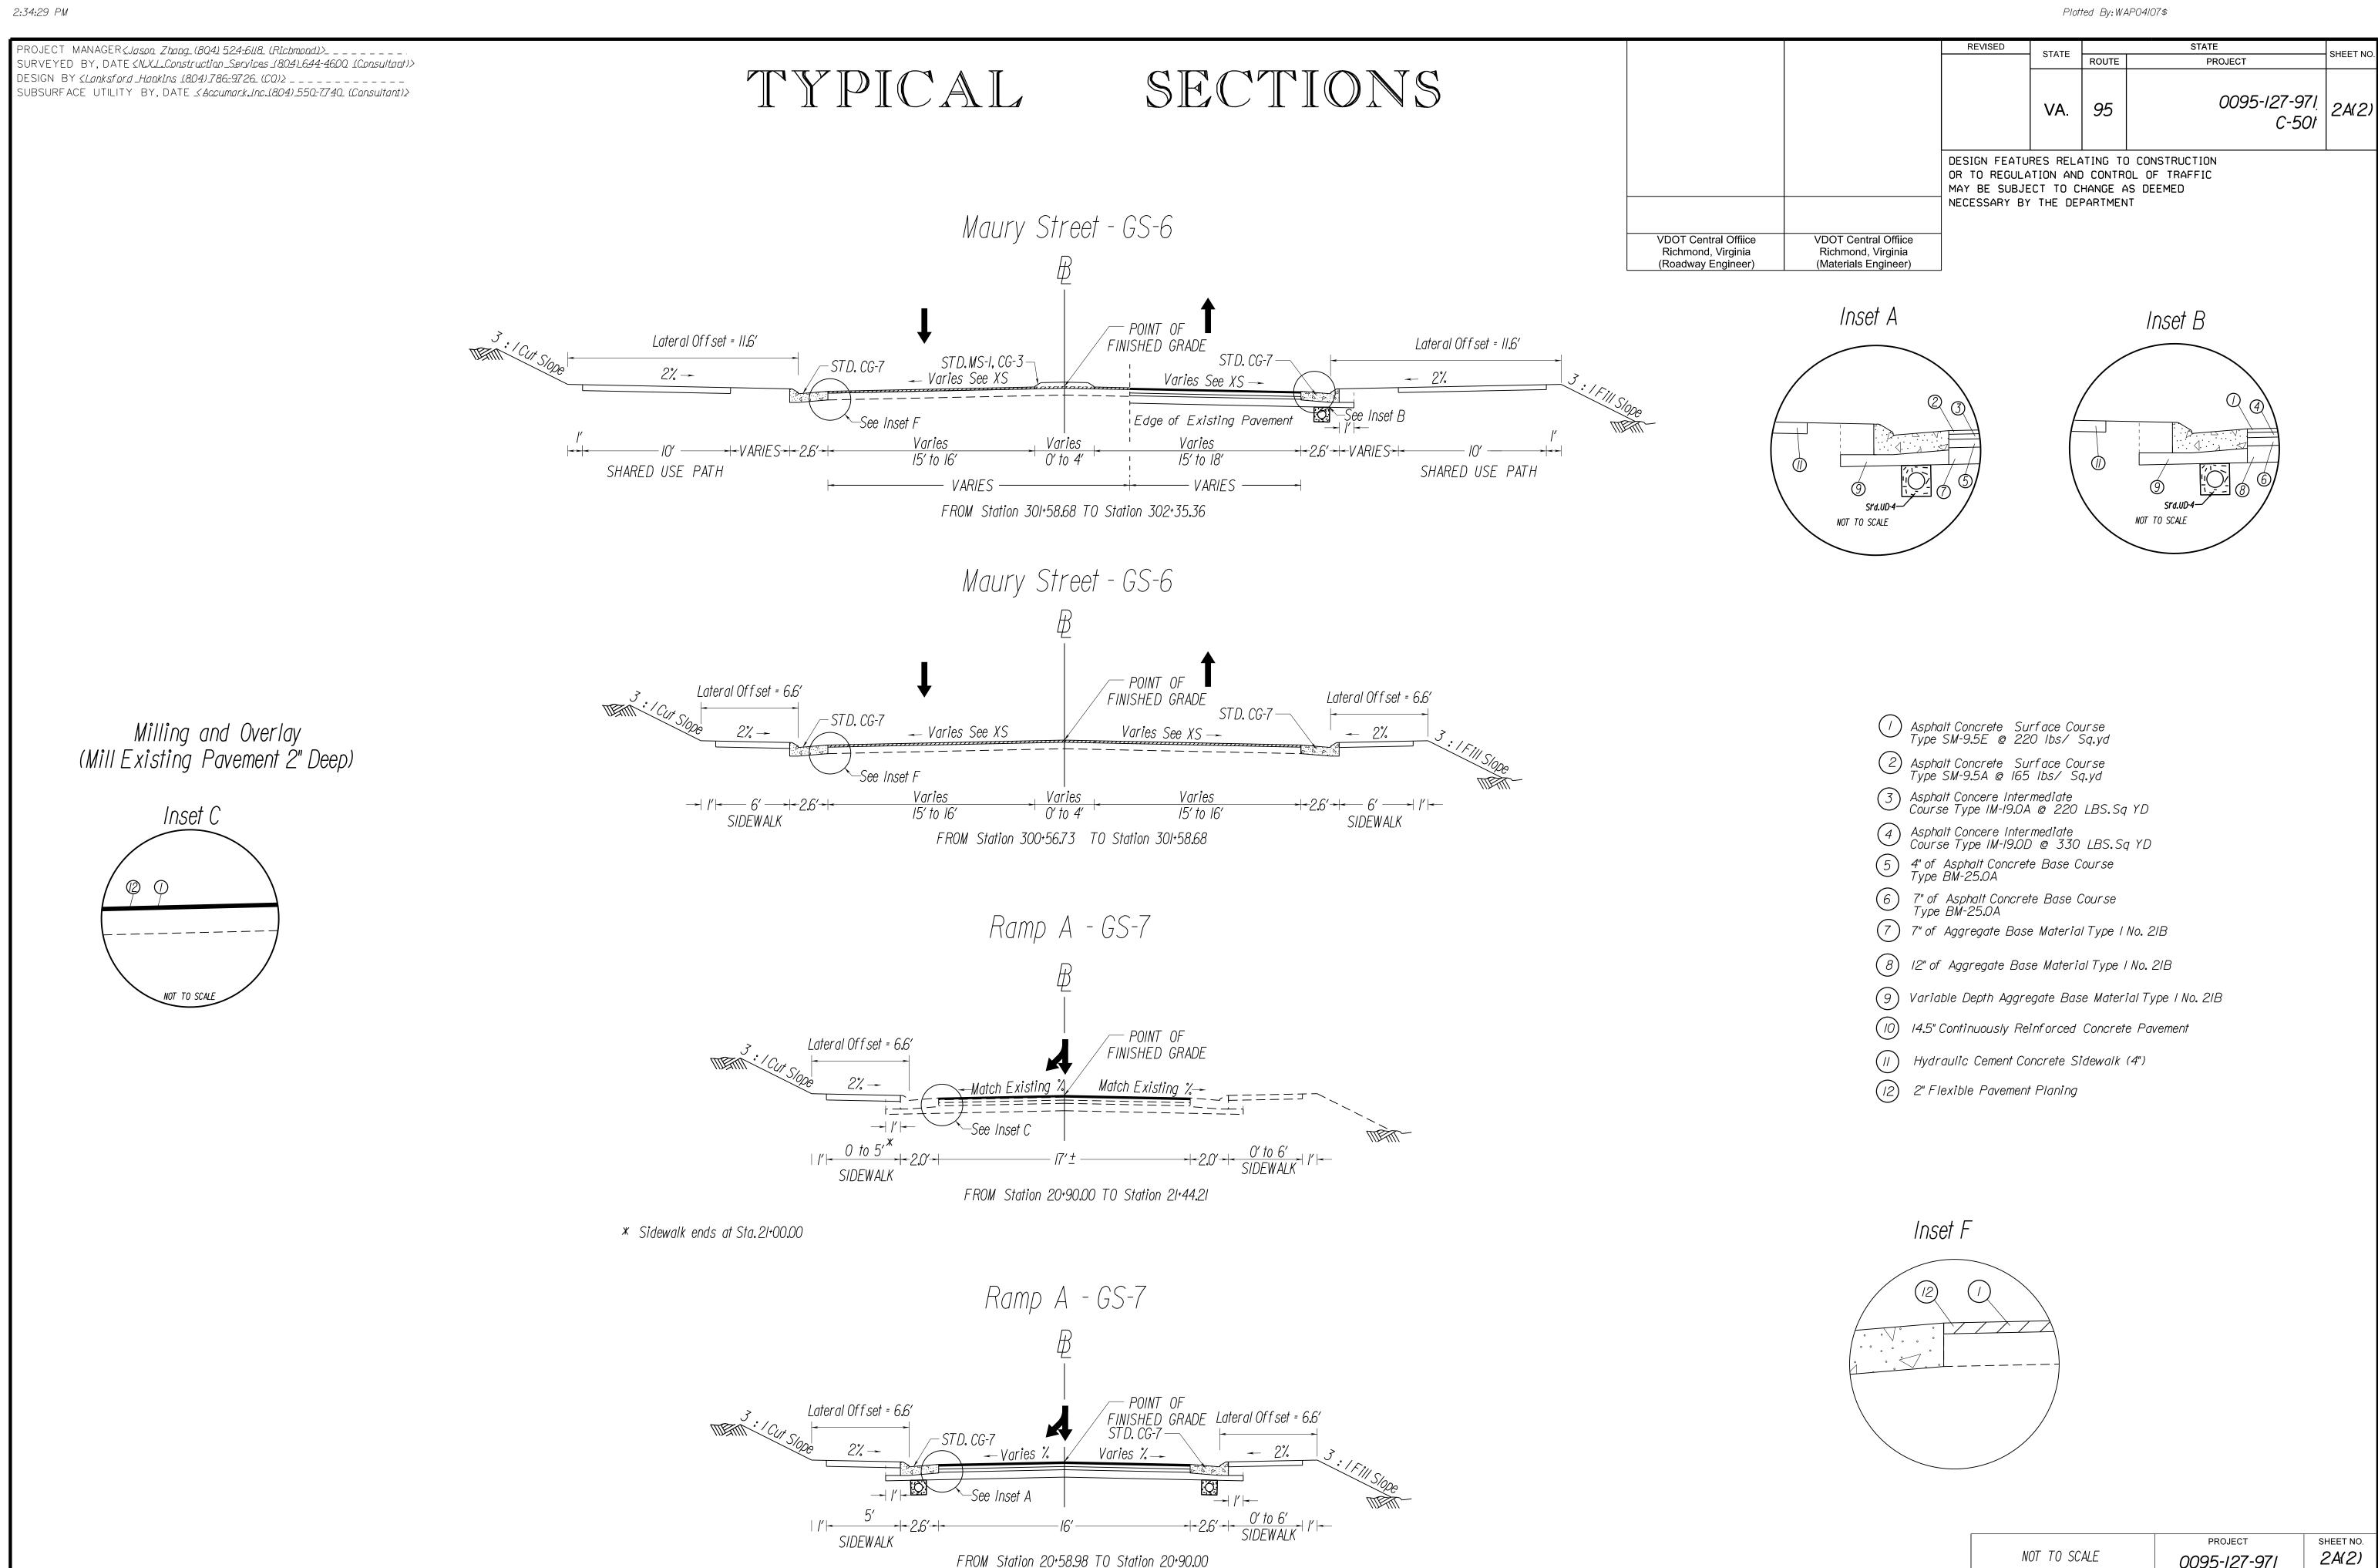


FROM Station 20+58.98 TO Station 20+90.00

SHARED USE PATH


VARIES 4' - 25'

FROM Station 302+35.36 TO Station 302+35.36

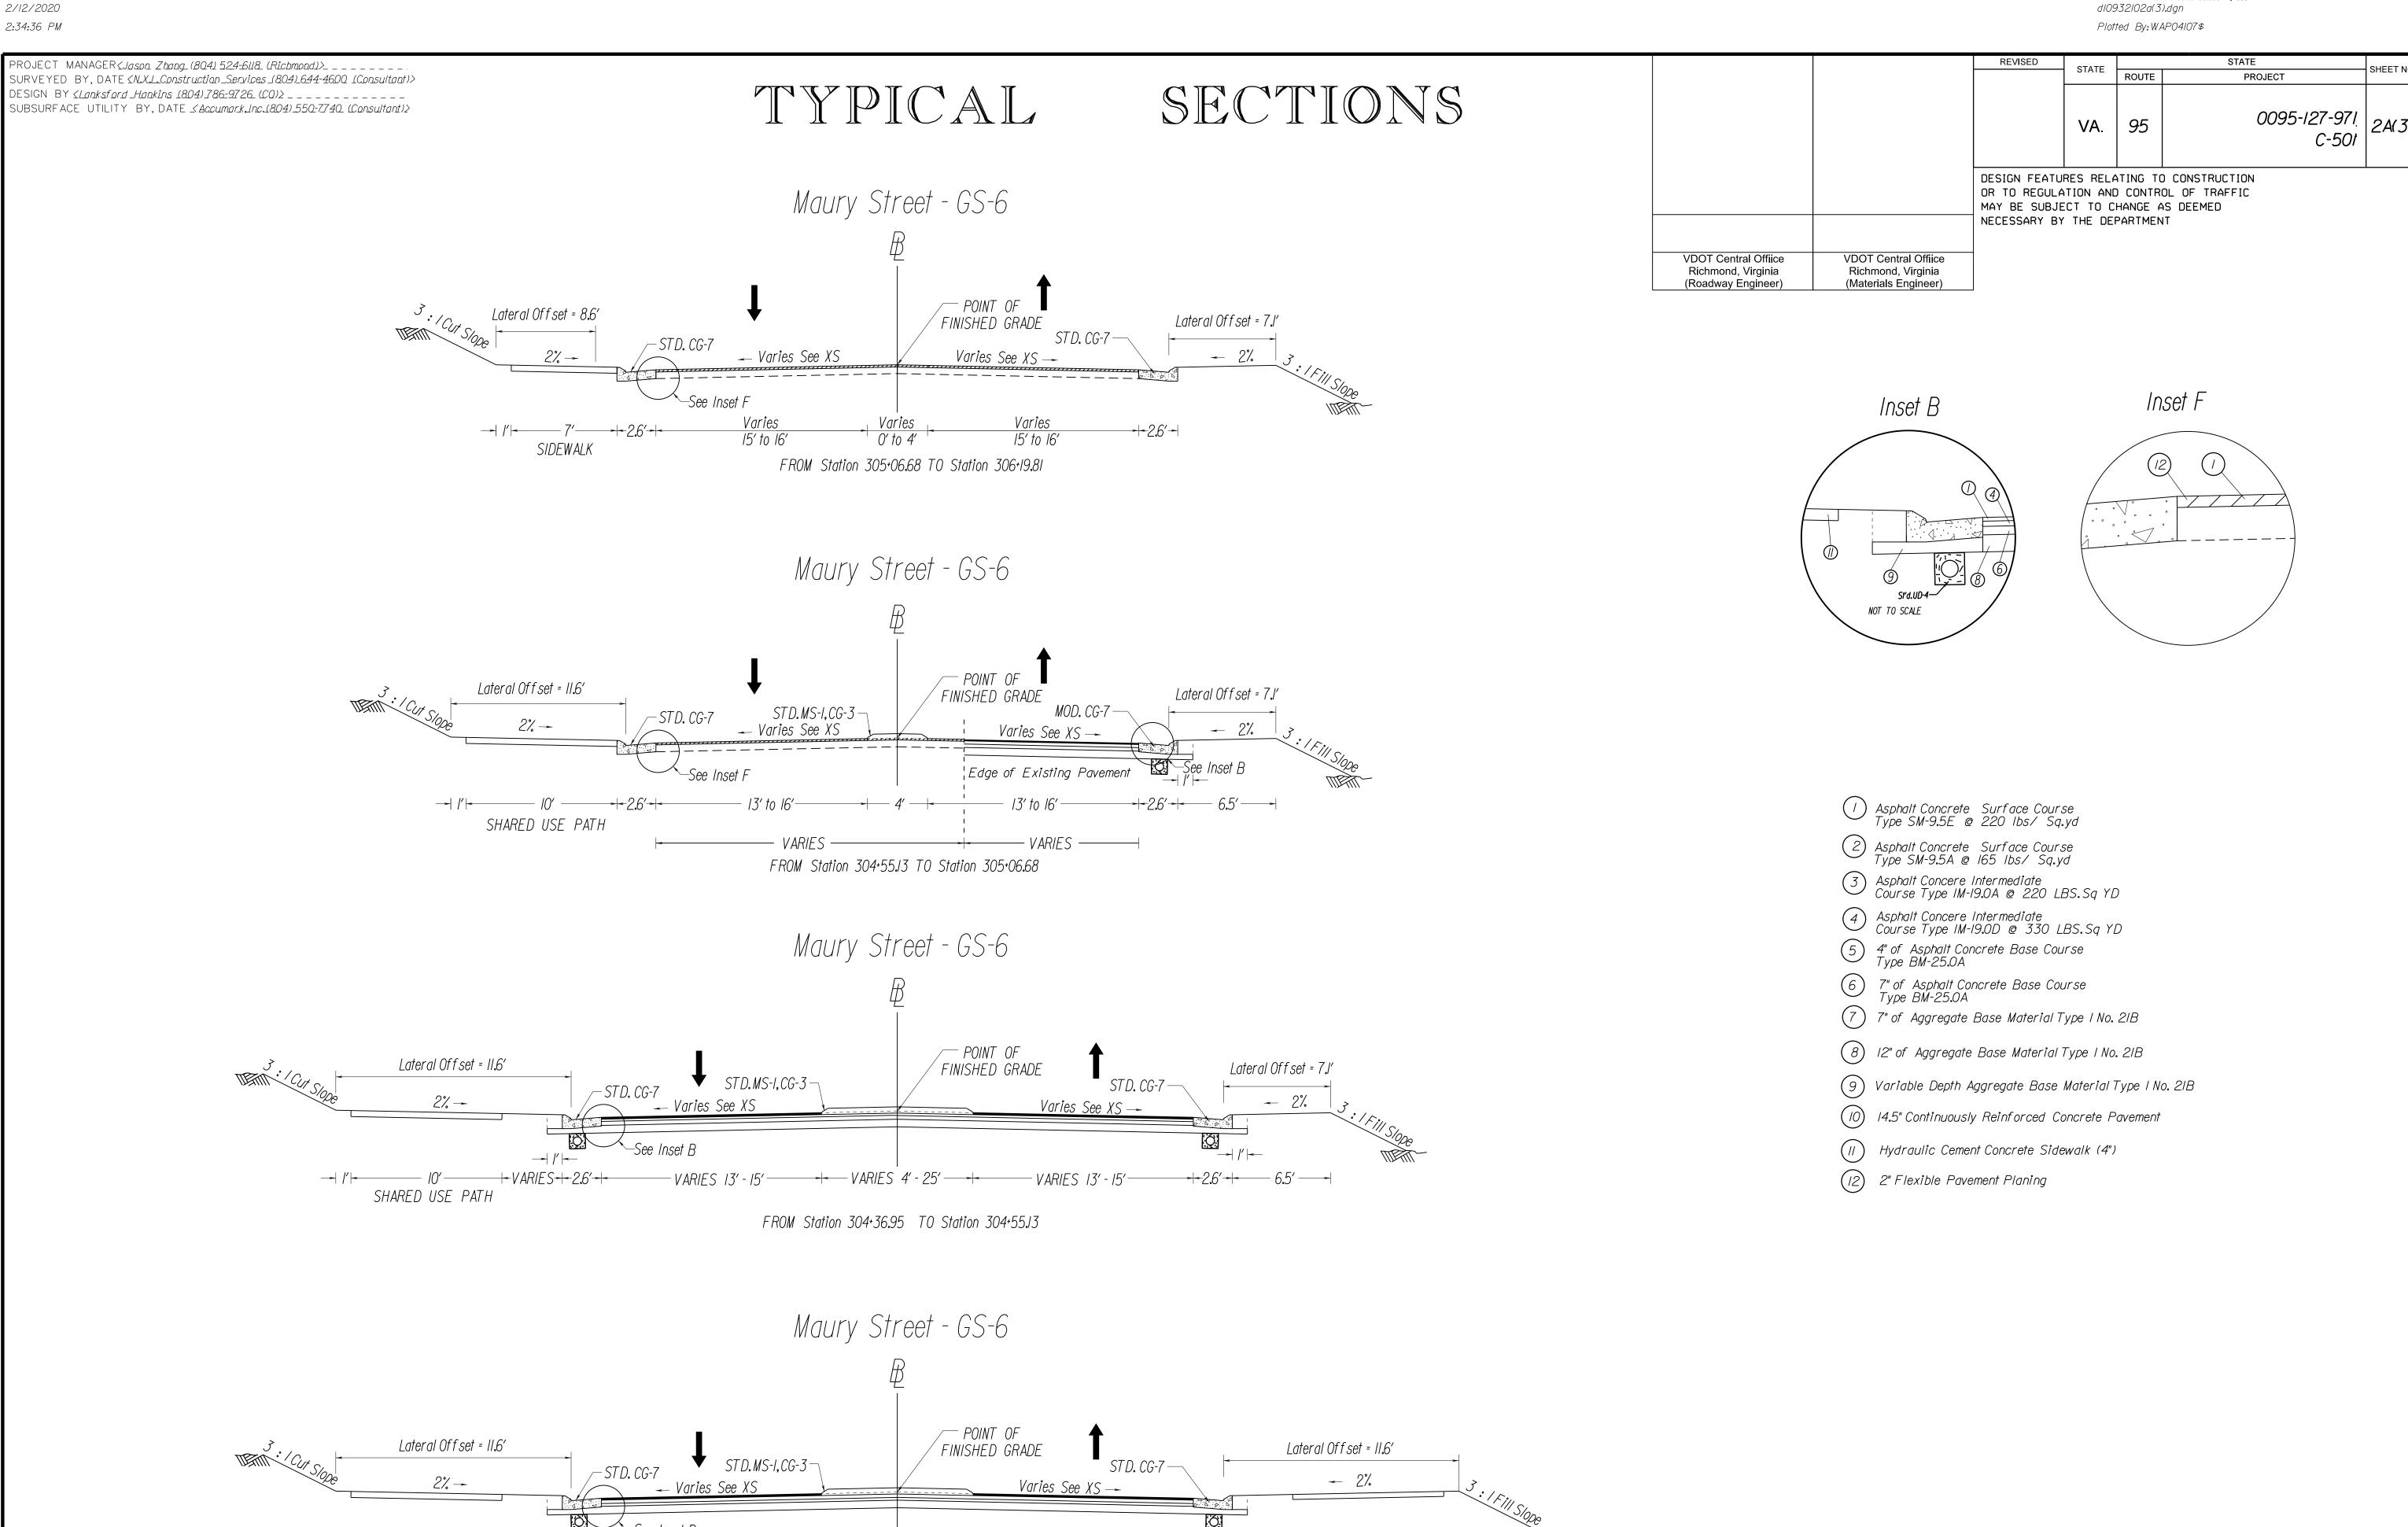

SHARED USE PATH

– VARIES 15' - 18'

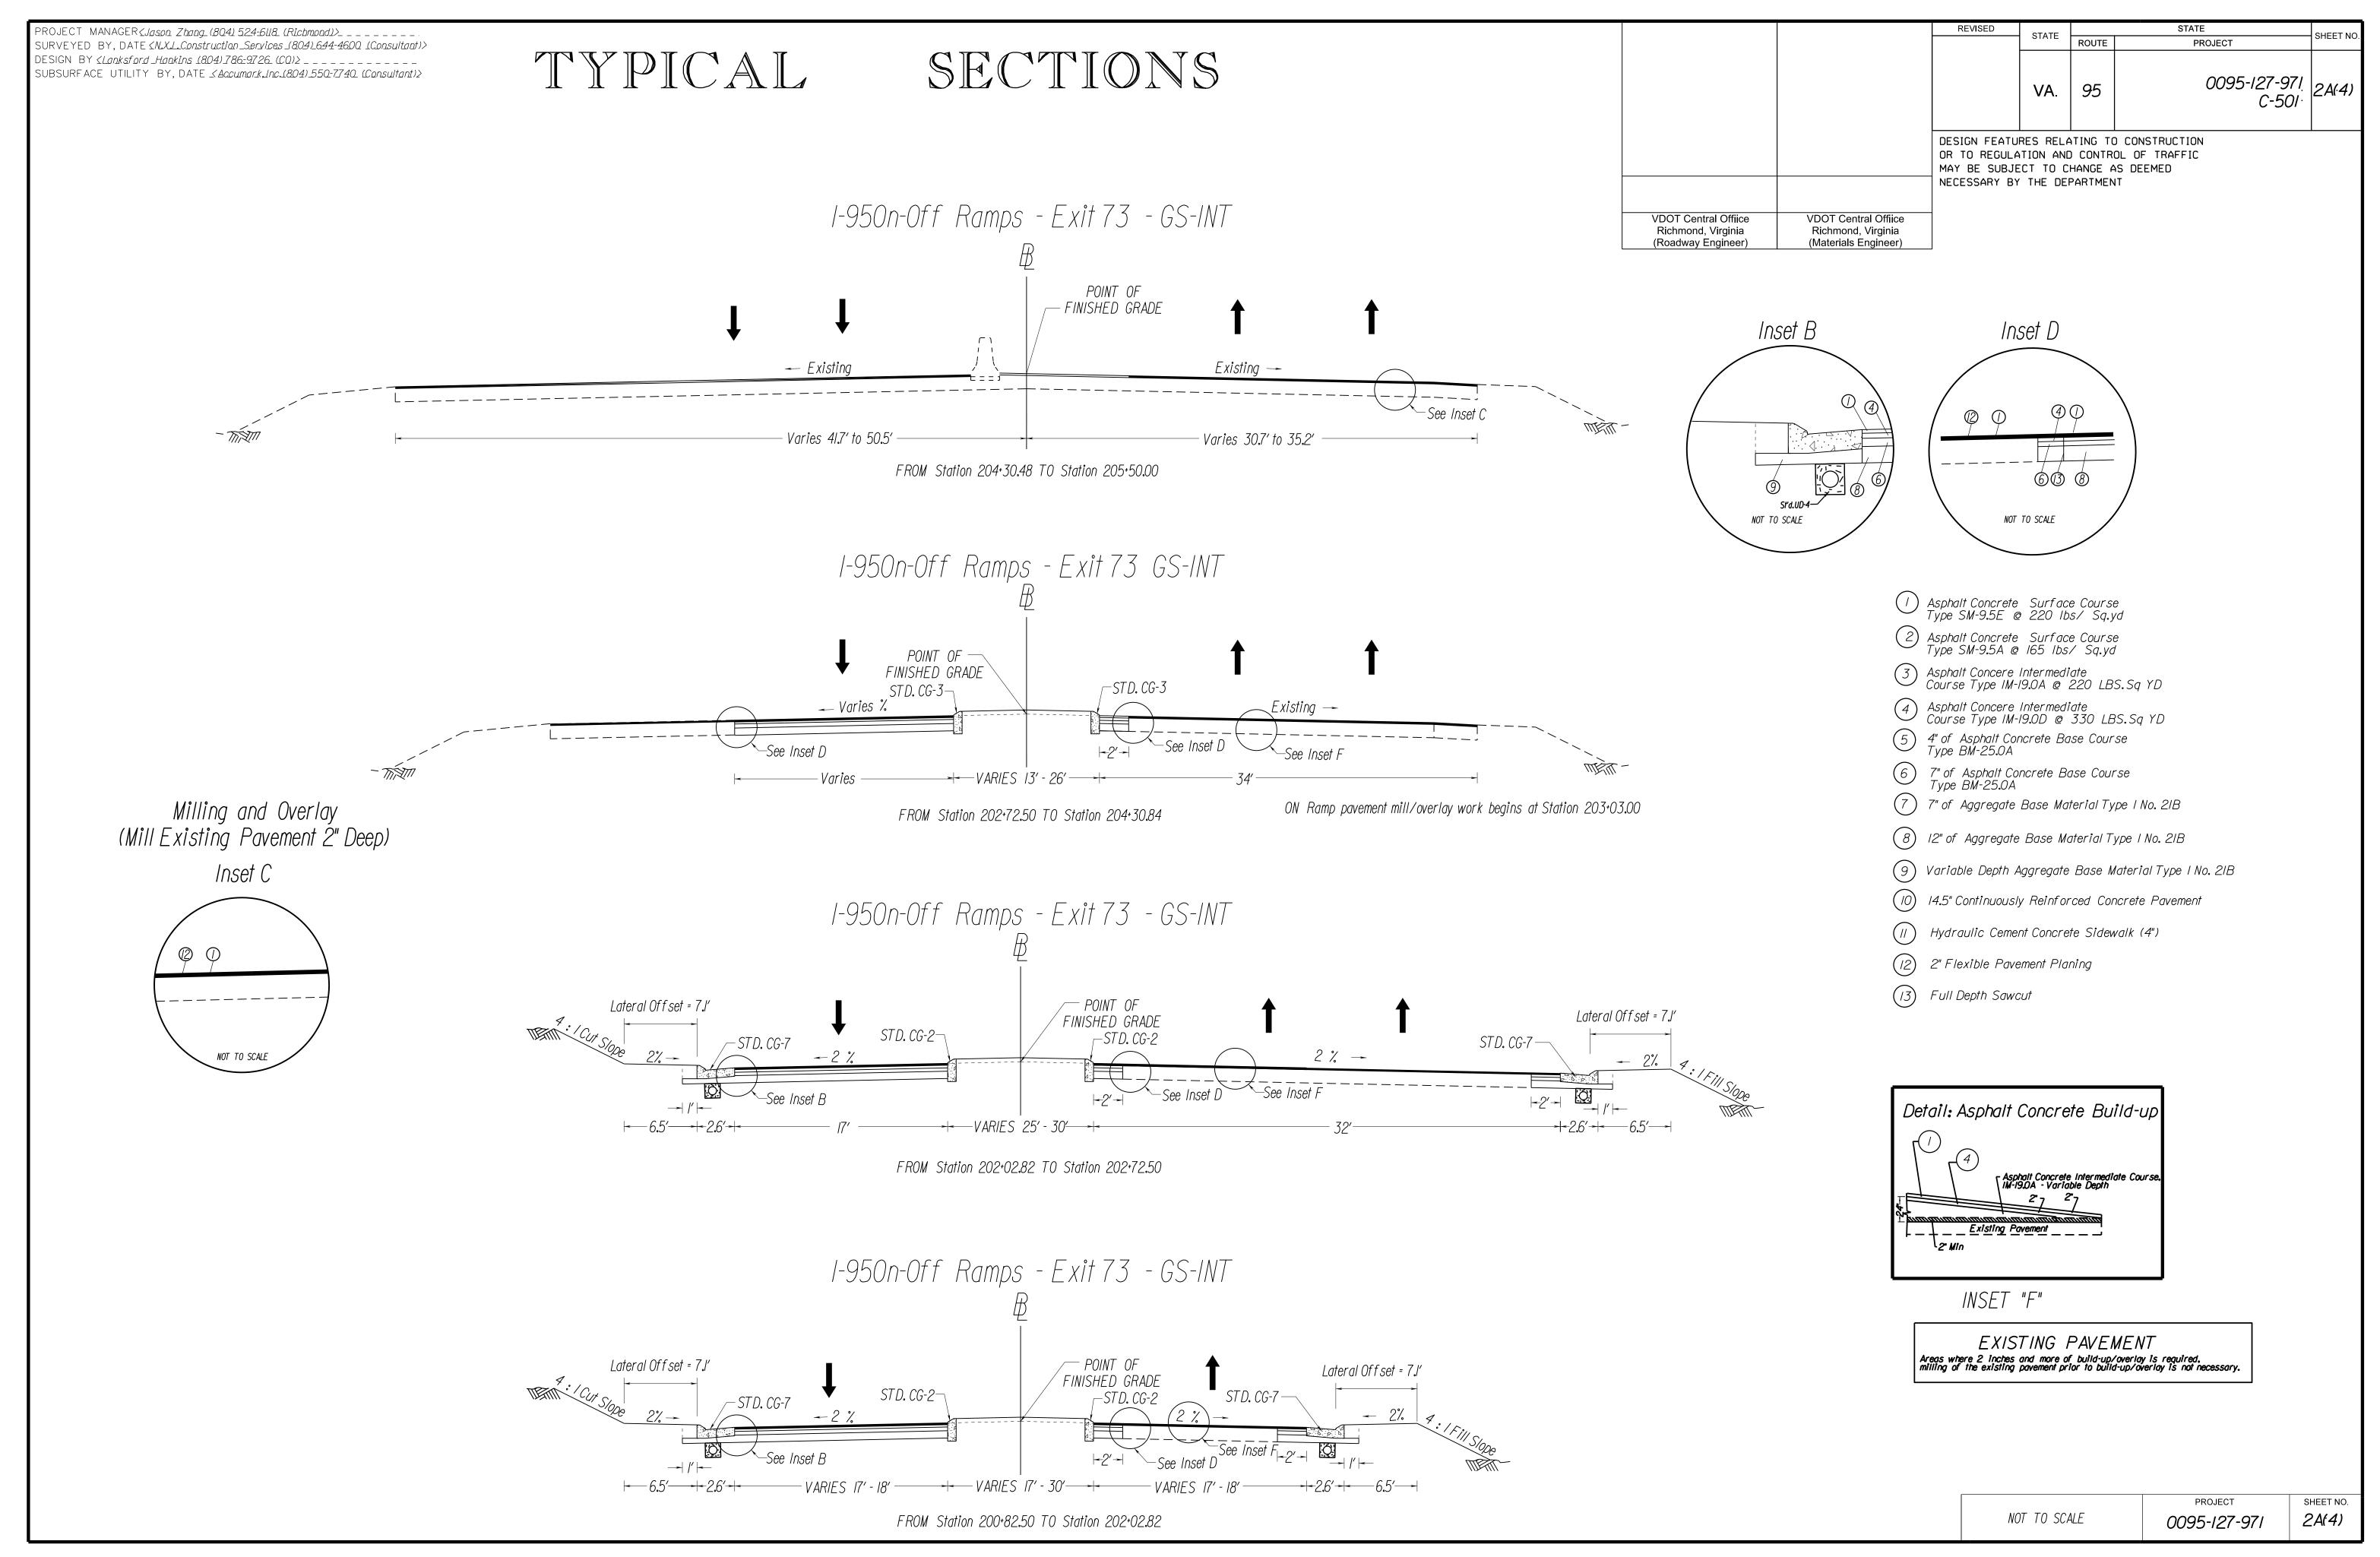

Plotted By: WAP04107\$

STATE

SURVEYED BY, DATE <N.X.L.Construction_Services_(804)_644-4600_(Consultant)> DESIGN BY *<Lanksford_Hankins* (804)786-9726 (CO)> _ _ _ _ _ _ _ _ _ SUBSURFACE UTILITY BY, DATE Accumark,Inc.(804).550-7740 (Consultant)>


TYPICAL

SECTIONS

ROUTE PROJECT 0095-127-971. C-501: 2A(5) VA. 95 DESIGN FEATURES RELATING TO CONSTRUCTION OR TO REGULATION AND CONTROL OF TRAFFIC MAY BE SUBJECT TO CHANGE AS DEEMED NECESSARY BY THE DEPARTMENT VDOT Central Offiice VDOT Central Office

REVISED

Ramp B - GS-R

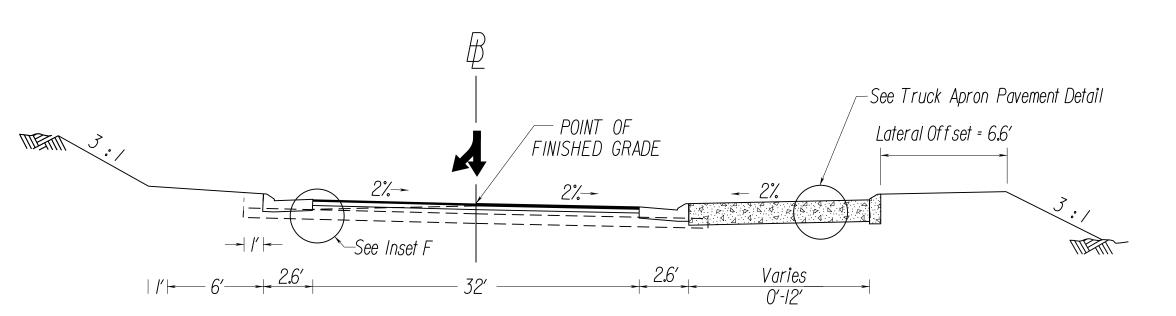


FROM Station 50+34.27 TO Station 51+31.12

Inset B Inset D 6 St'd.UD-4-NOT TO SCALE NOT TO SCALE


Richmond, Virginia (Materials Engineer)

Richmond, Virginia (Roadway Engineer)

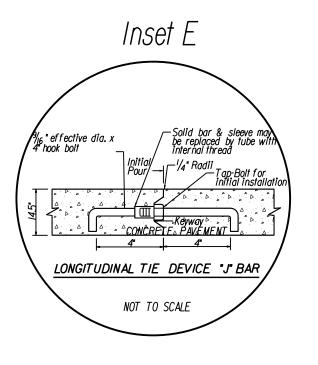

- Asphalt Concrete Surface Course Type SM-9.5E @ 220 lbs/ Sq.yd
- 2) Asphalt Concrete Surface Course Type SM-9.5A @ 165 lbs/ Sq.yd
- 3 Asphalt Concere Intermediate Course Type IM-19.0A @ 220 LBS.Sq YD
- Asphalt Concere Intermediate
 Course Type IM-19.0D @ 330 LBS.Sq YD
- 5) 4" of Asphalt Concrete Base Course Type BM-25.0A
- 6 7" of Asphalt Concrete Base Course Type BM-25.0A
- (7) 7" of Aggregate Base Material Type I No. 2IB
- 8) 12" of Aggregate Base Material Type I No. 21B
- (9) Variable Depth Aggregate Base Material Type I No. 21B
- (10) 14.5" Continuously Reinforced Concrete Pavement
- (II) Hydraulic Cement Concrete Sidewalk (4")
- (12) 2" Flexible Pavement Planing

Milling and Overlay (Mill Existing Pavement 2" Deep)

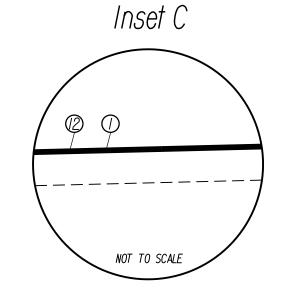

CENTRAL ISLAND JOINT MATERIAL--MODIFIED CG-3 LONGITUDINAL TIE — DEVICE - "J" BAR (see detail on this sheet) ST'D.CG-2— (1) (4) (6) (8) L 2%----∽SEE INSET E SEE INSET E WELDED WIRE FABRIC REINFORCED STEEL 6X6-W4XW4 CENTERED IN SLAB ROUNDABOUT TRUCK APRON PAVEMENT SECTION

I. CONSTRUCT ROUNDABOUT SHOULDER SLABS AS SHOWN ABOVE. NOTE: MAXIMUM SPACING BETWEEN CONTRACTION JOINTS IS 22.05'.

2. EXPANSION JOINTS SHALL CONFORM TO SHEETS 301.01,301.02, & 301.03 OF THE 2016 ROAD AND BRIDGE STANDARDS.


. STATIONS AND OFFSETS REFER TO THE CENTRAL ISLAND BASELINE OF CONSTRUCTION.

Detail: Asphalt Concrete Build-up r Asphalt Concrete Intermediate Course. ∖IM-19.0A - Variable Depth Existing Pavement

INSET "F"

EXISTING PAVEMENT Areas where 2 inches and more of build-up/overlay is required, milling of the existing pavement prior to build-up/overlay is not necessary.

PRIVATE AND COMMERCIAL ENTRANCES

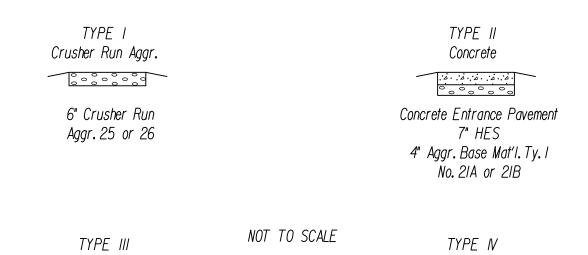

Asphalt Asphalt Conc. Type SM-9.5A or SM-9.5D @ 220 Lbs. per S.Y. 4" Aggr. Base Mat'l. Ty. I No. 21A or 21B

Asphalt Conc. Type

Asphalt Commercial


SM-9.5A or SM-9.5D @ 165 Lbs. per S.Y. 4" Asphalt Conc. Base Course BM-25**.**0 6" Aggr. Base Mat'l. Ty. I No. 21A or 21B

The type of entrance (I, II, III, IV) to be constructed will be determined by the existing condition at the time of construction.

SHEET NO. PROJECT NOT TO SCALE 2A(5) 0095-127-971

LIMITED ACCESS HIGHWAY

By Resolution of Commonwealth Transportation
Board dated October 4, 1956

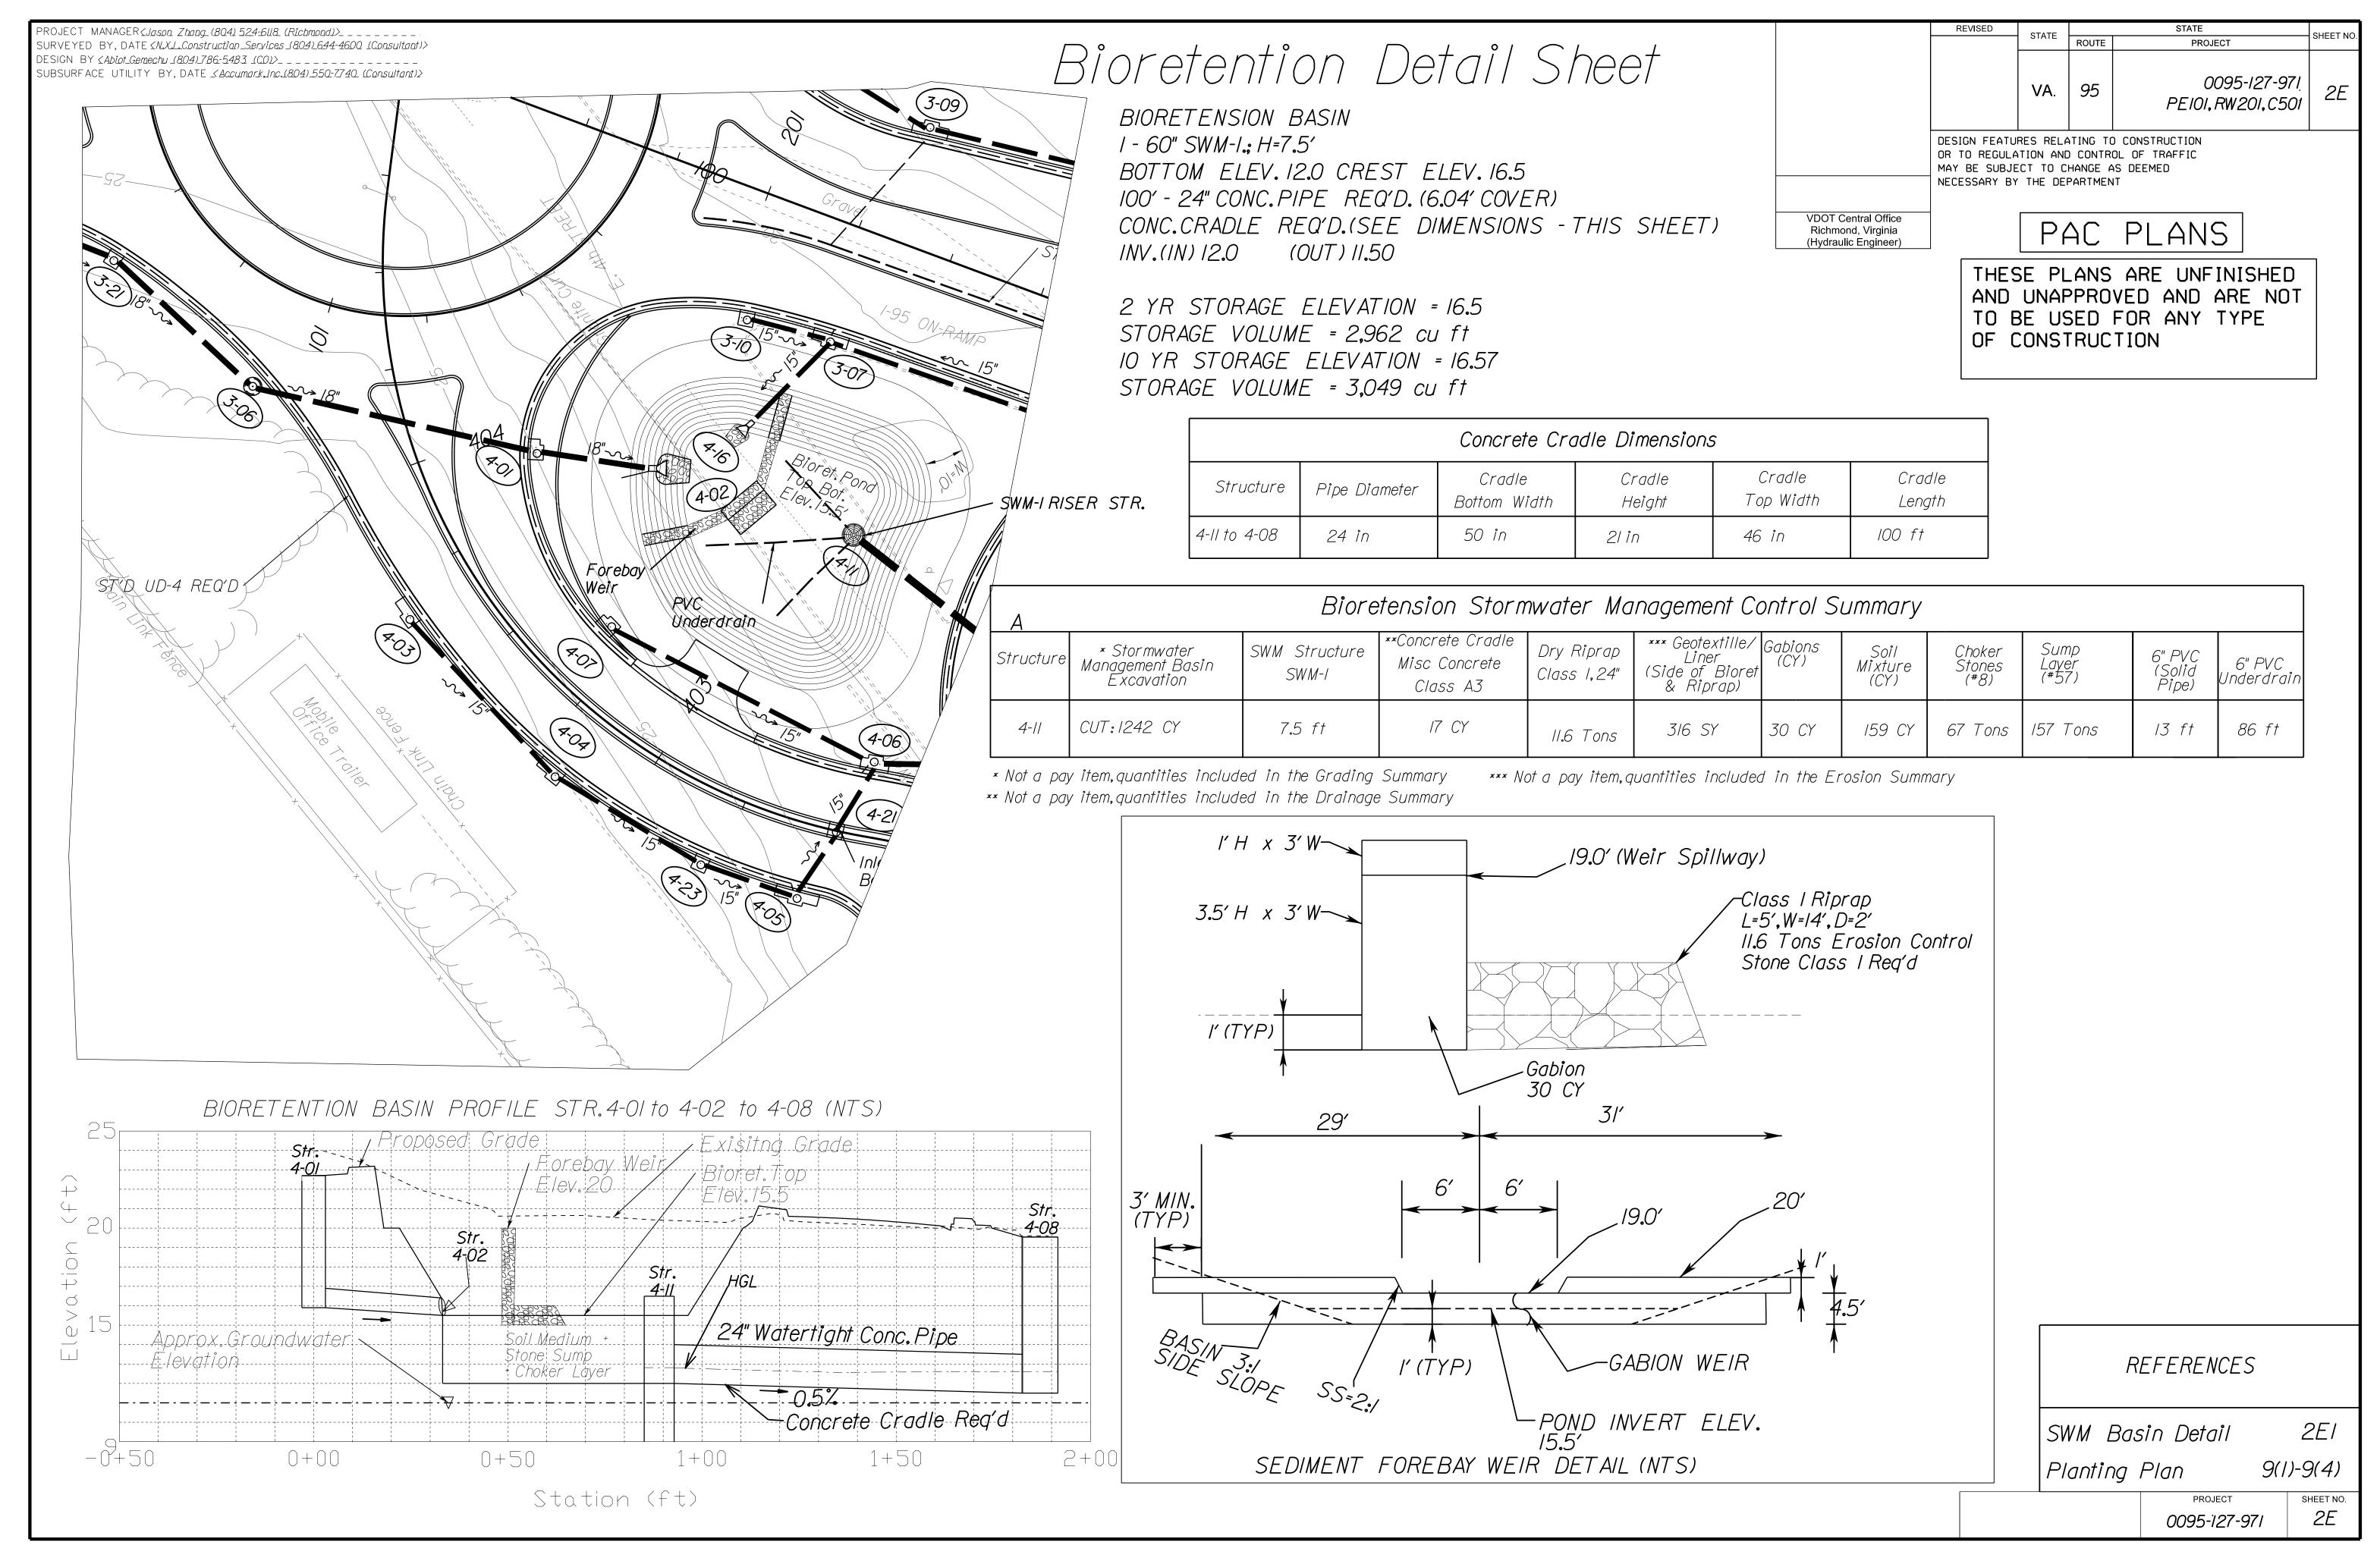



PROJECT MANAGER SURVEYED BY, DATE N.X.L.Construction_Services-1804).644-4600 (Consultant)> DESIGN BY < Lanksford Hankins (804) 786-9726 (CO)> SUBSURFACE UTILITY BY, DATE & Accumark, Inc. (804) 550-7740 (Consultant)

Bioretention Detail Sheet

PAC PLANS

THESE PLANS ARE UNFINISHED AND UNAPPROVED AND ARE NOT TO BE USED FOR ANY TYPE OF CONSTRUCTION

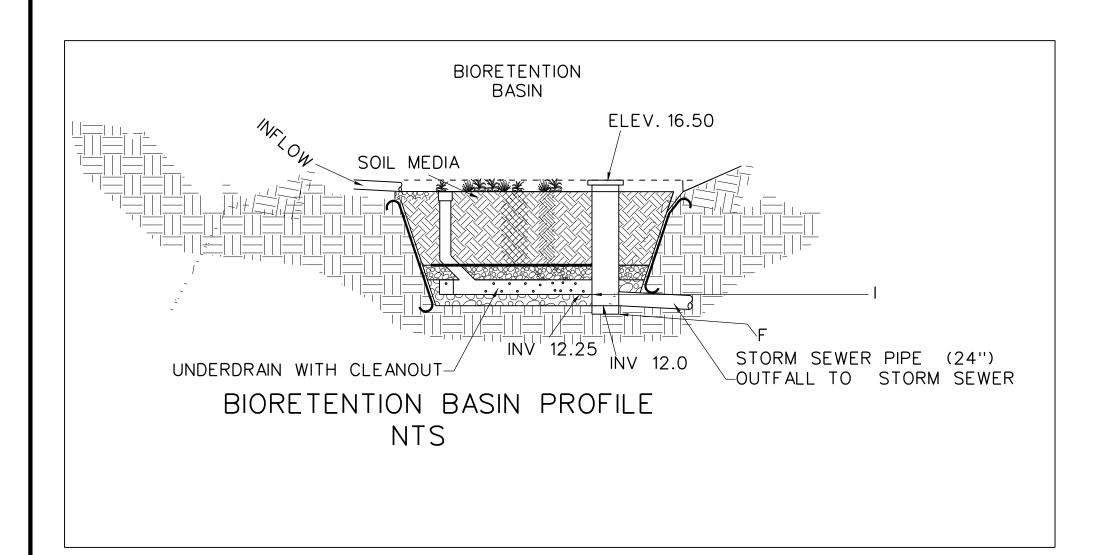

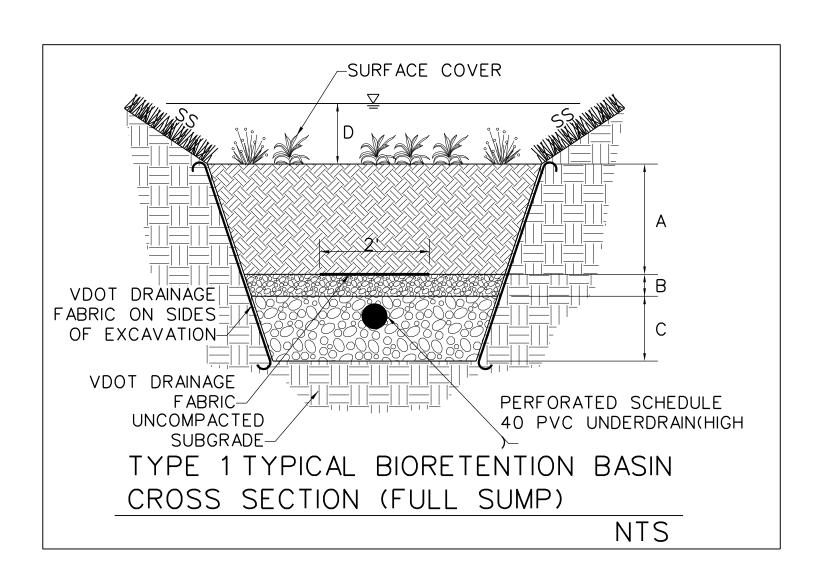

	7	TABLE: BIOFII	LTER S	SUBGRAD	E DIMENSIONING TABLE (BSDT)					
		ELEMENT	UNIT DIMENSION		NOTES					
	Α	BIORETENTION SOIL MEDIA DEPTH	IN	27	INCLUDES MULCH (IF SPECIFIED)					
	В	CHOKER LAYER	IN	3	MINIMUM 3" DEPTH					
	С	SUMP LAYER	IN	12						
	D	DEPTH OF PONDING	IN	12						
	SS	SIDE SLOPES	FT/FT	3 : /	3:1 MAXIMUM					
		SURFACE AREA OF FILTER BED	SF	1905						
	BIORETENTION ELEVATIONS									
		ELEMENT	ELEVA	TION (FT)	NOTES					
	E	TOP OF BERM ELEVATION	20	0.0						
	F	BOTTOM OF TRENCH SUMP	9.0	O (Min)						
	G	PRETREATMENT FOREBAY/ CELL ELEVATION	15.:	5						
	Н	BIORETENTION BED SURFACE ELEVATION	<i>15.50</i>							
	I UNDERDRAIN 12.25									
			E	BIORETENTION	MEDIA/MATERIAL					
X HIGH IN SUMP LOW IN SUMP		UNDERDRAIN	DIA	6 IN	PERFORATED SCHEDULE 40 PVC					
MULCH X NO MULCH	S	SURFACE COVER	IN	2						
		SUMP LAYER	STONE SIZE	NO 57 or 8						
	(CHOKER LAYER	STONE SIZE	NO 8						
	ſ	PVC CLEANOUT	DIA	6 IN	SEE CONSTRUCTION DRAWINGS FOR LOCATION AND QUANTITY					
		UNCOMPACTED SUBGRADE SOIL			AVOID COMPACTION OF SUBGRADE; RIPPING/ TILLING MAY BE REQUIRED IF COMPACTED; LINER MAY BE REQUIRED OVER STRUCTURAL FILL					
				BIORETENTION	OUTFLOW TYPE					
X	SWI	M RISER OUTFALL			SEE VDOT ROAD/BRIDGE STANDARDS					

LIMITED ACCESS HIGHWAY

By Resolution of Commonwealth Transportation
Board dated hl0932l02el.dgn

Plotted By: WAP04107\$

REVISED	STATE	SIAIE			
	SIKIL	ROUTE	PROJECT	SHEET N	
	VA.	<i>9</i> 5	0095-127-971 PE101,RW201,C501	2E1	
DESIGN FEATUR	RES RELA	ATING TO) CONSTRUCTION		

OR TO REGULATION AND CONTROL OF TRAFFIC MAY BE SUBJECT TO CHANGE AS DEEMED NECESSARY BY THE DEPARTMENT

VDOT Central Office Richmond, Virginia (Hydraulic Engineer)

GENERAL NOTES

- 1.) ALL MATERIALS AND PROCEDURES TO BE IN ACCORDANCE WITH VDOT ROAD AND BRIDGE SPECIFICATIONS AND SPECIAL PROVISIONS.
- 2.) SEE CONSTRUCTION DRAWINGS FOR SPACING AND LAYOUT OF UNDERDRAINS AND CLEANOUTS.
- 3.) SEE SWM-12 FOR DETAILS ON CONVERTING SEDIMENT BASIN/TRAP TO PERMANENT BIORETENTION.

PLANT SCHEDULE


- 1.)PERRENNIALS/HERBACEAUS.
- 2.)PLANT ACCORDING TO SPECFICATION PROVIDED ON "TABLE 9.4 OF VA DEQ STORMWATER DESIGN SPECIFICATION NO. 9".
- 3.) FOR BIORETENTION MATERAIL SPECIFICATION REFER TO " "TABLE 9.6 OF VA DEQ STORMWATER DESIGN SPECIFICATION NO. 9".
- 4.) FOR SUGGESTED MAINTENANCE FREQUENCY AND TASKS REFER TO "TABLE 9.7 OF VA DEQ STORMWATER DESIGN SPECIFICATION NO. 9".


REFERENCES


2E SWM Basin Detail Planting Plan 9(1)-9(4)

> SHEET NO. SCALE 2E1 0095-127-971


dI0932I03_Ia.dgn Plotted By:WAP04I07\$

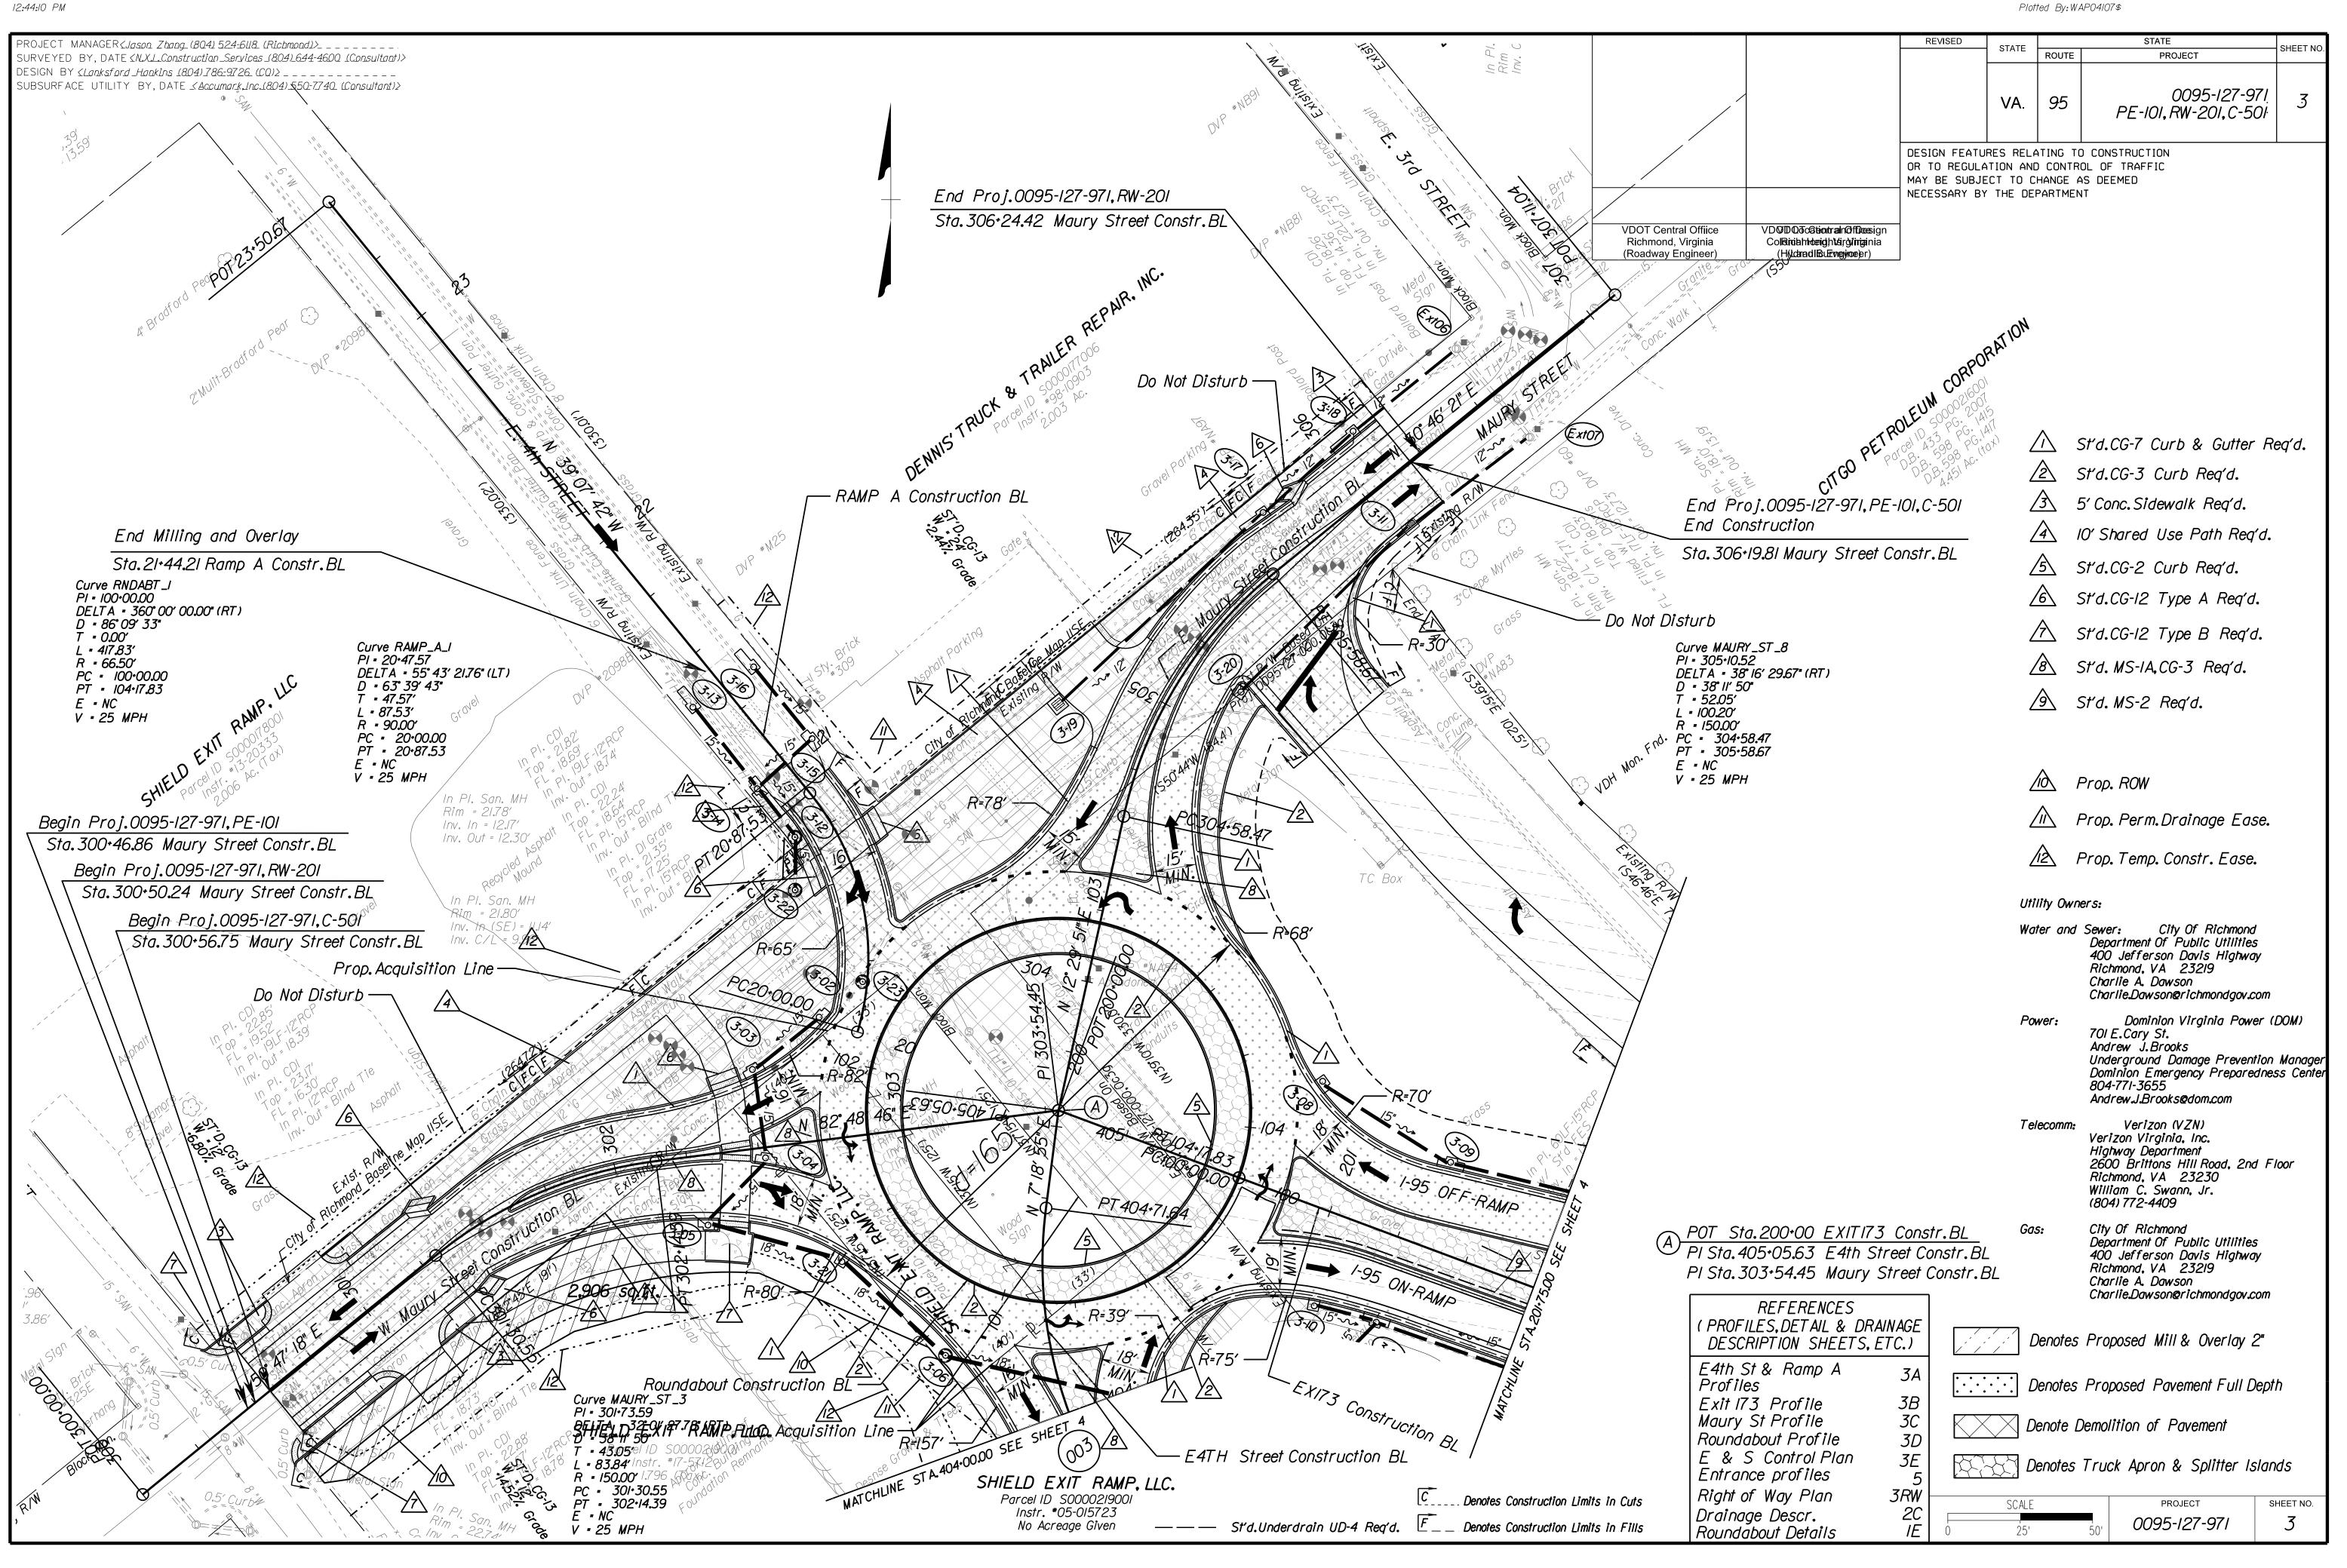


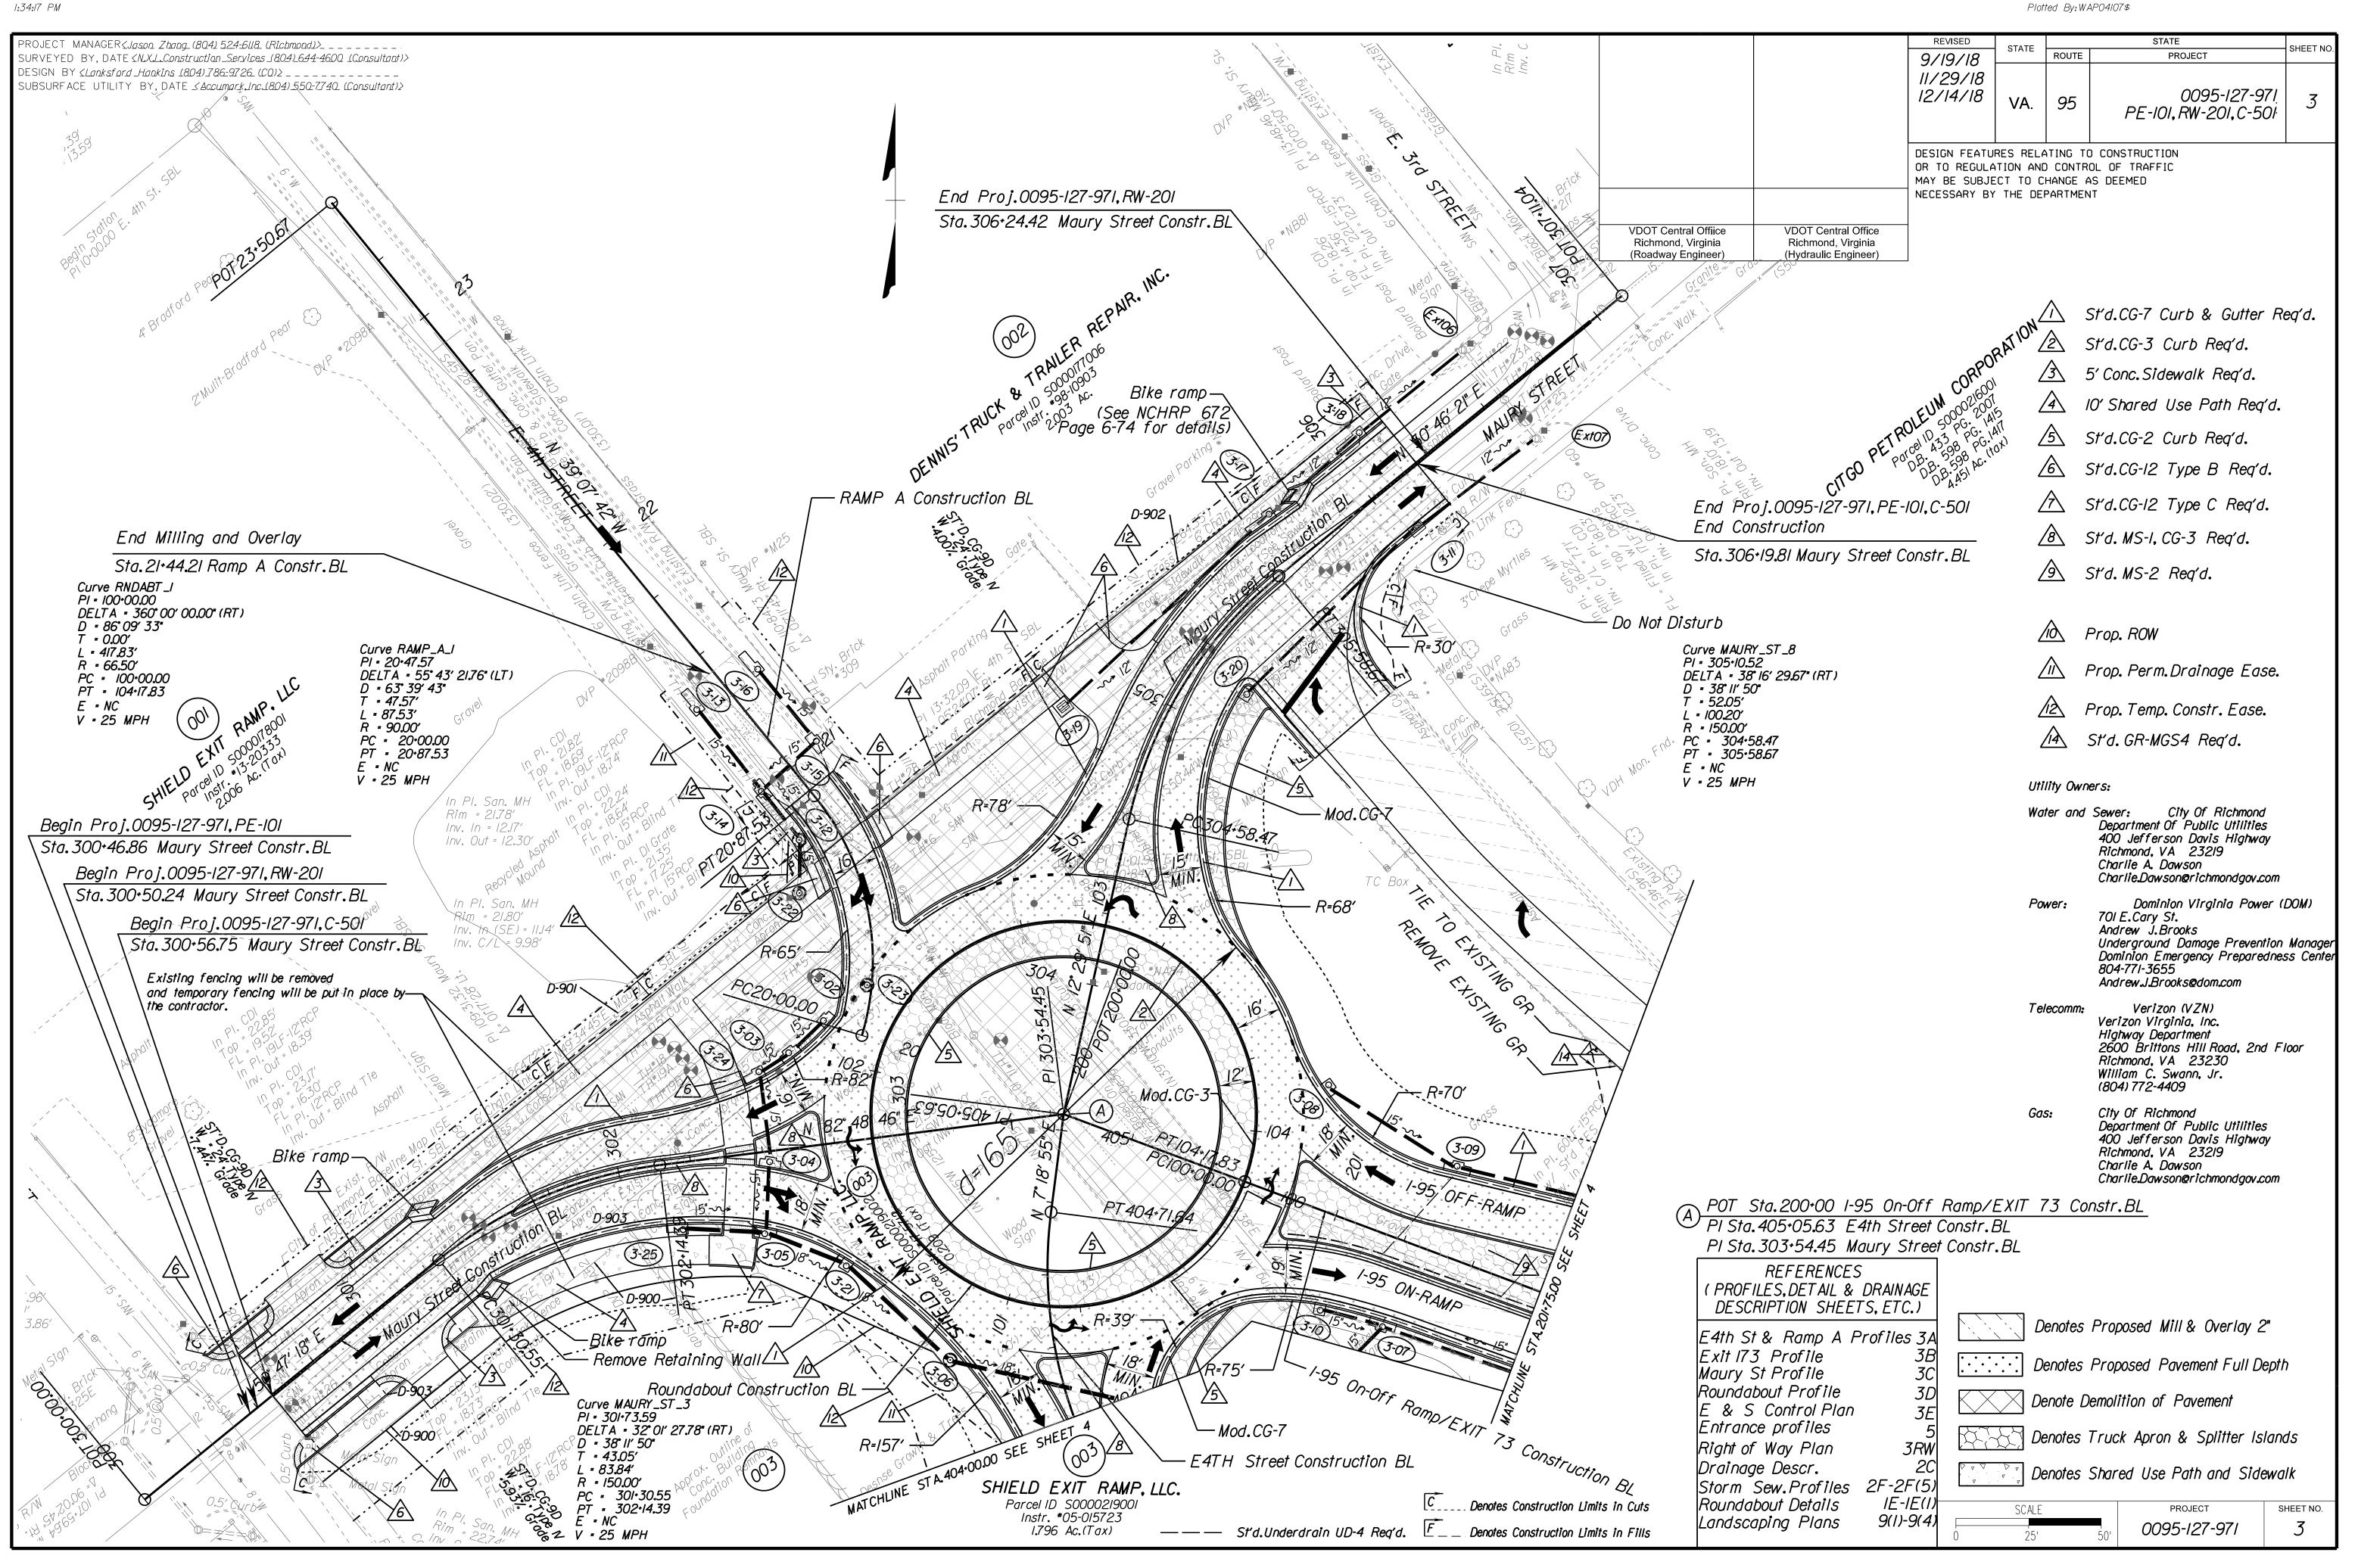


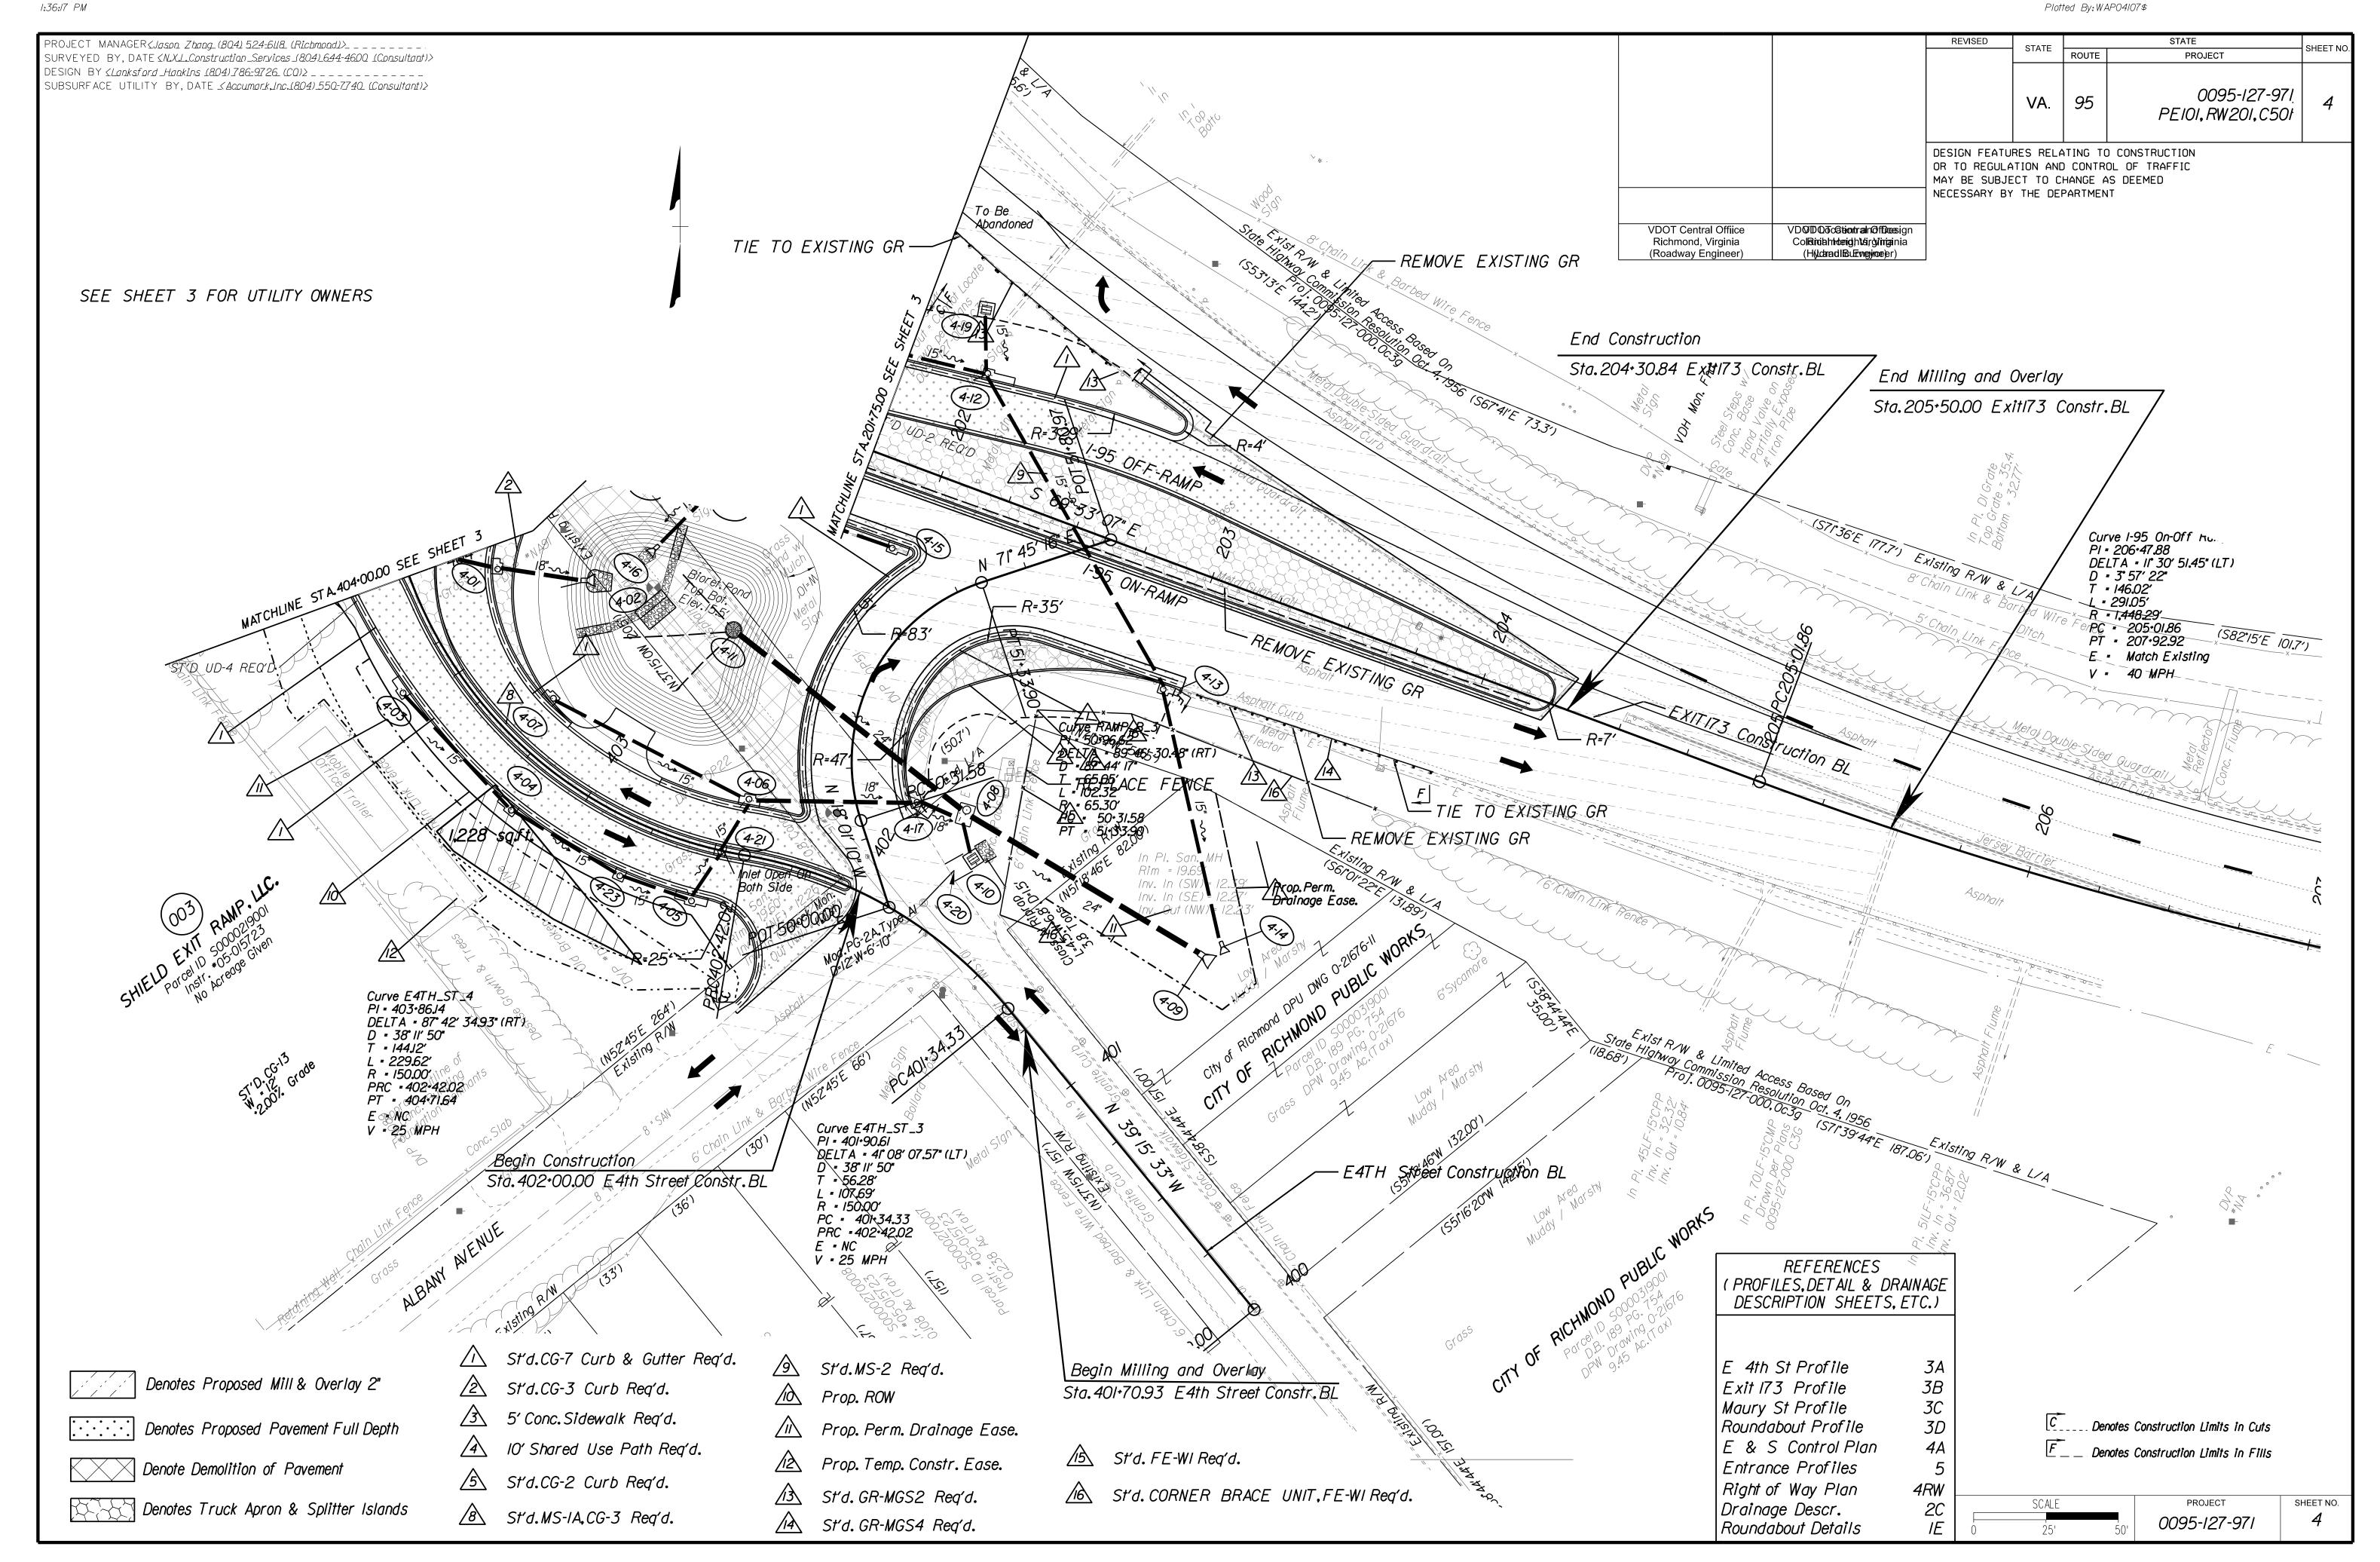

1:35:49 PM

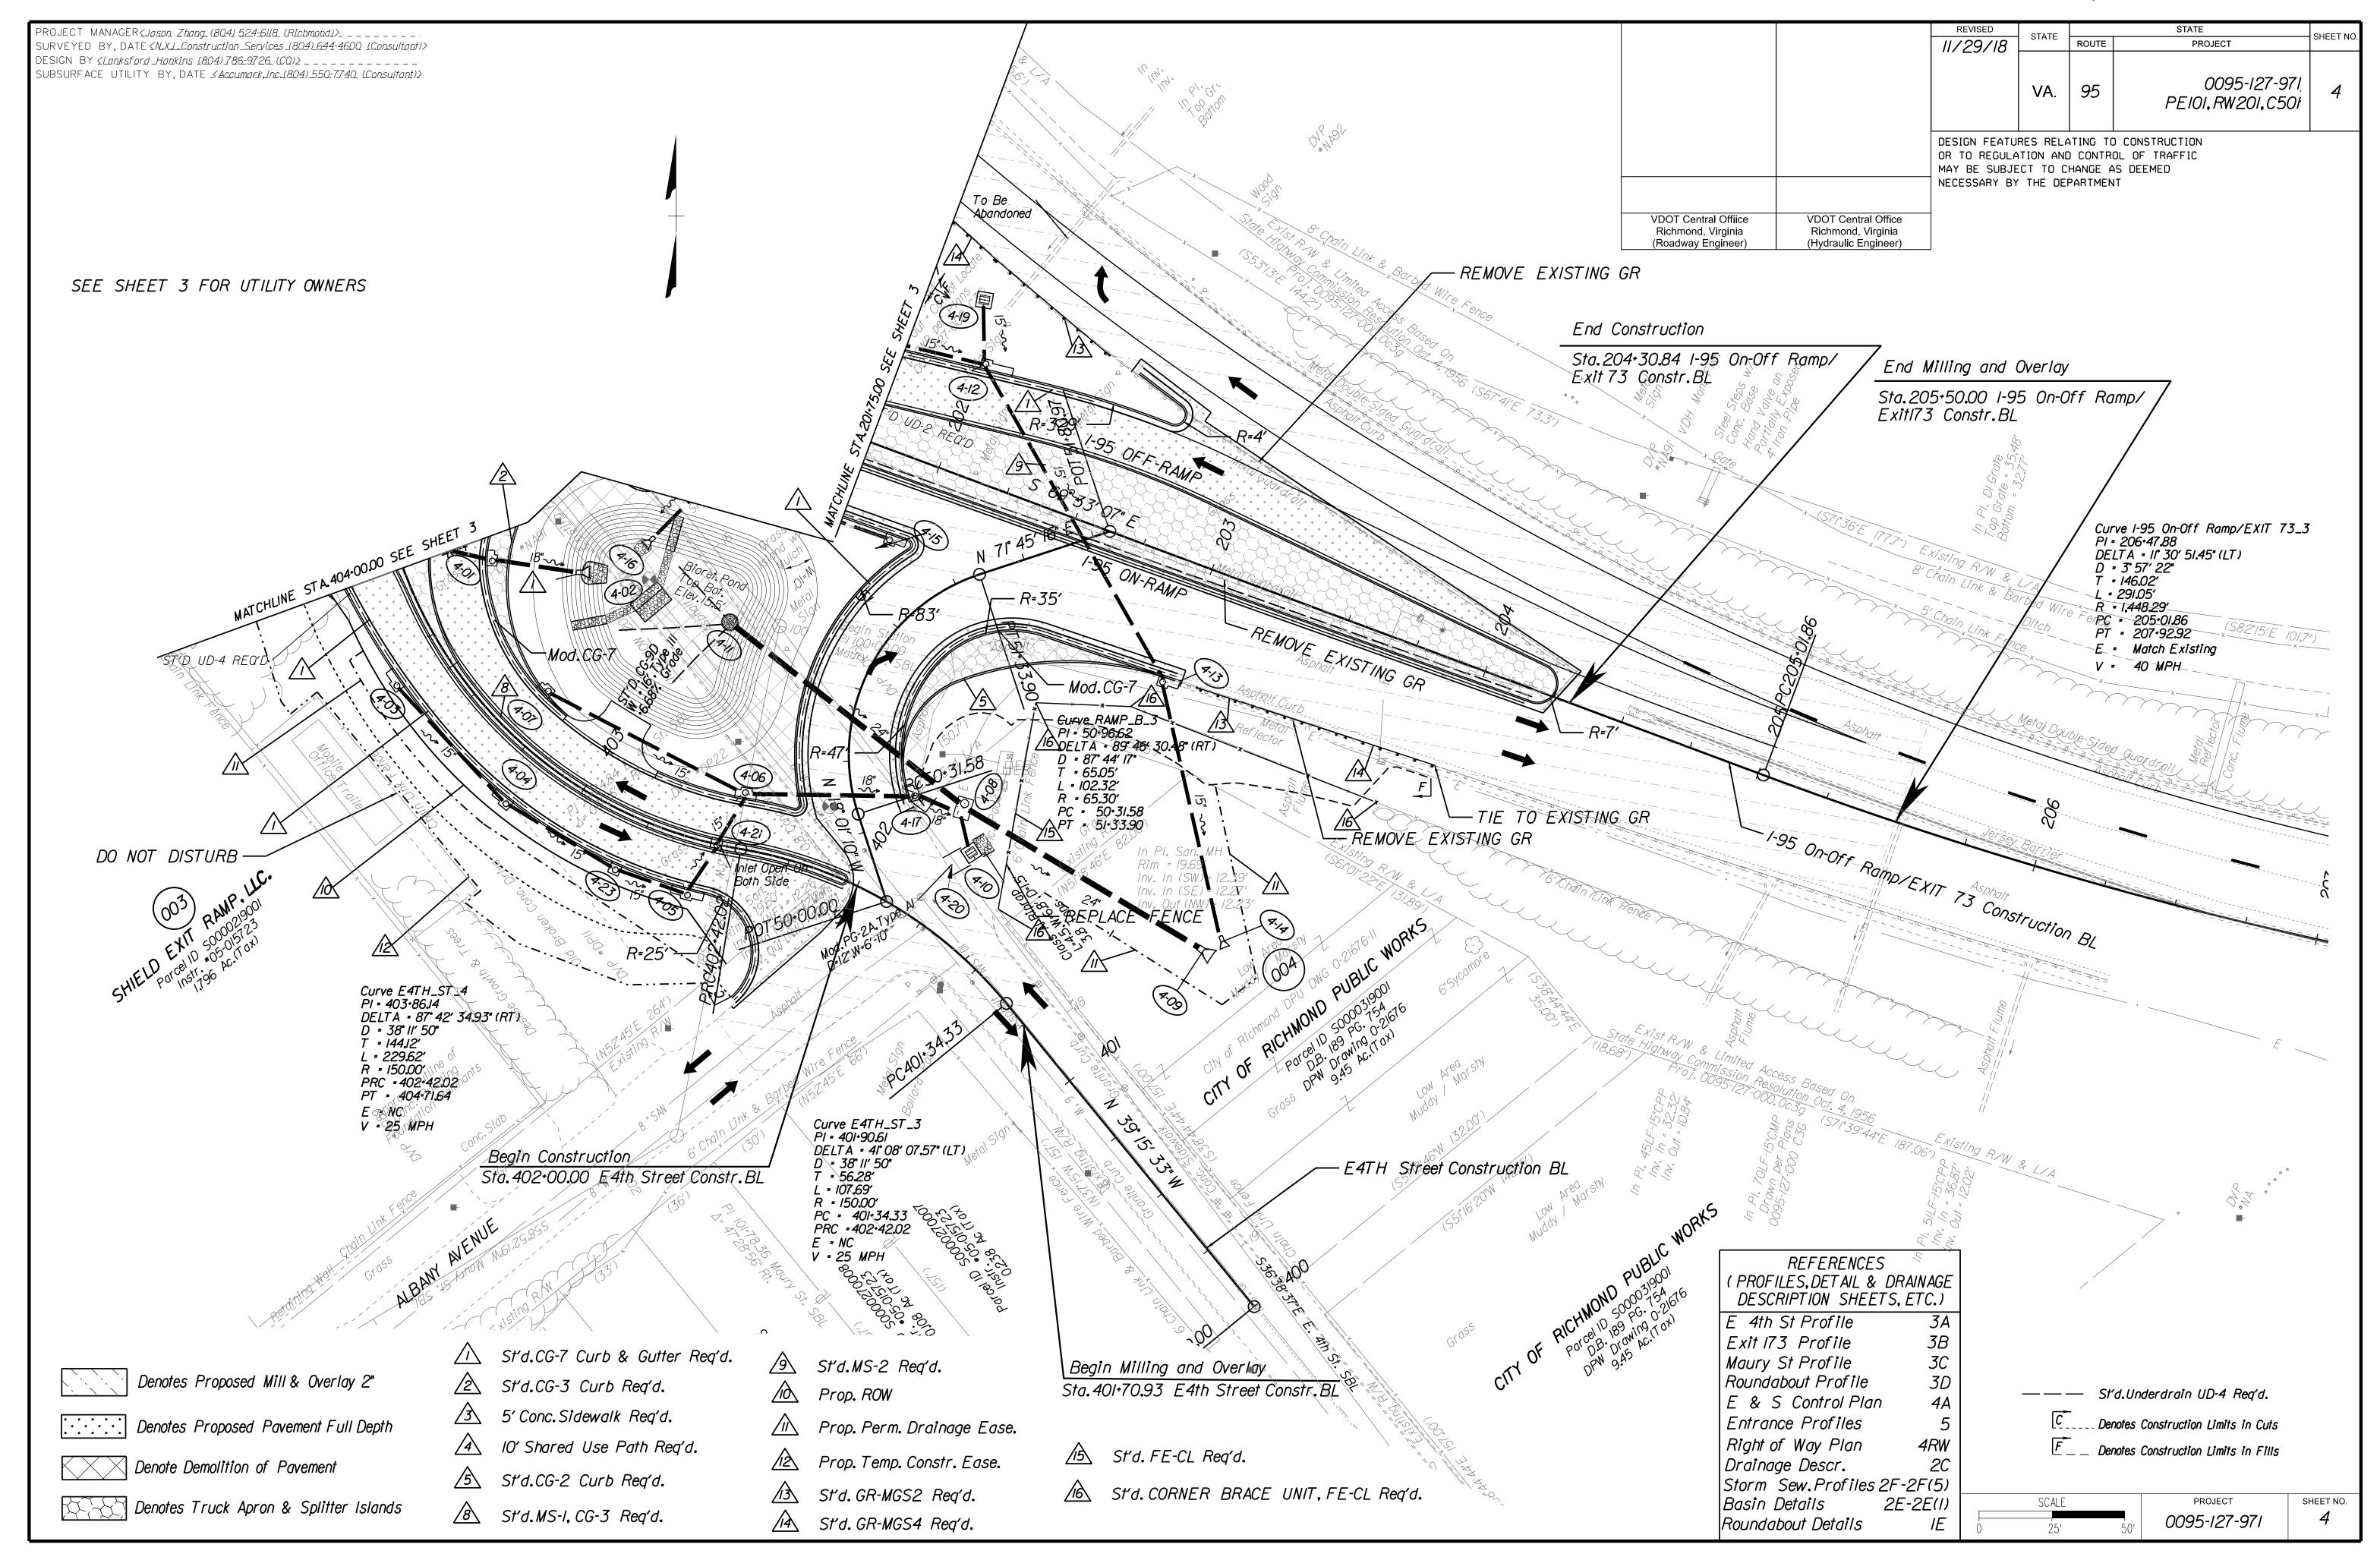

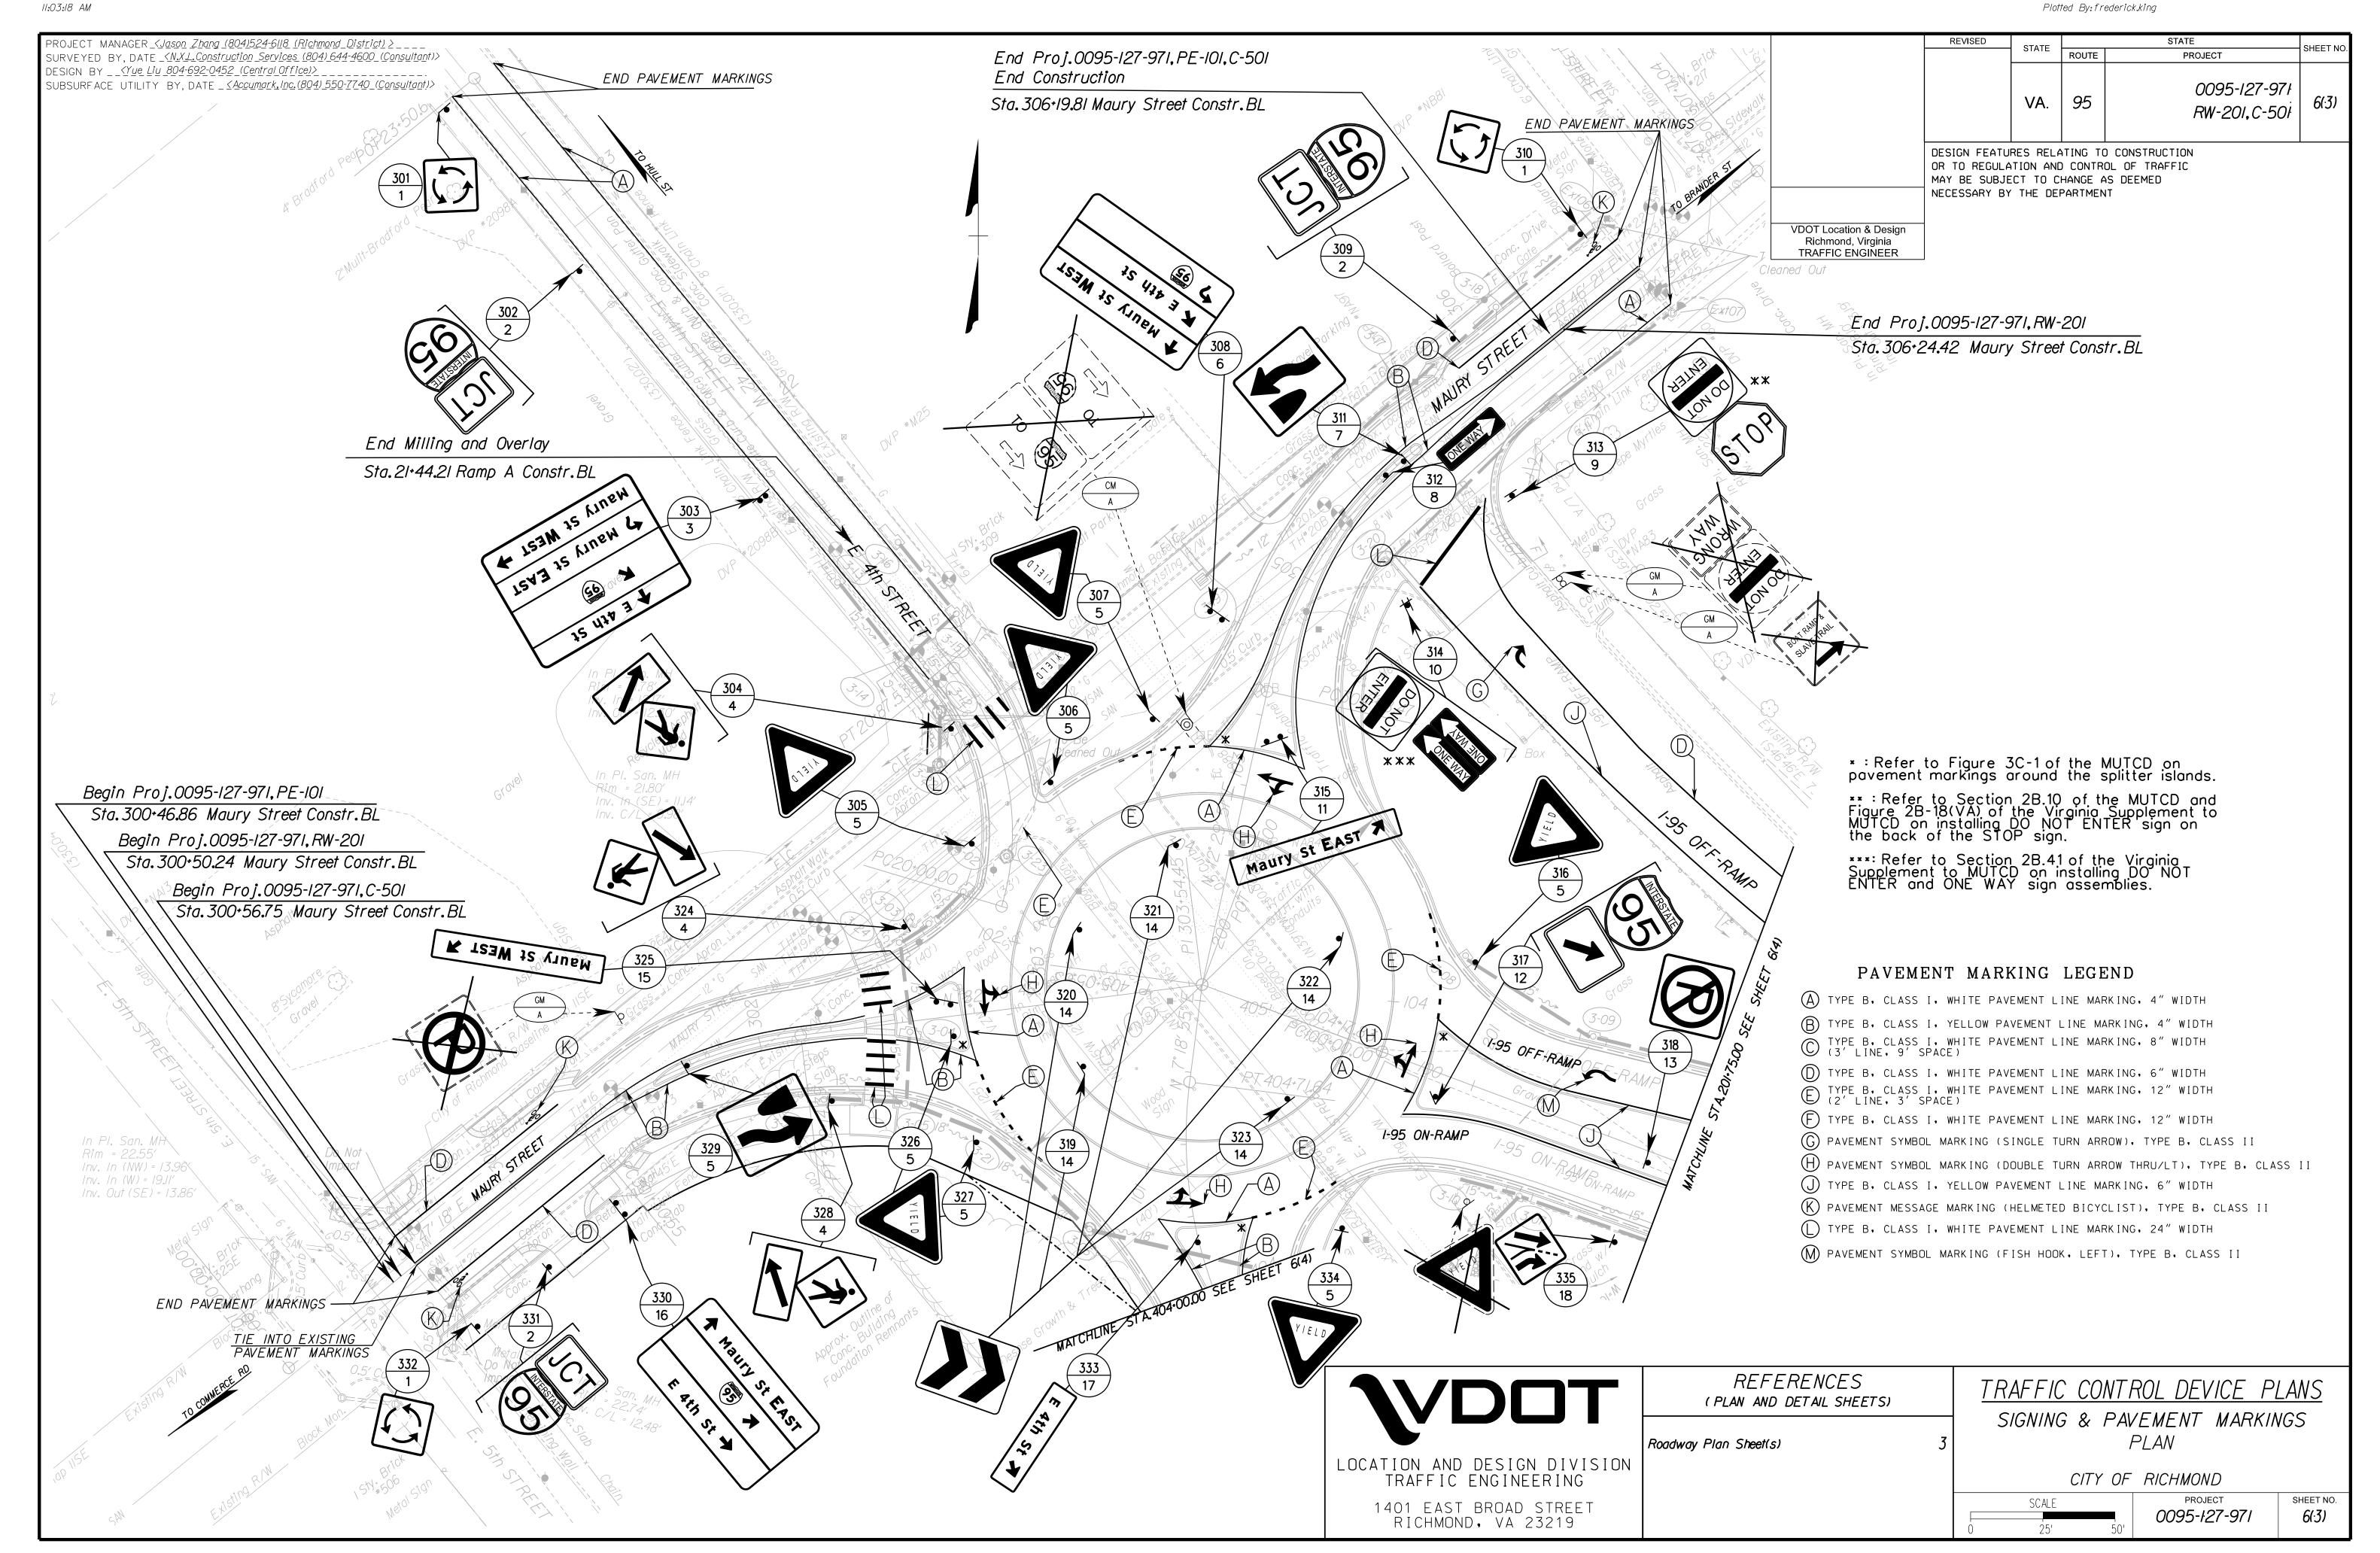

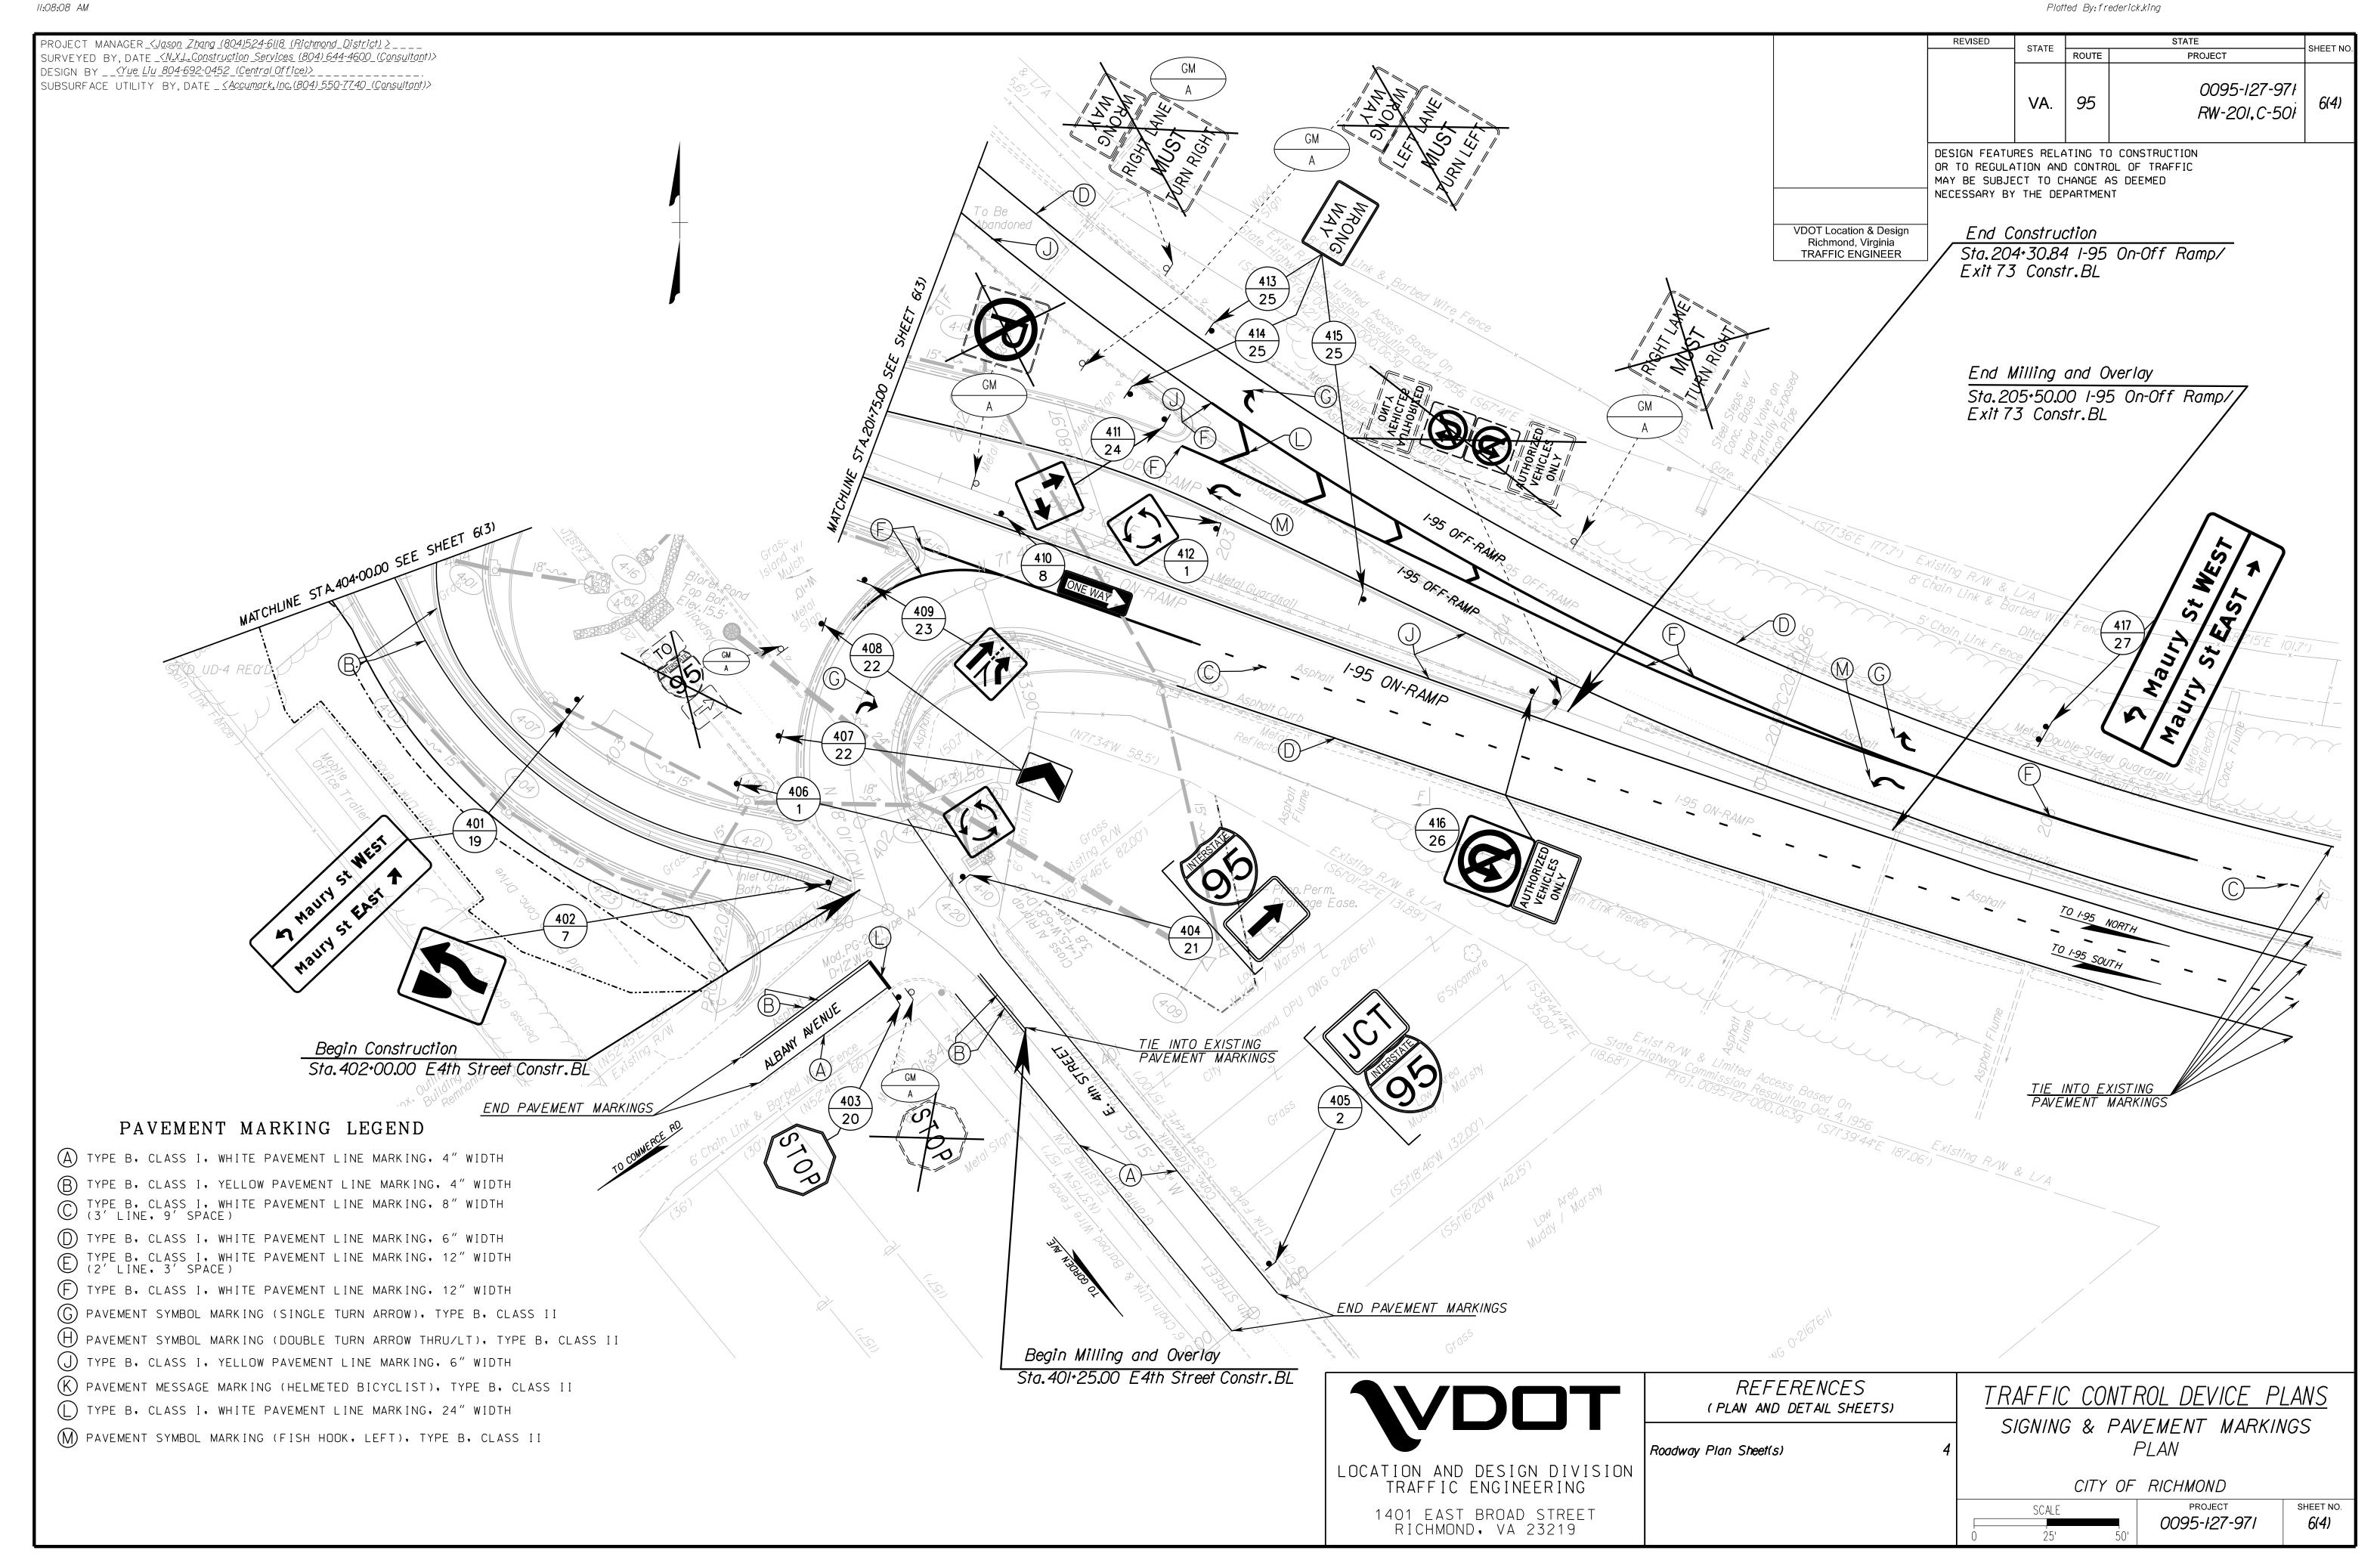

ROJECT MANAGER Jason Zhang, PE (804) 524-6118 (Richmond)
SURVEYED BY N.X.L.Construction Services (804) 644-4600 (Consultant)
ESIGN BY <u>Dale Huff,CLA (540) 643-2514 or (540) 577-8231</u>
SUBSURFACE UTILITY BY, DATE

General Notes

- 1. All planting shall be in accordance with VDOT Road and Bridge Specifications
- 2. All planting and site work shall be within the right of way or construction easement
- 3. The planting season for this project shall be from October 15 through December 10 or March 1 through April 15 depending on species.
- 4. All plants must be in place by March 15 in order that replacements may be made prior to March 30.
- 5. Size of plants indicated on this summary sheet refer to size of plants delivered to the project site, not after they have been pruned.
- 6. Plants shall be set in the planting pit, at the proper depth, on tamped soil mix. Soil mix shall then be filled around the roots to approximately 75% of the depth of the pit, tamped, and thoroughly watered. After settlement of the soil, the remainder of the pit shall be filled with soil mix and again watered, all within the same day of planting. The same procedure shall be followed in planting replacements.
- 7. During the establishment period the contractor shall water each plant with the following minimum quantities of water for each watering.
 - (A) Deciduous Trees over 10'Ht. 12 gallons per pit (B) Deciduous Trees 10' Ht. or less - 6 gallons per pit (C) Shrubs - 2 gallons per pit (D) Ground Covers/Perennials - 1 gallon per pit (E) Sod - 1" on surface.
- (F) In addition the Contractor will fill all 25 G. Tree Gators. The Contractor shall water all living plants every 2 weeks during the period between April 1 and May 31; every 2' weeks during the period between June 1 and September 30; and every 4 weeks during the period between October 1 and November 30. For Contractor's bidding purposes, this assumes a total of 18 times per year, and is included in the cost per plant. See note 32.
- 8. The Landscape Architect shall be given the opportunity to inspect and approve all plant material at its source prior to digging or delivery. If this opportunity is waived, a representative sample of each species may be required for approval prior to shipment of the total quantity.
- 9. Utility data has not been collected for this project. Prior to any construction, excavation, or landscaping, the contractor shall assume the responsibility of locating and verifying allutilities, above and/or below ground, public and/or private that may exist and cross through the areas of construction.
- 10. Major trees shall not be planted under overhead wires at any time.
- 11. Location of plant materials shown on the plans are schematic only and shall be adjusted as required for changes due to actual field conditions by the Landscape Architect.
- 12. The mulching material for this project shall be:

SHREDDED HARDWOOD BARK (See Standard 1201.08 for Mulch Specifications)

- 13. Unless otherwise noted on the plans, all street type trees will receive oversize planting pits. See Detail.
- 14. Definition of abbreviation:

CAL. - Caliper HGT. - Height

B & B - Balled & Burlapped - Container

- Bareroot - Each

- Linear Feet C.Y.

- Cubic Yard S.F. - Square Feet - Hour

15. Planting pits for container material shall be twice the width of the container and equal to the depth of the container. Should the ball size exceed the minimum size given, the pit size should be increased to meet the required of the planting details.

- 16. All integrally colored and impressed concrete will be MATCRETE/INCRETE or equal and shall be ADOBE per the MATCRETE color chart. Surface hardener will be 30% Autumn Brown and 30% Rustic Brown, applied randomly to facsimile actual cobbles. Score and Expansion joints are shown on the plans per Distict Materials Engineer. Wherever the concrete meets any other surface or joint, a 8" tooled, rough troweled edge will be implemented. A sample panel of the special concrete will be formed, poured, and tooled by the Contractor for inspection prior to proceeding. This sample panel will be inspected and approved by the Landscape Architect in conjunction with the Engineer prior to work proceeding. The impressed pattern will be <u>Cobblestone</u> imprinted radially. One contact for the MATCRETE/Increte product (Regional Representative) is Mr. Rodney Tozier 540-387-2261.
- 17. All integrally colored and impressed concrete surfacing requires expansion joints as determined by the District Materials Engineer. Shop drawings will be required from the concrete finisher that reflect how these expansion joints will relate to score joints so that a pattern is developed throughout the finishing. Shop drawings will be submitted for approval by to the Landscape Architect in conjunction with the Engineer.
- 18. On-center spacing shown is approximate and spacing shall be per the plan.
- 19. Cost for watering, vegetation control, litter pick-up from mulched areas and mulch refreshment for each visit as needed and directed by the Engineer is to be included in the cost per plant. See note 32.
- 20. For all trees, a 25 Gallon Tree Gator will be installed as part of the unit price for the plant. These will be filled during the watering schedule as indicated on the summary sheet, installed per the manufacturer recommendation and as approved by the Landscape Architect. See note 32.
- 21. All oversize planting pits shall be excavated and reviewed for approval by the Landscape Architect prior to backfilling or planting trees.
- 22.Under no circumstance will the root flare on shrubs and trees be covered with mulch or improved backfill. Root ball baskets will be removed entirely, burlap untied, and dropped to bottom of pit.
- 23. Seeding overlay "R", above, is a VDOT approved mix and will be installed per the manufacturers optimal recommendation. For seeding overlay mix "X", above, the contractor will submit a regional conservation wetlands seeding mix to the Engineer for approvalby the Landscape Architect. For estimating purposes, consult Ernst Conservation Seeding, VDOT Hampton Roads lo-gro mix.
- 24. Beds get one C.Y. improved backfill per bed and then 4'shredded mulch. Improved backfill will have mulch layer applied immediately after placement. No disturbed soil will remain uncovered by mulch for more than 24hrs.

LANDSCAPE GENERAL NOTES AND SUMMARY

DECICN FEATURES DELATING TO CONSTRUCTION	REVISED	STATE		SHEET NO.	
DESIGN FEATURES RELATING TO CONSTRUCTION OR TO REGULATION AND CONTROL OF TRAFFIC	1	STATE	ROUTE	PROJECT	SHEET NO.
MAY BE SUBJECT TO CHANGE AS DEEMED NECESSARY BY THE DEPARTMENT		VA.	95	0095-127-971 , C501	9(1)

PLANT KEY	BOTANICAL NAME	COMMON NAME (PAY ITEMS)	QTY.	UNIT	SIZE	Caliper	MIN.PIT SIZE DIAM. X DEPTH WATERING KEY	HT. OF BRNCH ING	ADDITIONAL REMARKS
А	Fagus grandifolia	American Beech	3	Each	16' min.	3''	Oversized Plant Pit See Detail A	min. 42'	Matched B. & B.; High Crotch uniform; Limbed up min. 42''
В	Magnolia virginiana	Swamp Magnolia	13	Each	8' - 10' min.	2''	Oversized Plant Pit See Detail A	min. 36'	B. & B.; Field Grown; Tree form
С	Cercis canadensis 'Black Pearl'	Black Pearl Redbud	30	Each	8' - 10' min.	2''	Oversized Plant Pit See Detail A	min. 36'	B. & B.; Field Grown; Tree form
D	Hamamelis virginiana	American Witch-hazel	3	Each	8' - 10' min.	2''	Oversized Plant Pit See Detail A	min. 36'	B. & B.; Field Grown; Tree form
BED	Plant cluster		145	Unit	Unit = 1 Bed	= 35 S	F		See Detail Plan A, sheet 9(2A)
E	Hemerocallis	*Native Orange / Yellow Daylily	*32	Bed	1 quart				50 / 50 mix
F	Yucca filimentosa 'Aureum'	*Varieted Yucca	*3	Bed	1 gallon				Field Grown clumps
	Narcissus 'February Gold'	*February Gold Daffodil	*40	Bed	9		5" - 6" depth		Class A Double nose - premium
	Narcissus 'Mount Hood'	*Mount Hood Daffodil	*40	Bed			5" - 6" depth		Class A Double nose - premium
	Lilliacaea 'Turk's Cap'	*Turk's Cap Lilly	*20	Bed			7" depth		Center in bed between yucca and shrub species;
	·						·		Class A heavy; Red/Orange mix 50 / 50
G	Magnolia virginiana	Swamp Magnolia	44	Each	3 gallon	3/4"	D		May substitute B. & B. Shrub form.
Н	Cercis canadensis 'Black Pearl'	Black Pearl Redbud	44	Each	3 gallon	3/4''	D		May substitute B. & B. Shrub form.
1	Hamamelis virginiana	American Witch-hazel	44	Each	3 gallon	3/4"	D		May substitute B. & B. Shrub form.
J	Chamaecyparis obtusa 'Nana Gracilis''	Dwarf Hinoki Falsecypress	220	Each					
		MISC. ITEMS							
K		Basin Seed Mix	1	Acre					See sheet 9(2A); See note 23
L		Sod	1,903	SY					
		Mulching	63	CY					
		Bed Preparation	51	Unit	Unit = 100 S	.F.			
		Remulching	42	CY					
		Bed Prep. Type B	145	Unit	Unit = 1 Bed	= 35 S	F		
		Oversize Planting Pit	49	Each					
		Improved Backfill	113	CY					8 - 10'' depth; Topsoil provided by contractor
М		Ornamental Stone Cover	104	SY					
N		Boulders	9	Each					
		Steel Edging	189	LF					
0		Integrally Colored and Impressed Concrete	930	SY					
		∗Included in the cost per bed							
	25. DELIVERY AND INSPECTION:	ct shall be given the apportunity to inspect and sele			30. BEDS:		existing turf and weeds shall be eradicated by removal or berbic	. , .	

- (A) The VDOT Landscape Architect shall be given the opportunity to inspect and select plants utilizing a VDOT Plant Identifiation tag at the source of supply prior to diaging
- (A) The Landscape Architect shall also inspect the Plants upon delivery to ensure that plants are living viable, disease free, pest free, that all trees have a basal flare at the top of the root container or root ball and are not covered with additional soil, that all trees have a central dominant leader, and that all plants are healthy and in a condition suitable for immediate planting. Plants not meeting these specifications will be rejected.

live tissue.

- (A) Plants that are not to be installed within 48 hours of delivery shall be hilled in with shredded bark mulch to completely cover the container or root ball, and shall be watered in sufficiently to saturate the mulch. A site shall be selected that is in the shade from 11:00 AM to dusk, or a shade structure may be erected on site to provide shade. (B) - Plants shall be monitored daily for signs of stress and shall be watered in daily until
- (C) Plants that have shed their foliage or plants with foliage that has turned brown due to stress shall not be planted and shall be removed from the project site.
- (D) In no case shall plants be stored in a closed storage unit where natural light and water
- (E) Plants stored on site for more than 10 days shall be rejected.
- The Landscape Architect (or his representative) shall inspect plants and direct the Contractor
- to prune limbs and roots according to the following: (A) - LIMBS: While laying down on side, inspect the tree crown, and make clean pruning cuts as necessary to remove codominant leaders, dead or broken branches, and basal suckers. (B) - All above ground pruning shall be made just outside the branch collar and all basal suckers
- back to the point of origin, even if from the root system. Trees having co -dominate leaders within the lower 2/3's of the crown shall be rejected. Reduction pruning of codominate leaders will be limited to limbs less than 1.5" inches in diameter (C) - ROOTS: Inspect root zone for potential stem girdling roots (SGRs), "J" roots, or any roots

starting to encircle around the stem or root system. Prune away defective roots back to

- 28. STAKEOUT: (A) - The Contractor shall stakeout proposed plant locations of trees and shrubs in reasonable conformance with the plans, making adjustments for existing trees not to be disturbed. Staking shall be wood stakes (color coded with paint), or metal (color coded with flags) to differentiate between large trees, small trees, evergreen trees, large shrubs and small shrubs. The location of shrub masses shall be outlined with paint. The Landscape Architect shall review and approve the proposed stakeout and/ or call for adjustments in the location of plant materials by the contractor prior to beginning planting operations.
- 29. PRE-EMERGENT AND FERTILIZER APPLICATION: (A) - Top-dress each planting pit with a granular, slow release pre-emergent herbicide and fertilizer as approved by the Landscape Architect. For beds, apply pre-emergent
- throughout the bed at the manufacturer's specified rate. (B) Then apply a 3" layer of mulch as specified, being careful to keep mulch away from
- the trunk base. (C) - Cost for pre-emergent and fertilizer application shall be included in the Contract Unit Price Bid for Each Tree and Shrub.

- (A) In bed areas, existing turf and weeds shall be eradicated by removal or herbicide spraying. Herbicide must be applied at least One Week before Bed Préparation. Any soilremoved with weeds/turf shall be replaced with improved backfill prior to planting operations. See Section 605 of the Specifications for "BED PREPARATION".
- 31. PLANTING OPERATIONS COORDINATION MEETING: (A) - Following award of the project, and at least 3 months prior to Planting Operations the Contractor shall schedule a meeting with the Engineer, and the Landscape Architect to review elements of the plans and expectations for quality of materials, workmanship, manner of executing the work, site preparation and maintenance during the establishment
- 32. WATERING, WEEDING, PEST CONTROL DURING PLANT ESTABLISHMENT PERIOD: (A) - Generally, NO WATER WELLS/SAUCERS (except on downward side of sloped plant pits) shall be constructed with subsoil.
- (B) Watering for all deciduous and evergreen trees shall be accomplished by use of 20 gallon (Min.) Watering Tubes / Bags as specified in the attached Special Provisions. (C) - Water trees and evergreens routinely, filling Watering Tubes / Bags once every 14 days from May 1st through Oct. 30th. Remove Watering Tubes / Bags at the end
- of the first full growing season. If drought conditions persist. Fill bags every week. (D) - All other plants shall be watered every 7 days (minimum) at the following rates unless there has been 1" or more of rainfall for that specific week. -Shrubs or Grasses 24" height or greater: - 2 Gallons Per Pit (Min.) - 1 Gallon Per Pit (Min.) ii -Shrubs or Grasses less than 24'' height:
- iii Ground Covers - 0.5 Gallon Per Pit. (Min.) (E) - Contractor is responsible for controlling pests, plant disease and removing weed growth in tree rings and plant beds throughout the establishment period. Project shall be inspected on a weekly basis (in concert with watering during the growing season) and corrective action taken for control of weed growth and pest infestations by pesticide and herbicide spraying as directed by the Landscape Architect.
- (F) Watering rates shown are for the minimum amount depending on weather, and the price for watering is to be included in the cost per plant.
- 33. TERMINUS OF ESTABLISHMENT PERIOD:
- (A) A finalinspection of the project shall be made at the terminus of the Establishment period to identify dead, dying, damaged and diseased plants to be removed and replaced in kind. Plants shall be replaced at the contractor's expense. (B) - Should tree stakes and guys be used, all above-ground materials shall be removed & discarded off-site after first full growing season (end of October). Plants shall stand
- (C) Any water wells that may have been constructed (on sloped pits only) shall be a TEMPORARY aid and shall be removed after first full growing season (end of October). Tree rings shall be weed-free and shall be remulched at the end
- of the establishment period. (D) - Discard all trash and debris generated during operations off-site at an appropriate waste facility. No waste materials shall be buried in planting pits/beds or otherwise

plumb and be maintained upright and at a positive grade throughout the establishment

- 34. Bulbs are to receive the recommended application of HOLLYTONE at time of installation, to be included in cost of bulb.
- 35. In addition to improved backfill for all planting holes, Diehard Transplant or other approved mycorrhizal blend shall be used according to manufacturers recommendations.


THESE PLANS ARE UNFINISHED AND ARE NOT TO BE USED FOR ANY TYPE OF CONSTRUCTION.

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- 36. Improved Backfill will be 60% Class B Topsoil and 40% Organic Compost as approved by the Landscape Architect in conjunction with
- 37. All beds to recieve recommended application of Diehard Transplant at time of installation to be included in cost per bed.


PROJECT 0095-127-971 SHEET NO. 9(1)


110932109(2)**.**dgn 7/26/2019 Plotted By: WAP04107\$ 10:25:23 AM PROJECT MANAGER <u>Jason Zhang,PE (804)524-6118 (Richmond)</u> STATE REVISED ROUTE PROJECT SURVEYED BY, DATE N.X.L. Construction Services (804) 644-4600 (Consultant) DESIGN BY *Dale Huff,CLA (540) 643-2514 or (540) 577-8231* SUBSURFACE UTILITY BY, DATE _____ LANDSCAPE DETAILS 95 0095-127-971,C-501 9(2) VA. DESIGN FEATURES RELATING TO CONSTRUCTION ** REMOVE BINDING MATERIALS FROM TRUNKS AND STEMS, AND REMOVE METAL CAGES FROM ROOT BALLS OR TO REGULATION AND CONTROL OF TRAFFIC PLACE ROOTS IN NATURAL GROWING POSITION.
CAREFULLY WORK SOIL AROUND ROOTS. SOAK THE SOIL AROUND THE ROOTS UNTIL IT IS COMPLETELY SATURATED. MAY BE SUBJECT TO CHANGE AS DEEMED AFTER SPREADING MULCH, HAND TAPER TO THE BASE OF THE TRUCK OR STEM (TYPICAL). ATTACH ABOVE THE FIRST BRANCH — RING OF SOIL ANY TYPE OF CONSTRUCTION. STAKES WILL BE DRIVEN OUTSIDE THE BALL OR ROOT AREA DRIVE STAKE AT ANGLE AND DRAW VERTICAL ~ SOIL MIXTURE ✓ CUT LOOSE AND
REMOVE WRAPPING
MATERIALS FROM
ROOT BALL
(TYPICAL). * * (WITHOUT TAPROOT)
PLANTING BARE ROOT TREES.
SPREAD THE ROOTS OVER THE SOIL. (SHRUBS) IF THERE IS A TAP ROOT PRESENT PLANT THE BARE ROOT TREE AS SHOWN. STAKING MAY BE REQUIRED 2" X 2" X 6'-0" LONG STAKE BALLED & BURLAPPED, & CONTAINER PLANTS BARE ROOT PLANTS Richmond, Virginia RING OF SOIL ON DOWNWARD SIDE OF SLOPE DEPTH OF STAKES 'F SHALL BE 2'-0" ALL AREAS BETWEEN PLANTS WILL BE CULTIVATED 6" IN DEPTH, MIN. ∕ 3" MULCH DEPTH OF STAKES SHALL BE 2'-0" - GEOTEXTILE FABRIC ** CUT LOOSE AND REMOVE WRAPPING MATERIALS FROM ROOT BALL (TYPICAL) 2" # 357 AGGREGATE WHEN REQUIRED * FINISHED GRADE \ SOD —

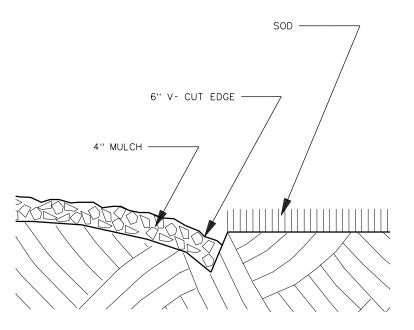



TYPICAL EDGING DETAIL FOR

INDIVIDUAL PLANT PITS AND BEDS NTS

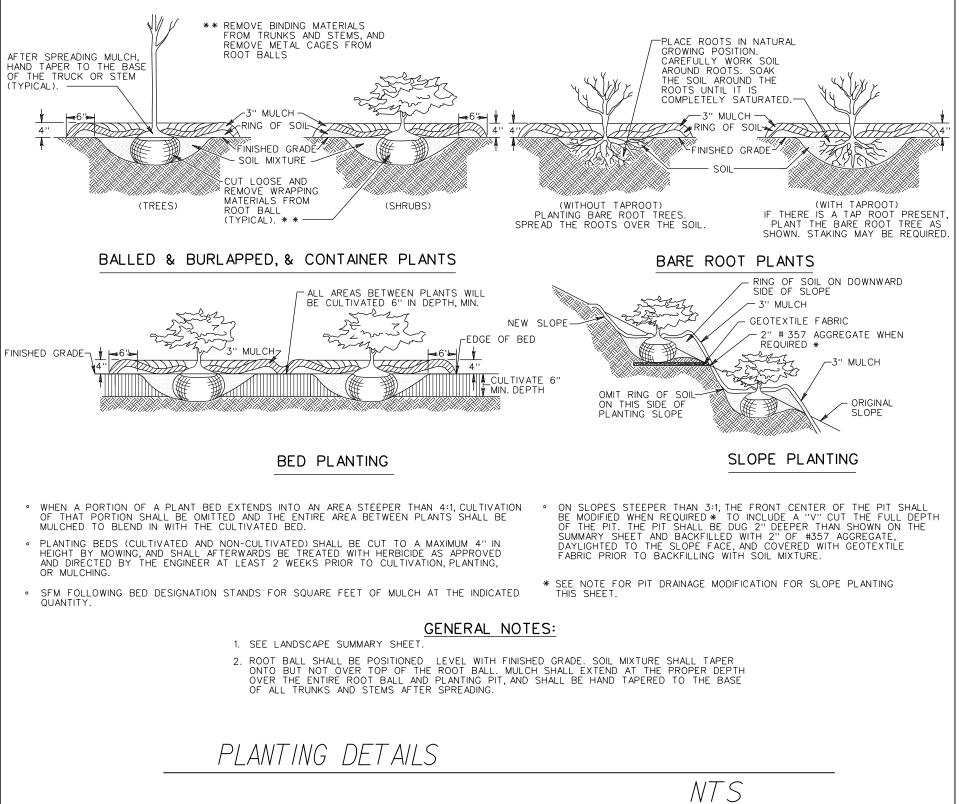

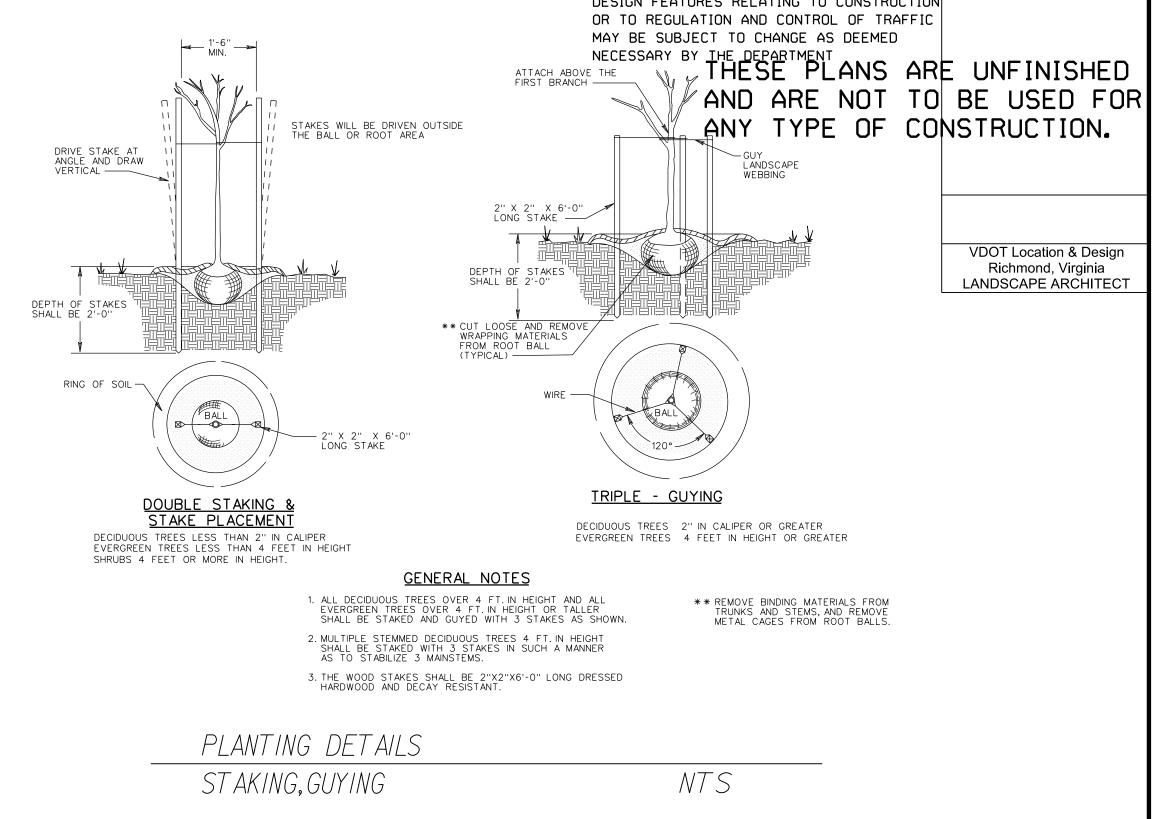

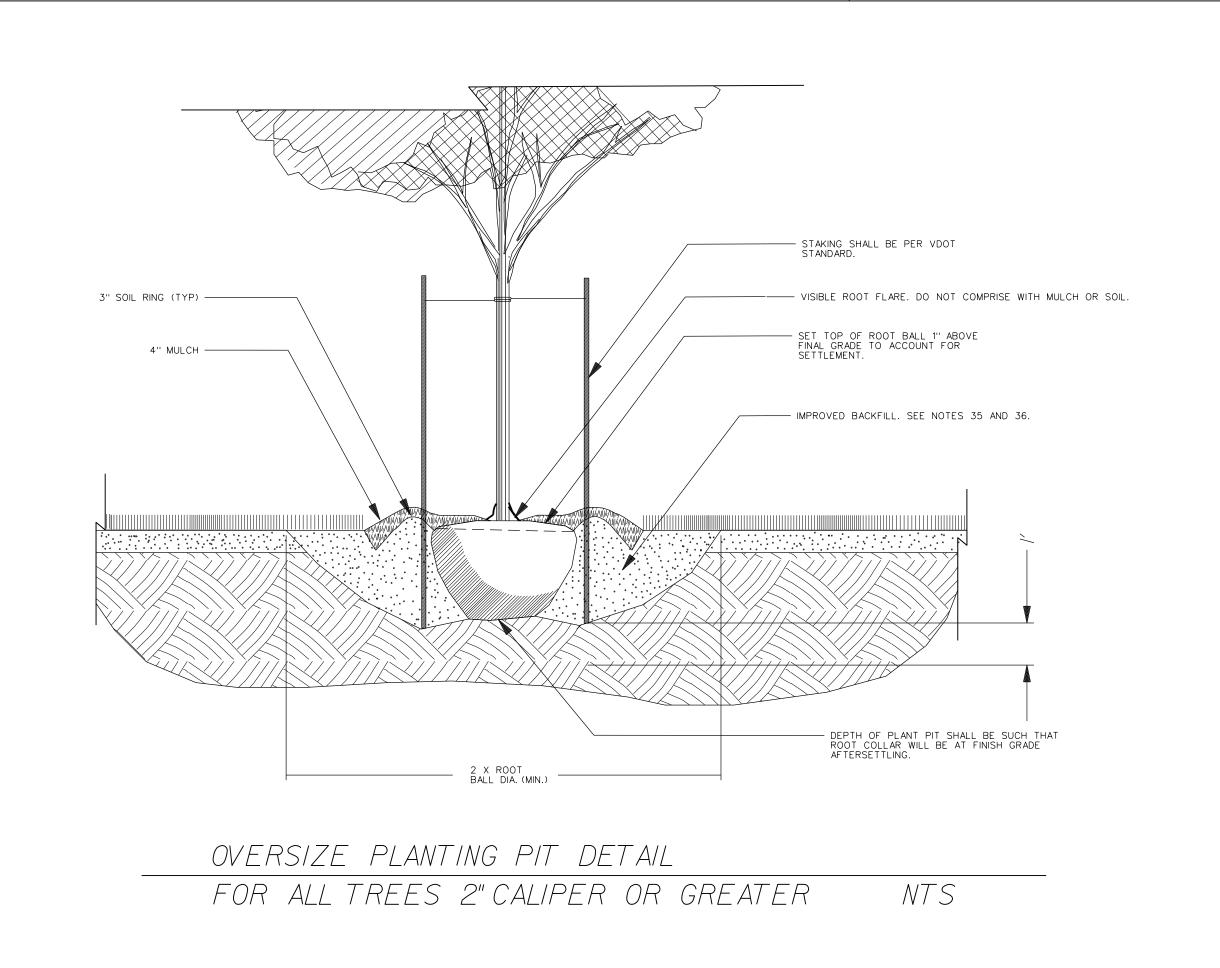

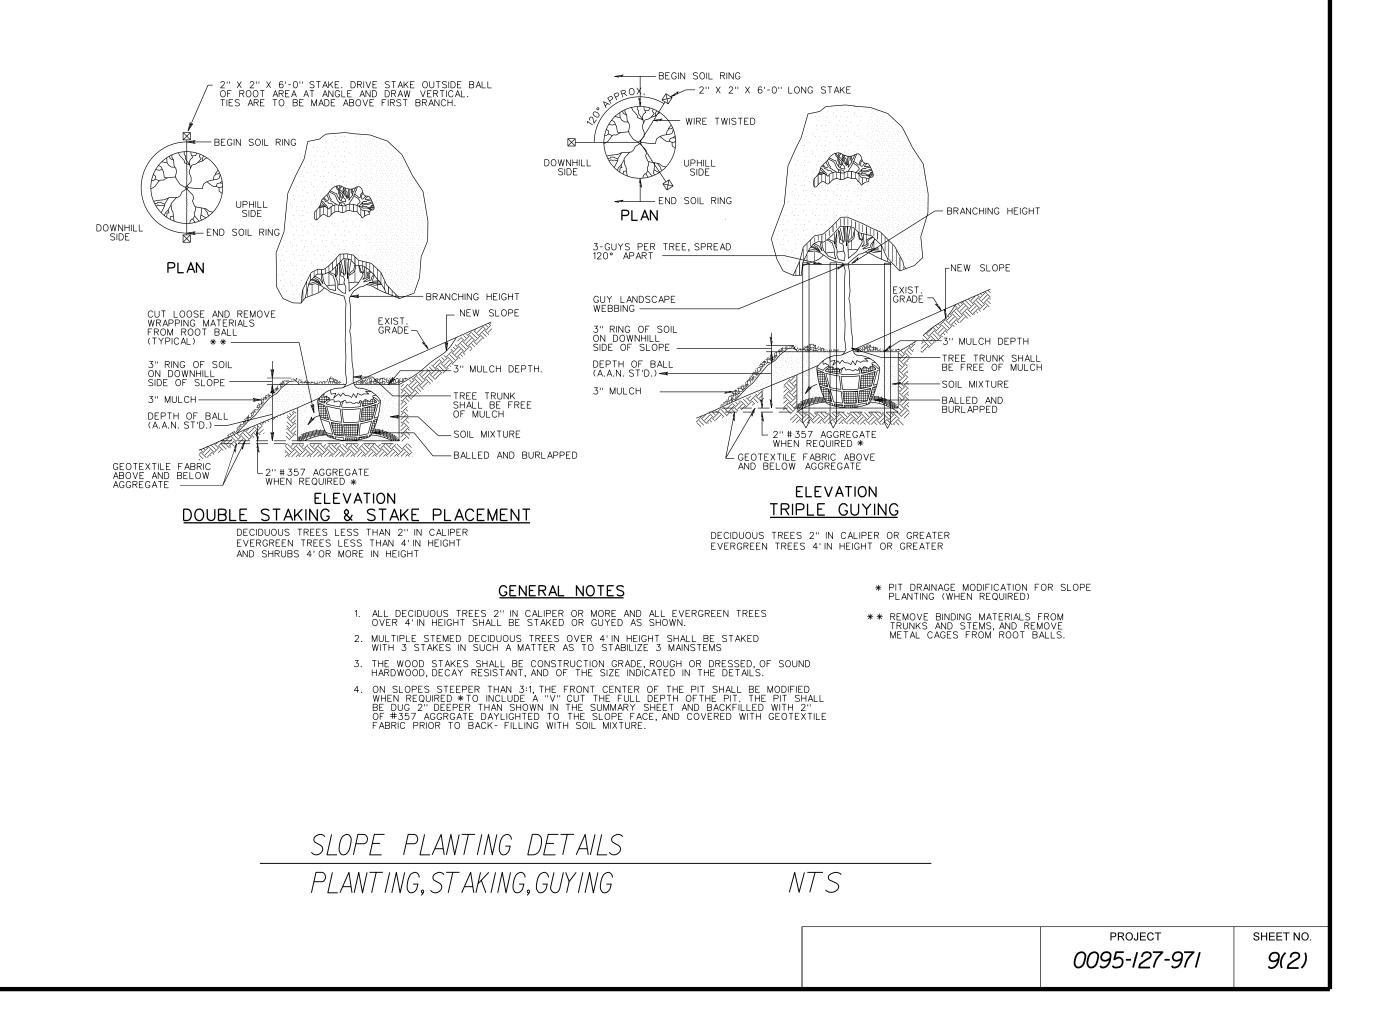

PROJECT MANAGER <u>Jason Zhang</u>, <u>PE</u> (<u>804</u>) <u>524-6118</u> (<u>Richmond</u>)

SURVEYED BY, DATE N.X.L.Construction Services (804) 644-4600 (Consultant)

DESIGN BY <u>Dale Huff, CLA (540) 643-2514 or (540) 577-8231</u>

SUBSURFACE UTILITY BY, DATE _______

SHEET NO.

9(2A)

0095-127-971

BED PLANTING DETAILS & BASIN SEED MIX

V DACI	N SEED MIX
<u>A - BASII</u> QTY	N SEED MIX SEED TYPE
8.0%	CREEPING BENTGRASS
9.0%	COLONIAL BENTGRASS,'HIGHLAND'
5.0%	BROOMSEDGE,MO ECOTYPE
0.5%	SOFT RUSH
10.0%	REDTOP PANIGRASS,COASTAL PLAIN NC ECOTYPE
10.0%	ROUGH BLUEGRASS
0.2%	VIRGINIA SPIDERWORT,SOUTHEASTERN PA/NORTHERN VA BLEND
0.3%	PARTRIDGE PEA,PA ECOTYPE
2.0%	LANCELEAF COREOPSIS
1.5%	ANNUAL GAILLARDIA (INDIAN BLANKET)
1.5%	BLACKEYED SUSAN,COASTAL PLAIN NC ECOTYPE
50.0%	LITTLE BLUESTEM, FORT INDIANTOWN GAP-PA ECOTYPE
1.0%	SHOWY TICKSEED SUNFLOWER (BUR MARIGOLD)
1.0%	COASTAL PLAIN NC ECOTYPE
Notes: Se	eding Rate: 30 lbs.per acre from Oct May,mid-May preferred.Can be hydroseeded.

Ernst Conservation Seeds Inc., seed mixture or approved equal.

THESE PLANS AND ARE NOT TO BE USED FOR CONSTRUCTION.

ARE UNFINISHED TO BE USED FOR CONSTRUCTION.

DESIGN FEATURES RELATING TO CONSTRUCTION OR TO REGULATION AND CONTROL OF TRAFFIC MAY BE SUBJECT TO CHANGE AS DEEMED NECESSARY BY THE DEPARTMENT

VDOT Location & Design Richmond, Virginia LANDSCAPE ARCHITECT

REVISED

