

45'S'UC'IAT'E'S, IN VG ENGINEERS KESIDE AVENUE

RGINIA DETAILS

HMOND, VIRG

DRAINAGE MAPS, CA

REVISIONS:

DATE: 5-13-19

DESIGNED
BY: BSH


DRAWN
BY: GAE

BY: GAE
CHECKED
BY: BSH

SCALE: 1" = 40'

JN. 1820

PRELIMINARY

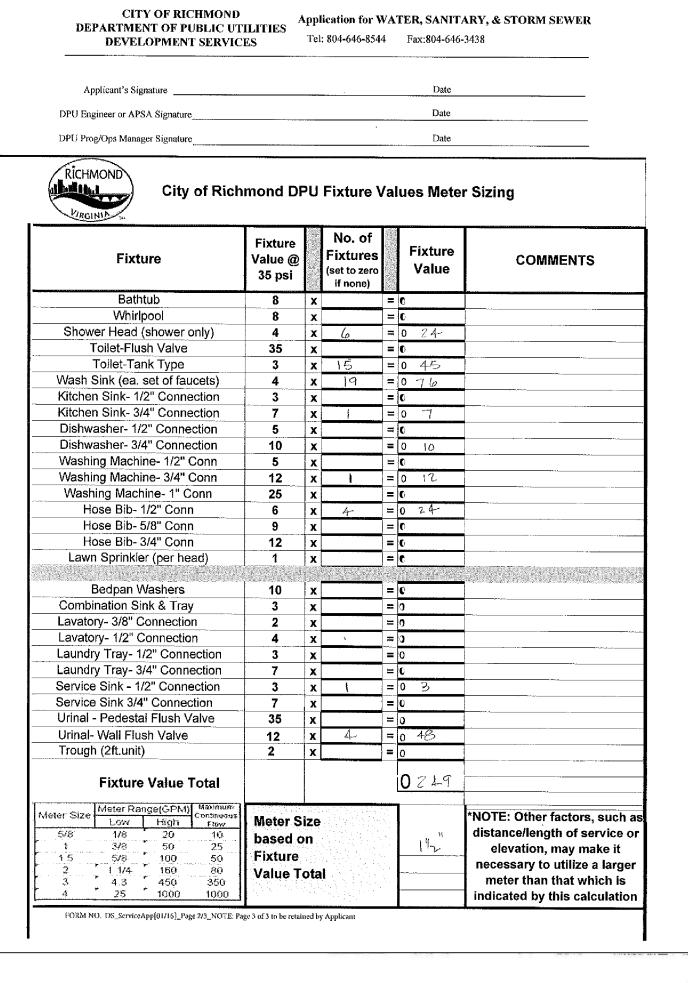

DEPARTMENT OF PUBLIC UTILITIES

RICHMOND, VIRGINIA

**HYDRANT** 

FLANGE

- DO NOT BLOCK

WEEP HOLES, PLACE STONE OVER

WEEP HOLE AREAS

/1/2 CY # 57 STONE

DPU DWG. NUMBER:

M - 11

RREAKAWAY

**ELEVATION** 

- SIDEWALK

FACE OF CURB

EXTENSION SEE

DETAIL, FIGURE 1

VALVE STEM EXTENSION

57 STONE FULL WIDTH

OF TRENCH AT VALVE BOX

- TEE OR TAPPING

DRAWN X

CHK'D X

DATE 6/29-04

SCALE NOT TO SCALE

WATERMAIN

SMALL VALVE BOX

12" TYP.

RETAINER

RESTRAIN JOINTS

GLAND (TYP.)


CITY OF RICHMOND, VIRGINIA

FIRE HYDRANT DETAIL

ALL JOINTS TO BE RESTRAINED.


2. IN GRASS AREAS PROVIDE 1'-6" SQ. x 4"


THICK CONC. PAD AROUND TOP OF VALVE BOX.

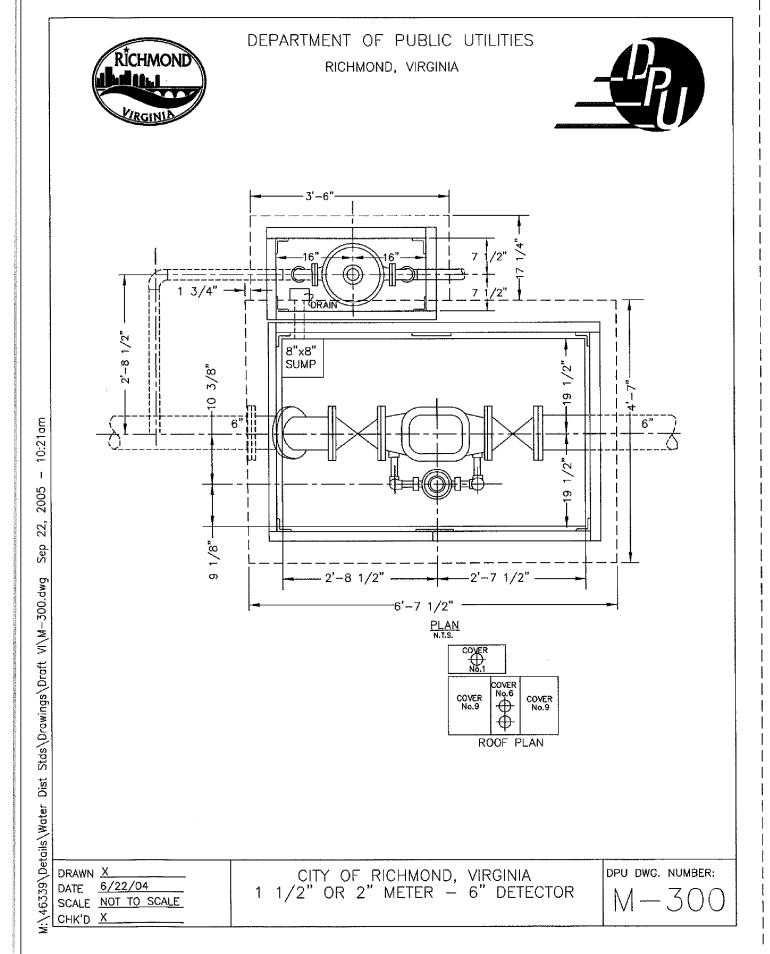

## STANDARD NOTES

- ALL CONSTRUCTION AND MATERIALS SHALL CONFORM WITH THE LATEST EDITION OF STANDARDS AND SPECIFICATION OF THE VIRGINIA DEPARTMENT OF HIGHWAYS AND TRANSPORTATION, EXCEPT WHERE LOCAL JURISDICTION STANDARDS ARE APPLICABLE.
- MANHOLE STRUCTURES MAY BE EITHER PRECAST OF CAST-IN-PLACE.
- CONTRACTOR SHALL BE RESPONSIBLE FOR NOTIFYING THE UTILITY CONSTRUCTION DIVISION AND SCHEDULING A PRE-CONSTRUCTION MEETING AT LEAST 48 HOURS PRIOR TO STARTING ANY WORK ON THIS PROJECT. ALL WORK SHALL BE SUBJECT TO INSPECTION BY COUNTY INSPECTORS.
- 4. THE CONTRACTOR SHALL NOTIFY THE OWNER AT LEAST 48 HOURS PRIOR TO STARTING WORK ON THE PROJECT.
- ALL PERMITS, INSPECTIONS AND APPROVALS SHALL BE THE RESPONSIBILITY OF THE CONTRACTOR AND AT HIS EXPENSE.
- 6. THE CONTRACTOR IS REQUIRED TO MAINTAIN ALL PIPES AND STRUCTURES FREE FROM OBSTRUCTION UNTIL ACCEPTED BY THE COUNTY AND THE OWNER. THE CONTRACTOR IS RESPONSIBLE FOR ANY DAMAGE CAUSED BY FAILURE TO MAINTAIN THE SANITARY OR STORM SEWERS IN OPERABLE CONDITION.
- TOPOGRAPHIC DATA SHOWN HEREON WAS OBTAINED FROM A FIELD SURVEY BY HULCHER & ASSOCIATES, INC. AND SUPPLEMENTED BY RECORD INFORMATION FROM OWNER.
- CONTRACTOR SHALL DISPOSE OF ALL SURPLUS MATERIAL OFF-SITE IN AN APPROVED AREA AND MANNER SUBSEQUENT TO DETERMINING THAT THE OWNER DOES NOT DESIRE TO STORE ANY OF THE MATERIAL.
- THE LOCATION OF ALL EXISTING UTILITIES MAY OR MAY NOT BE SHOWN: AND WHERE SHOWN IS APPROXIMATE ONLY. THE CONTRACTOR SHALL FIELD VERIFY THE LOCATION OF ALL EXISTING UTILITIES TO HIS SATISFACTION PRIOR TO EXCAVATION.
- 10. THE CONTRACTOR SHALL PROVIDE PROPER NOTIFICATION TO "MISS UTILITY" (811) PRIOR TO COMMENCEMENT OF CONSTRUCTION.
- 11. THE CONTRACTOR SHALL GUARANTEE ALL WORKMANSHIP AND MATERIALS FOR ONE YEAR OF ACCEPTANCE BY OWNER.
- 12. THE CONTRACTOR SHALL MAINTAIN SET OF PLANS ON-SITE AT ALL TIMES. HE SHALL CONTINUALLY REFLECT "AS BUILT" CONDITIONS ON THIS SET AND RETURN IT TO THE ENGINEER AT PROJECT COMPLETION.
- 13. CONTRACTOR IS RESPONSIBLE TO VISIT THE SITE AND DETERMINE THE SITE CONDITIONS AND DEGREE OF DIFFICULTY INVOLVED IN PROPERLY ATTENDING TO THE WORK PRIOR TO PRICING THE JOB. HE SHALL BRING TO THE ATTENTION OF THE ENGINEER ANY DISCREPANCIES NOTED IN HIS VISIT OR REVIEW OF THE CONTRACT DOCUMENTS.
- 14. ALL TEMPORARY FACILITIES (WATER, TOILET, ETC.) SHALL BE SUPPLIED AND MAINTAINED BY THE CONTRACTOR.
- 15. ALL PAVEMENT MARKING SHALL BE 4" WIDE WHITE REFLECTORIZED PAINT.
- 16. ALL SIGNS SHALL CONFORM TO THE LATEST EDITION OF THE MANUAL ON UNIFORM TRAFFIC CONTROL DEVICES.
- 17. CONTRACTOR IS TO ENSURE THAT ALL ENT., WALKS & RAMPS MEET ADA REQUIREMENTS. CONTACT THE ARCHITECT IF THERE IS ANY QUESTIONS SEE ARCH. PLANS FOR LANDINGS, RAMPS AND HANDRAILS.
- 18. CONTRACTOR IS RESPONSIBLE FOR ALL SITE SAFETY REQUIREMENTS.
- 19. CONTRACTOR SHALL COORDINATE ALL UTILITIES IN SIZE, LOCATION AND ELEVATION.
- 20. ALL HANDICAP PARKING SPACES SHALL NOT EXCEED A 2% SLOPE IN ANY
- 21. ALL DISTURBED AREAS ARE TO BE STABILIZED PRIOR TO FINAL PAYMENT. THIS INCLUDES TOPSOIL, SEEDING, FERTILIZING AND MULCHING ALL AREAS.

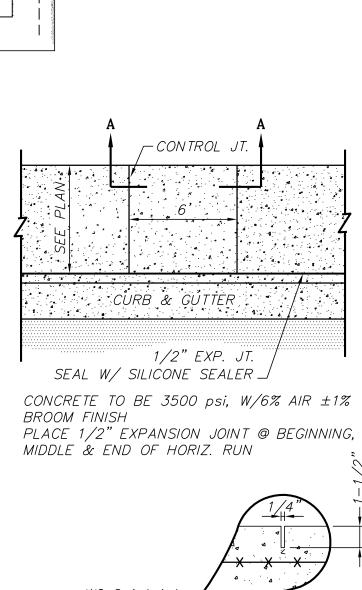

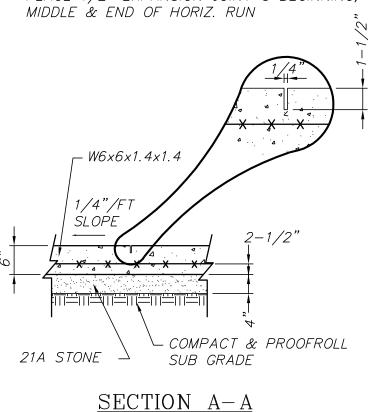

SIDEWALK DETAILS NO SCALE

\* WITH TAMPER-PROOF SWITCH & REMOTE MONITORING PER NFPA 13 TOP OF GROUND POURED IN PLACE CONCRETE PIPE SADDLES OR METAL PIPE STANDS COATED W/RUST RETARDANT COATING PIPE SIZES TO BE *INSTALLATION* PROVIDE NEMA 4X DISCONNECT IN EACH

FOR ADDITIONAL INFORMATION ON REVIEW, DESIGN & CONSTRUCTION

SEE PART IV, & PART V OF THE CHESTERFIELD COUNTY SPECIFICATIONS

EXT. COATING

BELOW GROUND VAULT CONSTRUCTION SHALL BE

REFER TO BOCA

PLUMBING CODE FOR DRAINAGE REQUIREMENTS

IN ACCORDANCE WITH BUILDING CODES

JD-2AL 4'-0" X 4'-0" MIN

SUMP PUMP -

D.C. BACKFLOW PREVENTER

SUBMIT PLANS TO DEPARTMENT OF PUBLIC UTILITIES (DPU) SEALED AND SIGNED BY A PROFESSIONAL ENGINEER

ADAPTER FITTINGS, 1/4" S.A.E. 45° FLARE TUBE x 1/4" NPT, FOR CONNECTION TO TEST DEVICE. BACKFLOW

INSTALL PIPING AND BACKFLOW PREVENTER, INCLUDING BRASS MALE TEST COCK ADAPTERS — (4) STRAIGHT HOSE

APPROVED DPU PLANS FOR TYPICAL INSTALLATION DETAILS. NO TAP-IN WILL BE PERMITTED FOR ANY PURPOSE

ALL FIRE SYSTEM BACKFLOW PREVENTION REQUIREMENTS SHALL BE MET BEFORE THE DOMESTIC METER WILL BE

THAT BACKFLOW PREVENTION ASSEMBLY. ALSO THE SHUTOFF VALVES SHALL MEET FIRE CODE STANDARDS.

BACKFLOW PREVENTION ASSEMBLY AND EXTENT THE SIAMESE RISER THROUGH THE TOP OF THE VAULT

PREVENTION DEVICES WILL BE INSTALLED AT THE WATER SERVICE CONNECTION AFTER THE DETECTOR CHECK. REFER TO

THE BACKFLOW PREVENTION ASSEMBLY'S SHUTOFF VALVES SHALL BE THE ONES APPROVED BY THE MANUFACTURER FOR

AS AN OPTION, THE CONTRACTOR MAY INSTALL THE SIAMESE CONNECTION IN THE SAME VAULT AS THE DOUBLE CHECK

\* (A) OUTSIDE STEM AND YOKE GATE VALVE

\*(C) OUTSIDE STEM AND YOKE GATE VALVE (D) 2-1/2" THREADED N.S.T. SIAMESE

CONNECTION FOR FIRE DEPARTMENT

(I) SUMP WHERE WATER TABLE IS A PROBLEM <u>ELEVATION</u>

(B) DOUBLE CHECK VALVE ASSEMBLY

W/AUTOMATIC BALL DRIP (E) REQUIRED LINE SIZE x 4"

(H) JD-2AL 4'x4' BILCO DOOR

GRAVITY DRAIN IF NOT

POURED IN PLACE OR PRECAST

CONCRETE VAULT (SEE PART V

FOR LIST OF APPROVED

MANUFACTURERS)

- LINK SEAL

CLEARANCE

- EXTERIOR MASTIC OR

BITUMINOUS COATING

(F) 4" CHECK VALVE

(G) 4" - 90° BEND

ASSEMBLY ASSE-1015

TYPICAL INSTALLATION

DOUBLE CHECK BACKFLOW PREVENTION ASSEMBLY

LOW HAZARD FIRE SYSTEM WITH DETECTOR CHECK

NO SCALE


PROCEDURE FOR FIRE SYSTEMS

WHEN BACKFLOW PREVENTION IS REQUIRED

APPLY FOR A PLUMBING PERMIT FROM CITY OF RICHMOND, DEPARTMENT OF BUILDING INSPECTIONS.

BILCO DOOR OR EQUAL \

## 6" CHECK ASSEMBLY AND VAULT

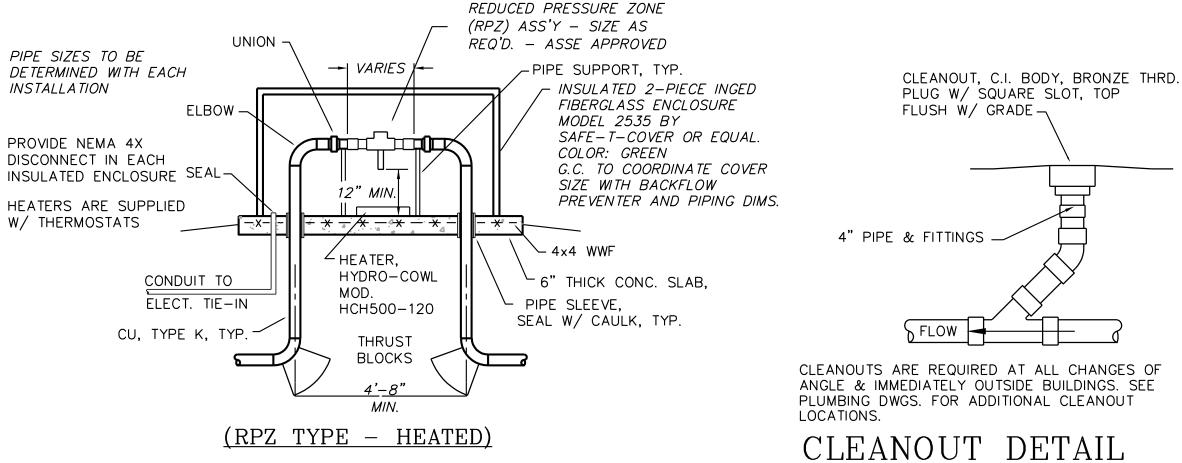

BACKFLOW PREVENTER INSTALLATION NOT TO SCALE

BY CITY - BY CONTRACTOR

COPPER LINES RUN FROM BACKFLOW

LOCATED AT ACCESS DOORS

ADEQUATE CLEARANCES

OF VALVES OR REPAIRS

REQUIRED FOR OPERATION

BETWEEN DETECTOR CHECK AND BACKFLOW DEVICE.

CALL BACKFLOW TECHNICIAN FOR INSPECTION OF BACKFLOW PREVENTER.

CALL INSPECTOR FOR INSPECTION FROM DETECTOR CHECK THROUGH THE INTERNAL

CONTRACTOR SHALL ARRANGE REQUIRED ELECTRICAL SERVICE FOR TAMPER SWITCHES

DETECTOR CHECK

FOR APPROVAL.

FIRE SYSTEM.

FLOW

ASSEMBLY TO TEST COCK BALL VALVES



REVISIONS:

DESIGNED

CHECKED

SCALE: 1" = 20"

PRELIMINARY

NO SCALE


CLEARANC

MIN.

DATE: 5-13-19

BY: BSH DRAWN BY: GAE

BY: BSH

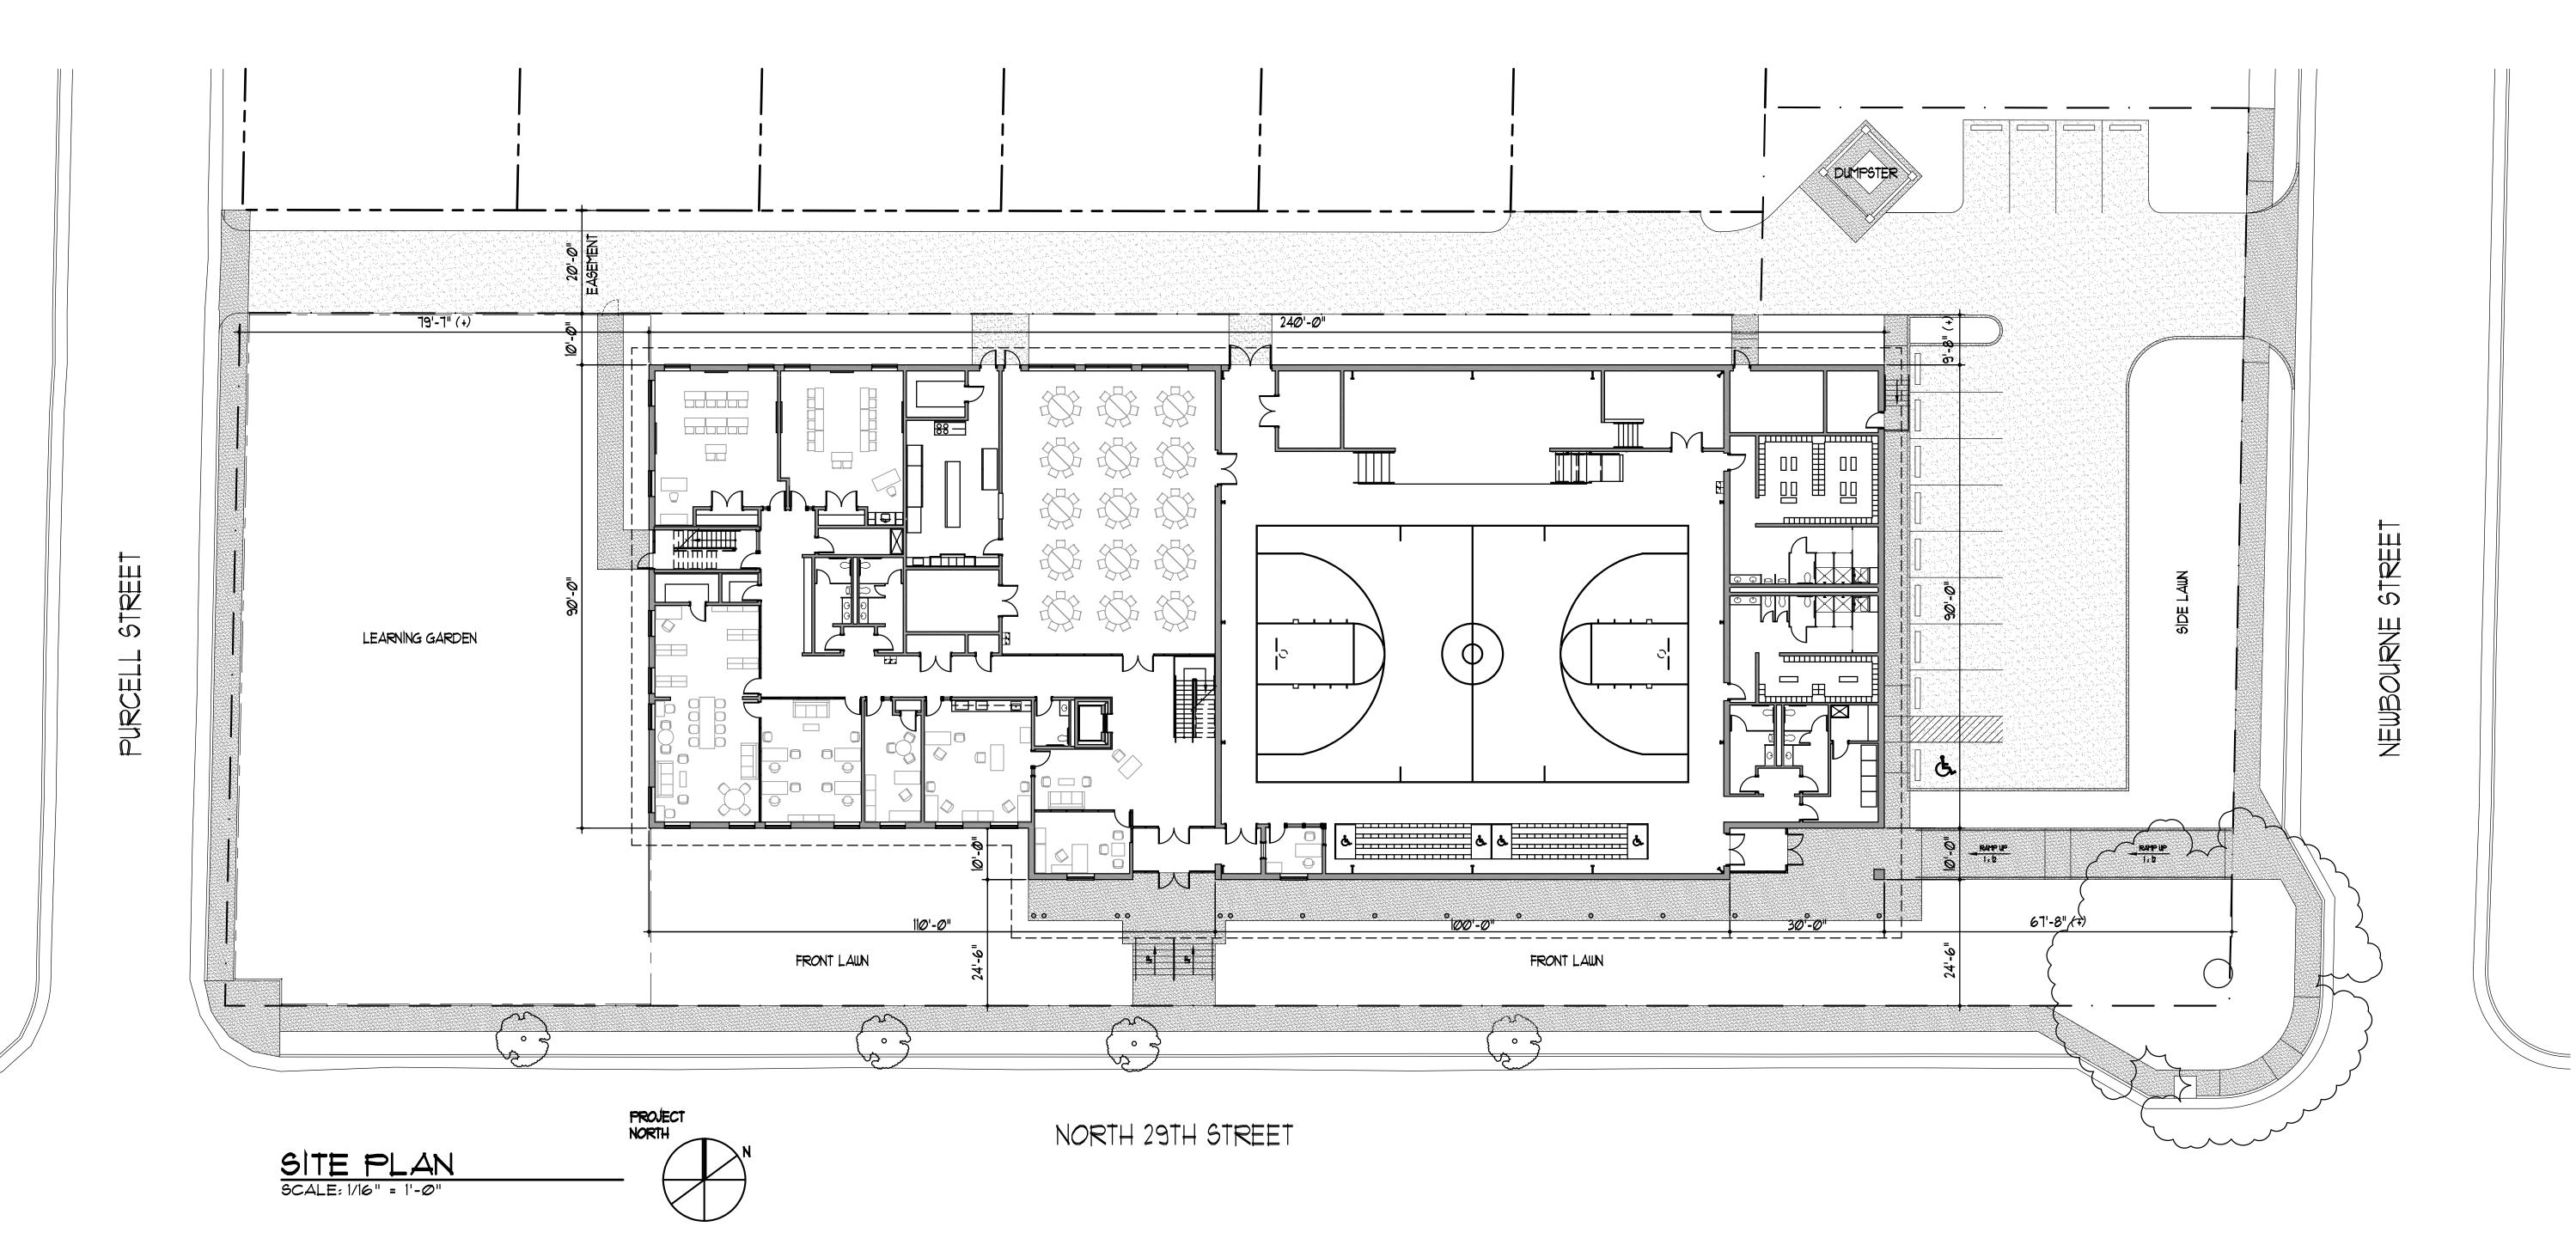

BOYNTON
ROTHSCHILD
ROWLAND
ARCHITECTSPC

The Ironfronts Suite 221 1011 East Main Street Richmond, Virginia 23219 [804] 643 ■ 1977 [804] 643 ■ 1981 [Fax]

Architecture Planning Interior Architectur

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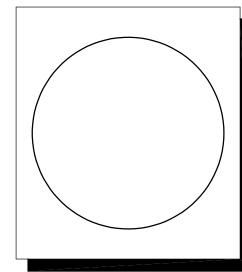
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BUILD WELL

1660 HUGUENOT ROAD
MIDLOTHIAN, VA 23113

PRELIMINARY



COMMISSION
SPECIAL USE PERMIT
PLANS

ANNA JULIA COOPER EPISCOPAL SCHOOL

NEW MIDDLE SCHOOL 2100 NORTH 29TH ST. RICHMOND, VIRGINIA 23223

PRELIMINARY:
ARCHITECTURAL
SITE PLAN

REVISIONS			
NO.	DESCRIPTION	DATE	


DATE SHT. NO.


MAY 13, 2019

COMM. NO.

1921

GRAPHIC SCALES

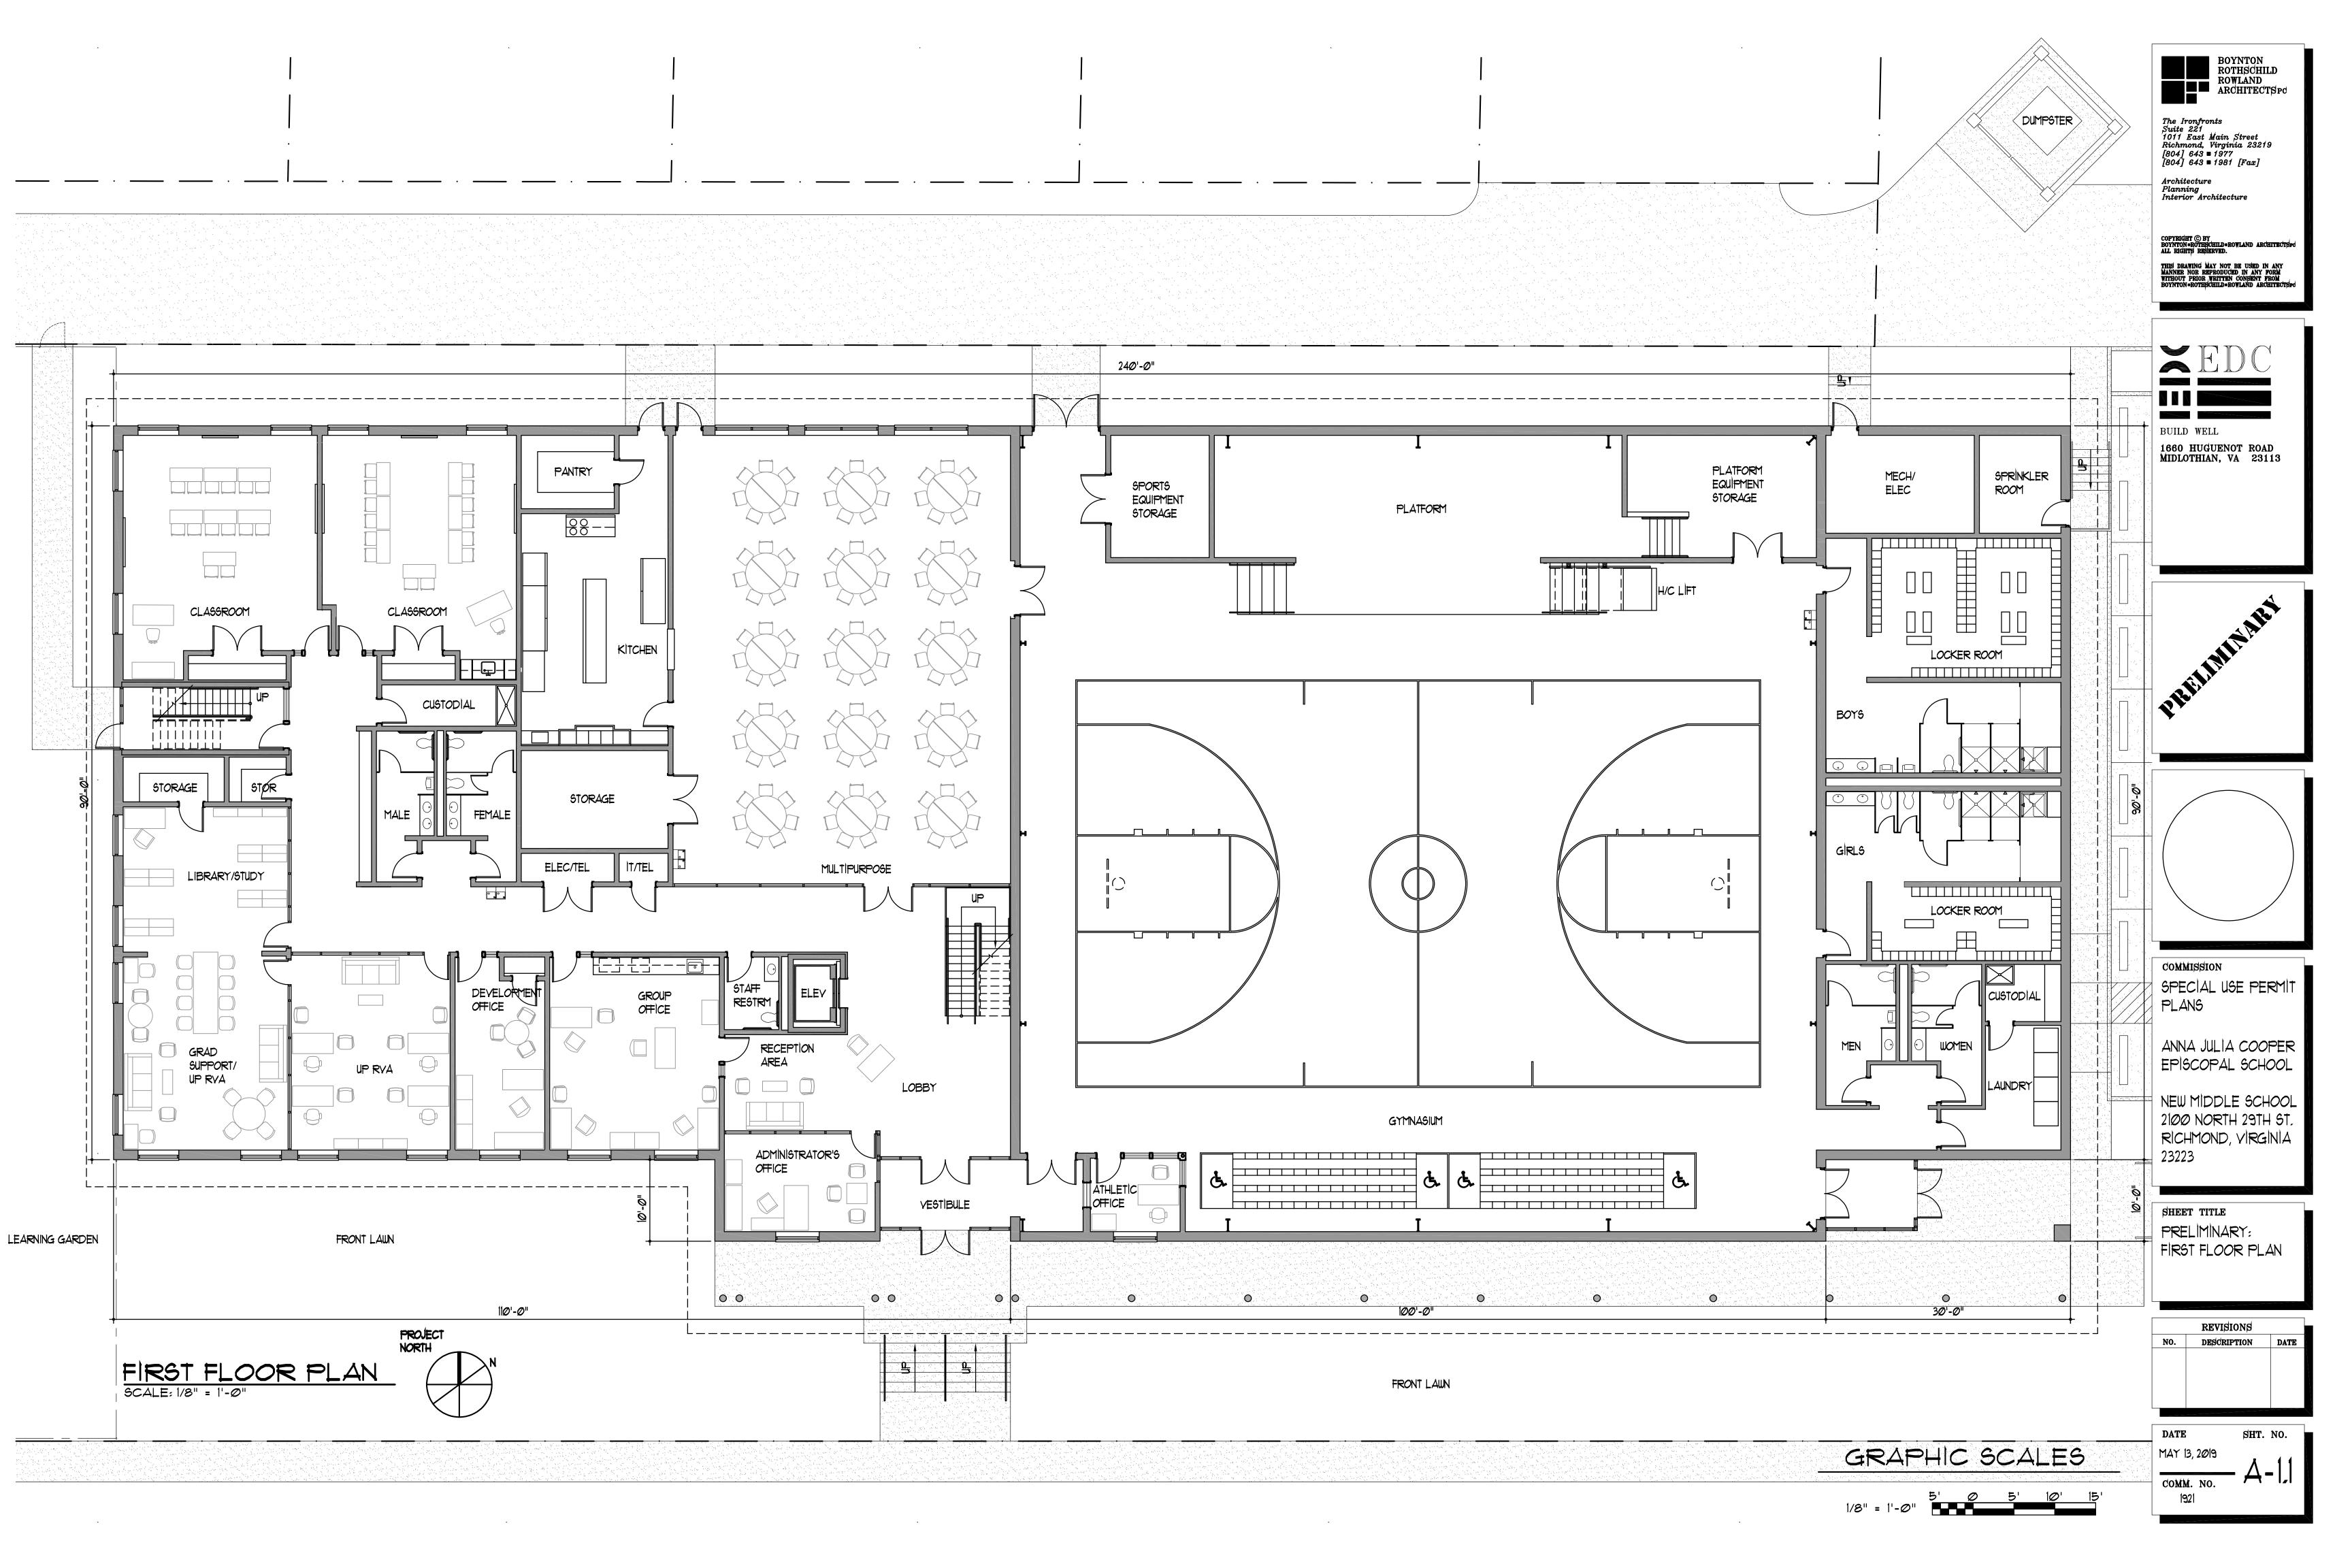

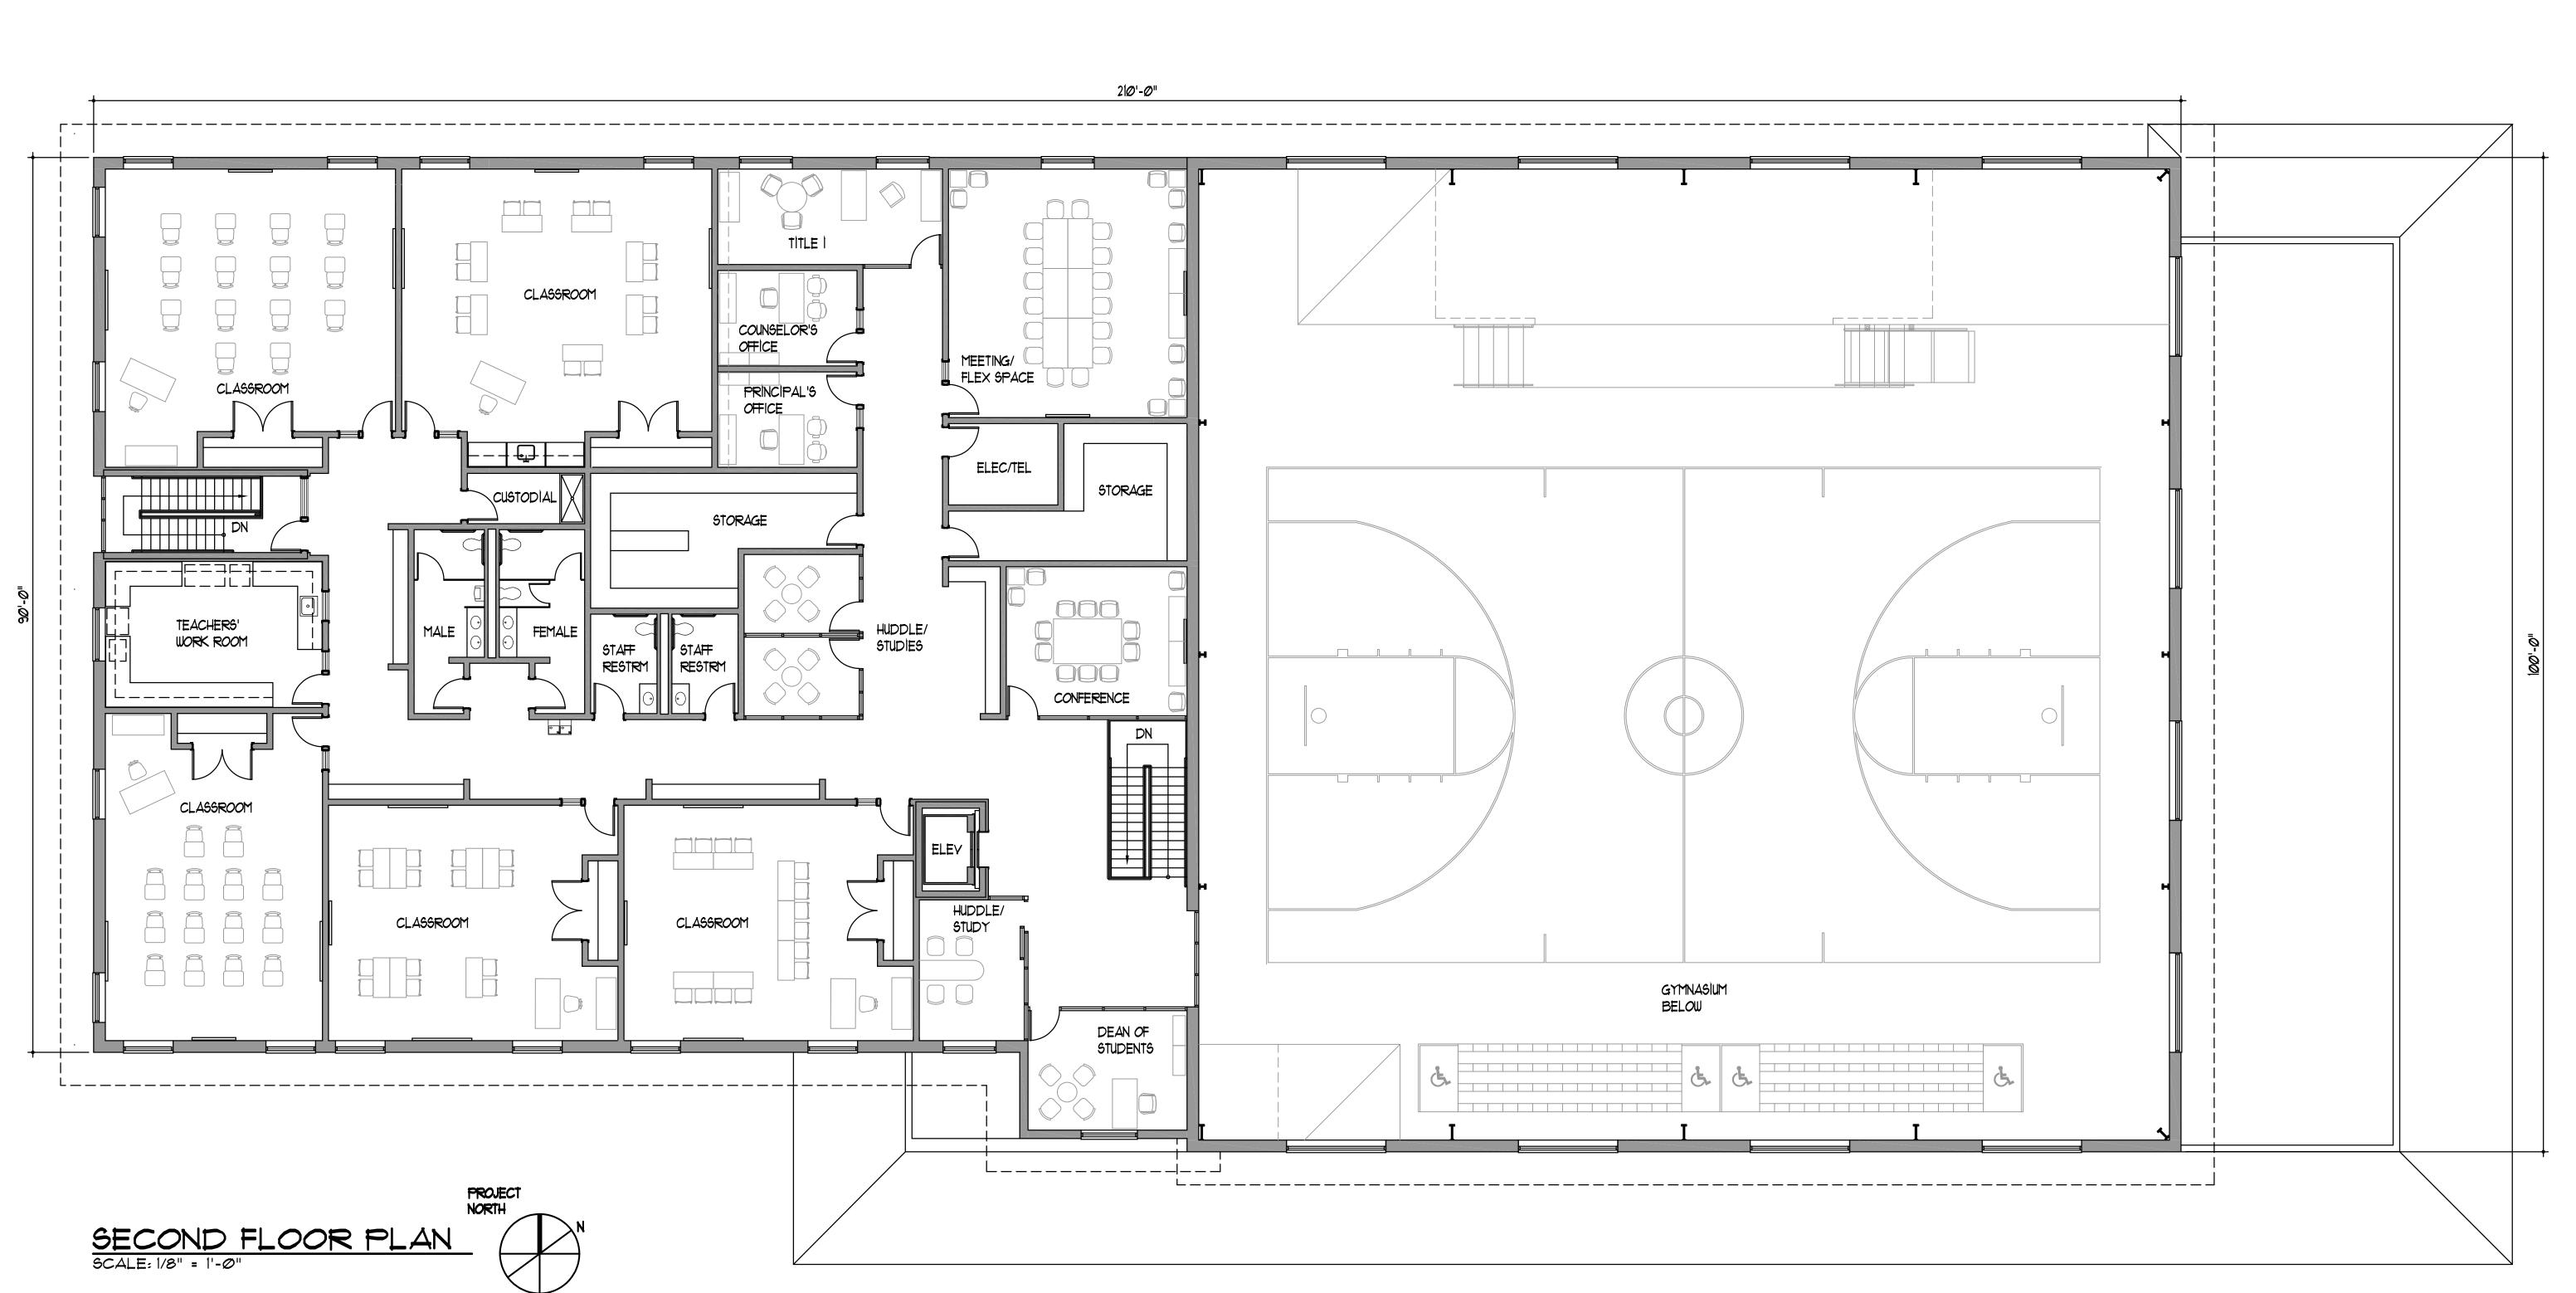


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ROWLAND
ARCHITECTSPC

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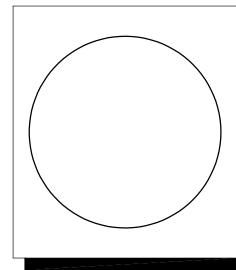
Architecture
Planning
Interior Architect

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PRELIMINATION



COMMISSION
SPECIAL USE PERMIT
PLANS

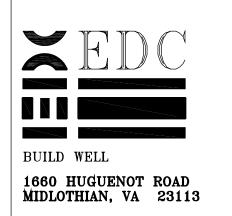ANNA JULIA COOPER EPISCOPAL SCHOOL

NEW MIDDLE SCHOOL 2100 NORTH 29TH ST. RICHMOND, VIRGINIA 23223

SHEET TITLE
SCHEMATIC:
SECOND FLOOR PLAN

REVISIONS			
NO.	DESCRIPTION	DATE	

DATE SHT. NO.

MAY 13, 2019

COMM. NO.

1921

GRAPHIC SCALES



SOUTH ELEVATION - SCHEMATIC

SCALE: 1/8" = 1'-0"



WEST ELEVATION - SCHEMATIC SCALE: 1/8" = 1'-0"

EXTERIOR BUILDING MATERIALS:

WALLS: BRICK TO MATCH EXISTING SCHOOL BRICK METAL PANELS ABOVE BRICK - LIGHT GREY

ROOF: 4 IN 12 SLOPED STANDING SEAM METAL - GREY

ENTRANCES: ALUMINUM STOREFRONT - WHITE

WINDOWS: VINYL COVERED WOOD - WHITE

FASCIA:

CEMENTITIOUS BOARDS - WHITE




EAST ELEVATION - SCHEMATIC SCALE: 1/8" = 1'-0"



NORTH ELEVATION - SCHEMATIC

SCALE: 1/8" = 1'-0"

GRAPHIC SCALES

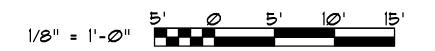




The Ironfronts
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1011 East Main Street
Richmond, Virginia 23219
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Architecture Planning Interior Architecture

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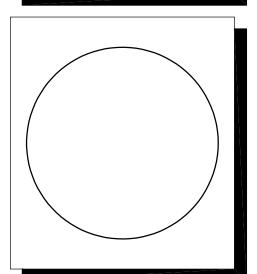
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BUILD WELL

1660 HUGUENOT ROAD
MIDLOTHIAN, VA 23113

PRIMINARY

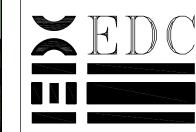

dommission

SPECIAL USE PERMIT PLANS

ANNA JULIA COOPER EPISCOPAL SCHOOL

NEW MIDDLE SCHOOL 2100 NORTH 29TH ST. RICHMOND, VIRGINIA 23223

SHEET TITLE
SCHEMATIC:
ELEVATIONS

REVISIONS			
NO.	DESCRIPTION	DATE	
	,		

DATE SHT. NO.

MAY 13, 2019

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1921










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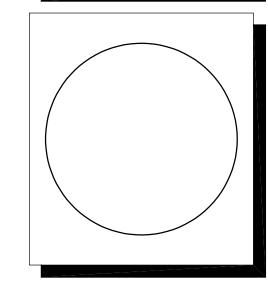
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BUILD WELL

1660 HUGUENOT ROAD
MIDLOTHIAN, VA 23113

PRIMINARY

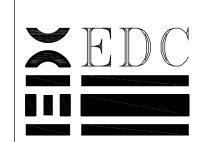

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SPECIAL USE PERMIT PLANS

ANNA JULIA COOPER EPISCOPAL SCHOOL

NEW MIDDLE SCHOOL 2100 NORTH 29TH ST. RICHMOND, VIRGINIA 23223

SHEET TITLE
SCHEMATIC:
ELEVATIONS

revisions				
DESCRIPTION	DATE			

ATE SHT AY 13, 2019

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