

SUBGRADE (COMPACTED @ 95%)

DETAIL

- 6x6 WWF REINFORCEMENT



## GE SF

 $\bigcirc$ 

<u>o</u>

7

AND DNA

SEDIMENT SITE IS NO

WITH THE VII.
TROL HANDBOOK.
THE 100 YEAR F

FLOOD

PLAIN

Z O T

S. EROSION AND SEDIMENT CONTROLS SHALL BE MAINTAINED UNTIL THE DISTURBED AREA IS STABILIZED.

3. PROPERTIES ADJOINING THE SITE SHALL BE KEPT CLEAN OF MUD OR SILT CARRIED FROM THE SITE BY VEHICULAR TRAFFIC OR RUNOFF.

7. THE DISPOSAL OF WASTE MATERIALS REMOVED FROM EROSION AND SEDIMENT CONTROL FACILITIES AND THE DISPOSAL OF THESE FACILITIES SHALL BE IN ACCORDANCE WITH THE VIRGINIA EROSION

井

5

4.

AND SHALL BE FEROSION AND SEEROSION AND SEEROSION THE RUNOFF FROM THE DRAINAGE FACILII

AND SEDIMENT CONTROLS SHALL B
IN ACCORDANCE WITH THE VIRGIN
AND SEDIMENT CONTROL HANDBOO
AND SEDIMENT CONTROL HANDBOO
LAND DISTURBING ACTIVITY.
AND SEDIMENT CONTROLS SHALL B
AND SEDIMENT CONTROLS SHALL B
FROM THE SITE WILL NOT ENTER SI
E FACILILTIES.

STORM

 $\mathbb{H}$ 

HANDBOOK OR AS THE

SHALL BE HE VIRGINIA

NOTE: REMOVE PLANTS FROM CONTAINERS PRIOR TO PLANTING

SCARIFY BOTTOM AND SIDES OF HOLE TO 4" DEPTH MIN.

3

WITH THE VICONTROL HEROSION AI

VIRGINIA EROSION HANDBOOK.

F Z Z

OF OFF THE
ACCORDANCE
D SEDIMENT

ROSION

AND

5

NO DISTURBED AREA SHALL REMAIFOR MORE THAN (7) DAYS.

EXCESS EXCAVATION DISPOSED OF SITE SHALL BE DISPOSED OF IN ACCOUNTY.


REMAIN DENUDED


CONTROL


GUIDELINES

SEDIMENT

ROSION

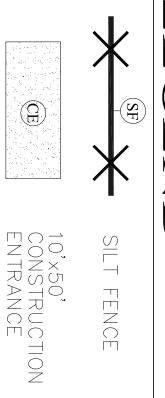

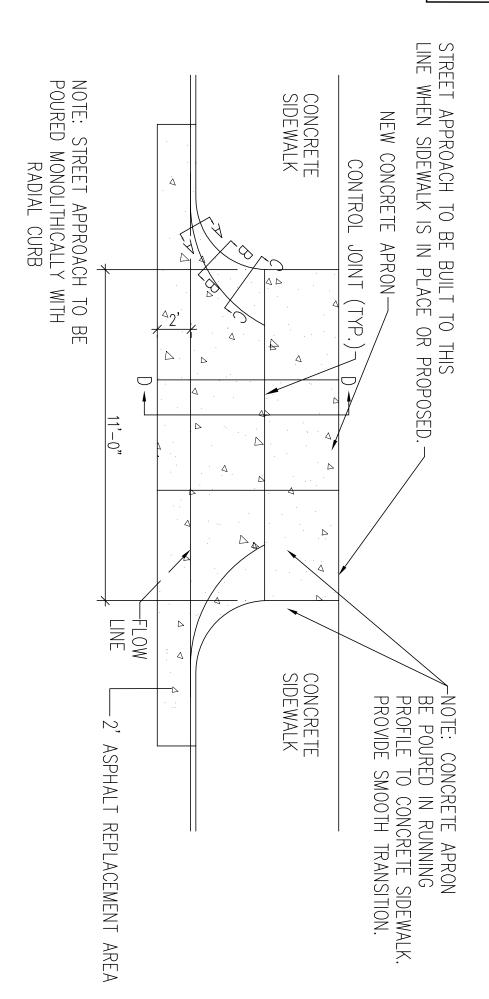


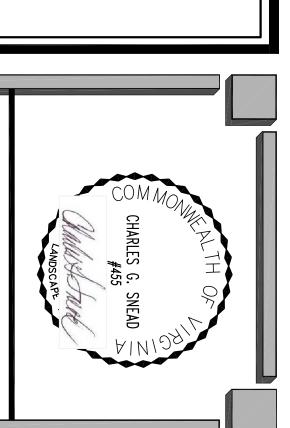

MAX. 3" WIDE GRANITE DUST JOINT.

-- 2" THICK, IRREGULAR
BLUESTONE FLAGSTONE
(AVE. SIZE, (1' X 2')

4" DEPTH GRANITE DUST BASE (FROM TIDEWATER QUARRIES)

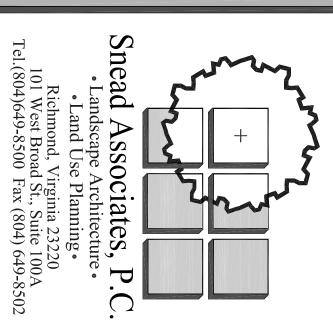

Site For Details

New Single Family GRACE PL **Detached Homes** ACE

-1/8" WIDE x 1/2" DEEP CONTROL JOINT (TYP.)
-6" #21A GRAVEL BASE (COMPACTED @ 95%)

-1/2" x 4" WHITE FOAM EXPANSION JOINT MATERIAL (20' o.c. MAX.)

UNDISTURBED SUBGRADE

LIGHT BROOM FINISH

1734-1738 N. 28th St. RICHMOND, VA 23223

_	 					
				No.		
				Description	Revisions:	
				Date		

Designed By:
Drawn By: Checked By:
Project Number: 06-13-14 1" = 10' C.G. Snead S.P C.G. Snead


Construction Details

Site Plan

Sheet Number: C2 of 3

ONCRETE

PRON DETAIL

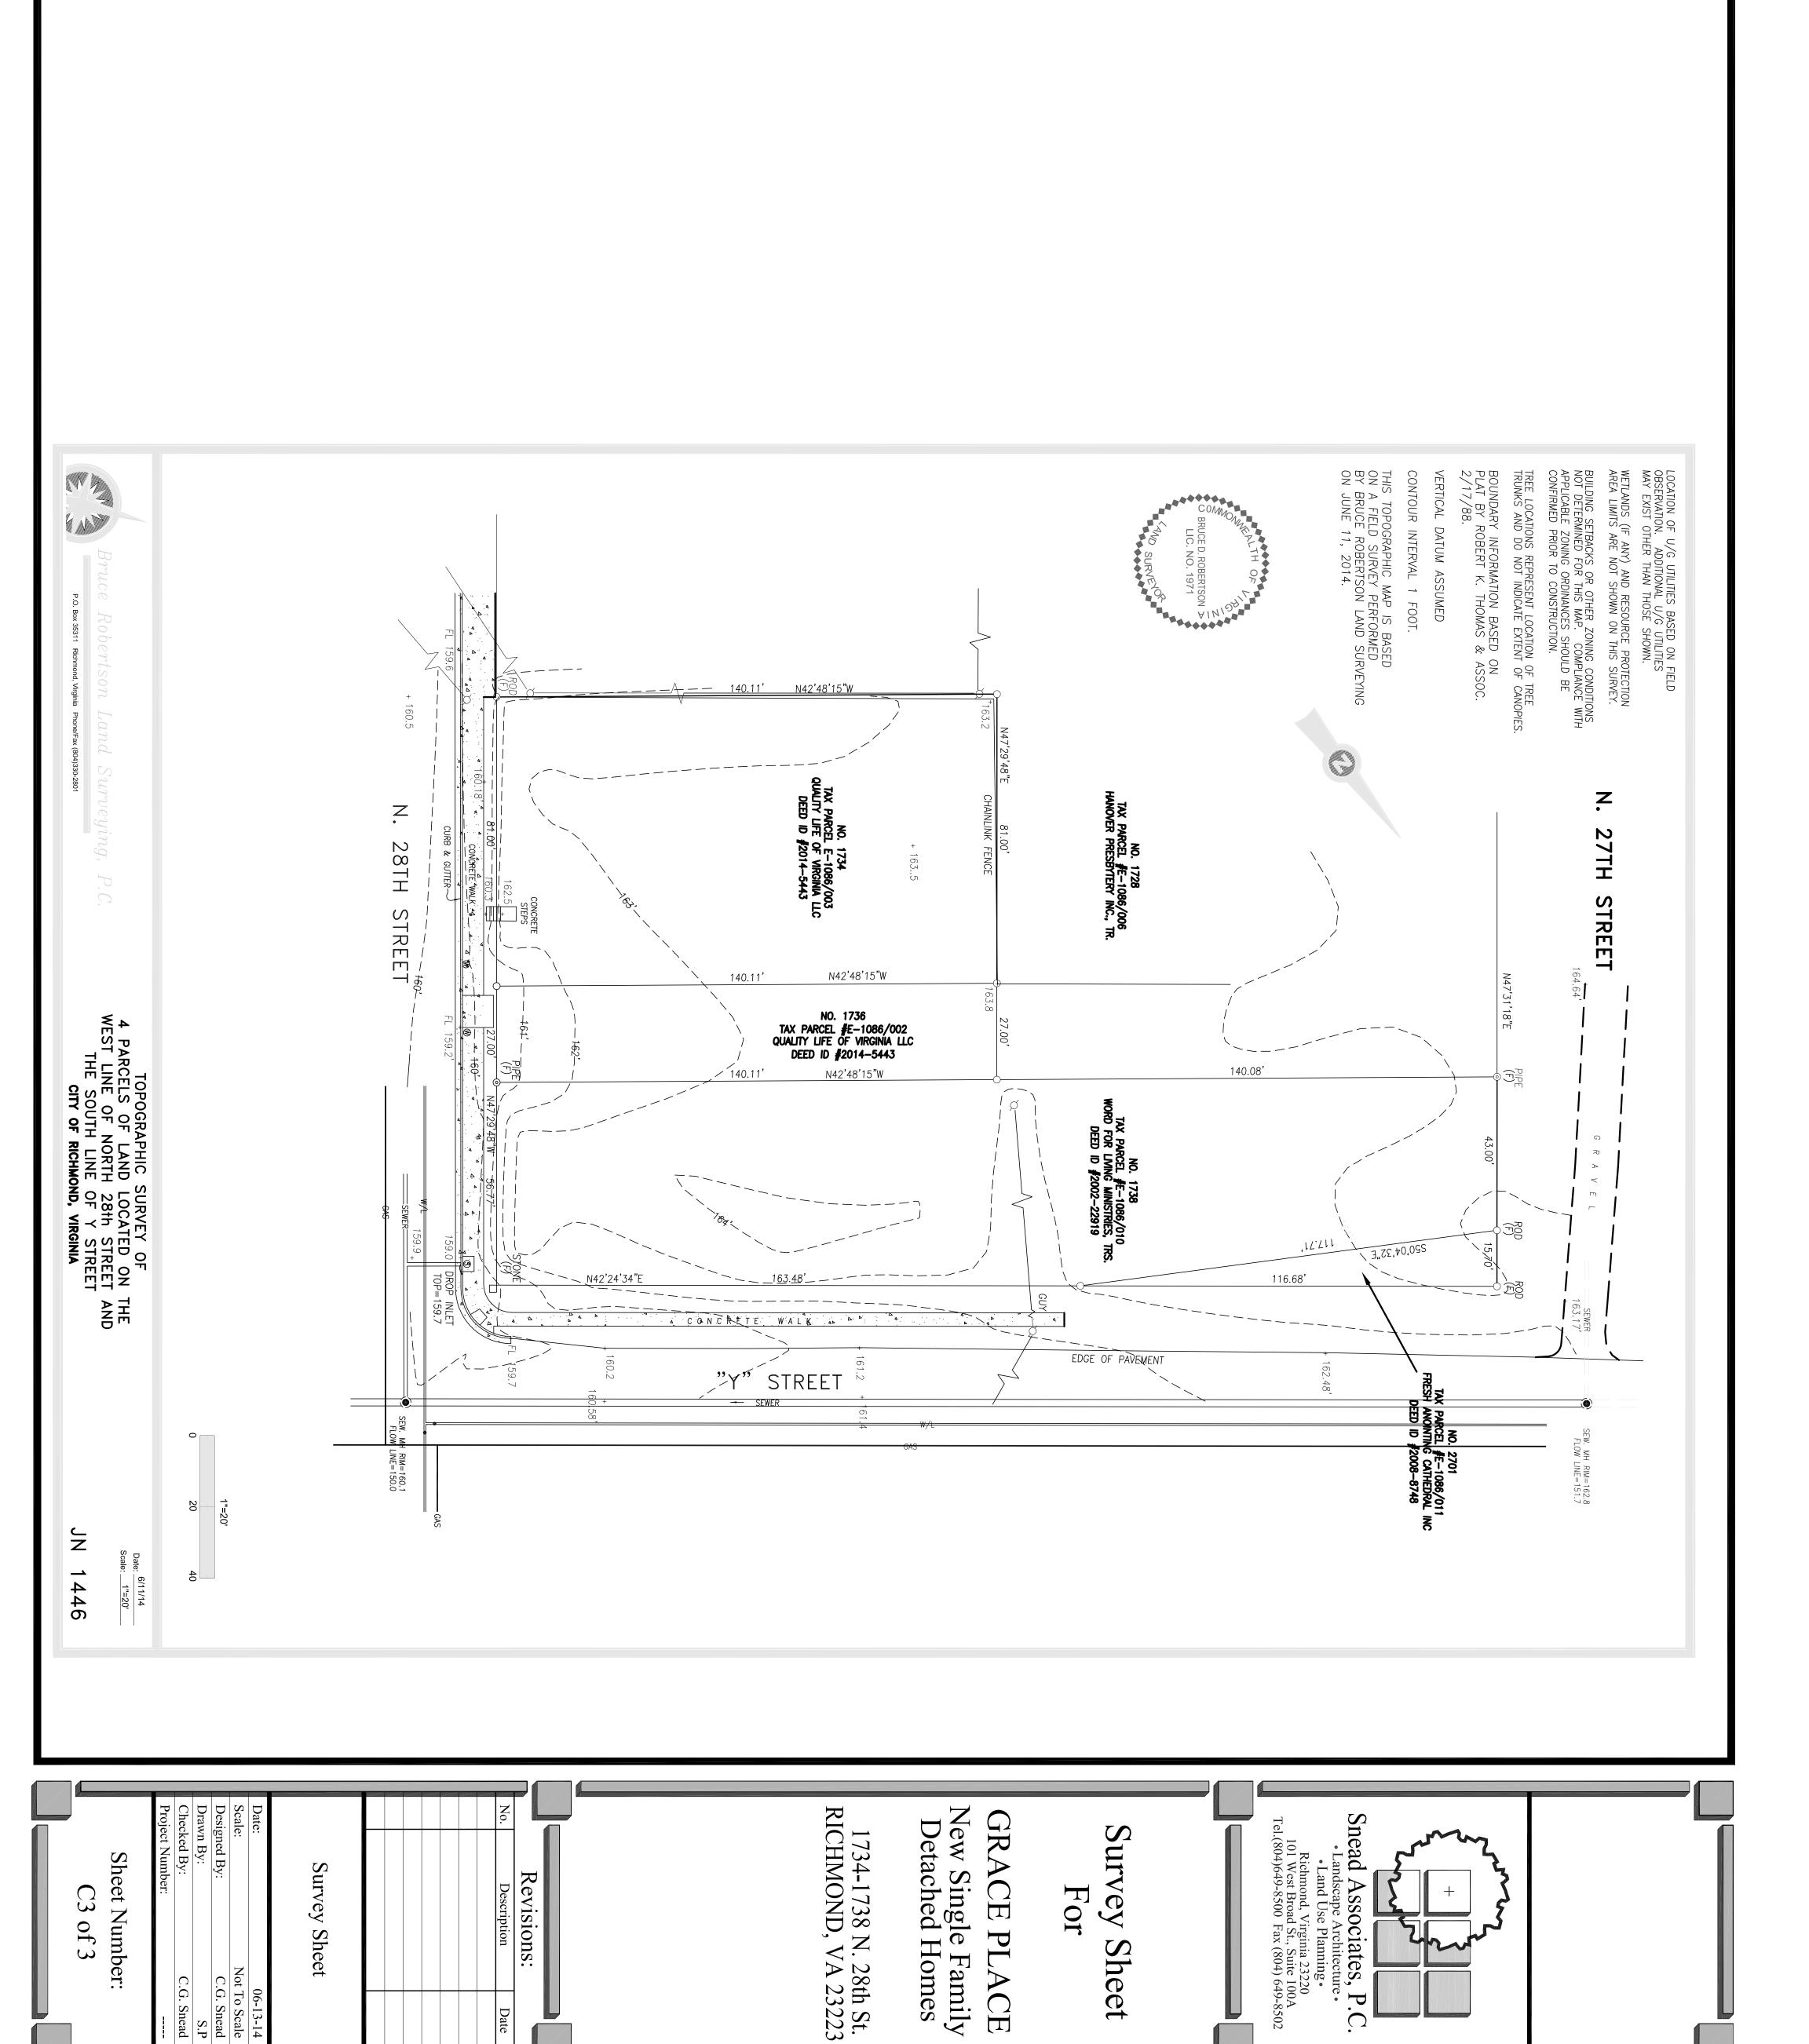

06-13-14
Not To Scale
C.G. Snead
S.P
C.G. Snead

- USE GROUP RE
- 2 CONTRACTOR SHALL CONFORM TO THE 2009 VIRGINIA UNIFORM STATEWIDE BUILDING CODE / 2009 I.R.C. AND ALL LOCAL ORDINANCES
- 'n CONTRACTOR SHALL VERIFY ALL DIMENSIONS AND SITE CONDITIONS BEFORE STARTING CONSTRUCTION.
- 4. DIMENSIONS ARE TO THE FACE OF STUD (3 1/2" ALL DIMENSIONS SHOWN ARE ACTUAL, AND ARE TO THE FACE OF IN FIELD. EXTERIOR FRAMING WALL). DIMENSIONS ARE TO THE EXTERIOR FACE OF 1/2" SHEATHING (4" WALL); INTERIOR FRAMING FACE OF EXTERIOR SHEATHING TO ALIGN WITH FACE OF MASONRY BELOW. STUDS OR MASONRY OR EXTERIOR SHEATHING, CONTRACTOR TO COORDINATE
- ū CONTRACTOR SHALL CAULK, FLASH, OR OTHERWISE MAKE THE BUILDING WEATHERTIGHT. CONTRACTOR SHALL CAULK ALL GAPS BETWEEN U SSIMILAR
- 6 ALL WOOD JOISTS WITHIN 18" OR WOOD GIRDERS WITHIN 12" OF EXPOSED EARTH SHALL BE PRESSURE PRESERVATIVE TREATED
- 7 32" HANDRAILS AND 36" GUARDRAILS TO HAVE PICKETS AT 6" O.C. AND POSTS AT 60" O.C. MAX. GUARDRAILS ARE REQUIRED ON ALL PORCHES, DECKS, STAIRS, ETC. ΣĦΗ 30" OR MORE ELEVATION DIFFERENCE
- 8. ALL HOSE BIBBS SHALL BE FREEZEPROOF AND HAVE A VACUUM BREAKER
- ٩. EXTERIOR REQUIRED STAIRS ARE SHOWN FOR LOCATION ONLY. CONTRACTOR SHALL VERIFY ALL GRADE ELEVATIONS AND ACTUAL NUMBER OF STAIRS
- 0 (3) 2X4'S WITH MID-HEIGHT BLOCKING ARE REQUIRED WHERE NOTED AS "TRIPLE STUD SUPPORT" ON DRAWINGS
- RUN ALL TOILET FANS AND EXHAUST VENTS TO AN OWNER APPROVED EXTERIOR DISCHARGE.
- 12 PROVIDE 75 % SOLD CMU OR GROUT FILLED TOP COURSE AT ALL HOLLOW CUM PIERS
- Ü 6" MIN. REQUIRED BETWEEN FINISH GRADE AND BOTTOM OF SIDING AT CONC. SLABS AND 16" AT CRAWL SPACE
- SILL PLATE ANCHORAGE 1/2" DIAMETER ANCHOR BOLTS AT 6'-0" O.C. MAXIMUM AT ALL EXTERIOR WALLS AND INTERIOR BEARING WALLS MAX. FROM CORNERS. (8" LONG INTO CONCRETE, 18" LONG INTO MASONRY.) CODE APPROVED STRAP ANCHORS MAY BE USED AT THE AND <u>~</u>
- <u>ज</u> ALL GLAZING WITHIN 18" OF FLOOR OR 48" OF DOORS SHALL BE TEMPERED GLASS OR SAFETY GLAZED.

CONTRACTOR'S OPTION.

- <u>e</u> ENGINEER SEALED AND SIGNED SHOP DRAWINGS ARE REQUIRED FOR PRE-ENGINEERED WOOD FLOOR AND ROOF TRUSSES
- PROVIDE FIRESTOPPING AND DRAFTSTOPPING AS REQUIRED
- 8. ALL UNEXPOSED CONCRETE SHALL BE 3,000 PSI MIN. STRENGTH, ALL EXPOSED CONCRETE SHALL BE 3,500 PSI STRENGTH WITH 5 AIR ENTRAI NMENT.
- BENDING STRESS OF 1,000 PSI MIN. FOR REPETITIVE ALL STRUCTURAL LUMBER (I.E. JOISTS, RAFTERS, HEADERS, ETC.) MEMBERS SHALL HAVE A MODULUS OF ELASTICITY OF 1,400,000 고 본 AND EXTRE 1E FIBER
- SHALL BE CONSTRUCTED OF 2X4 STUDS (STUD GRADE S-P-F SD S45 MIN.) AT 16" O.C. (U.N.O.)
- SHELVING AND SHELF RODS TO BE BRACED AT 4'-0" O.C. MAXIMUM.

JUI\Grace Place\1-GENERAL.dwg

- 22. VERIFY FRAMING/CONSTRUCTION DIMENSIONS PRIOR TO INSTALLATION 읶 CABINETS. TUB, HVAC EQUIPMENT AND OTHER BUILT-IN FIXTURES <del>2</del>
- INSULATE ALL PIPING IN EXTERIOR WALLS AND CRAWL SPACE
- 24. PROVIDE RECESSED BOX WITH VALVE TO AREA OF REFRIGERATOR FOR ICEMAKER.
- 25. ALL ELECTRICAL AND MECHANICAL LAYOUTS ARE CONCEPT ONLY. CONTRACTOR AND OR SUBCONTRACTOR SHALL VERIFY AND ABIDE BY LOCAL CODES

)	HOWERS
)	S AND -
	TUBS .
	TO HAVE
) ) -	A WATE
	HOWERS AND TUBS TO HAVE A WATER RESISTANT RECESSED LIGHT ABOV.
) - ) =	TANT RE
	CESSED
	LHUL
	ABOVE

.ICE AND SNOW SHIELD WILL BE USED ON THE FIRST 3'-0" OF ROOF

AND GUIDELINES

BEFORE STARTING

- GUTTER AND DOWNSPOUTS ON STRUCTURE AND PORCH (PRE-FINISHED ALUMINUM)
- 29. VINYL SOFFITS @ ALL PORCH CEILINGS

	il I	ſi	
•			₩ T
1 000			XAM
į			ING
5			$\equiv$
			UEX

A2.0	AI.I	AI.0
ELEVATIONS	ENLARGE FLOOR PLAN	FLOOR PLANS

SQUARE FOOTAGE

(FINISHED) FIRST FLOOR SF.	700 SF.
(FINISHED) SECOND FLOOR SF.	700 SF.
TOTAL FINISHED SF.	1,400 SF.

06-May-14 ssue Date: Plot Date: 19-Jun-14

The Zoe

SHEET NUMBER

SOLID BEARING (FI

(FIELD VERIFY) 2,000 LBS/SQ

<u>DEAD FLOOR (ALL)</u> LIVE ROOF (SNOW)

Foundation	×	Crwl Space		Slab	┪	Ва	Basement	1	Walk out		
Basement Options	$\prod$	Poured walls	Ш	CMU	7 1	₫廿	Unfinished	П	Finished		
Basement Baths		Half Bath		Full		뒣	Details:				
		1,400	SF								
Renderings		Interior		Plans	×		Elevation(s)				
Number of Stories		One Story	$ \times $	2 Story	$\Box$	ω (a)	3 Story		4 Story		
Number of Bedrooms	ω				H						
Number of Baths	2.5										
Master Bedroom	П	1st Floor	×	2nd Floor	$\dagger \dagger$	++					
Master Bath	×	Tub & Shr		Shr only	$\Box$	Ď	Double Van		Other		
Kitchen	П	Morning Rm.		Island	×	—	Breakfast Area		Other		
In-law Suite	П	1st Floor	Ш	2nd Floor	$\sqcap$	g	Other	×	None		
In-law Bath	П	Tub & Shr		Shr only	П	Ď	Double Van	×	None		
Hall Bath		Tub & Shr		Shr only		뒣	Double Van		Other		
Garage Attached		1 Car		2 Car	$\Box$	ω 0	Car		4 Car	×	None
Garage Detached		1 Car	Ш	2 Car	П	3	Car		4 Car	×	None
Ceiling Height 1st FL.	П	8' Tall	$ \times $	9' Tall	$\Box$		10' Tall		Other		
Ceiling Height 2nd FL	×	8' Tall	$\Pi$	9' Tall	$\sqcap$	10	10' Tall	П	Other		
Laundry Room	×	1st Floor		2nd	$\Box$	Ва	Basement		Mudroom		Garage
Fire Place		Wood Burn		Gas	×		None				
Fire Place Location	П	Family Room		Dine	$\sqcap$	<u> </u>	Living Room		Other		
Front Exterior Mat.	×	Siding		Brick	$\sqcap$	<u>S</u>	Stone		Dryvit		Other
Right Side Ext. Mat	×	Siding		Brick	$\Box$	St	Stone		Dryvit		Other
Left Side Ext. Mat	×	Siding		Brick	$\sqcap$	St	Stone		Dryvit		Other
Rear Exterior Mat	×	Siding		Brick	$\Box$	St	Stone		Dryvit		Other
Door Heights 1st FL.	×	6'-8"	Ш	7'-0"	$\sqcap$	8'-0"	0"	П	Other		
Door Heights 2nd FL.	×	6'-8"	Ш	7'-0"	Ħ	8'-0"	0"		Other		
Hot Water Heater	×	Boiler Tank	Ш	Thankless	$\dagger \dagger$	++					
Outside Living Space		Deck		Patio		Sc	Screened Porch		Stoop		

## Floor Finishes

**Plan Details** 

## Plan Type: Floor


i i talanta	Taminata	17:m1	Camara, Tila	Campat
VIICIEII	Lailliate	<b>У</b> ШУ1	Ceranne i ne	Calpet
Pantry	Laminate	Viny1	Ceramic Tile	Carpet
Great Room	Laminate	Viny1	Ceramic Tile	Carpet
J	χ	V 72 1	) HH:	2
S ming a soon	E) CHILLIAN C	,) .	Commission of the	Cur p or
Foyer	Laminate	Viny1	Ceramic Tile	Carpet
Hall Bath	Laminate	Viny1	Ceramic Tile	Carpet
Stairs	Laminate	Viny1	Ceramic Tile	Carpet
Junior Suite	Laminate	Vinyl	Ceramic Tile	Carpet
Junior Suite Closet	I aminate	Vinv1	Ceramic Tile	Camet
Other	Laminate	Viny1	Ceramic Tile	Carpet
Master Bedroom	Laminate	Viny1	Ceramic Tile	Carpet
Master Bath	Laminate	Viny1	Ceramic Tile	Carpet
Master Closet	Laminate	Viny1	Ceramic Tile	Carpet
				Σ.
Laundry Koom	Laminate	Vinyl	Ceramic Lile	Carpet
Bedroom #2	Laminate	Viny1	Ceramic Tile	Carpet
Hall Bath #2	Laminate	Viny1	Ceramic Tile	Carpet
Bedroom #3	Laminate	Vinyl	Ceramic Tile	Carpet
Hall	Laminate	Vinvl	Ceramic Tile	Carpet



The Zoe


SHEET NUMBER


TO

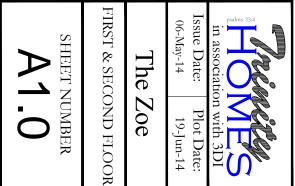

SECOND FLOOR PLAN

SCALE: 1/8" =1'-0"

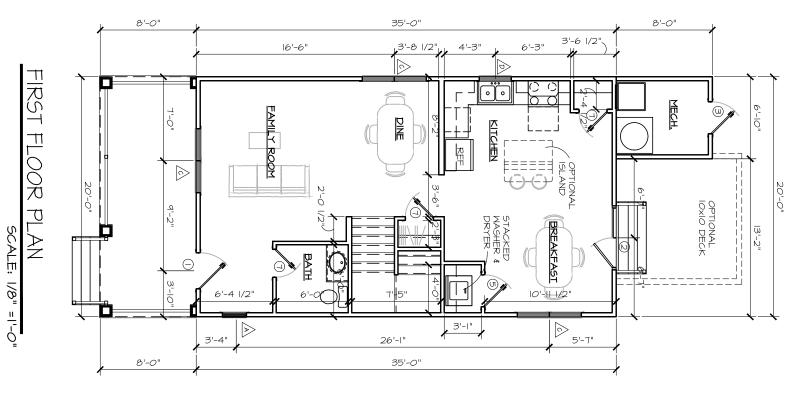

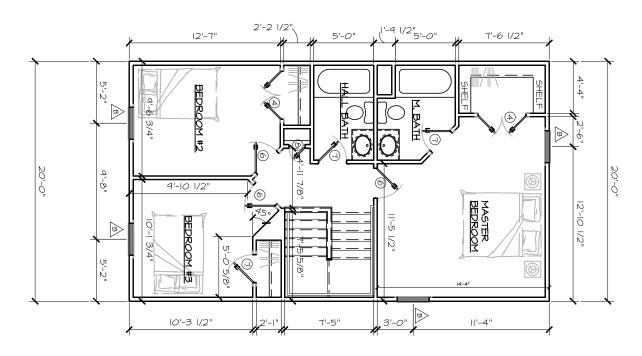


 	Ņ	NOTE:		œ	7	0	ſΠ	4	w	N	_	
EXTERIOR M	=RAMER SHALL F AND FRAMING FO HANDRAILS, MED TISSUE HOLDERS TROUBLE DOORS	E: VENDERS A		1/4×6/8	2/4×6/8	2/6×6/8	2/6×6/8	2/0×6/8	2/8×6/8	5/0×6/8	3/0x6/8	DO
INTERIOR WALLS SHOWN AT 3 I/2" EXTERIOR WALLS SHOWN AT 4"	FRAMER SHALL PROVIDE BLOCKING AND FRAMING FOR ALL CABINETS, HANDRAILS, MEDICINE CABINETS, TISSUE HOLDERS AND ACCESS	E: ALL CONTRACTORS, SUBS, AND VENDERS ARE TO STATE ALL DIMENSIONS PRIOR TO CONSTRUCTIONS		INTERIOR	INTERIOR	INTERIOR	DOUBLE DOOR INTERIOR	DOUBLE DOOR INTERIOR	EXTERIOR	FRENCH DOOR	EXTERIOR W/ SIDE LITES	DOOR TYPE LEGEND

2/8x5/2 D/H TILT TWIN 2/8x3/2 D/H TILT


WINDOW TYPE LEGEND

2/0x\_ OVAL FIXED (optional)

2/8x5/2 D/H TILT

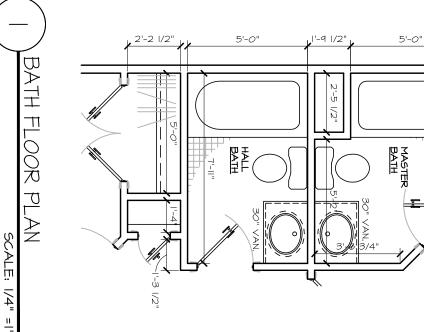



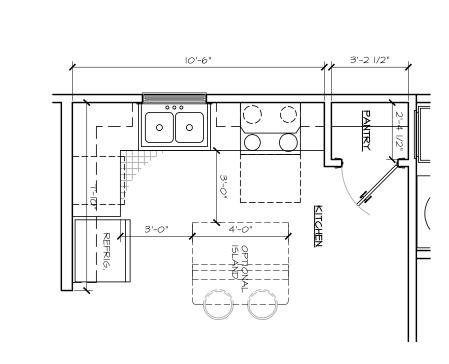

 $\mathcal{U}$ 

STANDARD LAUNDRY ROOM

SCALE: 1/4" =1'-0"


4-0=

3'-1"

KITCHEN FLOOR PLAN SCALE: 1/4" =1'-0"


OPT. LAUNDRY ROOM

SCALE: 1/4" =1'-0"

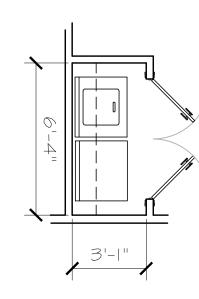

ENLARGED FLOOR PLAN Issue Date: 06-May-14 SHEET NUMBER

1.1 The Zoe Plot Date: 19-Jun-14

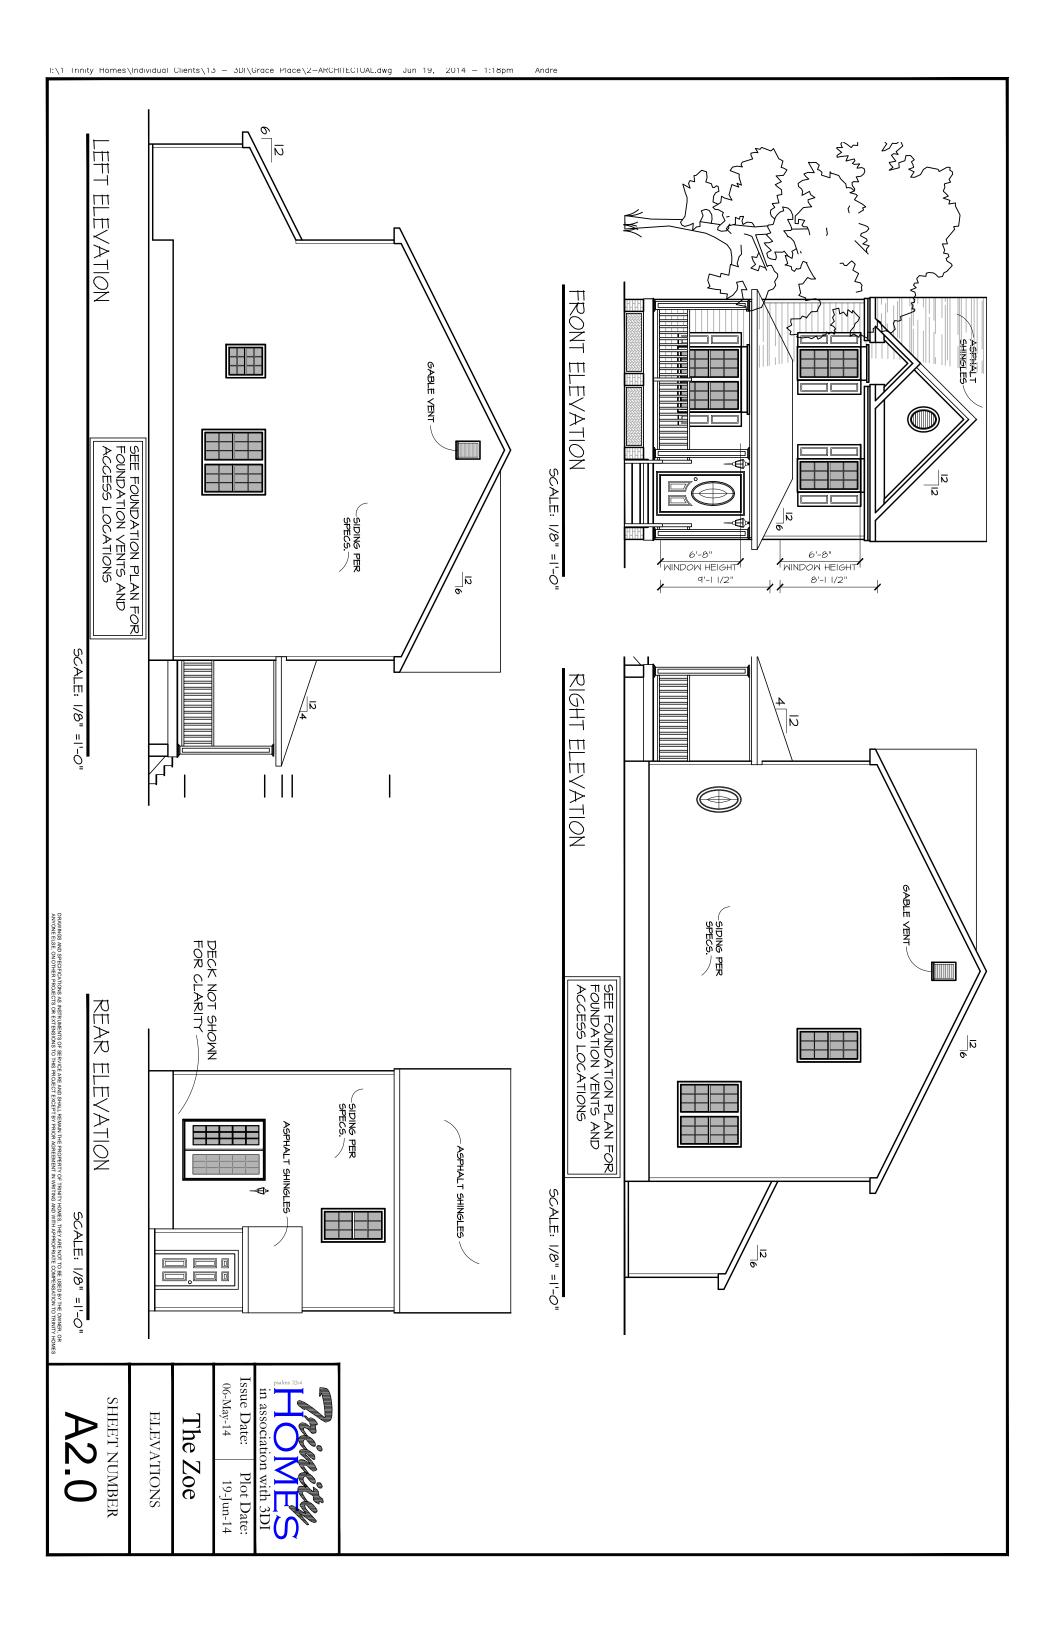

WALL LEGEND NON-BEARING WALL BEARING WALL - 2x\_ JOIST

· - BEAM / HEADER = ROOF TRUSS

FRAMING NOTES:

I. ALL HEADERS UNDER 5'-0" TO BE (2) 2X8 W DOUBLE JACKS UN.O.

ALL HEADERS OVER 5'-0" TO BE (2) 2XIO W DOUBLE JACKS U.N.O.

FRAMER SHALL PROVIDE BLOCKING AND FRAMING FOR ALL CABINETS, HANDRAILS, MEDICINE CABINETS AND ACCESS TROUBLE DOORS

TRUSS LAYOUT BY TRUSS MANUFACTURE TO SUPERCEDE THESE DRAWINGS.

I. BAND TO BE PRESSURE TREATED AT STOOP DECKS AND PORCHES CRAML SPACE DOOR MUST BE 36" WIDE AND A MIN. OF 30" HIGH WITH P.T. ROUGH OPENING HINGED & BOLTED

COORDINATE FLOOR JOIST LAYOUT WITH PLUMBING FIXTURE LOCATION

4. BACKFILL AS REQUIRED TERMITE TREAT GROUND COVER WITH 6 MILL POLY

Issue Date:


06-May-14 Plot Date:

19-Jun-14

The Zoe

STRUCTURAL PLAN

SHEET NUMBER

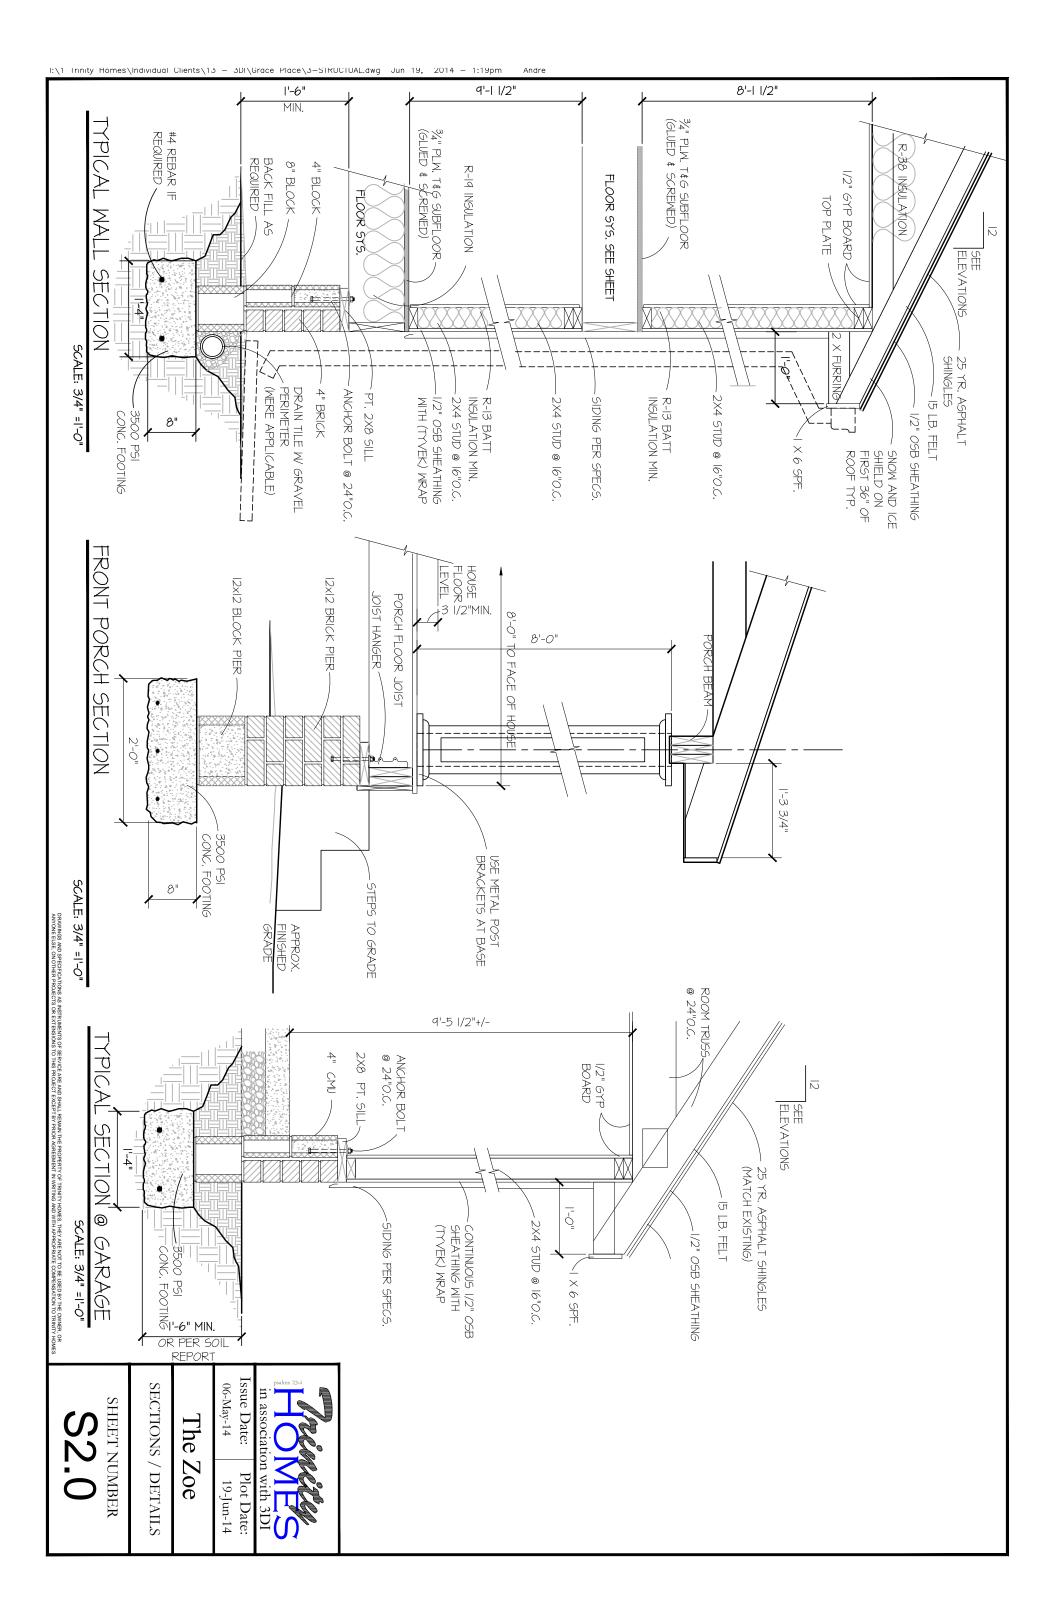

··· / o.

SIMPSON MSTAIS HOLD DOWN

(2)STUDS @ CORNER

WALL SHEATHING

BOTTOM PLATE

FLOOR SHEATHING

9'-1 1/2"

4'-6"

SHEET NUMBER

SECTIONS / DETAILS

The Zoe

[ssue Date:

Plot Date:

02-Jul-14

in association with 3DI

06-May-14