

Application for SPECIAL USE PERMIT

Department of Planning and Development Review Land Use Administration Division 900 E. Broad Street, Room 511 Richmond, Virginia 23219 (804) 646-6304 http://www.richmondgov.com/

Application is hereby submitted for: (check one) ✓ special use permit, new ✓ special use permit, plan amendment ✓ special use permit, text only amendment			
Project Name/Location			
Property Address: 1105 Apperson St. Richmond, VA 23231		Date: 7/1/23	
Tax Map #: <u>E0002176003</u> Fee: \$300			
Total area of affected site in acres: <u>.062</u>			
(See <i>page 6</i> for fee schedule, please make check payable to the "City o	f Richmond")		
Zoning Current Zoning: R-5 Residential (Single Family)			
Existing Use: unimproved lot			
Proposed Use (Please include a detailed description of the proposed use in the required applicant's report) We would like to build the attached home plan on this lot.			
Existing Use: unimproved lot			
Is this property subject to any previous land use cases? Yes No If Yes, please list the Ordinance Number:			
Applicant/Contact Person: Scott Dearnley			
Company: NSD Investments LLC			
Mailing Address: 2518 Founders Bridge Rd			
City: Midlothian	State: VA	Zip Code: 23113	
Telephone: _(<u>804</u>) <u>938-5277</u>	Fax: _()_		
Email: scott.dearnley@joynerfineproperties.com			
Property Owner: NSD Investments LLC			
If Business Entity, name and title of authorized signee: Scott	Dearnley		
(The person or persons executing or attesting the execution of this Applic she has or have been duly authorized and empowered to so execute or at	eation on behalf of the test.)	Company certifies that he or	
Mailing Address: 2518 Founders Bridge Rd			
City: Midlothian	State: VA	Zip Code: 23113	
Telephone: _(804)938-5277	Fax: _()		
Email: scott.dearnley@joynerfineproperties.com			
Property Owner Signature: Swa Deamley	Nary	y. Dearnley	

The names, addresses, telephone numbers and signatures of all owners of the property are required. Please attach additional sheets as needed. If a legal representative signs for a property owner, please attach an executed power of attorney. **Faxed or photocopied signatures will not be accepted.**

NOTE: Please attach the required plans, checklist, and a check for the application fee (see Filing Procedures for special use permits)

Applicant's Report

I am submitting this request for a special use permit to build a single-family home on a lot that I own at 1105 Apperson St. Richmond, VA 23231. The lot currently does not have enough square feet to qualify as a buildable lot. There are lots of these narrow homes in the City of Richmond that have 5 foot side setbacks so this home would be similar to those.

In my opinion, one additional home would not be detrimental to the safety, health, morals and general welfare of the community, would not create additional congestion, would not create fire or other hazards, would not cause overcrowding or an undue concentration of population, would not adversely affect the school system and other public services, and would not interfere with adequate light and air.

I feel that a new home on this lot would be a positive for the City and the area. It would provide much needed housing in a real estate climate that has very little inventory and it would provide additional tax revenue for the City.

I appreciate your consideration of my application. If you have any questions or concerns, please contact me at 804-938-5277.

Scott Dearnley
Member, NSD Investments LLC

0.00



1105 APPERSON ST. TM VAVRA ASSOCIATES, P.C.

GENERAL REQUIREMENTS:

CONTRACTOR IS RESPONSIBLE TO VERIFY PLAN, EXISTING DIMENSIONS AND CONDITIONS OF THIS PROPOSED DESIGN. DISCREPANCIES SHALL BE PROVIDED TO THE BUILDER IN WRITING PRIOR TO COMMENCEMENT OF CONSTRUCTION.

THESE PLANS ARE DESIGNED IN ACCORDANCE WITH THE 2018 IRC WITH VRC AMENDMENTS. ITEMS NOT ADDRESSED HEREIN ARE SUBJECT TO 2018 IRC AND VRC. IT IS ASSUMED THAT THE CONTRACTOR/ BUILDER IS VERSED IN THE AFOREMENTIONED CODES AND THAT ALL CONSTRUCTION PRACTICES WILL BE EXECUTED IN A MANNER CONSISTENT WITH THESE STANDARDS.

THE CONTRACTOR IS SOLELY RESPONSIBLE FOR ALL CONSTRUCTION MEANS, MATERIALS AND METHODS, ENSURING THAT PROJECT COORDINATION IS IN ACCORDANCE WITH REQUIREMENTS OF THE AUTHORITY HAVING JURISDICTION.

STRUCTURAL SPECIFICATIONS:

THE CONDITIONS AND ASSUMPTIONS STATED IN THESE SPECIFICATIONS SHALL BE VERIFIED BY THE CONTRACTOR FOR CONFORMANCE TO ALL CODES AND CONDITIONS. IN THE EVENT OF ANY DISCREPANCY BETWEEN THESE SPECIFICATIONS AND CODES AND CONDITIONS, THE CONTRACTOR SHALL NOTIFY THE BUILDER IN WRITING OF THE DISCREPANCY AND ALTERNATE PRESCRIPTIVE MEASURES OR ENGINEERED SOLUTIONS SHALL BE APPLIED TO ENSURE STRUCTURAL ADEQUACY.

WHERE A CONFLICT BETWEEN THESE DRAWINGS EXISTS WITH AFOREMENTIONED CODE OR DESIGN PRINCIPALS, THE MORE STRINGENT REQUIREMENT SHALL BE FOLLOWED.

DESIGN CRITERIA		
GROUND SNOW LOAD	25	
EXPOSURE CATEGORY (WALL BRACING)	В	
SEISMIC DESIGN CATEGORY	В	
WEATHERING PROBABILITY	SEVERE	
FROST DEPTH	JURISDICTIONAL	
UNDERLAYMENT REQUIRED	YES	

LIVE LOADING		
LIVING AREAS	40	
SLEEPING AREAS	30	
ATTICS WITH STORAGE	20	
HABITABLE ATTICS	30	
BALCONIES AND DECKS	40	
PASSENGER VEHICLE GARAGES	50	
STAIRS	40	

SOILS SHALL PROVIDE AN ASSUMED 1500 LBS. ALLOWABLE BEARING. THE WATER TABLE (SEASONAL OR OTHERWISE) SHALL NOT EXTEND TO WITHIN 2' OF THE BOTTOM OF CONCRETE SLABS, FOOTINGS AND WALLS.

FOOTINGS MUST EXTEND TO FROST DEPTH DESIGNATED BY THE AUTHORITY HAVING JURISDICTION.

FOOTINGS SHALL BE PLACED ON NON-EXPANSIVE SOILS.

BACKFILL FOR SLABS MUST BE IN ACCORDANCE WITH IRC R506.

CONCRETE COMPRESSIVE STRENGTH	
BASEMENT WALLS, FOUNDATIONS AND OTHER CONCRETE WALLS NOT EXPOSED TO WEATHER	25 <i>00</i> PSI
BASEMENT SLABS AND INTERIOR SLABS ON GROUND (NOT GARAGES)	25 <i>00</i> PSI
BASEMENT WALLS, FOUNDATION WALLS, EXTERIOR WALLS AND OTHER VERTICAL CONCRETE EXPOSED TO WEATHER	3500 PSI
PORCHES, CARPORT SLABS, STEPS EXPOSED TO WEATHER AND OTHER VERTICAL CONCRETE EXPOSED TO WEATHER.	3500 PSI

ALL STRUCTURAL WALL SHEATHING SHALL BE 1/2" O.S.B AND FASTENED IN ACCORDANCE WITH TABLE 602.10.4.

STRUCTURAL FLOOR SHEATHING SHALL BE MINIMUM $^3\!4$ " O.S.B TONGUE AND GROOVE OR BLOCKED AT ALL EDGES. FASTEN WITH 8D COMMON NAILS FASTENED 6" AT EDGES 12" AT INTERMEDIATE SUPPORT.

MOOD:

ALL SOLID SAWN HEADERS, BEAMS AND GIRDERS SHALL BE MINIMUM SYP #2. APPLY WET FACTOR FOR WEATHER EXPOSED MEMBERS.

WOOD TRUSSES SHALL BE DESIGNED INSTALLED AND MANUFACTURED IN ACCORDANCE WITH ANSI TPI I. MANUFACTURER SHALL PROVIDE SEALED TRUSS DRAWINGS FOR REVIEW AND INSPECTION.

ALL WOODEN MEMBERS SHALL BE PROTECTED FROM DECAY AND TERMITE INFESTATION IN ACCORDANCE WITH R317 AND R318 OF THE IRC.

PROVIDE A CONTINUOUS DOUBLE TOP PLATE ACROSS ALL BEARING STUD WALLS.

MINIMUM COLUMN SUPPORT UNDER ANY BEAM OR HEADER UNLESS OTHERWISE NOTED IS A SINGLE 2X4 SPF #2. HEADERS MUST HAVE A MINIMUM OF I JACK STUD AND I KING STUD.

FOUNDATION ANCHORAGE SHALL BE IN ACCORDANCE WITH R403.1.6.

ALL POSTS SHOWN ON FLOOR OR FRAMING PLAN SHALL TERMINATE TO FOOTING AT GROUND OR TRANSFERRED TO A BEAM BELOW.

ALL STRUCTURAL COMPOSITE LUMBER SHALL BE INSTALLED IN ACCORDANCE WITH MANUFACTURER'S SPECIFICATIONS AND MUST BE ACCOMPANIED BY BOTH A LAYOUT AND BEAM SHEETS PRODUCED BY THE DESIGNER.

BORING AND NOTCHING LIMITS SHALL EXCEED NEITHER MANUFACTURER'S SPECS FOR STRUCTURAL COMPOSITE NOR IRC LIMITS FOR SOLID SAWN LUMBER.

ALL WALLS TO BE ASSEMBLED IN ACCORDANCE WITH FLOOR PLAN AND FRAMING PLANS

REFERENCED HERE. MASONRY:

MORTAR USED SHALL BE TYPE "S". ANY ADDITIVES SHALL BE PROPORTIONED IN ACCORDANCE WITH ASTM C-270.

BRICK VENEER SHALL BE ATTACHED TO FRAMING WITH MINIMUM 22 GAUGE GALVANIZED CORRUGATED STEEL TIES $\frac{1}{6}$ " WIDE 24" O.C VERTICALLY AND 32" O.C. HORIZONTALLY.

WEEP HOLES SHALL BE WITHIN THE FIRST COURSE ABOVE GRADE AND WITHIN THE FIRST COURSE ABOVE STEEL LINTELS. WEEP HOLES SHALL BE NO LESS THAN 3/16" DIAMETER AND NO MORE THAN 33" O.C.

VENEER FLASHING SHALL BE IN ACCORDANCE WITH IRC R703.7.5

ALLOWABLE SPANS FOR LINTELS SUPPORTING MASONRY VENEER			
ANGLE SIZE	NO STORY ABOVE	ONE STORY ABOVE	TWO STORIES ABOVE
3 × 3 × 1/4	6'	4'-6"	3'
4 × 3 × 1/4	8'	6'	4'-6"
5 × 3 ½ × %	10'	8'	6'
6 × 3 ½ × %	14'	9'-6"	7'
2-6×3½×5/6	20'	12'	9'-6"

ALL MASONRY FOUNDATION CONSTRUCTION SHALL BE INSTALLED IN ACCORDANCE WITH TMS 402, ACI 530, ASCE 5 NCMA TR68-A. THE IRC PRESCRIPTIVE CODE MAY BE USED AS AN ALTERNATIVE.

ENERGY, THERMAL & MOISTURE

WHERE REQUIRED, WALLS SHALL BE DAMPROOFED/ WATERPROOFED IN ACCORDANCE WITH IRC R405 & R406.

A 6 MIL. POLYETHYLENE VAPOR RETARDER SHALL BE PLACED BENEATH ALL INTERIOR SLABS.

THE EARTH ENCLOSED BY CRAWL SPACES SHALL BE COVERED WITH A CLASS I VAPOR RETARDER IN ACCORDANCE WITH IRC R408.

FLASHING SHALL BE INSTALLED ON ALL EXTERIOR WALLS TO ENSURE AGAINST WATER INFILTRATION. ALL AREAS SPECIFIED IN IRC R703.8 SHALL BE ADDRESSED AS SPECIFIED.

AN APPROVED WATER RESISTIVE BARRIER SHALL BE APPLIED TO ALL EXTERIOR SHEATHING. EITHER TYPE I #15 ROOF FELT OR OTHER LISTED AND APPROVED HOUSEWRAP WILL SATISFY THIS REQUIREMENT. INSTALLATION, LAPS, JOINTS AND SEAMS SHALL BE INSTALLED IN ACCORDANCE WITH IRC R703.2 OR MANUFACTURER'S INSTALLATION INSTRUCTIONS.

THE BUILDING THERMAL ENVELOPE IN THESE DRAWINGS ARE ASSUMED TO BE CLIMATE ZONE 4. THE THERMAL ENVELOPE SHALL BE SEALED IN ACCORDANCE WITH IRC IIO2.4.I.I. INSULATION R-VALUES (WHEN INSTALLED PRESCRIPTIVELY) SHALL BE INSTALLED IN ACCORDANCE WITH THE TABLE BELOW. WHEN PRESCRIPTIVE INSTALLATION IS NOT PRACTICAL A RESCHECK MAY ACCOMPANY THESE PLANS AS AN ALTERNATIVE FOR THE BUILDING OFFICIAL'S APPROVAL.

INSULATION AND FENESTRATION REQUIREMENTS	
CLIMATE ZONE	4 EXCEPT MARINE
FENESTRATION U-FACTOR	0.32
SKYLIGHT U-FACTOR	0.55
GLAZED FENESTRATION SHGC	0.40
CEILING R-VALUE	49
WOOD FRAME WALL R-VALUE	15 OR 13+1
MASS WALL R-VALUE	8 -13
FLOOR R-VALUE	19
BASEMENT WALL R-VALUE	IO CONTINUOUS OR 13 CAVITY
SLAB R-VALUE AND DEPTH	IO, 2FT
CRAWL SPACE WALL R-VALUE	10-13

SAFETY:

ALL HANDRAILS AND GUARDRAILS ARE TO BE INSTALLED IN ACCORDANCE WITH R3II AND R3I2.

SMOKE ALARMS SHALL BE LOCATED AND INSTALLED ACCORDING TO IRC. R3I4.

CARBON MONOXIDE ALARMS, WHEN REQUIRED, SHALL BE LOCATED AND INSTALLED IN ACCORDANCE WITH IRC R315.


GLAZING IN HAZARDOUS LOCATIONS, AS SPECIFIED IN IRC R308, SHALL BE ASSEMBLED AND IDENTIFIED WITH A MANUFACTURER'S DESIGNATION SPECIFYING WHO APPLIED THE DESIGNATION AND THE STANDARD WITH WHICH IT COMPLIES, ALTERNATIVE CERTIFICATION MAY BE CONSIDERED BY THE BUILDING OFFICIAL.

DWELLING/ GARAGE FIRE SEPARATION		
FROM RESIDENCE AND ATTICS	½" GYP APPLIED TO GARAGE SIDE	
FROM ALL HABITABLE ROOMS ABOVE GARAGE	%" TYPE X GYP BOARD	
STRUCTURES SUPPORTING FLOOR/ CEILING ASSEMBLIES USED FOR SEPARATION	½" GYP BOARD	
GARAGES LOCATED LESS THAN 3 FEET FROM A DWELLING UNIT ON THE SAME LOT	½" GYP BOARD APPLIED TO INTERIOR SIDE OF EXTERIOR WALLS THAT ARE WITHIN THIS AREA.	

THE INFORMATION, PLANS, AND SPECIFICATIONS APPEARING IN THESE DRAWINGS ARE THE PROPERTY OF T.M. VAVRA AND ASSOCIATES. DUPLICATION IN WHOLE OR PART IS PROHIBITED.

COPYRIGHT NOTICE:

THIS HOME PLAN IS PROTECTED UNDER THE UNITED STATES COPYRIGHT LAW. WHEN PURCHASING A HOME PLAN FROM US, YOU HAVE BEEN LICENSED THE RIGHT TO BUILD ONE RESIDENCE. THIS PLAN MAY NOT BE COPIED, RESOLD, OR USED FOR THE CONSTRUCTION OF MORE THAN ONE RESIDENCE WITHOUT THE EXPRESS WRITTEN PERMISSION OF TMVAVRA ASSOCIATES P.C.. TMVAVRA ASSOCIATES P.C. RETAINS ALL RIGHTS, TITLE, AND OWNERSHIP OF THE ORIGINAL DESIGN AND DOCUMENTS, AS WELL AS ANY DERIVATIVE VERSION OF THE PLANS.

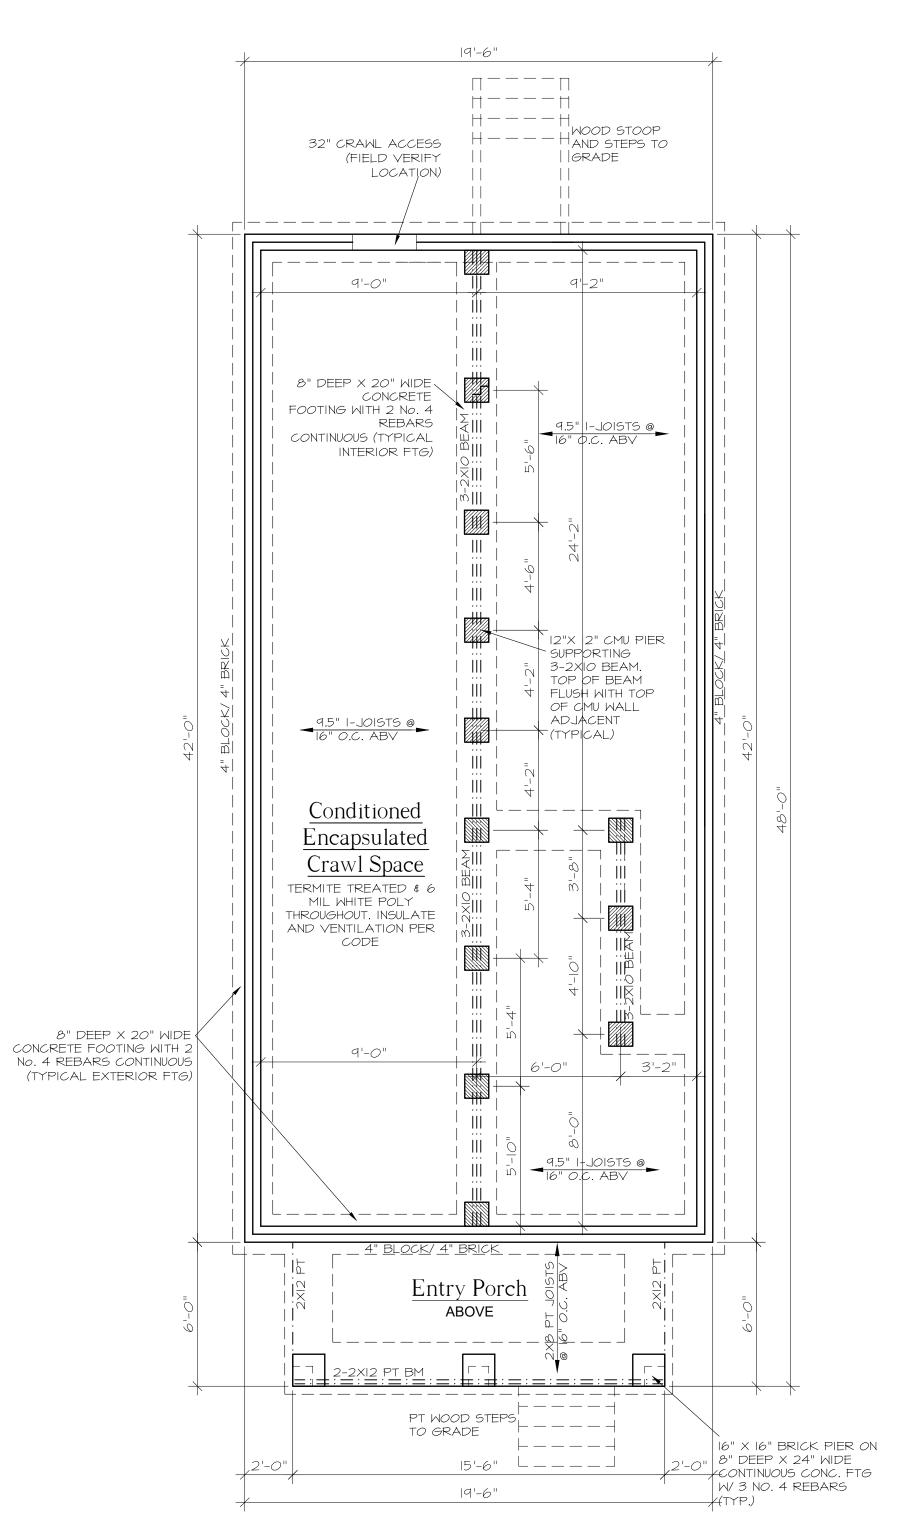


FOUNDATION PLAN

SCALE: 1/4" = 1'-0"

NOTE: VERIFY FOOTING SIZE AND FOUNDATION REINFORCEMENT WITH SOILS ANALYSIS, UNBALANCED FILL DEPTH, AND HEIGHT OF MASONRY PER CODES.

COMPOSITE MASONRY FOUNDATION: 4" BRICK WITH CMU BACKER. STRUCTURAL BRICK TIES AT 16" OC VERTICAL, 32" OC HORIZONTAL, FULL BED, HEAD AND COLLAR

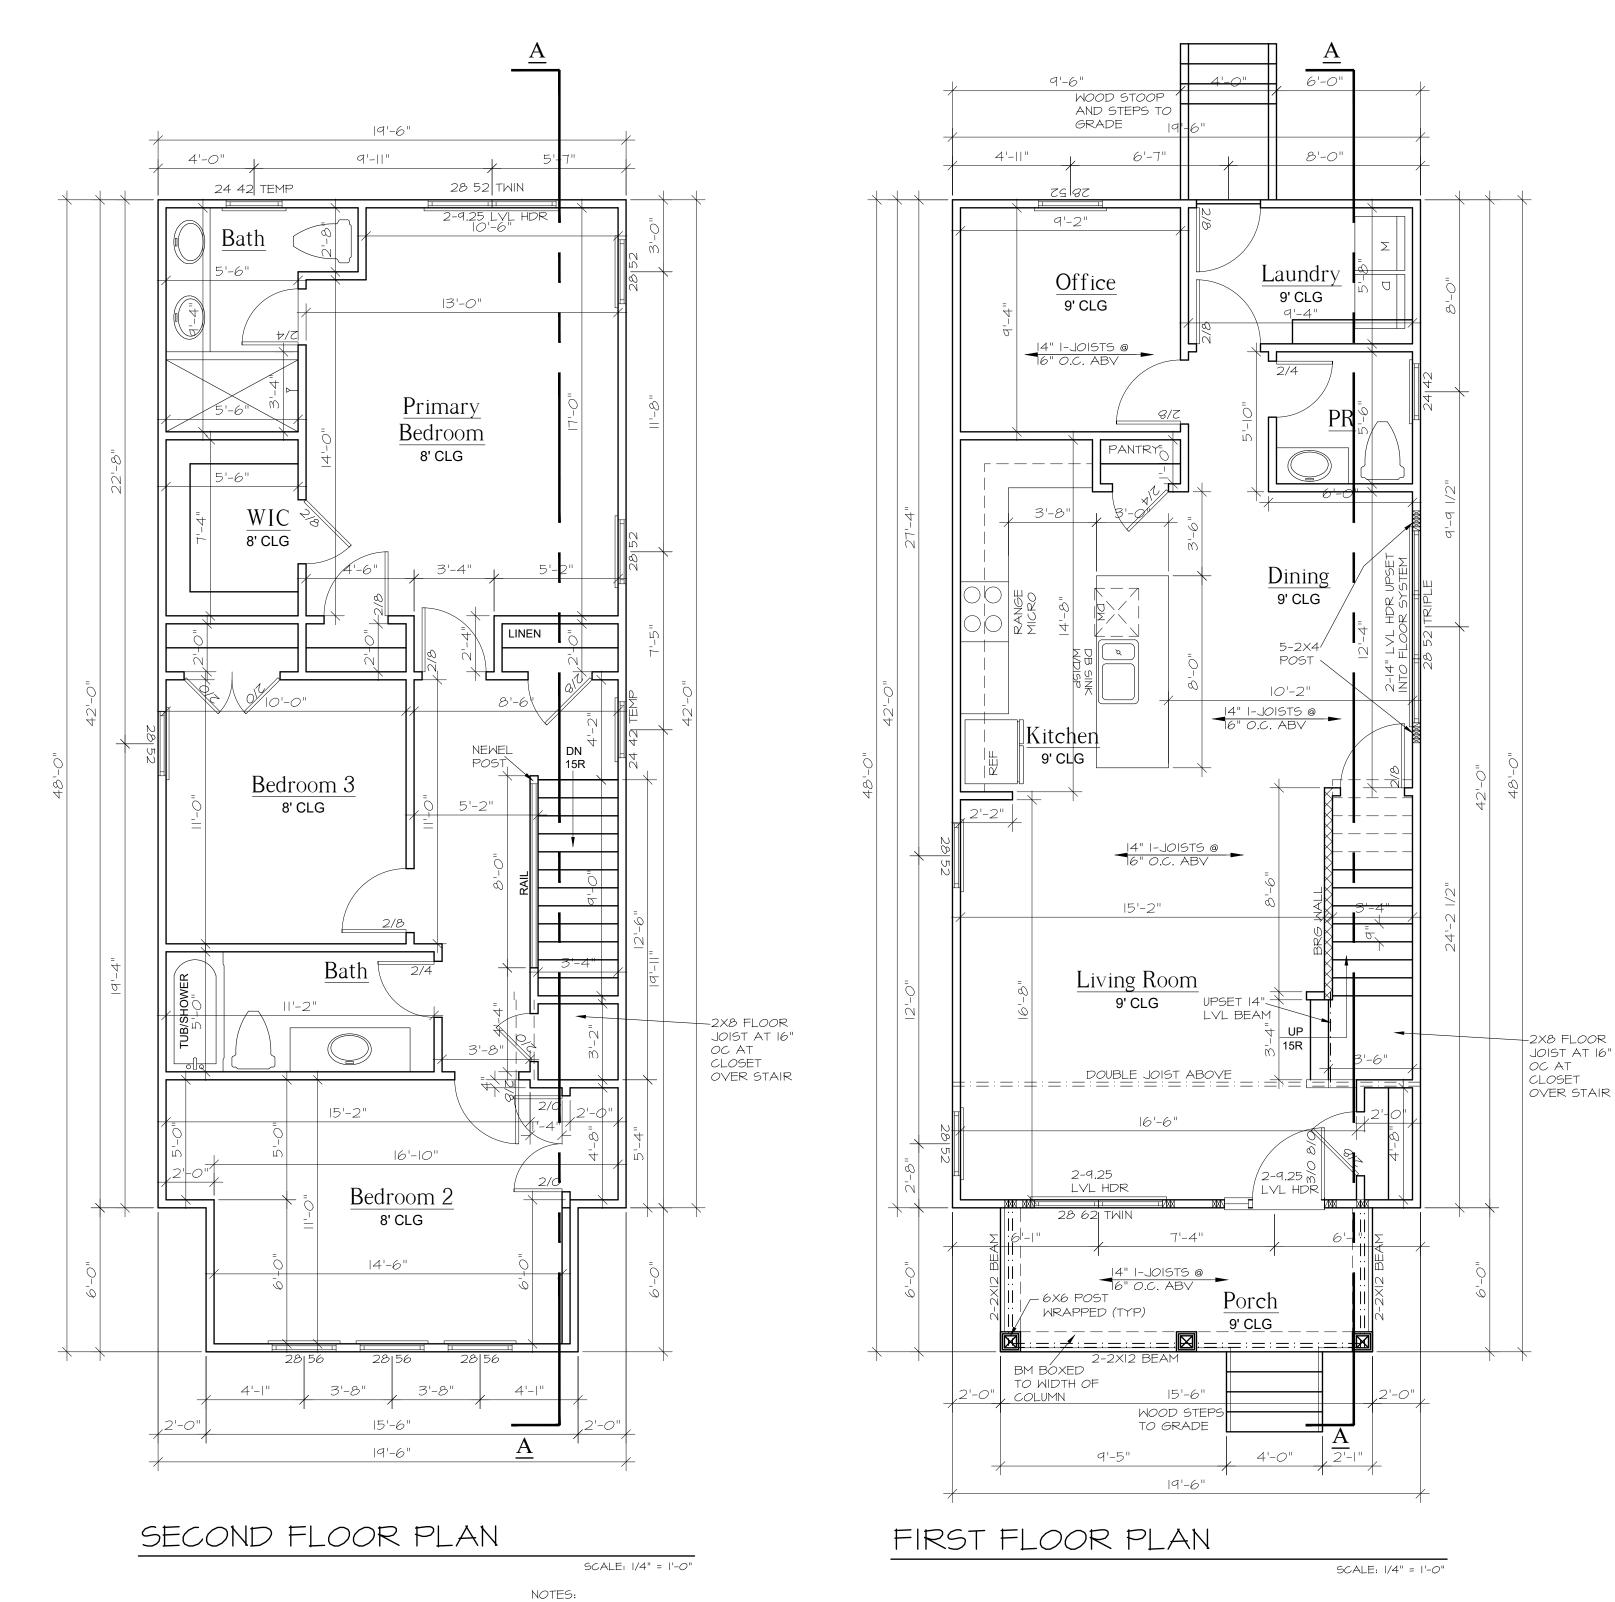

ALL HEADERS 2-2X8 UNLESS OTHERWISE NOTED
 ALL EXTERIOR WALLS 2X4 AT 16" O.C., ALL INTERIOR WALLS 2X4 AT 16"

O.C. UNLESS NOTED.

REQUIRED FOR 3.5" WIDTH.

3. ALL STRUCTURAL WOOD MEMBERS (I.E. JOISTS, RAFTERS, BEAMS, ETC.) TO BE SOUTHERN YELLOW PINE #2 UNLESS OTHERWISE NOTED 4. ALL ELEVATION REFERENCES ARE RELATIVE TO INTERIOR FINISHED

5. ALL STRUCTURAL COLUMNS MUST EXTEND CONTINUOUS TO FOUNDATION.

6. BUILDER TO VERIFY ALL WINDOWS MEET EGRESS REQUIREMENTS PER MANUFACTURERS SPECS PRIOR TO ORDERING OR PLACING WINDOWS. 7. ALL WALLS DRAWN AT NOMINAL 4"/6" WIDTH. BEARING AND EXTERIOR WALL TO BE PLACED AS SHOWN, ADJUST INTERMEDIATE WALLS AS

TOTAL AREA OF STRUCTURE: 912 SF LOT SIZE: 2625.57 SF LOT COVERAGE = 34.7%

INTERIOR DOOR HEIGHTS FIRST FLOOR 6'-8" SECOND FLOOR 6'-8" UNLESS NOTED OTHERWISE

FIRST FL. LIVING: SECOND FL. LIVING: 866 SF TOTAL COND. AREA: 1685 SF ENTRY PORCH: 93 SF 1778 SF AREA UNDER ROOF:


AREA CALCULATIONS

YOUNGBLOOD I 1105 APPERSON FOUNDATION PI






SHEET NO.

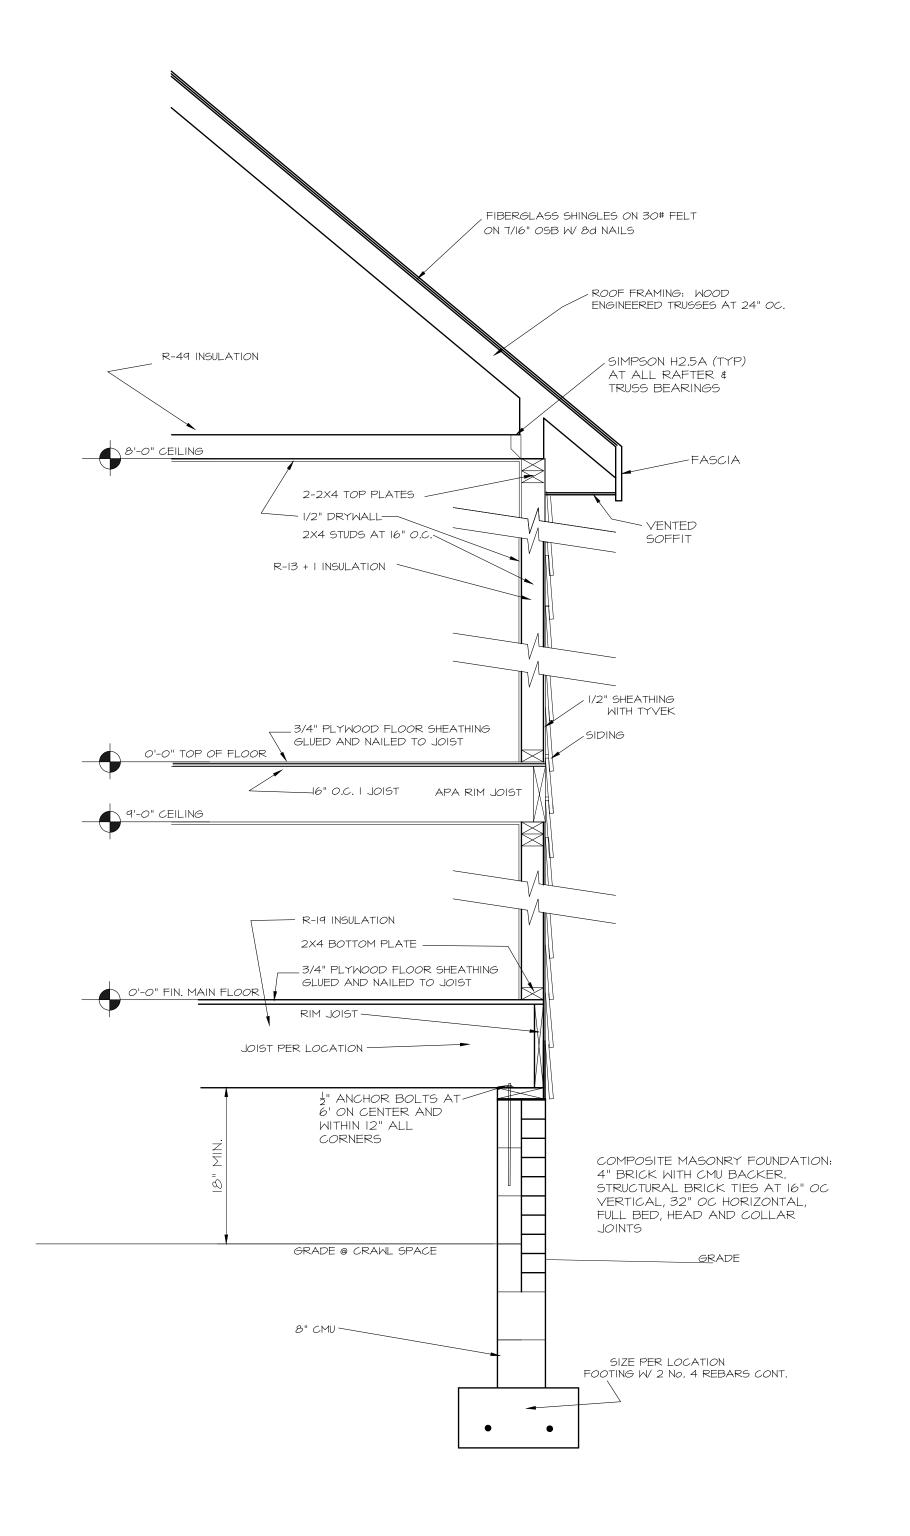

WALL SECTION 2 STORY

SCALE: 3/4" = 1'-0"

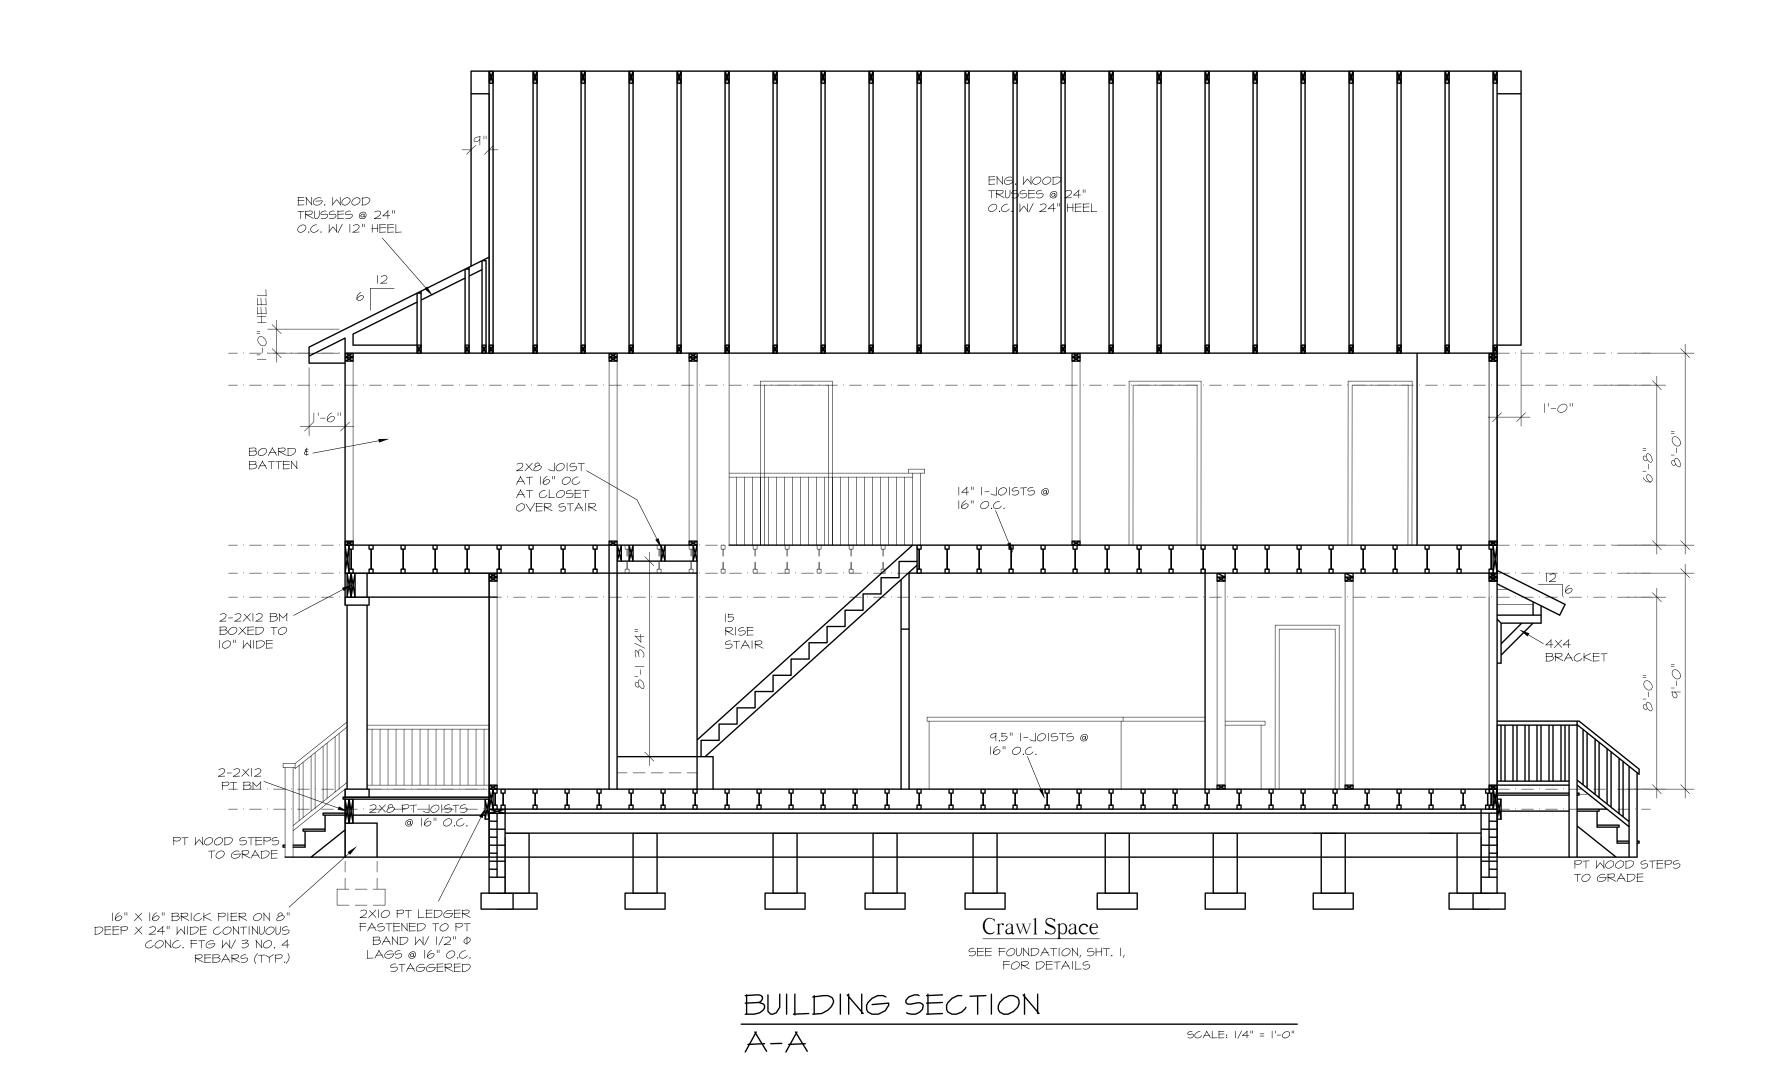

19'-6"


ENG. WOOD TRUSSES @ 24" O.C. W/ 24" HEEL

SCALE: 1/4" = 1'-0"

TRUSSES @ 24" O.C. W/ 12" HEEL

ROOF FRAMING PLAN

SHEET NO.

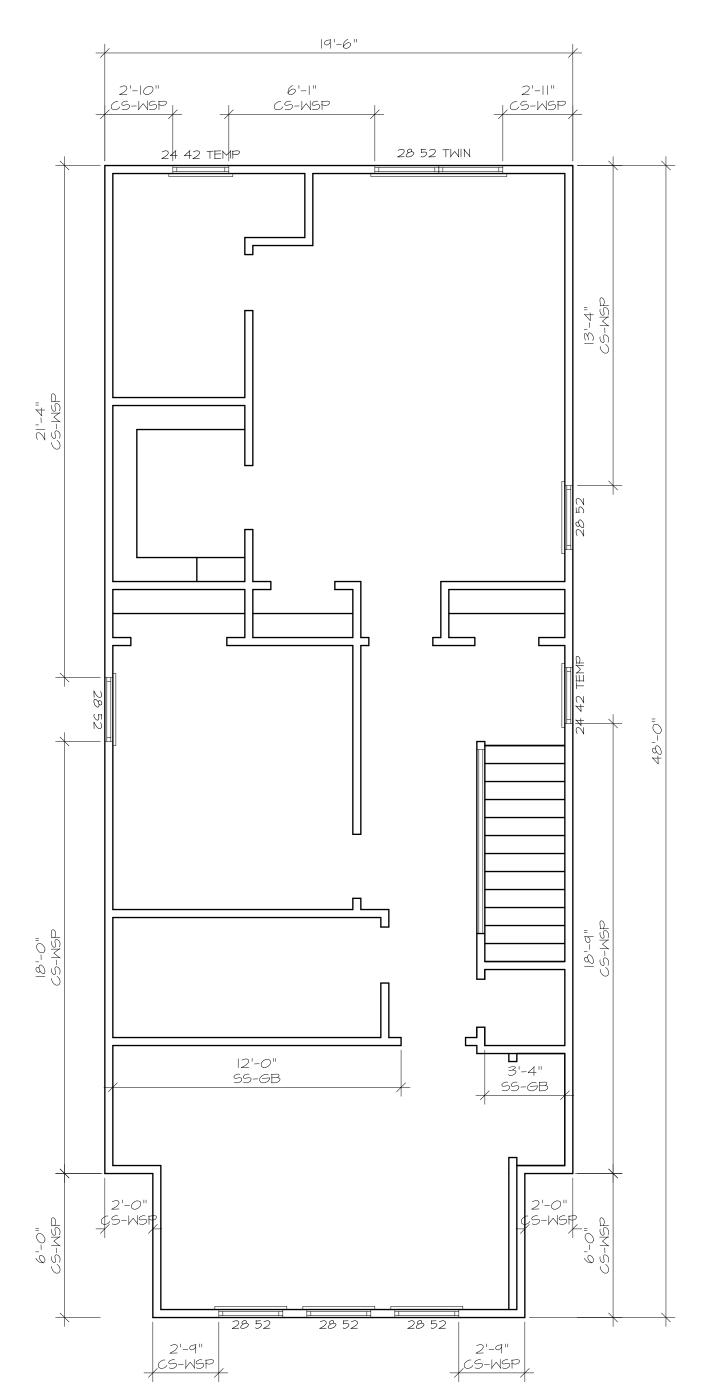


SECOND FLOOR BRACE WALL PLAN SCALE: 1/4" = 1'-0"

WIND BRACING PANEL REQUIREMENTS:

ALL EXTERIOR WALL SHEATHING SHALL BE BRACED IN ACCORDANCE WITH R602.10.4 IRC 2018 AS FOLLOWS:

- UNO. EXTERIOR SHEATHING SHALL BE AS FOLLOWS: 2X4 MIN. SPF (STUD GRADE) SPACED @ 16"
 O.C. MAX. EXTERIOR WALL SHEATHING 7/16" OSB OR PLYWOOD. FASTENERS 8d X 2.5" LONG NAILS @ 6" O.C. @ PANEL EDGES & 12" O.C. @ INTERMEDIATE SUPPORTS.
 WOOD STRUCTURAL PANEL (WSP) SHALL BE CONSTRUCTED THE SAME AS ABOVE, AND ALL
- EDGES OF BRACED WALL PANELS (WSP OR CS-WSP) SHALL BE BLOCKED WITH 2X4(6)
 BLOCKING AND THE SAME NAILING AS ABOVE.

 3. WHEN CONTINUOUS SHEATHING METHODS (CS-WSP OR CS-PF) ARE SPECIFIED ON THE PLANS,
 ALL EXTERIOR SHEATHABLE SURFACES ON THE SPECIFIED BRACED WALL LINE SHALL BE
 SHEATHED THE SAME AS NOTE I & SHALL BE BLOCKED WITH 2X4 BLOCKING.
- 4. GYPSUM BOARD (GB) BRACED WALL, WHEN INSTALLED VERTICALLY, SHALL BE BLOCKED WITH 2X4 BLOCKING & FINISHED AS FOLLOWS: INTERIOR WALL FINISH 1/2" GYPSUM BOARD. FASTENERS 6d X 2" COMMON NAIL @ 7" O.C. @ EDGES & 7" IN FIELD OR No 6 1-1/4" SCREWS @ 4" O.C. @ EDGES & IN FIELD.
- 5. MINIMUM BRACED WALL PANEL LENGTH IS IN ACCORDANCE WITH TABLE R602.10.5
- 6. ABBREVIATIONS & LEGEND:
 CS-WSP -CONTINUOUS SHEATHING
 WSP -WOOD STRUCTURAL PANEL
 CS-PF -CONTINUOUSLY SHEATHED PORTAL FRAME
 GB -GYPSUM BOARD

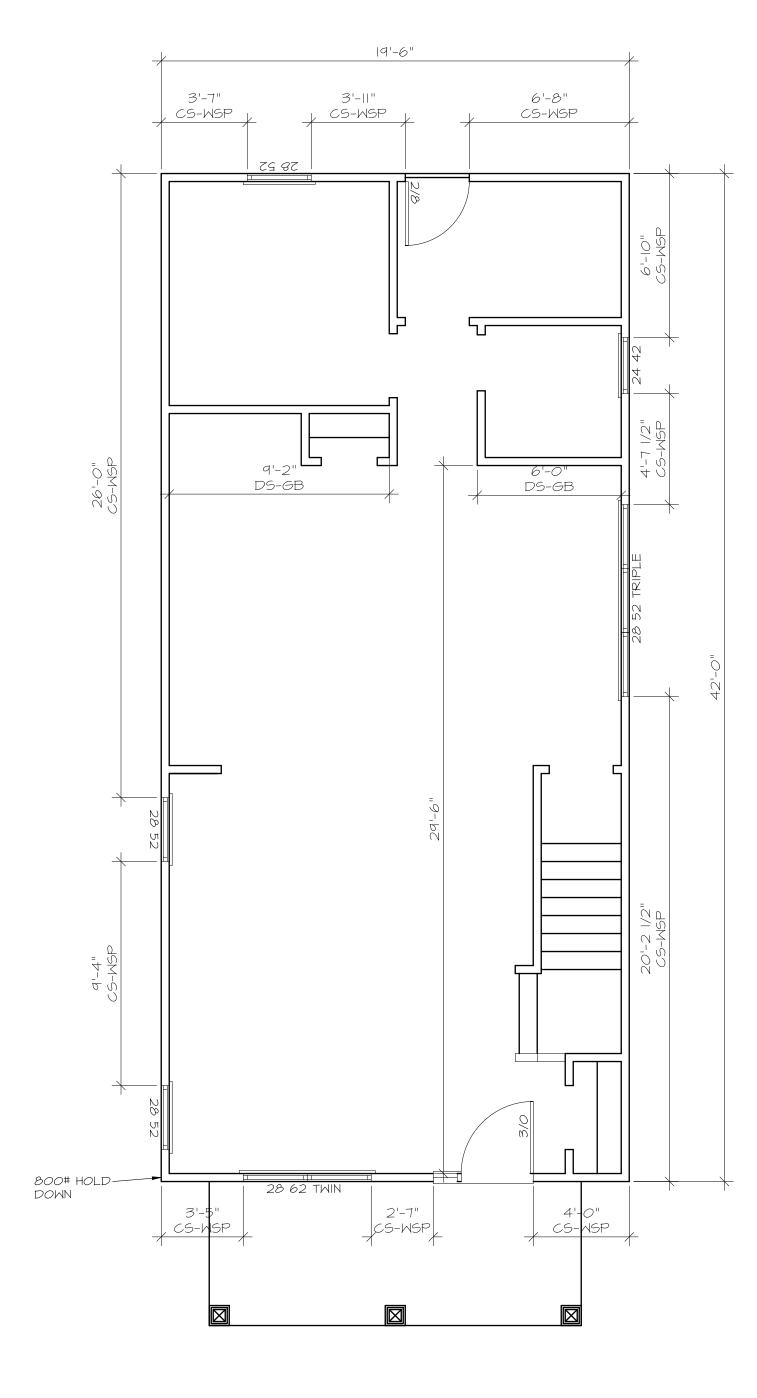

FIRST FLOOR BRACE WALL PLAN

BLOCKING REQUIREMENTS: STRUCTURAL PANELS ALL INTERIOR BRACED WALL PANELS SHALL HAVE CONTINUOUS FULL DEPTH BLOCKING OR ADDITIONAL JOIST IN FLOOR AND CEILING. PANEL SHALL BE NAILED TO BLOCKING/JOIST WITH 3-16d NAILS AT 16" O.C. TO FLOOR MEMBER, 3-8d NAILS TO CEILING MEMBER.

800# HOLD DOWN ANCHOR: SIMPSON LSTA24 WALL TO RIM JOIST AND 2- SIMPSON A35 ANCHORS RIM JOIST TO 2X8 SILL PLATE



City of Richmond **Department of Planning** & Development Review

Special Use Permit

LOCATION: 1105 Apperson Street

APPLICANT: NSD Investments, LLC

COUNCIL DISTRICT: 7

PROPOSAL: To authorize the special use of the property known as 1105 Apperson Street for the purpose of a single family detached dwelling upon certain terms and conditions.

For questions, please contact David Watson at 804-646-1036 or David.Watson@RVA.gov

