

KFi
 ARCHITECTURE
 INTERIORS
 URBAN DESIGN
 101 west Broad Street
 Suite 101B
 Richmond, VA 23220
 804.788.0880

vhb
 115 South 15th Street
 Suite 200
 Richmond, VA 23219
 804.343.7100

&D
DANIELS & ASSOCIATES, P.C.
 Consulting Engineers
 2112 W. Laburnum Avenue
 Suite 202
 Richmond, VA 23227
 804.553.1283

Snead Associates, P.C.
 Landscape Architecture
 8005 Creighton
 Parkway #703
 Mechanicsville, VA 23111
 804.649.8500

HS ENGINEERING, INC.
 CONSULTING ENGINEERS
 479 Southlake Boulevard
 Richmond, VA 23236
 804.594.7210

Kanawha Plaza
 East Canal Street
 Richmond, Virginia

No.	Revision	Date	Apprv.

Designed by _____ Checked by _____
 Issued for _____ Date _____
 Planning Commission May 14, 2015
 Review
 Not Approved for Construction

SITE LAYOUT PLAN

SCALE: 1' = 20'



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9th St.

7th St.

Kanawha Plaza
 East Canal Street
 Richmond, Virginia

No.	Revision	Date	Appr'd


Designed by _____ Checked by _____
 Issued for _____ Date _____
 Planning Commission April 20, 2015
 Review
 Not Approved for Construction

LANDSCAPE PLAN

Drawing Number _____

SCALE: 1" = 20'

Sheet _____ of _____
 Project Number
 33945.00

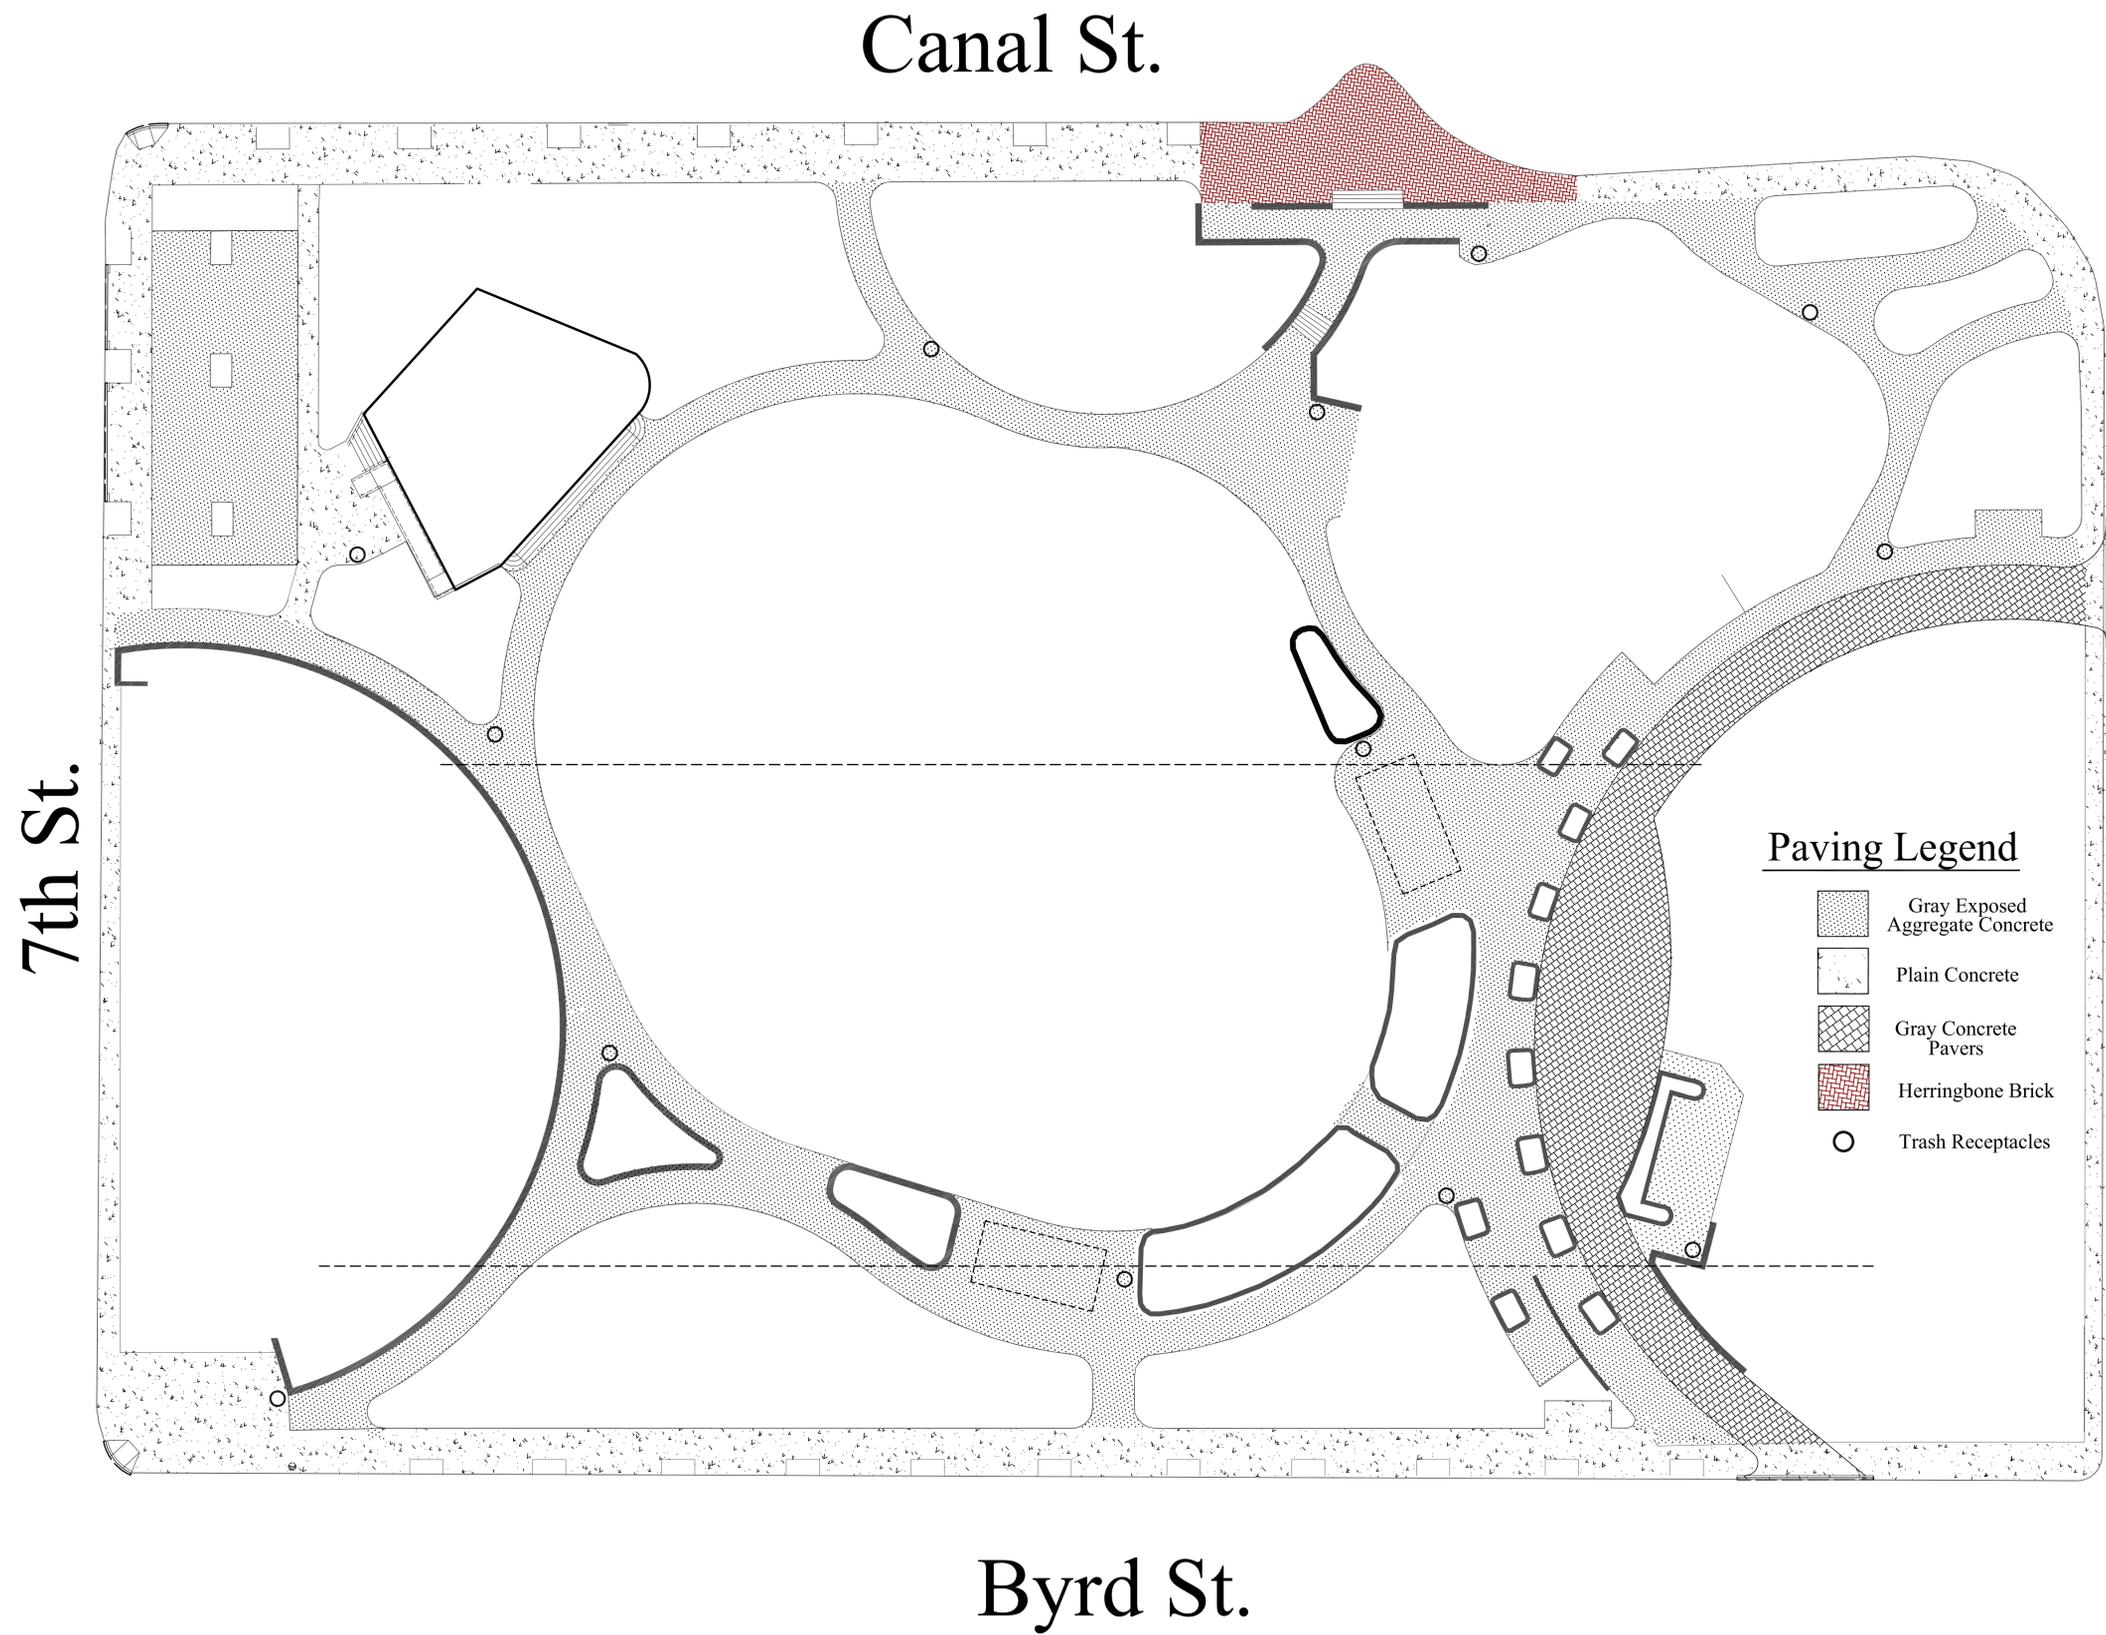

Canal St.

Byrd St.

7th St.

9th St.

Paving Legend

-  Gray Exposed Aggregate Concrete
-  Plain Concrete
-  Gray Concrete Pavers
-  Herringbone Brick
-  Trash Receptacles



**ARCHITECTURE
 INTERIORS
 URBAN DESIGN**

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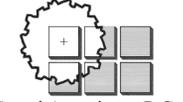


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Planning Commission April 20, 2015
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PAVING PLAN

Drawing Number _____

Sheet _____ of _____

Project Number
 33945.00



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Richmond, VA 23256
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PLANT LIST: Kanawha Plaza

KEY	QUANTITY	BOTANICAL NAME	COMMON NAME	SIZE	NOTES/SPACING
Trees					
	14	Quercus coccinea 'Splendens'	Splendens Scarlet Oak	3" Caliper	B & B, Specimen, Spacing as shown
	49	Nyssa sylvatica	Black Gum	3" Caliper	B & B, Specimen, Spacing as shown
	3	Lagerstroemia indica 'Natchez'	Natchez White Crape Myrtle	10-12' Ht	B & B, Multi Stem, Straight Growth
	18	Crataegus phaenopyrum	Washington Hawthorn	6-7' Ht	B & B, Specimen, Spacing as shown
	21	Ilex attenuata 'Fosteri'	Fosteri Holly	10-12' Ht	B&B, Tree Form
	28	Magnolia grandiflora 'Little Gem'	Espalier Little Gem Magnolia	4-5' Ht	Espalier Form, Container Grown
	9	Platanus occidentalis	American Sycamore	3" Caliper	B & B, Specimen, Spacing as shown
	2	Ulmus parvifolia 'Bosque'	Bosque Elm	3" Caliper	B & B, Specimen, Spacing as shown

Shrubs

	243	Itea virginica	Virginia Sweetspire	5 Gallon	
	75	Ilex vomitoria 'nana'	Dwarf Yaupon Holly	5 Gallon	Container, 4' O.C.
	195	Ilex cornuta 'Burford Nana'	Dwarf Burford Holly	3 Gallon	Container, 4' O.C.
	99	Ilex verticillata	Winterberry	5 Gallon	Container, 3' O.C.
	27	Ilex crenata 'Hoogendorn'	Hoogendorn Holly	5 Gallon	Container, 3' O.C.

Perennials and Groundcovers

	295	Muhlebergia capillaris	Muhly Feathergrass	1 Gallon	Container, 3' O.C.
	145	Pennisetum alopecuroides	Fountain Fountain Grass	1 Gallon	Container, 3' O.C.
	640	Sedum angelina	Angelina Sedum	1 Qt	Container, 18" O.C.
	171	Calamagrostis acutiflora 'Carl Foerster'	Carl Foerster Feather Reed Grass	1 Gallon	Container, 3' O.C.
	109	Rudbeckia fulgida	Black Eyed Susan	1 Gallon	Container, 3' O.C.
	30	Stipa tenuissima 'Ponytails'	Ponytails Feathergrass	1 Gallon	Container, 2' O.C.
	69	Nepeta faassenii 'Dropmore'	Catmint	1 Gallon	Container, 2' O.C.
	27	Yucca 'Color Guard'	Varigated Adams Needle	1 Gallon	Container, 2' O.C.
	43	Tiarella cordifolia 'Brandywine'	Brandywine Foam Flower	1 Gallon	Container, 2' O.C.
	1385	Liriope muscari 'Royal Purple'	Royal Purple Green Liriope	1 Qt	Container, 12" O.C.
	SOD	0.75ac	Bermuda spp. Sod	Sod All Disturbed Areas Not Designated As Plant Bed	

Kanawha Plaza
East Canal Street
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PLANT LIST

Drawing Number


SCALE: 1' = 20'

Sheet _____ of _____

Project Number
33945.00



Trash Receptacle
 Petersen Manufacturing Co.
 Model # WGB455554
 Color: Silver Gray

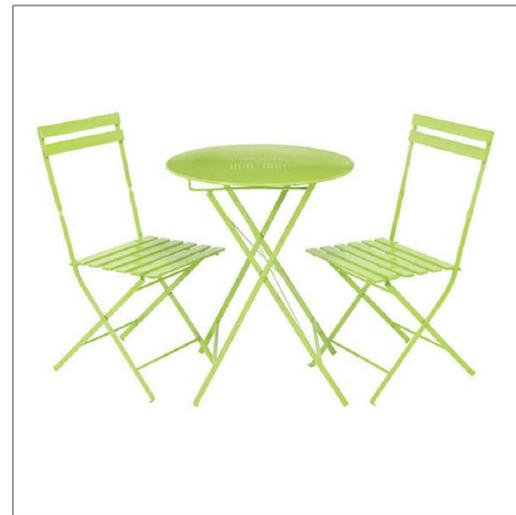

Moveable Tables and Chairs

Fermob / Bistro Table and Chairs
 Color: Verveine (Lime Green)
 Americancountryhomestore.com



Food Truck Area Dining Light: Urbis / Boreal
 Color: Platinum Silver



Tree Uplights: Vision 3 / IG3 Uplight



Area Light: Kim / Era / Heritage
 Site and Pedestrian Lighting
 Color: Silver Gray



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SITE MATERIALS
 IMAGES

Drawing Number

Sheet of

Project Number
 33945.00

— MATCHING GRANITE CAP

#5 DOWEL FOR
PRECAST CAP

3/8" MASONRY
JOINTS (TYP.)

6"X 18"
GRANITE BLOCK
(COLOR: GRAY)

— JOINT REINFORCEMENT
@ EVERY 2 COURSES.
LADDER TYPE WITH
2-3/16" SIDE RODS

FOR DRAINAGE, CREATE
SCUPPER @ ASPHALT PAVING
LEVEL. OMIT ONE FULL BLOCK
EVERY 15' O.C.

1/2" EXPANSION JOINT

FINISHED GRADE OF
NEW CONCRETE PAD



FINISHED GRADE

6" #57 STONE
COMPACTED
@ 95%


3 #5 REBAR CONT.
#5 REBAR @ 12" O.C.

#5 DOWELS @ 24" O.C.
ALTERNATE DIRECTION
HORIZ. LEG.

COMPACTED SUBGRADE

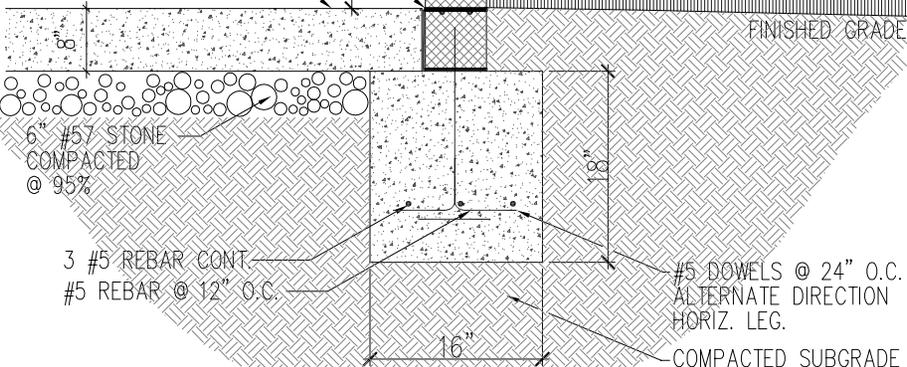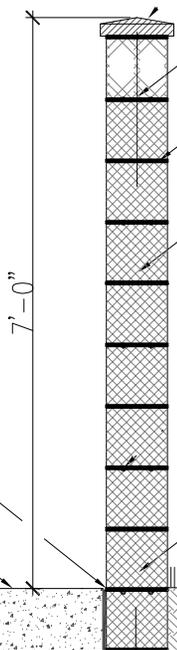

GRANITE SCREEN WALL


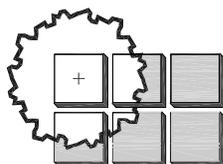


Snead Associates, P.C.
Landscape Architecture
Land Use Planning
8005 Creighton Pkwy #703
Mechanicsville, VA 23111
804-240-7823
sneadassociates@aol.com

**Design Development
for
Kanawha Plaza
Improvements**

Date: 03-10-2015
Scale: ----
Designed By: ----
Drawn By: ----
Checked By: C.G. Snead
Project Number: ----

Sheet Number:
of

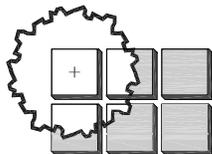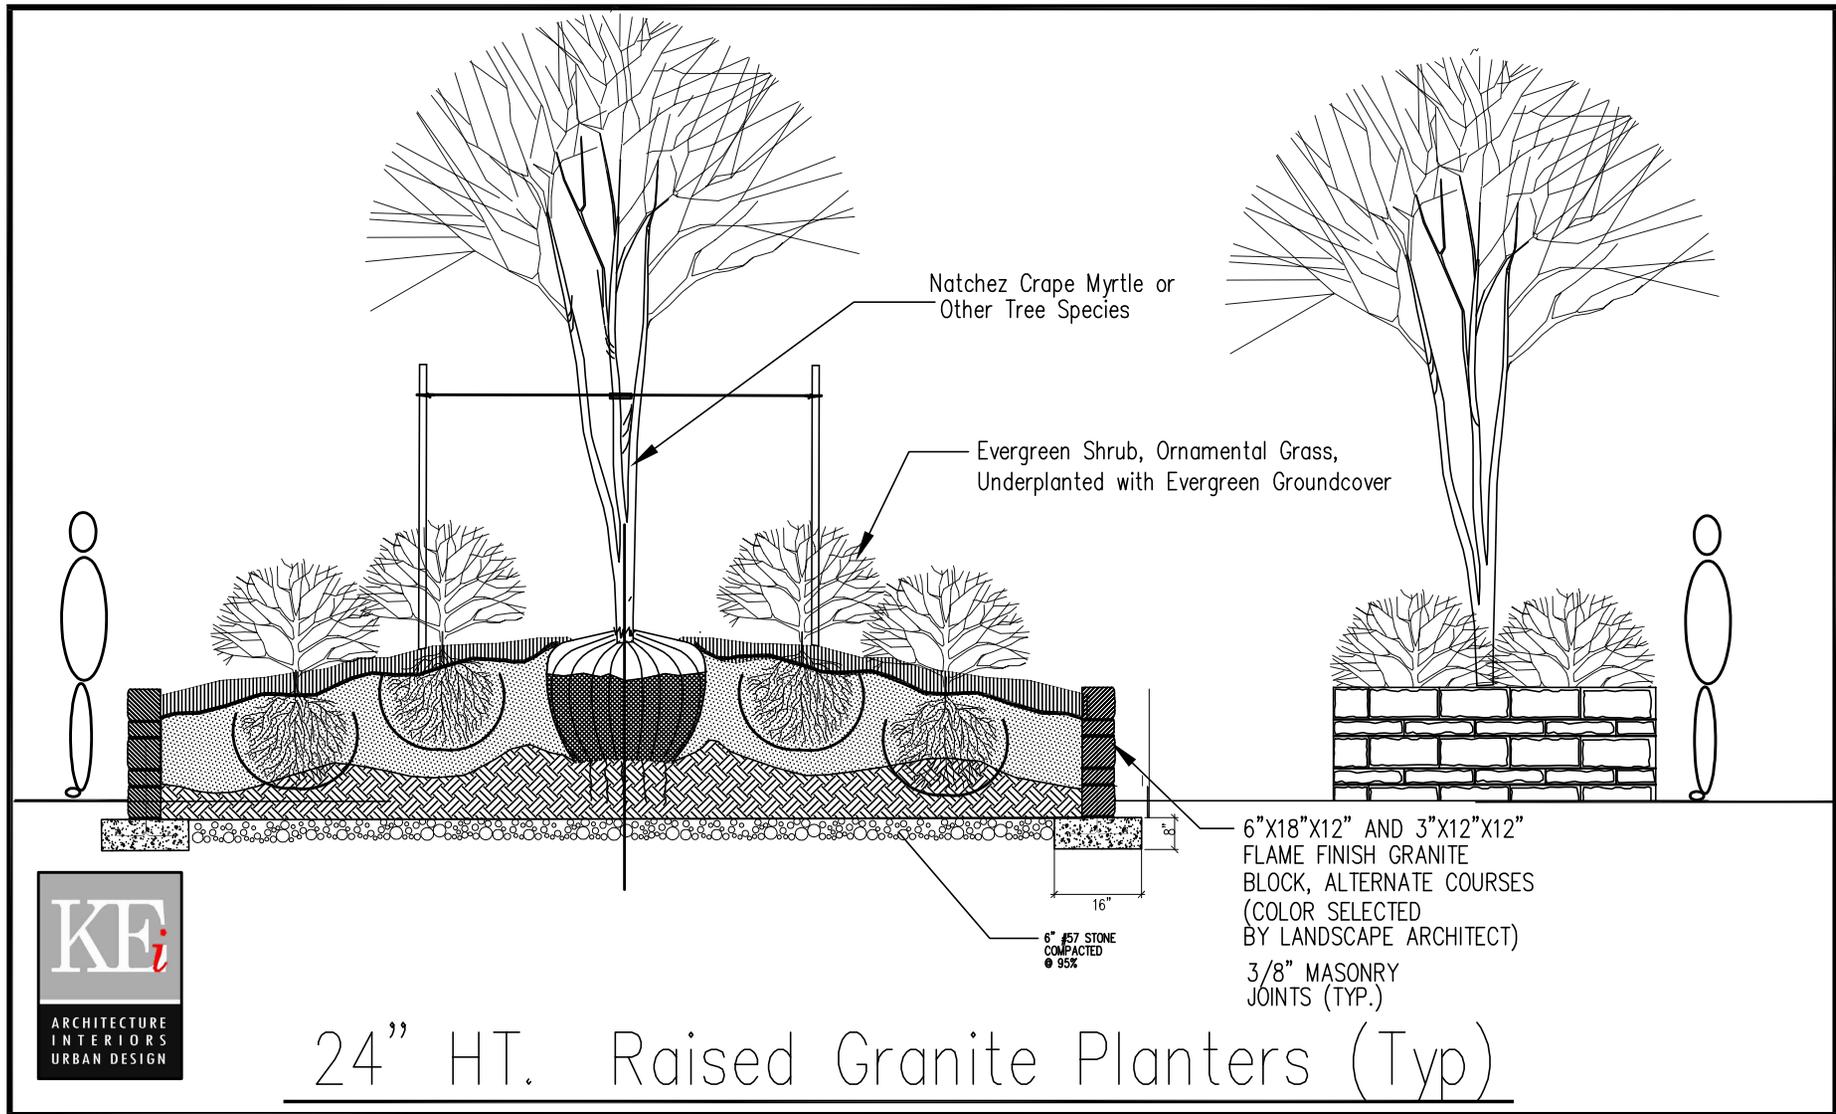

Snead Associates, P.C.
Landscape Architecture
Land Use Planning
8005 Creighton Pkwy #703
Mechanicsville, VA 23111
804-240-7823
sneadassociates@aol.com

**Design Development
for
Kanawha Plaza
Improvements**

Date: 03-19-2015
Scale: ----
Designed By: ----
Drawn By: ----
Checked By: C.G. Snead
Project Number: ----

Sheet Number:
of



Transmittal

Lighting Virginia-Central
 400 G2 Southlake Blvd.
 Richmond VA 23236
 Phone: (804) 379-7777
From: Diana Ades

Project Kanawha Plaza
Quote# LV - CENTRAL15-17875
Location Richmond VA
 Contact:

ATTACHED WE ARE SENDING YOU 1 COPIES OF THE FOLLOWING ITEMS:

- | | | |
|-----------------------------------|--|--------|
| <input type="checkbox"/> Drawings | <input checked="" type="checkbox"/> Specifications | Other: |
| <input type="checkbox"/> Prints | <input type="checkbox"/> Information | |
| <input type="checkbox"/> Plans | <input type="checkbox"/> Submittals | |

THESE ARE TRANSMITTED FOR:

- | | | |
|--|---|---------------------------------|
| <input type="checkbox"/> Prior Approval | <input type="checkbox"/> Resubmittal for Approval | <input type="checkbox"/> Record |
| <input type="checkbox"/> Approval | <input type="checkbox"/> Corrections | Bids due on: |
| <input type="checkbox"/> Approval as Submitted | <input checked="" type="checkbox"/> Your Use | Other: |
| <input type="checkbox"/> Approval as Noted | <input type="checkbox"/> Review and Comment | |

Qty	Type	MFG	Part
6	A3	Kim Lighting	1A-RA25-3-E35-120L-3K-X-PS-LS/ HA11L-TM1
6	A4	Kim Lighting	1A-RA25-4-E35-120L-3K-X-PS-LS/ HA11L-TM1
12	B	ERCO	34124.023 / POLE BRACKET
12	A POLE	American Lite Pole	RNA-20-45-7-AB-PC(PS)-T20R
22	C2	Kim Lighting	1SA-RA17-2-E35-60L-3K-X-PS-LS/ HA11S-TM1
22	C POLE	American Lite Pole	RNA-14-45-7-AB-PC(PS)-T20R
13	L	Misc. Vendor	SCHREDER BOR-LHP3200-MT-XX- XXX-RAL(SILVER)/A114-1-59
13	L POLE	American Lite Pole	RNA-12-45-7-AB-PC(PS)-T20R
40	S	C W COLE & COMPANY, INC.	L606W-AL
110	T	Vision3 Lighting	IG3B-XX-118-0-0-0
10	T XFMR	Vision3 Lighting	XM2-XXX-120-X

Submitted by Lighting Virginia-Central



Job Name:
Kanawha Plaza

Catalog Number:
1A-RA25-3-E35-120L-3K-X-PS-LS/
HA11L-TM1
Notes:


Type:
A3

LV - CENTRAL15-17875



Era[®]

Heritage Style Luminaire

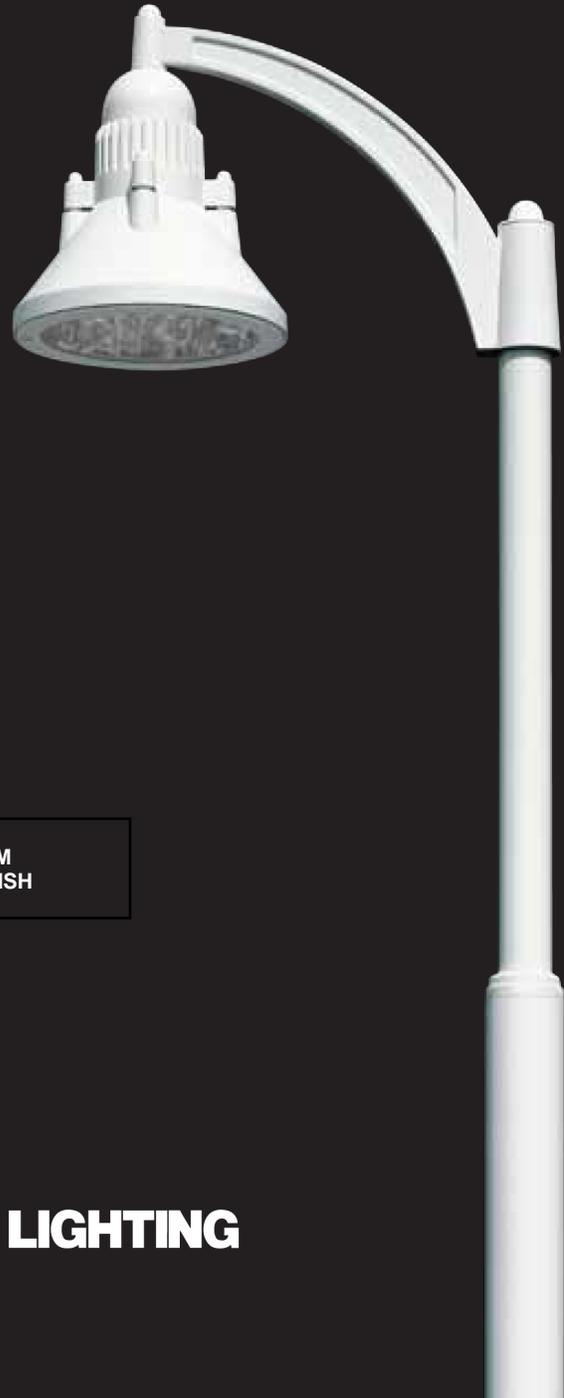

PLATINUM
SILVER FINISH





Job Name:
Kanawha Plaza

Catalog Number:

1A-RA25-3-E35-120L-3K-X-PS-LS/
HA11L-TM1

Notes:

Type:

A3

LV - CENTRAL15-17875



KIM LIGHTING

RA25

25" Era[®] PicoEmitter[™] LED

revision 9/10/14 • kl_ra25eled_spec.pdf

Type:

Job:

Catalog number:

/ / / / /
 Mtg Fixture Electrical Module Finish Options Pole & Arm*
 See page 2 See page 3


*Select pole and arm from Kim **Arms and Poles Selection Guide**. If pole is provided by others, indicate O.D. for arm fitting. Arm Options are also shown on page 4.

Approvals:

Date:
Page: 1 of 6

Specifications

25" Diameter
120 Light Emitting Diodes
Total System Watts = 126W

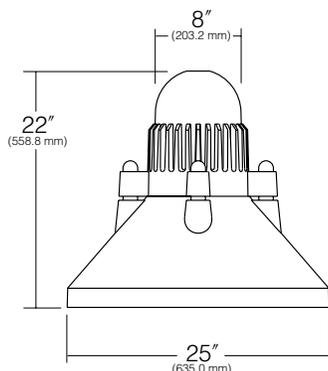

The Ballast Housing is a one-piece die-cast, low copper (<0.6% Cu) aluminum alloy component with integral cooling fins. The Reflector Housing is one-piece die-cast, low copper (<0.6% Cu) aluminum alloy. The Ballast Housing attaches to the Reflector Housing with stainless steel fasteners and is sealed with a silicone gasket.

One-piece die-cast, low copper (<0.6% Cu) aluminum alloy. Stainless steel hinges provided for attachment to the Reflector Housing. Stainless steel threaded fasteners provide easy access, concealed from normal view. The 3/16" thick clear flat lens seals against the reflector flange by a one-piece extruded silicone gasket with fused seam, to produce a fully sealed optical chamber.

Stainless steel bolts are provided to attach the luminaire to the crook arm or swept arm mounting.

All electrical components are UL and CSA recognized, mounted on a single plate and factory prewired with quick-disconnect plugs. Module includes a driver, LifeShield[™] temperature control device and surge protector. Electrical module attaches to housing with key hole slots, accessible by opening the lens frame and removing optical module. Driver is rated for -40°F starting and has a 0-10V dimming interface for multi-level illumination options.

Precision, replaceable PicoEmitters are positioned to achieve directional control toward desired task. The entire EmitterDeck[®] fastens to the housing as a one-piece module.

TGIC thermoset polyester powder coat paint, 2.5 mil nominal thickness. Standard colors are Black, Dark Bronze, Light Gray, Stealth Gray[™], Platinum Silver, or White. Custom colors are available.

Listed To: UL 1598 Standard for Luminaires - UL 8750 Standard for Safety for Light Emitting Diode (LED) Equipment for use in Lighting Products and CSA C22.2#250.0 Luminaires.

Kim Lighting warrants Era LED products ("Product(s)") sold by Kim Lighting to be free from defects in material and workmanship for (i) a period of five (5) years for metal parts, (ii) a period of ten (10) years for exterior housing paint finish(s), (iii) a period of six (6) years for LED Light Engines (PicoEmitter reflectors) and, (iv) a period of five (5) years for LED power components (LED Driver, LifeShield[®] temperature control device, surge protector), from the date of sale of such goods to the buyer as specified in Kim Lighting shipment documents for each product.

Fixtures must be grounded in accordance with national, state and/or local electrical codes. Failure to do so may result in serious injury.

KIM LIGHTING RESERVES THE RIGHT TO CHANGE SPECIFICATIONS WITHOUT NOTICE.



HUBBELL LIGHTING, INC.

U.S. Patent D430,687



Job Name:
Kanawha Plaza

Catalog Number:

1A-RA25-3-E35-120L-3K-X-PS-LS/
HA11L-TM1

Notes:

Type:

A3

LV - CENTRAL15-17875



KIM LIGHTING

RA25

25" Era® PicoEmitter™ LED

revision 9/10/14 • kl_ra25eled_spec.pdf

Type:

Job:

Page: 2 of 6



Standard Features

Mounting

Plan View:



EPA 25":

1.5

3.0

4.5

5.2

N/A

Cat. No.:

1A

2B

3Y

4C

1W

NOTE: 1A, 2B, 3Y and 4C mounting arms are part of the Pole Assembly. **1W** Wall Mount arm is **not** included and must be ordered separately. See page 4 for styles and ordering information.

Fixture

Cat. No. designates fixture and optic



x

Distribution:

1 = Type I Full Cutoff

2 = Type II Full Cutoff

3 = Type III Full Cutoff

4 = Type IV Full Cutoff

5 = Type V Square Full Cutoff

L = Type L Left Full Cutoff


R = Type R Right Full Cutoff

E35

E35 = 350mA

Electrical Module

Cat. Nos. for Electrical Modules available:

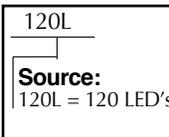

xK

Color Temperature:

3K = 3000K

4K = 4200K

5K = 5100K

2K = 580nm - Amber

x

Voltage:

120 = 120V

208 = 208V

240 = 240V

277 = 277V

347 = 347V

480 = 480V

SELECT VOLTAGE

Finish

TGIC powder coat

Color: Black Dark Bronze Light Gray Stealth Gray Platinum Silver White Custom Color¹

Cat. No.: **BL** **DB** **LG** **SG** **PS** **WH** **CC**

¹Custom colors subject to additional charges, minimum quantities and extended lead times. Consult representative. Custom color description: _____

0-10V Dimming Interface

Driver has a 0-10V dimming interface with a dimming range of 10-100%. Is compatible with most control systems including Hubbell Building Automation wiHUBB™. Approved dimmers include Lutron Diva AVTV, Lutron Nova NFTV and NTFTV. Note: Not compatible with current sourcing dimmers. Controls compatible via Gray and Purple dimming lead.





Job Name:
Kanawha Plaza

Catalog Number:
1A-RA25-3-E35-120L-3K-X-PS-LS/
HA11L-TM1

Notes:

Type:

A3

LV - CENTRAL15-17875



RA25
25" Era® PicoEmitter™ LED
revision 9/10/14 • kl_ra25eled_spec.pdf

Type:

Job:

Page: 5 of 6



Arm Options

Arms **Note:** Wall mount arm is **not** included and must be ordered separately. Refer to Kim Lighting's Arms and Poles Selection Guide for complete details.

Mtg.	Post Top Crook			Side Pole Crook			Post Top Swept Cast Arm		
	Arm	Tenon Mt.	Wall Mt.	Arm	Tenon Mt.	Wall Mt.	Arm	Tenon Mt.	Wall Mt.
1A	<input type="checkbox"/> HA01L	<input type="checkbox"/> HA01L-TM1	—	<input type="checkbox"/> HA02L	<input type="checkbox"/> HA02L-TM1	<input type="checkbox"/> HA02S-W	<input type="checkbox"/> HA03L	<input type="checkbox"/> HA03L-TM1	—
2B	—	—	—	—	<input type="checkbox"/> HA02L-TM2	—	—	<input type="checkbox"/> HA03L-TM2	—
3Y	—	—	—	—	<input type="checkbox"/> HA02L-TM3	—	—	<input type="checkbox"/> HA03L-TM3	—
4C	—	—	—	—	<input type="checkbox"/> HA02L-TM4	—	—	<input type="checkbox"/> HA03L-TM4	—

Mtg.	Side Pole Swept Cast Arm			Side Pole S-Shaped Up Cast Arm		
	Arm	Tenon Mt.	Wall Mt.	Arm	Tenon Mt.	Wall Mt.
1A	<input type="checkbox"/> HA11L	<input type="checkbox"/> HA11L-TM1	<input type="checkbox"/> HA11L-W	<input type="checkbox"/> HA12L	<input type="checkbox"/> HA12L-TM1	<input type="checkbox"/> HA12L-W
2B	—	<input type="checkbox"/> HA11L-TM2	—	—	<input type="checkbox"/> HA12L-TM2	—
3Y	—	<input type="checkbox"/> HA11L-TM3	—	—	<input type="checkbox"/> HA12L-TM3	—
4C	—	<input type="checkbox"/> HA11L-TM4	—	—	<input type="checkbox"/> HA12L-TM4	—

Mtg.	Side Pole Neo-Classic Arm			Side Pole Arm w/Top Scroll			Side Pole Ribbon Arm w/Top Gusset		
	Arm	Tenon Mt.	Wall Mt.	Arm	Tenon Mt.	Wall Mt.	Arm	Tenon Mt.	Wall Mt.
1A	<input type="checkbox"/> HA14L	<input type="checkbox"/> HA14L-TM1	<input type="checkbox"/> HA14L-W	<input type="checkbox"/> HA31L	<input type="checkbox"/> HA31L-TM1	<input type="checkbox"/> HA31L-W	<input type="checkbox"/> HA33L	<input type="checkbox"/> HA33L-TM1	<input type="checkbox"/> HA33L-W
2B	—	<input type="checkbox"/> HA14L-TM2	—	—	<input type="checkbox"/> HA31L-TM2	—	—	<input type="checkbox"/> HA33L-TM2	—
3Y	—	<input type="checkbox"/> HA14L-TM3	—	—	<input type="checkbox"/> HA31L-TM3	—	—	<input type="checkbox"/> HA33L-TM3	—
4C	—	<input type="checkbox"/> HA14L-TM4	—	—	<input type="checkbox"/> HA31L-TM4	—	—	<input type="checkbox"/> HA33L-TM4	—

Mtg.	Side Pole Ribbon Arm w/Top Brace			Side Pole Ribbon Arm w/Top Brace & Bottom Scroll			Side Pole Ribbon Arm w/Top Brace & Bottom Gusset		
	Arm	Tenon Mt.	Wall Mt.	Arm	Tenon Mt.	Wall Mt.	Arm	Tenon Mt.	Wall Mt.
1A	<input type="checkbox"/> HA35L	<input type="checkbox"/> HA35L-TM	<input type="checkbox"/> HA35L-W	<input type="checkbox"/> HA37L	<input type="checkbox"/> HA37L-TM	<input type="checkbox"/> HA37L-W	<input type="checkbox"/> HA38L	<input type="checkbox"/> HA38L-TM	<input type="checkbox"/> HA38L-W
		Consult factory for other mtgs.	Consult factory for other mtgs.		Consult Factory for other mtgs	Consult Factory for other mtgs		Consult Factory for other mtgs	Consult Factory for other mtgs

Arm Finial: HAF2 - Traditional style finial available to close off mounting hub opposite the fixture.
 *Not available on arm where indicated.





Job Name:
Kanawha Plaza

Catalog Number:

1A-RA25-3-E35-120L-3K-X-PS-LS/
HA11L-TM1

Notes:

Type:

A3

LV - CENTRAL15-17875



KIM LIGHTING

RA25

25" Era® PicoEmitter™ LED
revision 9/10/14 • kl_ra25eled_spec.pdf

Type:

Job:

Page: 6 of 6



Lumen Performance Charts

Spectroradiometric			
	3000K Average	4200K Average	5100K Average
Correlated Color Temp. CCT (K)	2800K-3175K	3800K-4600K	4600K-5600K
Color Rendering Index (CRI)	≤80	≤80	≤70
Power Factor	>.90	>.90	>.90

Projected Lumen Maintenance		
mA	100,000 hrs	(Calculated L70)
350	93.96%	675,000 Hrs.

Electrical Drive Current		
Volts - AC	Amps - AC	System Watts
120	1.05	126
208	0.61	126
240	0.53	126
277	0.45	126
347	0.36	126
480	0.26	126

B.U.G. Rating (TM15) in Lumens when B = Backlight, U = Uplight, G = Glare								
Temperature	TYPE 1	TYPE 2	TYPE 3	TYPE 3 NFO	TYPE 4	TYPE 4 NFO	TYPE 5	TYPE L/R
3000K	TBD	B2 U0 G2	B2 U0 G2	B1 U0 G2	B1 U0 G2	B1 U0 G2	B3 U0 G1	TBD
4200K	TBD	B3 U0 G3	B2 U0 G2	B2 U0 G2	B1 U0 G2	B1 U0 G2	B3 U0 G2	TBD
5100K	TBD	B3 U0 G3	B2 U0 G2	B2 U0 G2	B1 U0 G2	B1 U0 G2	B3 U0 G2	TBD

Absolute Lumens								
Temperature	TYPE 1	TYPE 2	TYPE 3	TYPE 3 NFO	TYPE 4	TYPE 4 NFO	TYPE 5	TYPE L/R
3000K	TBD	8181	7999	6556	7970	6670	8438	TBD
4200K	TBD	10298	10070	8253	10034	8397	10622	TBD
5100K	TBD	11296	11046	9053	11006	9210	11651	TBD

LED performance and lumen output continues to improve at a rapid pace. Log onto www.kimlighting.com to download the most current photometric files from Kim Lighting's IES File Library. For custom optics and color temperature configurations, contact factory.

Submitted by Lighting Virginia-Central



Job Name:
Kanawha Plaza

Catalog Number:

1A-RA25-4-E35-120L-3K-X-PS-LS/
HA11L-TM1

Notes:

Type:

A4

LV - CENTRAL15-17875



RA
SERIES

Era[®]

Heritage Style Luminaire



PLATINUM
SILVER FINISH



KIM LIGHTING



Job Name:
Kanawha Plaza

Catalog Number:

1A-RA25-4-E35-120L-3K-X-PS-LS/
HA11L-TM1

Notes:

Type:

A4

LV - CENTRAL15-17875



KIM LIGHTING

RA25

25" Era[®] PicoEmitter[™] LED

revision 9/10/14 • kl_ra25eled_spec.pdf

Type:

Job:

Catalog number:

/ / / / /
 Mtg Fixture Electrical Module Finish Options
 See page 2 See page 3 Pole & Arm*


*Select pole and arm from Kim **Arms and Poles Selection Guide**. If pole is provided by others, indicate O.D. for arm fitting. Arm Options are also shown on page 4.

Approvals:

Date:
Page: 1 of 6

Specifications

25" Diameter
120 Light Emitting Diodes
Total System Watts = 126W

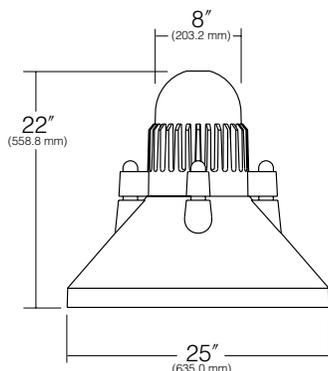

The Ballast Housing is a one-piece die-cast, low copper (<0.6% Cu) aluminum alloy component with integral cooling fins. The Reflector Housing is one-piece die-cast, low copper (<0.6% Cu) aluminum alloy. The Ballast Housing attaches to the Reflector Housing with stainless steel fasteners and is sealed with a silicone gasket.

One-piece die-cast, low copper (<0.6% Cu) aluminum alloy. Stainless steel hinges provided for attachment to the Reflector Housing. Stainless steel threaded fasteners provide easy access, concealed from normal view. The 3/16" thick clear flat lens seals against the reflector flange by a one-piece extruded silicone gasket with fused seam, to produce a fully sealed optical chamber.

Stainless steel bolts are provided to attach the luminaire to the crook arm or swept arm mounting.

All electrical components are UL and CSA recognized, mounted on a single plate and factory prewired with quick-disconnect plugs. Module includes a driver, LifeShield[™] temperature control device and surge protector. Electrical module attaches to housing with key hole slots, accessible by opening the lens frame and removing optical module. Driver is rated for -40°F starting and has a 0-10V dimming interface for multi-level illumination options.

Precision, replaceable PicoEmitters are positioned to achieve directional control toward desired task. The entire EmitterDeck[®] fastens to the housing as a one-piece module.

TGIC thermoset polyester powder coat paint, 2.5 mil nominal thickness. Standard colors are Black, Dark Bronze, Light Gray, Stealth Gray[™], Platinum Silver, or White. Custom colors are available.

Listed To: UL 1598 Standard for Luminaires - UL 8750 Standard for Safety for Light Emitting Diode (LED) Equipment for use in Lighting Products and CSA C22.2#250.0 Luminaires.

Kim Lighting warrants Era LED products ("Product(s)") sold by Kim Lighting to be free from defects in material and workmanship for (i) a period of five (5) years for metal parts, (ii) a period of ten (10) years for exterior housing paint finish(s), (iii) a period of six (6) years for LED Light Engines (PicoEmitter reflectors) and, (iv) a period of five (5) years for LED power components (LED Driver, LifeShield[®] temperature control device, surge protector), from the date of sale of such goods to the buyer as specified in Kim Lighting shipment documents for each product.

Fixtures must be grounded in accordance with national, state and/or local electrical codes. Failure to do so may result in serious injury.



HUBBELL LIGHTING, INC.

U.S. Patent D430,687

KIM LIGHTING RESERVES THE RIGHT TO CHANGE SPECIFICATIONS WITHOUT NOTICE.



Job Name:
Kanawha Plaza

Catalog Number:
1A-RA25-4-E35-120L-3K-X-PS-LS/
HA11L-TM1
Notes:

Type:
A4
LV - CENTRAL15-17875



RA25
25" Era® PicoEmitter™ LED
revision 9/10/14 • kl_ra25eled_spec.pdf

Type:
Job:

Page: 2 of 6



Standard Features

Mounting

Plan View:

EPA 25": 1.5 3.0 4.5 5.2 N/A

Cat. No.: **1A** **2B** **3Y** **4C** **1W**

NOTE: 1A, 2B, 3Y and 4C mounting arms are part of the Pole Assembly. 1W Wall Mount arm is **not** included and must be ordered separately. See page 4 for styles and ordering information.

Fixture

Cat. No. designates fixture and optic

RA25
Housing Size: 25"

x

E35
E35 = 350mA

Distribution:

- 1 = Type I Full Cutoff
- 2 = Type II Full Cutoff
- 3 = Type III Full Cutoff
- 4 = Type IV Full Cutoff
- 5 = Type V Square Full Cutoff
- L = Type L Left Full Cutoff
- R = Type R Right Full Cutoff

Electrical Module

Cat. Nos. for Electrical Modules available:

120L
Source:
120L = 120 LED's

xK
Color Temperature:

- 3K = 3000K
- 4K = 4200K
- 5K = 5100K
- 2K = 580nm - Amber

x
Voltage:

- 120 = 120V
- 208 = 208V
- 240 = 240V
- 277 = 277V
- 347 = 347V
- 480 = 480V

SELECT VOLTAGE

Finish

TGIC powder coat

Color: Black Dark Bronze Light Gray Stealth Gray Platinum Silver White Custom Color¹

Cat. No.: BL DB LG SG PS WH CC

¹Custom colors subject to additional charges, minimum quantities and extended lead times. Consult representative. Custom color description: _____

0-10V Dimming Interface

Driver has a 0-10V dimming interface with a dimming range of 10-100%. Is compatible with most control systems including Hubbell Building Automation wiHUBB™. Approved dimmers include Lutron Diva AVTV, Lutron Nova NFTV and NTFTV. Note: Not compatible with current sourcing dimmers. Controls compatible via Gray and Purple dimming lead.





Job Name:
Kanawha Plaza

Catalog Number:
1A-RA25-4-E35-120L-3K-X-PS-LS/
HA11L-TM1

Notes:

Type:

A4

LV - CENTRAL15-17875



RA25
25" Era® PicoEmitter™ LED
revision 9/10/14 • kl_ra25eled_spec.pdf

Type:

Job:

Page: 5 of 6



Arm Options

Arms **Note:** Wall mount arm is **not** included and must be ordered separately. Refer to Kim Lighting's Arms and Poles Selection Guide for complete details.

Mtg.	Post Top Crook			Side Pole Crook			Post Top Swept Cast Arm		
	Arm	Tenon Mt.	Wall Mt.	Arm	Tenon Mt.	Wall Mt.	Arm	Tenon Mt.	Wall Mt.
1A	<input type="checkbox"/> HA01L	<input type="checkbox"/> HA01L-TM1	—	<input type="checkbox"/> HA02L	<input type="checkbox"/> HA02L-TM1	<input type="checkbox"/> HA02S-W	<input type="checkbox"/> HA03L	<input type="checkbox"/> HA03L-TM1	—
2B	—	—	—	—	<input type="checkbox"/> HA02L-TM2	—	—	<input type="checkbox"/> HA03L-TM2	—
3Y	—	—	—	—	<input type="checkbox"/> HA02L-TM3	—	—	<input type="checkbox"/> HA03L-TM3	—
4C	—	—	—	—	<input type="checkbox"/> HA02L-TM4	—	—	<input type="checkbox"/> HA03L-TM4	—

Mtg.	Side Pole Swept Cast Arm			Side Pole S-Shaped Up Cast Arm		
	Arm	Tenon Mt.	Wall Mt.	Arm	Tenon Mt.	Wall Mt.
1A	<input type="checkbox"/> HA11L	<input type="checkbox"/> HA11L-TM1	<input type="checkbox"/> HA11L-W	<input type="checkbox"/> HA12L	<input type="checkbox"/> HA12L-TM1	<input type="checkbox"/> HA12L-W
2B	—	<input type="checkbox"/> HA11L-TM2	—	—	<input type="checkbox"/> HA12L-TM2	—
3Y	—	<input type="checkbox"/> HA11L-TM3	—	—	<input type="checkbox"/> HA12L-TM3	—
4C	—	<input type="checkbox"/> HA11L-TM4	—	—	<input type="checkbox"/> HA12L-TM4	—

Mtg.	Side Pole Neo-Classic Arm			Side Pole Arm w/Top Scroll			Side Pole Ribbon Arm w/Top Gusset		
	Arm	Tenon Mt.	Wall Mt.	Arm	Tenon Mt.	Wall Mt.	Arm	Tenon Mt.	Wall Mt.
1A	<input type="checkbox"/> HA14L	<input type="checkbox"/> HA14L-TM1	<input type="checkbox"/> HA14L-W	<input type="checkbox"/> HA31L	<input type="checkbox"/> HA31L-TM1	<input type="checkbox"/> HA31L-W	<input type="checkbox"/> HA33L	<input type="checkbox"/> HA33L-TM1	<input type="checkbox"/> HA33L-W
2B	—	<input type="checkbox"/> HA14L-TM2	—	—	<input type="checkbox"/> HA31L-TM2	—	—	<input type="checkbox"/> HA33L-TM2	—
3Y	—	<input type="checkbox"/> HA14L-TM3	—	—	<input type="checkbox"/> HA31L-TM3	—	—	<input type="checkbox"/> HA33L-TM3	—
4C	—	<input type="checkbox"/> HA14L-TM4	—	—	<input type="checkbox"/> HA31L-TM4	—	—	<input type="checkbox"/> HA33L-TM4	—

Mtg.	Side Pole Ribbon Arm w/Top Brace			Side Pole Ribbon Arm w/Top Brace & Bottom Scroll			Side Pole Ribbon Arm w/Top Brace & Bottom Gusset		
	Arm	Tenon Mt.	Wall Mt.	Arm	Tenon Mt.	Wall Mt.	Arm	Tenon Mt.	Wall Mt.
1A	<input type="checkbox"/> HA35L	<input type="checkbox"/> HA35L-TM	<input type="checkbox"/> HA35L-W	<input type="checkbox"/> HA37L	<input type="checkbox"/> HA37L-TM	<input type="checkbox"/> HA37L-W	<input type="checkbox"/> HA38L	<input type="checkbox"/> HA38L-TM	<input type="checkbox"/> HA38L-W
		Consult factory for other mtgs.	Consult factory for other mtgs.		Consult Factory for other mtgs	Consult Factory for other mtgs		Consult Factory for other mtgs	Consult Factory for other mtgs

Arm Finial: HAF2 - Traditional style finial available to close off mounting hub opposite the fixture.
 *Not available on arm where indicated.





Job Name:
Kanawha Plaza

Catalog Number:

1A-RA25-4-E35-120L-3K-X-PS-LS/
HA11L-TM1

Notes:

Type:

A4

LV - CENTRAL15-17875



KIM LIGHTING

RA25

25" Era[®] PicoEmitter[™] LED
revision 9/10/14 • kl_ra25eled_spec.pdf

Type:

Job:

Page: 6 of 6



Lumen Performance Charts

Spectroradiometric			
	3000K Average	4200K Average	5100K Average
Correlated Color Temp. CCT (K)	2800K-3175K	3800K-4600K	4600K-5600K
Color Rendering Index (CRI)	≤80	≤80	≤70
Power Factor	>.90	>.90	>.90

Projected Lumen Maintenance		
mA	100,000 hrs	(Calculated L70)
350	93.96%	675,000 Hrs.

Electrical Drive Current		
Volts - AC	Amps - AC	System Watts
120	1.05	126
208	0.61	126
240	0.53	126
277	0.45	126
347	0.36	126
480	0.26	126






B.U.G. Rating (TM15) in Lumens when B = Backlight, U = Uplight, G = Glare								
Temperature	TYPE 1	TYPE 2	TYPE 3	TYPE 3 NFO	TYPE 4	TYPE 4 NFO	TYPE 5	TYPE L/R
3000K	TBD	B2 U0 G2	B2 U0 G2	B1 U0 G2	B1 U0 G2	B1 U0 G2	B3 U0 G1	TBD
4200K	TBD	B3 U0 G3	B2 U0 G2	B2 U0 G2	B1 U0 G2	B1 U0 G2	B3 U0 G2	TBD
5100K	TBD	B3 U0 G3	B2 U0 G2	B2 U0 G2	B1 U0 G2	B1 U0 G2	B3 U0 G2	TBD

Absolute Lumens								
Temperature	TYPE 1	TYPE 2	TYPE 3	TYPE 3 NFO	TYPE 4	TYPE 4 NFO	TYPE 5	TYPE L/R
3000K	TBD	8181	7999	6556	7970	6670	8438	TBD
4200K	TBD	10298	10070	8253	10034	8397	10622	TBD
5100K	TBD	11296	11046	9053	11006	9210	11651	TBD

LED performance and lumen output continues to improve at a rapid pace. Log onto www.kimlighting.com to download the most current photometric files from Kim Lighting's IES File Library. For custom optics and color temperature configurations, contact factory.

ERCO

Gecko Floodlight

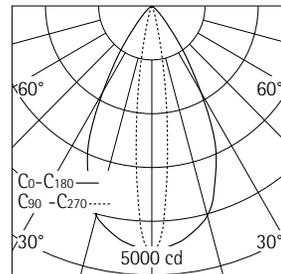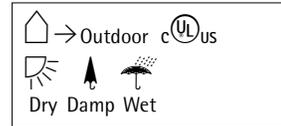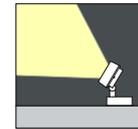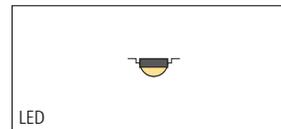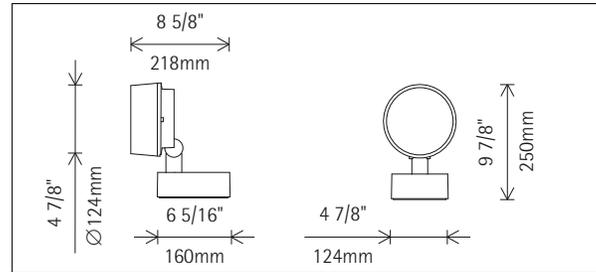

LED 18W 1800lm 3000K warm white

h(ft)	E(fc)	D	
		C0	C90
		55°	15°
3	509	3'1"	0'9"
6	127	6'3"	1'7"
9	57	9'4"	2'4"
12	32	12'6"	3'2"
15	20	15'7"	3'11"

34124.023 Graphit m
 LED 18W 1800lm 3000K warm white
 Dimmable
 Version 7
 Connected load 22W
 Spherolit lens, oval flood

Product description

Housing, hinge and mounting plate: corrosion-resistant, cast aluminum, No-Rinse surface treatment. Double powder-coated. Optimized surface for reduced accumulation of dirt. Hinge with scale and internal wiring. Housing 130° tilttable, rotatable through 360°.

Electronic control gear, 60Hz, 120V dimmable, 277V switchable. 2 cable entries. Through-wiring possible. 3-pole terminal block.

LED module: high-power LEDs on metal-core PCB. SDCM<2. CRI>90. L80/B10 50000h. Collimating lens made of optical polymer. Lens rotatable through 360°.

Compact light head with non-reflecting safety glass. Corrosion-resistant cast aluminum, double powder-coated. Suitable for wet location (IP65): dust-proof and water jet-proof.

120V: Dimming with external dimmers possible (trailing edge).

Weight 5.51lbs / 2.50kg

Available from 2nd quarter 2015

ERCO Lighting Inc.
 160 Raritan Center Parkway
 Suite 10
 Edison, NJ 08837
 USA
 Tel.: +1 732 225 8856
 Fax: +1 732 225 8857
 info.us@erco.com


Technical region: 120V/60Hz, 277V/60Hz

We reserve the right to make technical and design changes.

Edition: 25.02.2015

Current version under

www.erco.com/34124.023

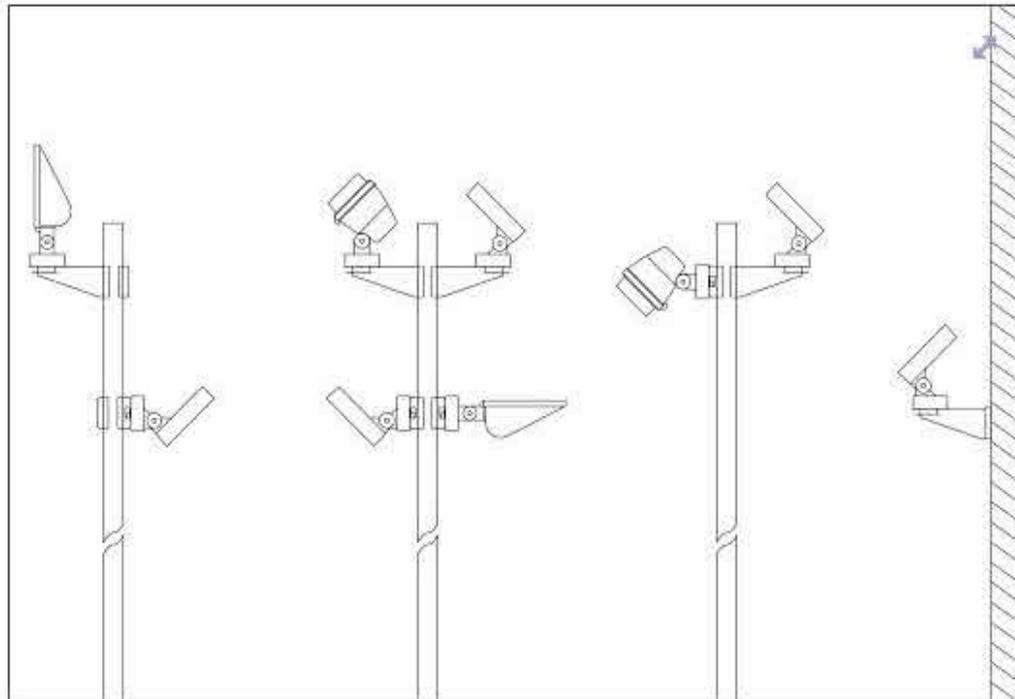

Flexible infrastructure

An entirely re-defined range of accessories for projectors, floodlights and wallwashers in the outdoor area features a practical clamping mechanism to ensure mounting without drilling into the poles. The clamping plate is suitable for dimensions with a diameter of 60-89mm. It is used to attach the attachment for direct mounting of the luminaire on the pole or for the traverse to fix luminaires tilting backwards. The traverse may also be attached directly to walls or façades. The accessories are suitable for all fixture sizes of Lightscan, Beamer and Parscoop.

Submitted by Lighting Virginia-Central



Job Name:
Kanawha Plaza

Catalog Number:
1SA-RA17-2-E35-60L-3K-X-PS-LS/
HA11S-TM1
Notes:

Type:
C2

LV - CENTRAL15-17875





Job Name:
Kanawha Plaza

Catalog Number:

1SA-RA17-2-E35-60L-3K-X-PS-LS/
HA11S-TM1

Notes:

Type:

C2

LV - CENTRAL15-17875



KIM LIGHTING

RA17

17" Era® PicoEmitter™ LED
revision 9/10/14 • kl_ra17eled_spec.pdf

Type:

Job:

Catalog number:

/ / / / /
 Mtg Fixture Electrical Module Finish Options
 See page 2 See page 3-4 Pole & Arm*

*Select pole and arm from Kim **Arms and Poles Selection Guide**. If pole is provided by others, indicate O.D. for arm fitting. Arm Options are also shown on page 5.


Approvals:

Date:

Page: 1 of 6

Specifications

17" Diameter
60 Light Emitting Diodes
Total System Watts = 68W

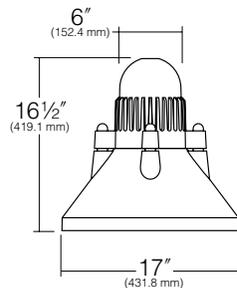

Housing: The Ballast Housing is a one-piece die-cast, low copper (<0.6% Cu) aluminum alloy component with integral cooling fins. The Reflector Housing is one-piece die-cast, low copper (<0.6% Cu) aluminum alloy. The Ballast Housing attaches to the Reflector Housing with stainless steel fasteners and is sealed with a silicone gasket.

Lens Frame: One-piece die-cast, low copper (<0.6% Cu) aluminum alloy. Stainless steel hinges provided for attachment to the Reflector Housing. Stainless steel threaded fasteners provide easy access, concealed from normal view. The 3/16" thick clear flat lens seals against the reflector flange by a one-piece extruded silicone gasket with fused seam, to produce a fully sealed optical chamber.

Mounting: Stainless steel bolts are provided to attach the luminaire to the crook arm or swept arm mounting.

Electronic Module: All electrical components are UL and CSA recognized, mounted on a single plate and factory prewired with quick-disconnect plugs. Module includes a driver, LifeShield® temperature control device and surge protector. Electrical module attaches to housing with key hole slots, accessible by opening the lens frame and removing optical module. Driver is rated for -40°F starting and has a 0-10V dimming interface for multi-level illumination options.

Optical Module: Precision, replaceable PicoEmitters are positioned to achieve directional control toward desired task. The entire EmitterDeck® mounting assembly fastens to the housing as a one-piece module.

Finish/Color: TGIC thermoset polyester powder coat paint, 2.5 mil nominal thickness. Standard colors are Black, Dark Bronze, Light Gray, Stealth Gray, Platinum Silver, or White. Custom colors are available.

Listed To: UL 1598 Standard for Luminaires - UL 8750 Standard for Safety for Light Emitting Diode (LED) Equipment for use in Lighting Products and CSA C22.2#250.0 Luminaires.

Warranty: Kim Lighting warrants Era LED products ("Product(s)") sold by Kim Lighting to be free from defects in material and workmanship for (i) a period of five (5) years for metal parts, (ii) a period of ten (10) years for exterior housing paint finish(s), (iii) a period of six (6) years for LED Light Engines (PicoEmitter®) and, (iv) a period of five (5) years for LED power components (LED Driver, LifeShield temperature control device, surge protector), from the date of sale of such goods to the buyer as specified in Kim Lighting shipment documents for each product.

CAUTION: Fixtures must be grounded in accordance with national, state and/or local electrical codes. Failure to do so may result in serious injury.



HUBBELL LIGHTING, INC.

U.S. Patent D430,687

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Job Name:
Kanawha Plaza

Catalog Number:
1SA-RA17-2-E35-60L-3K-X-PS-LS/
HA11S-TM1
Notes:

Type:
C2
LV - CENTRAL15-17875



RA17
17" Era® PicoEmitter™ LED
revision 9/10/14 • kl_ra17eled_spec.pdf

Type:

Job:

Page: 2 of 6



Standard Features

Mounting

Plan View:

EPA 17": 0.8	1.6	2.4	2.8	n/a
Cat. No.: <input type="checkbox"/> 1A	<input type="checkbox"/> 2B	<input type="checkbox"/> 3Y	<input type="checkbox"/> 4C	<input type="checkbox"/> 1W

NOTE: 1A, 2B, 3Y and 4C mounting arms are part of the Pole Assembly. 1W Wall Mount arm is **not** included and must be ordered separately. See page 4 for styles and ordering information.

Fixture

Cat. No. designates fixture and optic

<div style="border: 1px solid black; padding: 2px; width: fit-content;">RA17</div> <div style="border: 1px solid black; padding: 2px; width: fit-content; margin-top: 5px;">Housing Size: 17"</div>	<p>x</p> <div style="border: 1px solid black; padding: 2px; width: fit-content;">E35</div> <p>E35 = 350mA</p>	<p>Light Distribution:</p> <table border="0"> <tr> <td></td> <td></td> <td></td> </tr> <tr> <td>Type I</td> <td>Type II</td> <td>Type III</td> </tr> <tr> <td></td> <td></td> <td></td> <td></td> </tr> <tr> <td>Type IV Forward Throw</td> <td>Type V Square</td> <td>Type R Right</td> <td>Type L Left</td> </tr> </table>				Type I	Type II	Type III					Type IV Forward Throw	Type V Square	Type R Right	Type L Left
Type I	Type II	Type III														
Type IV Forward Throw	Type V Square	Type R Right	Type L Left													

Distribution:

- 1 = Type I Full Cutoff
- 2 = Type II Full Cutoff
- 3 = Type III Full Cutoff
- 4 = Type IV Full Cutoff
- 5 = Type V Square Full Cutoff
- L = Type L Left Full Cutoff
- R = Type R Right Full Cutoff

Electrical Module

Cat. Nos. for Electrical Modules available:

<div style="border: 1px solid black; padding: 2px; width: fit-content;">60L</div> <div style="border: 1px solid black; padding: 2px; width: fit-content; margin-top: 5px;">Source: 60L = 60 LED's</div>	<p>xK</p> <div style="border: 1px solid black; padding: 2px; width: fit-content;">Color Temperature:</div> <ul style="list-style-type: none"> <input checked="" type="checkbox"/> 3K = 3000K <input type="checkbox"/> 4K = 4200K <input type="checkbox"/> 5K = 5100K <input type="checkbox"/> 2K = 580nm - Amber 	<p>x</p> <div style="border: 1px solid black; padding: 2px; width: fit-content;">Voltage:</div> <ul style="list-style-type: none"> <input type="checkbox"/> 120 = 120V <input type="checkbox"/> 208 = 208V <input type="checkbox"/> 240 = 240V <input type="checkbox"/> 277 = 277V <input type="checkbox"/> 347 = 347V¹ <input type="checkbox"/> 480 = 480V¹ 	<div style="border: 1px solid black; padding: 5px; width: fit-content;">SELECT VOLTAGE</div>
---	--	--	--

¹Due to current unavailability of 347V and 480V drivers, specification of these voltages may feature an integral step-down transformer.

Finish

TGIC powder coat

Color: Black Dark Bronze Light Gray Stealth Gray

Platinum Silver

 White Custom Color²
 Cat. No.: BL DB LG SG

PS

 WH CC

²Custom colors subject to additional charges, minimum quantities and extended lead times. Consult representative. Custom color description: _____

0-10V Dimming Interface

Driver has a 0-10V dimming interface with a dimming range of 10-100%. Is compatible with most control systems including Hubbell Building Automation wiHUBB™. Approved dimmers include Lutron Diva AVTV, Lutron Nova NFTV and NTFTV. Note: Not compatible with current sourcing dimmers. Controls compatible via Gray and Purple dimming lead.





Job Name:
Kanawha Plaza

Catalog Number:

1SA-RA17-2-E35-60L-3K-X-PS-LS/
HA11S-TM1

Notes:

Type:

C2

LV - CENTRAL15-17875



KIM LIGHTING

RA17

17" Era® PicoEmitter™ LED
revision 9/10/14 • kl_ra17eled_spec.pdf

Type:

Job:

Page: 5 of 6



Arm Options

Arms

Note: Wall mount arm is **not** included and must be ordered separately. Refer to Kim Lighting's Arms and Poles Selection Guide for complete details.

Mtg.	Post Top Crook			Side Pole Crook			Post Top Swept Cast Arm		
	Arm	Tenon Mt.	Wall Mt.	Arm	Tenon Mt.	Wall Mt.	Arm	Tenon Mt.	Wall Mt.
1SA	<input type="checkbox"/> HA01S	<input type="checkbox"/> HA01S-TM1	—	<input type="checkbox"/> HA02S	<input type="checkbox"/> HA02S-TM1	<input type="checkbox"/> HA02S-W	<input type="checkbox"/> HA03S	<input type="checkbox"/> HA03S-TM1	—
2SB	—	—	—	—	<input type="checkbox"/> HA02S-TM2	—	—	<input type="checkbox"/> HA03S-TM2	—
3SY	—	—	—	—	<input type="checkbox"/> HA02S-TM3	—	—	<input type="checkbox"/> HA03S-TM3	—
4SC	—	—	—	—	<input type="checkbox"/> HA02S-TM4	—	—	<input type="checkbox"/> HA03S-TM4	—

Mtg.	Side Pole Swept Cast Arm			Side Pole S-Shaped Up Cast Arm		
	Arm	Tenon Mt.	Wall Mt.	Arm	Tenon Mt.	Wall Mt.
1SA	<input type="checkbox"/> HA11S	<input type="checkbox"/> HA11S-TM1	<input type="checkbox"/> HA11S-W	<input type="checkbox"/> HA12S	<input type="checkbox"/> HA12S-TM1	<input type="checkbox"/> HA12S-W
2SB	—	<input type="checkbox"/> HA11S-TM2	—	—	<input type="checkbox"/> HA12S-TM2	—
3SY	—	<input type="checkbox"/> HA11S-TM3	—	—	<input type="checkbox"/> HA12S-TM3	—
4SC	—	<input type="checkbox"/> HA11S-TM4	—	—	<input type="checkbox"/> HA12S-TM4	—

Mtg.	Side Pole Neo-Classic Arm			Side Pole Arm w/Top Scroll			Side Pole Ribbon Arm w/Top Gusset		
	Arm	Tenon Mt.	Wall Mt.	Arm	Tenon Mt.	Wall Mt.	Arm	Tenon Mt.	Wall Mt.
1SA	<input type="checkbox"/> HA14S	<input type="checkbox"/> HA14S-TM1	<input type="checkbox"/> HA14S-W	<input type="checkbox"/> HA31S	<input type="checkbox"/> HA31S-TM1	<input type="checkbox"/> HA31S-W	<input type="checkbox"/> HA33S	<input type="checkbox"/> HA33S-TM1	<input type="checkbox"/> HA33S-W
2SB	—	<input type="checkbox"/> HA14S-TM2	—	—	<input type="checkbox"/> HA31S-TM2	—	—	<input type="checkbox"/> HA33S-TM2	—
3SY	—	<input type="checkbox"/> HA14S-TM3	—	—	<input type="checkbox"/> HA31S-TM3	—	—	<input type="checkbox"/> HA33S-TM3	—
4SC	—	<input type="checkbox"/> HA14S-TM4	—	—	<input type="checkbox"/> HA31S-TM4	—	—	<input type="checkbox"/> HA33S-TM4	—

Mtg.	Side Pole Ribbon Arm w/Top Brace			Side Pole Ribbon Arm w/Top Brace & Bottom Scroll			Side Pole Ribbon Arm w/Top Brace & Bottom Gusset		
	Arm	Tenon Mt.	Wall Mt.	Arm	Tenon Mt.	Wall Mt.	Arm	Tenon Mt.	Wall Mt.
1SA	<input type="checkbox"/> HA35S	<input type="checkbox"/> HA35S-TM	<input type="checkbox"/> HA35S-W	<input type="checkbox"/> HA37S	<input type="checkbox"/> HA37S-TM	<input type="checkbox"/> HA37S-W	<input type="checkbox"/> HA38S	<input type="checkbox"/> HA38S-TM	<input type="checkbox"/> HA38S-W
		Consult factory for other mtgs.	Consult factory for other mtgs.		Consult Factory for other mtgs	Consult Factory for other mtgs		Consult Factory for other mtgs	Consult Factory for other mtgs

Arm Finial:

HAF2 - Traditional style finial available to close off mounting hub opposite the fixture.
¹Not available on arm where indicated.





Job Name:
Kanawha Plaza

Catalog Number:1SA-RA17-2-E35-60L-3K-X-PS-LS/
HA11S-TM1

Notes:

Type:**C2**

LV - CENTRAL15-17875

**KIM LIGHTING****RA17**17" Era® PicoEmitter™ LED
revision 9/10/14 • kl_ra17eled_spec.pdf**Type:****Job:****Page: 6 of 6**

Lumen Data

Spectroradiometric			
	3000K Average	4200K Average	5100K Average
Correlated Color Temp. CCT (K)	2800K-3175K	3800K-4600K	4600K-5600K
Color Rendering Index (CRI)	≤80	≤80	≤70
Power Factor	>.90	>.90	>.90

Projected Lumen Maintenance		
mA	100,000 hrs	(Calculated L70)
350	94.63%	783,000 Hrs.

Electrical Drive Current		
Volts - AC	Amps - AC	System Watts
120	0.57	68
208	0.33	68
240	0.28	68
277	0.25	68
347	0.20	68
480	0.14	68

B.U.G. Rating (TM15) in Lumens when B = Backlight, U = Uplight, G = Glare								
Temperature	TYPE 1	TYPE 2	TYPE 3	TYPE 3 NFO	TYPE 4	TYPE 4 NFO	TYPE 5	TYPE L/R
3000K	B2 U0 G2	B1 U0 G1	B1 U0 G1	B1 U0 G1	B1 U0 G1	B0 U0 G1	B2 U0 G1	TBD
4200K	B3 U0 G3	B2 U0 G2	B1 U0 G1	B1 U0 G1	B1 U0 G2	B1 U0 G1	B3 U0 G1	TBD
5100K	B3 U0 G3	B2 U0 G2	B1 U0 G1	B1 U0 G1	B1 U0 G2	B1 U0 G1	B3 U0 G1	TBD

Absolute Lumens								
Temperature	TYPE 1	TYPE 2	TYPE 3	TYPE 3 NFO	TYPE 4	TYPE 4 NFO	TYPE 5	TYPE L/R
3000K	4236	4343	4312	3563	4353	3613	4356	TBD
4200K	5298	5432	5393	4456	5444	4519	5447	TBD
5100K	5851	5999	5956	4921	6012	4991	6016	TBD

LED performance and lumen output continues to improve at a rapid pace. Log onto www.kimlighting.com to download the most current photometric files from Kim Lighting's IES File Library. For custom optics and color temperature configurations, contact factory.






Job Name:
Kanawha Plaza

Catalog Number:
RNA-14-45-7-AB-PC(PS)-T20R

Notes:

Type:
C POLE

LV - CENTRAL15-17875

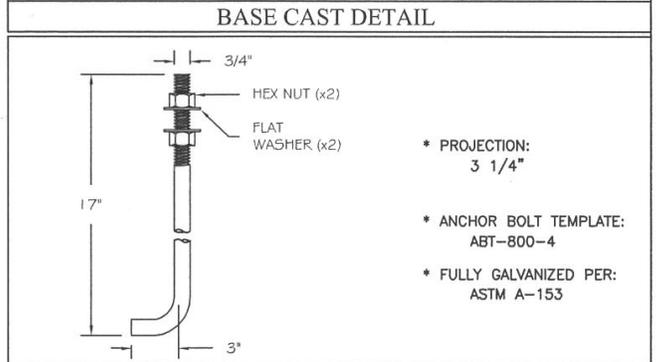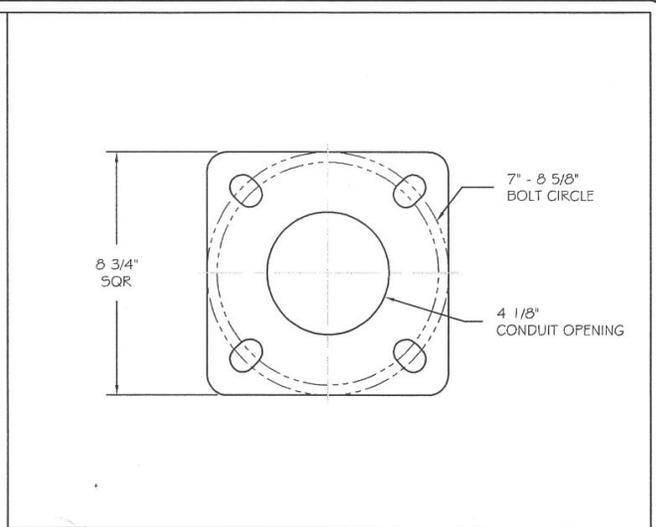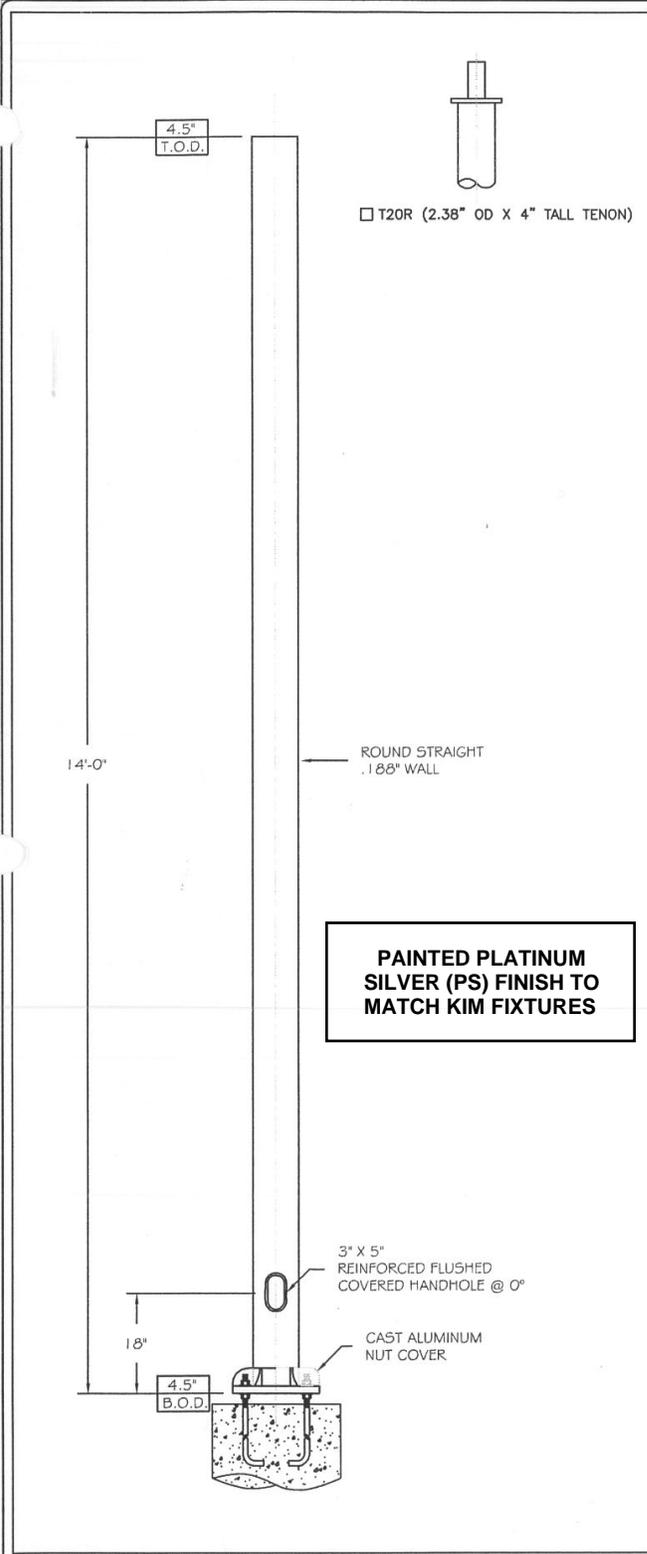

LOADING CHART

WIND (MPH)	80	90	100	110
EPA	11.4	8.6	6.8	5.4
WEIGHT	150	150	150	150

SPECIFICATIONS

COMPONENT	SPECIFICATION
POLE SHAFT	6063 - ALLOY ALUMINUM
BASE CAST	A356 ALLOY ALUMINUM
ANCHOR BOLTS	ASTM F-1554 GRADE 55

- GENERAL NOTES**
- ALUMINUM TUBE SHALL BE HEAT TREATED TO T6 TEMPER.
 - POLE ASSEMBLY TO BE PAINTED AND WRAPPED.
 - DESIGN WIND SPEEDS IN LOADING CHART INCLUDE 1.3 GUST FACTOR.
 - POLE DESIGN IS BASED AGAINST AASHTO 1994 STANDARDS.

(FOR APPROVAL)

BY: _____ DATE: _____

	AMERICAN LITE POLE 2800 S. HULEN, SUITE 200 FORT WORTH, TX 76109 817-924-3682 PH. 817-924-7049 FAX	REV. DATE BY REVISION DESCRIPTION PROJECT NAME: FOUNDRY PARK BRIDGE	SCALE: NONE DATE: 11/30/10 DWG BY: BM
	** CONFIDENTIAL** THE INFORMATION CONTAINED IN THIS DRAWING IS PROPRIETARY AND CONFIDENTIAL. UNAUTHORIZED DUPLICATION OR DISSEMINATION OF THIS DOCUMENT IS STRICTLY PROHIBITED WITHOUT PRIOR WRITTEN NOTICE FROM AMERICAN LITE POLE.	DESCRIPTION: ROUND STRAIGHT 14' ALUMINUM	PO NUMBER: _____ QTY: _____ CHK'D BY: CKR

Submitted by Lighting Virginia-Central



Job Name:
Kanawha Plaza

Catalog Number:
SCHREDER BOR-LHP3200-MT-XX-
XXX-RAL(SILVER)/A114-1-59
Notes:

Type:
L

LV - CENTRAL15-17875



BOREAL




URBIS
MEMBER OF SCHREDER GROUP GIE

NOBLE MATERIALS

The Boreal luminaire has a body made of cast aluminium and a clear acrylic wrap-around diffuser. The body is protected against corrosion by a baked polyester powder coating. The wrap-around diffuser is encircled by a stainless steel perforated mask. All parts inside the luminaire are made of aluminium.

SYMMETRICAL LIGHTING

The optical compartment provides a tightness level of IP 66. It has a refractor and upper reflector providing symmetrical lighting.

MASKS AND COLOURS


The Boreal luminaire is equipped with a perforated mask providing a spontaneous and festive effect.

Other types of masks are also available.

A dichroic filter placed inside the wrap-around diffuser permits the creation of coloured effects.

MAINTENANCE


Access to the lamp and control gear is via three captive screws located under the luminaire. The control gear is mounted on a removable plate.

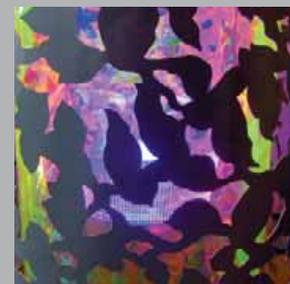


BRANCHES
MASK



HANDWRITING
MASK

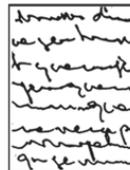

CLASSIC
MASK

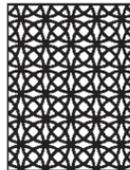

ABSTRACT
MASK



FOLIAGE
MASK





Job Name:
Kanawha Plaza

Catalog Number:
SCHREDER BOR-LHP3200-MT-XX-
XXX-RAL(SILVER)/A114-1-59

Notes:

Type:

L

LV - CENTRAL15-17875

BOREAL


Type: _____ Quantity: _____ Approvals _____

Job: _____

Date: _____

Catalog Number: BOR • • • • • • • •
lamp type voltage dichroic filter drum pattern color mounting pole

Model	BOREAL
Dimensions	
Height	33.1 in/840mm
Diameter	24 in/611mm
EPA	2.15 sq ft/.20 m ²
Weight	66.1 lbs/30kg
IP rating	66
Light Source	
Metal Halide	70, 150 watt T-6

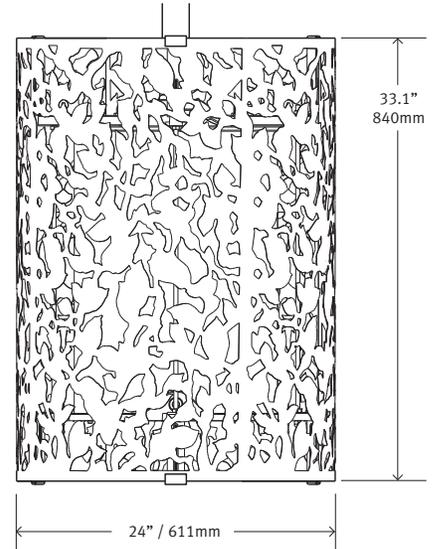

SPECIFICATIONS

- Housing:** Made of cast aluminum, 0.100" (254mm) minimum thickness with a mounting provision for attachment to the arm. The housing is attached to the arm with a threaded pipe connection and stainless steel set screws.
- Outer drum:** The outer drum is 316 alloy stainless steel with a lightly brushed finish. The drum is available in three standard mesh patterns. The drum is attached to the housing, on the top and bottom and can be removed.
- Lens:** A clear outer cylindrical acrylic lens is attached to the housing with a continuous silicone seal. The optical compartment is rated at IP66. The vertical lamp is placed at the center of the optical chamber, providing a symmetrical distribution, IES classification type 5.
- Filter:** A dichroic filter, blue or magenta, is located inside the lens to generate a colored moire effect.
- Lamp Access:** A gasketed removable cover is accessible at the bottom of the lens assembly.
- Electrical:** A terminal block is located in the lamp housing. Wires up to #8 can be terminated. A ground lug is also included. The lamp socket is porcelain, pulse rated 4kV G-12 base for use with a T-6 lamp.
- Ballast:** A high power factor, potted and enclosed ballast is mounted inside the pole. The ballast is dual voltage 120 or 277 volt.
- Finish:** The standard finish is a light sanded texture, black polyester powder coating. The finish provides a highly durable UV and salt spray resistant finish in accordance to the ASTM B117 standard and humidity proof in accordance with the ASTM D2247 standard.

Schröder



Job Name:
Kanawha Plaza

Catalog Number:
SCHREDER BOR-LHP3200-MT-XX-
XXX-RAL(SILVER)/A114-1-59
Notes:

Type:
L
LV - CENTRAL15-17875

BOREAL

Type: _____ Quantity: _____

Approvals




Job: _____

Date: _____

Catalog Number: BOR • • • • •
lamp type voltage dichroic filter drum pattern color mounting pole

1	2	3	5
LAMP TYPE MH T6 - 70 70 watt metal halide T-6 lamp, G12 base  MH T6 - 150 150 watt metal halide T-6 lamp, G12 base  LHP-3200  LED 90W 8900lm	VOLTAGE MT F-can ballast, in pole mounting. Dual voltage, 120 or 277 volt EUC-096S105DT(7) LED Dimmable-Driver (96W, 90-305Vac)	DICHROIC FILTER MG Magenta dichroic filter CY Cyan dichroic filter <div style="border: 1px solid black; padding: 5px; text-align: center; margin-top: 10px;">SELECT FILTER</div>	POLE AND BRACKET COLOR SBK 200 Sand blast textured Black RAL [SILVER TBD - TO MATCH KIM "PS"] Provide four digit RAL color number CSC Custom color. Provide a color sample for matching and approval

SELECT DRUM PATTERN

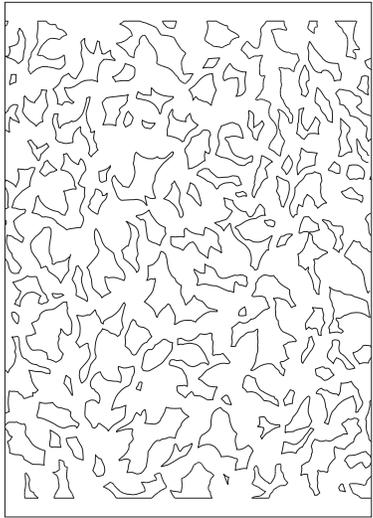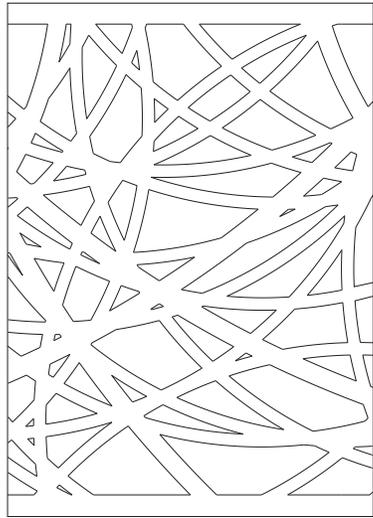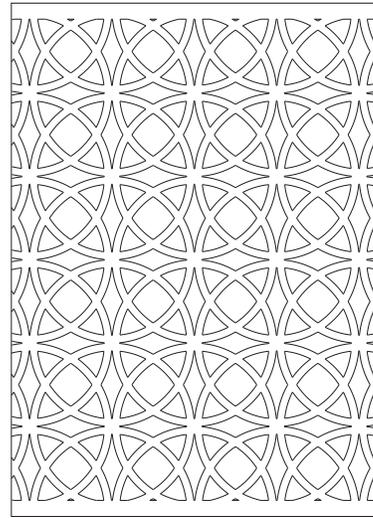DRUM MESH PATTERN		
FOM Foliage mesh pattern 	BRM Branches mesh pattern 	CIM Circles mesh pattern 





Job Name:
Kanawha Plaza

Catalog Number:
SCHREDER BOR-LHP3200-MT-XX-
XXX-RAL(SILVER)/A114-1-59
Notes:

Type:
L
LV - CENTRAL15-17875

BOREAL


Type: _____ Quantity: _____ Approvals

Job: _____

Date: _____

Catalog Number: BOR • • • • •
lamp type voltage dichroic filter drum pattern color mounting pole

6

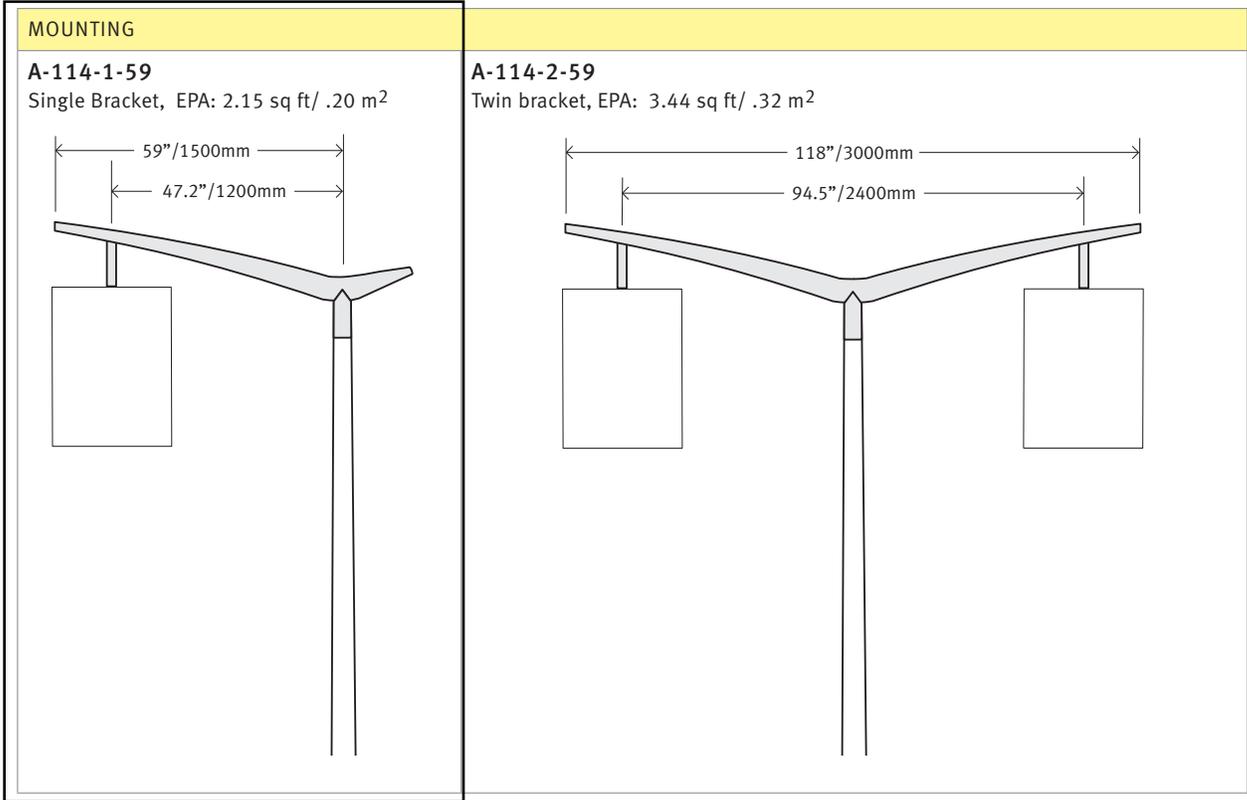

7

POLE
Refer to the Schröder pole guide.







Job Name:
Kanawha Plaza

Catalog Number:
RNA-12-45-7-AB-PC(PS)-T20R


Type:
L POLE

Notes:

LV - CENTRAL15-17875

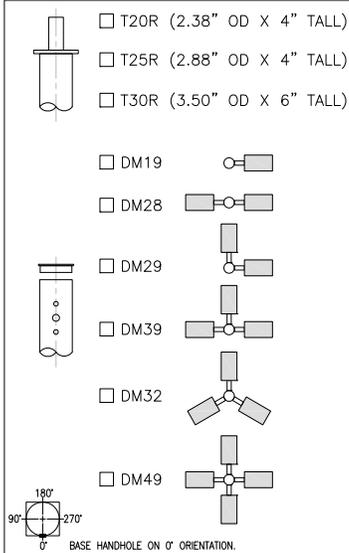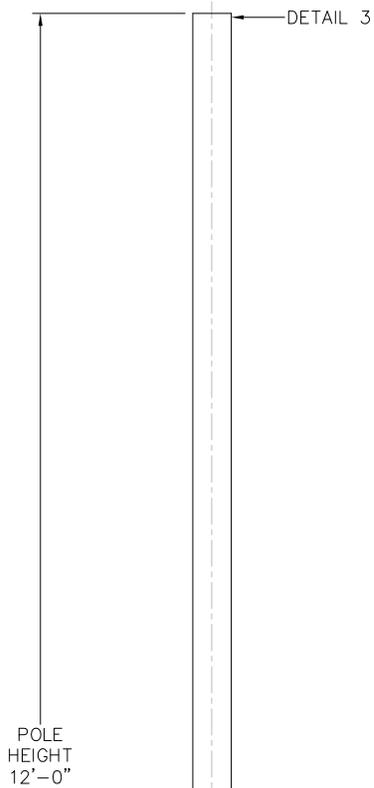


DETAIL 3 POLE TOP

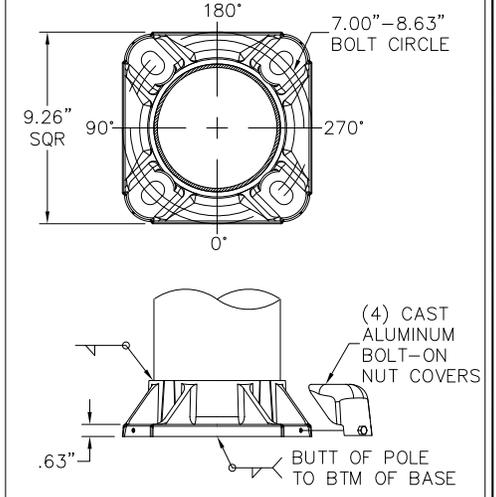

DETAIL 1 BASE CAST


**PAINTED TO MATCH
KIM PLATINUM SILVER (PS)
AND SCHREDER
FIXTURES**

DETAIL 4

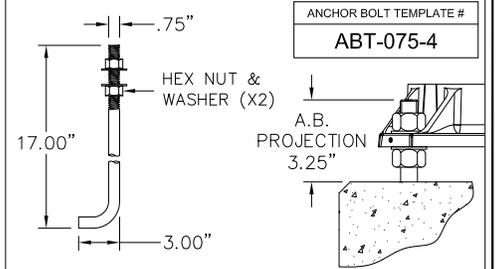

DETAIL 2 ANCHOR BOLT

POLE
HEIGHT
12'-0"

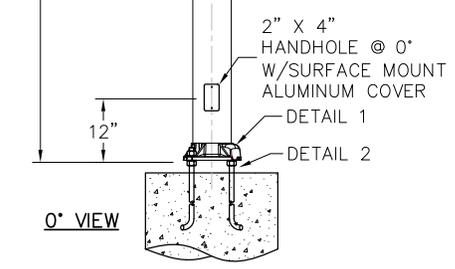

- 1) POLE SHAFT IS EXTRUDED FROM SEAMLESS ALLOY ALUMINUM & TREATED TO PRODUCE A T6 TEMPER.
- 2) ALL ALUMINUM ALLOYS SHALL COMPLY WITH METALLURGICAL AND MECHANICAL PROPERTIES SET FORTH IN THE ALUMINUM ASSOCIATION STANDARDS.
- 3) ANCHOR BOLTS SHALL BE FULLY GALVANIZED PER ASTM A153.
- 4) PROVISIONS FOR GROUNDING LOCATED AT BASE HAND HOLE.
- 5) VIBRATION DISCLAIMER: ALTHOUGH RARE, VIBRATIONS SEVERE ENOUGH TO CAUSE DAMAGE CAN OCCASIONALLY OCCUR IN STRUCTURES OF ALL TYPES. BECAUSE THEY ARE INFLUENCED BY MANY INTERACTING VARIABLES, VIBRATIONS ARE GENERALLY UNPREDICTABLE. THE USERS MAINTENANCE PROGRAM SHOULD INCLUDE OBSERVATION FOR EXCESSIVE VIBRATION AND EXAMINATION FOR ANY STRUCTURAL DAMAGE. ALP WARRANTY EXCLUDES FATIGUE FAILURE OR SIMILAR PHENOMENA RESULTING FROM INDUCED VIBRATION, HARMONIC OSCILLATION OR RESONANCE ASSOCIATED WITH MOVEMENT OF AIR CURRENTS AROUND THE POLE.

LOADING DATA							
DESIGN CRITERIA:	AASHTO LTS-3 1994						
WIND SPEED(mph)	80	90	100	110	120	130	140
EPA FT²	10.2	7.7	6.2	5.0	-	-	-
WEIGHT (lbs)	75	75	75	75	-	-	-
FINISH							
TBD							

MATERIAL DATA	
COMPONENT	ASTM
POLE SHAFT	6063-T4
BASE CAST	A356
ANCHOR BOLTS	F1554 GR.55

POLE DIMENSION DATA						
TYPE	DESIGN	POLE LENGTH (FT)	BASE DIA. (IN)	TOP DIA. (IN)	GAUGE OR THK (IN)	WEIGHT (LBS)
	RNA-12-45-7-AB	12'-0"	4.50	4.50	.188	41

DETAIL GENERAL NOTES



AMERICAN LITE POLE
2800 S. HULEN, SUITE 200
FORT WORTH, TX 76109
817-924-3682 PH.
817-924-7049 FAX

**** CONFIDENTIAL ****
THE INFORMATION CONTAINED IN THIS DRAWING IS PROPRIETARY AND CONFIDENTIAL. UNAUTHORIZED DUPLICATION OR DISSEMINATION OF THIS DOCUMENT IS STRICTLY PROHIBITED WITHOUT PRIOR WRITTEN NOTICE FROM AMERICAN LITE POLE.

REV. DATE BY REVISION DESCRIPTION
PROJECT NAME:

DESCRIPTION:
ROUND STRAIGHT ALUMINUM ANCHOR BASE
12' x 4.5" x .188"

PO NUMBER: DATE: DWG BY:
040214 BM

QUOTE NUMBER: SCALE: QTY: CHKD BY:
NTS CKR

DRAWING NUMBER: REV:
RNA-12-45-7-AB



Job Name:
Kanawha Plaza

Catalog Number:
L606W-AL

Notes:

Type:
S

LV - CENTRAL15-17875

COLE LIGHTING SUBMITTAL

JOB NAME _____

CATALOG NUMBER _____

Type _____

Steplites

L600 SERIES

SPECIFICATIONS

Construction


- Recessed housing is constructed from 16 gauge electro-galvanized steel, matte black powder coat finished
- Faceplates are 3/16" aluminum or stainless steel
- Aluminum faceplates are powder coated; Stainless steel are satin finished, passivated for maximum rust resistance
- Fixtures are furnished with stainless steel socket head tamperproof screws
- Diffuser is clear tempered glass, set in silicone sealant
- Internal baffle is coated matte black to eliminate glare
- Optional junction box is cast aluminum with polyester coating
- cETLus listed installation in any wall construction and suitable for wet locations in any wall construction.

Electrical

- Fixture is wired with high performance LEDs positioned for 5°, 10° or 15° cutoff (5° standard)
- Integral driver is universal voltage
- Housing provided with 1/2" conduit knockout on each side, suitable for 4 wire thru-wiring, 2 in 2 out
- Optional junction box allows 8 wire thru-wiring, 4 in 4 out. Provided with two 1/2" tapped conduit entrances in the bottom and one 1/2" tapped conduit entrance in each side.

Mounting

Housing has flange with holes for mounting. Thru-wall housings allow 1" of adjustment for varying wall thicknesses.

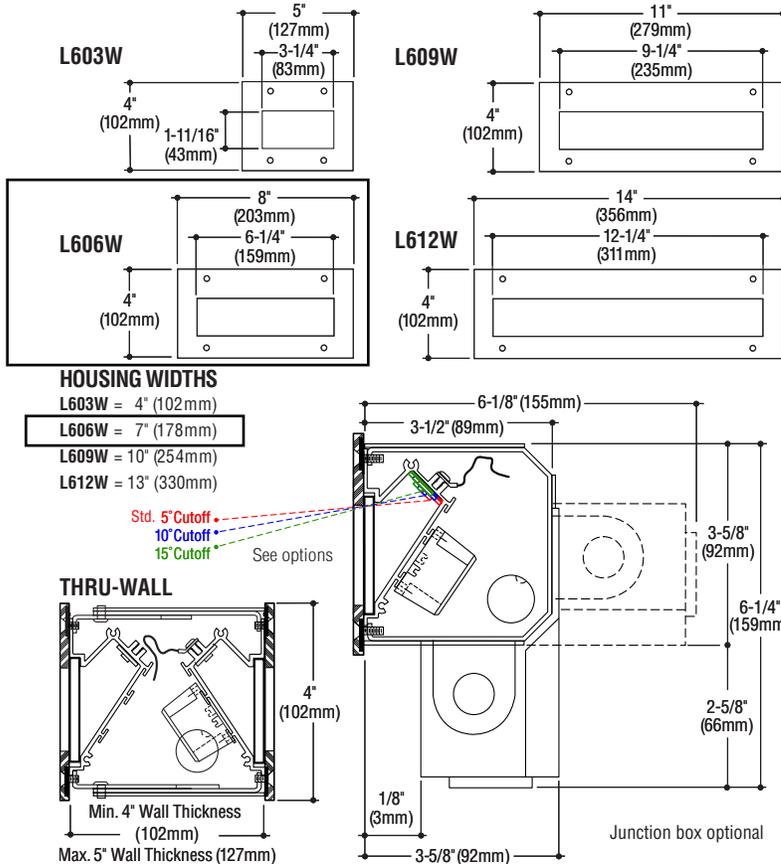

Catalog Number Lamp	Faceplate		Thru-Wall	
	Aluminum	Stainless Steel	Aluminum	Stainless Steel
LED 1.5W, (126 lm @ 3000°K)*	<input type="checkbox"/> L603W-AL	<input type="checkbox"/> L603W-N	<input type="checkbox"/> L603W-2S-AL	<input type="checkbox"/> L603W-2S-N
LED 3.6W, (215 lm @ 3000°K)*	<input type="checkbox"/> L603W-AL-HO	<input type="checkbox"/> L603W-N-HO	<input type="checkbox"/> L603W-2S-AL-HO	<input type="checkbox"/> L603W-2S-N-HO
LED 3.0W, (252 lm @ 3000°K)	<input checked="" type="checkbox"/> L606W-AL	<input type="checkbox"/> L606W-N	_____	_____
LED 7.2W, (430 lm @ 3000°K)	<input type="checkbox"/> L606W-AL-HO	<input type="checkbox"/> L606W-N-HO	_____	_____
LED 4.5W, (377 lm @ 3000°K)	<input type="checkbox"/> L609W-AL	<input type="checkbox"/> L609W-N	_____	_____
LED 10.8W, (645 lm @ 3000°K)	<input type="checkbox"/> L609W-AL-HO	<input type="checkbox"/> L609W-N-HO	_____	_____
LED 6.0W, (503 lm @ 3000°K)	<input type="checkbox"/> L612W-AL	<input type="checkbox"/> L612W-N	_____	_____
LED 14.4W, (860 lm @ 3000°K)	<input type="checkbox"/> L612W-AL-HO	<input type="checkbox"/> L612W-N-HO	_____	_____

*Indicated values for wattage doubled for thru-wall models.

Options

Bronze faceplate: Satin finished, clear coated.

Add suffix -B.

Junction box: Cast aluminum junction box.

Add suffix -J (Not available on L603 model).

Dimming: Universal voltage 0-10V driver. Add suffix -DIM. (Not available on L603 model)

Alternate faceplate color: Black or white.

Add suffix -BLK or -WHT.

Frosted glass diffuser: Tempered. Add suffix -FG.

Cutoff: 10° Add suffix -10° 15° Add suffix -15°.

K14

LED colors: 4000°K

(L603, 146 lm), (L603-HO, 249 lm),

(L606, 292 lm), (L606-HO, 498 lm),

(L609, 438 lm), (L609-HO, 747 lm),

(L612, 584 lm), (L612-HO, 995 lm). Add suffix -4K.

Amber. Add suffix -AMB. Blue. Add suffix -BLU.

NOTE: Amber and Blue not available in HO-2.

How to Specify

1. Select catalog number with desired features.

2. Add suffixes for options required to meet job conditions.



C.W. Cole & Company, Inc.
 2560 N. Rosemead Boulevard
 South El Monte, CA 91733-1593

Tel. (626) 443-2473

Fax (626) 443-9253

info@colelighting.com

www.colelighting.com



Job Name:
Kanawha Plaza

Catalog Number:
IG3B-XX-118-0-0-0

Notes:

Type:

T

LV - CENTRAL15-17875

Job:

Approval:

Type:

VISION-3

LIGHTING

MR16 Round Well Light **MODEL IG3**

12V, 20W Max., MR16 Halogen

12-24V, 10W or 12V, 12.5W LED

Specifications:

Housing: Cast C84400 bronze collar attached to an ABS plastic housing using 18-8 stainless steel hardware.

Lamp Holder: Machined 6061-T6 aluminum cap attached to a machined 6061-T6 aluminum body using one 18-8 stainless steel set screw, and sealed with a high temperature silicone O-ring. Cap and body are black anodized. Cap accepts up to three internal accessories, held in place by a stainless steel clip. Lamp holder is supplied with 6' of cable. Cable exit sealed with a water tight strain relief fitting.

Aiming: Lamp holder is attached to 304 stainless steel bracketry, allowing full 360° rotational, and ±29° (MR16 and 10W LED) or ±19° (12.5W LED) vertical aiming. Bracketry is mounted to cast C84400 bronze collar, allowing adjustment with faceplate removed. 18-8 stainless steel hardware locks lamp holder in place after adjustment.

Faceplate: Cast C84400 bronze faceplate mounts to aiming bracketry with 18-8 stainless steel hardware, ensuring that lens opening is properly aligned. The 1/4" tempered faceplate lens is secured to the faceplate with a high temperature, UV curing, silicone adhesive.

Finish: TGIC thermo set polyester powder coat paint available in 14 standard colors. Also available in three additional bronze finishes: Natural, Polished, and Aged.

Cap Lens: Tempered, clear lens, secured to cap with a high temperature, UV curing, silicone adhesive. Stepped, flush lens reduces collection of water and debris on the lens.

Socket: GY-6.35 porcelain socket with 600V, 250°C, PTFE coated 18 ga leads.

Lamps:

- 12 Volt bi-pin 20W MR16 halogen (See **Certification** heading).
- 12-24 Volt AC/DC, 10W LED with High/Low switch for 35W & 20W halogen equivalent outputs. Requires up to 13W at startup, which must be allowed for during system design.
- 12 Volt AC/DC, 12.5W LED with push button selection of 4 outputs (50W, 35W, 20W & 12W halogen equivalent). Requires up to 15W at startup, which must be allowed for during system design.

LED modules are field replaceable and feature replaceable lenses, an L70 of 60,000 hrs., dynamic transformer recognition, phase dimming (see Transformer and Dimmer Compatibility List), and patented LEDSense® thermal management.

Certification: CSA tested & certified to US and Canadian safety standards for the following applications:

Wet location landscape use (UL1838):

IG3B - 20W Max. MR16 Halogen lamp.

10W LED & 12.5 LED can be used in all models and applications.

All ratings subject to change without notice. See web site or contact V3 for most current info.

**Ordering Information:**

IG3B		Lamp	Lens Accy ¹	Filter ¹	Louver ¹
Model	Finish				
IG3B - Cast Bronze	BL - Black	0 - None	0 - None	0 - None	0 - None
	BLT - Textured Black	LED 2,3:	L1 - Spread Lens	F1 - Red	H1 - Honeycomb Louver
	BN - Bronze	116 - 10W, 3000K, 12° ¹	L2 - Linear Lens	F2 - Blue	
	BNT - Textured Bronze	117 - 10W, 3000K, 21° ¹	L3 - Softening Lens	F3 - Light Blue	
	BAT - Textured Bark	118 - 10W, 3000K, 41°¹		F4 - Green	
	WI - White	119 - 12.5W, 3000K, 19°		F5 - Amber	
	GRT - Textured Green	120 - 12.5W, 3000K, 34°		F6 - Pink	
	SI - Silver	121 - 12.5W, 3000K, 60°		F7 - Mercury Vapor	
	GY - Grey	MR16 Halogen:			
	BE - Beige	01 - ESX, 20W, 12°			
	GNT - Textured Granite	02 - BAB, 20W, 40°			
	SAT - Textured Sand				
	PAT - Textured Patina				
	EAT - Textured Earth				
	NAT - Natural				
	POL - Polished				
	AGE - Aged				

SELECT FINISH

Notes:

1. Only two lens accessories can be used with 10W LED.
2. Only power LED with magnetic or V3 approved electronic transformers (contact V3 for transformer compatibility info).
3. LED available with other color temperatures as a special order. Consult your V3 sales rep.
4. Specifications, certifications, and ordering information are subject to change. Please check website for latest specification sheets.

Example: IG3B - NAT - 01 - 0 - F3 - H1

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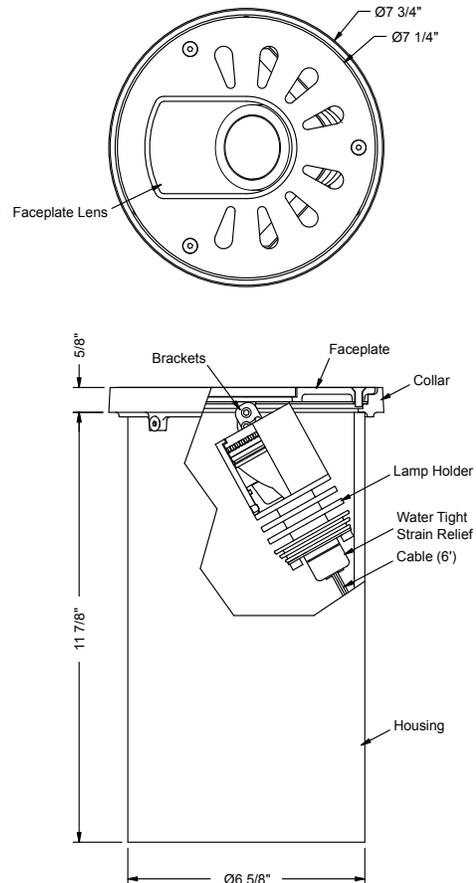
P.O. Box 607, Fowler, CA 93625

(559) 834-5749

(559) 834-4779 fax

www.vision3lighting.com

revision 7/11/13





Job Name:
Kanawha Plaza

Catalog Number:
XM2-XXX-120-X

Notes:

Type:
T XFMR

LV - CENTRAL15-17875

Job:

Approval:

Type:

VISION-3

LIGHTING

Multi-Tap Transformer **MODEL XM2**
120 VAC, 100/300/600/900/1200 Watt Magnetic Transformers

Specifications:

100W version:

Construction: 100W landscape lighting transformer with two voltage outputs: 12V and 15V. 15V tap is provided to help reduce voltage drop and increase lamp brilliance. Packaged in a stainless steel NEMA style rain tight enclosure with enclosed wiring terminals and removable cover. Unit includes side wiring access through two 1/2" and 3/4" double knockouts, and one 1 1/4" and 1 1/2" double EKO on a swing down bottom. Optional features include removable timer and field installed or remote photocell.

Specifications:

- 100 Watt - single circuit output.
- NEMA style rain tight keyhole mount stainless steel enclosure.
- Wiring compartment with input and output terminals.
- Complete wiring instructions.
- 24-hour removable timer option.
- Field installed or remote photocell option.
- X-10 remote control compatible.
- 6' outdoor line cord.
- Two voltage output taps, 11 and 15 Volts.
- Low voltage circuit breaker.
- UL tested & certified to US and Canadian safety standards.


300W, 600W, 900W 1200W versions:

Construction: Landscape lighting transformer with multiple voltage outputs. Multi-tap output is from 11 to 15 Volts in 300, 600, 900, and 1200 Watts. Packaged in a stainless steel NEMA 3R rain tight enclosure with enclosed wiring terminals, hinged lockable cover and up to five 1/2" and 3/4" knockouts - bottom and side entry. Optional features include removable timer and field installed or remote photocell.


Specifications:

- 300 Watt - single circuit output. 600 Watt - dual circuit output. 900 Watt - 3 circuit output. 1200 Watt - 4 circuit output.
- NEMA style rain tight keyhole mount stainless steel enclosure.
- Wiring compartment with input and output terminals.
- Complete wiring instructions.
- 24-hour removable timer option.
- Field installed or remote photocell option.
- X-10 remote control compatible.
- 6' outdoor line cord.
- Multiple voltage output taps, 11-15 Volts.
- Low voltage circuit breaker. 1 circuit breaker per circuit on multiple circuit models.
- UL tested & certified to US and Canadian safety standards.

Note: Some direct burial and 277V options are available. Contact your Vision3 Lighting sales representative for more information.

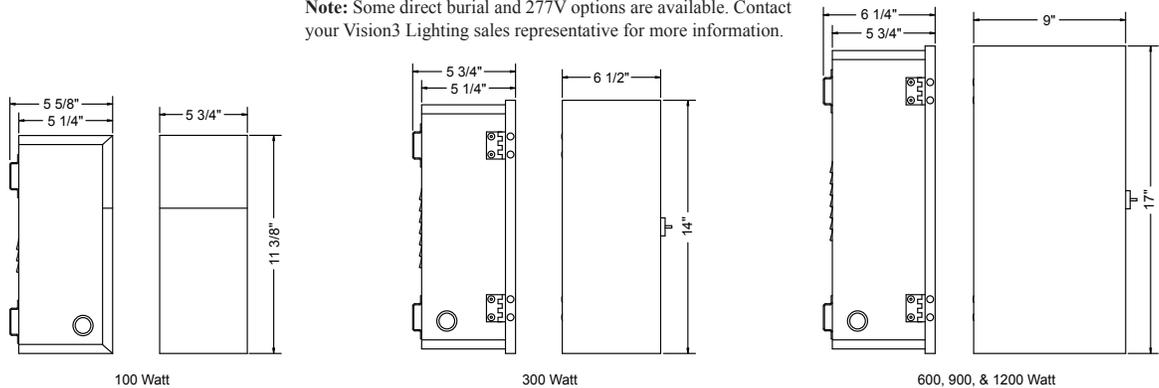


Ordering Information:

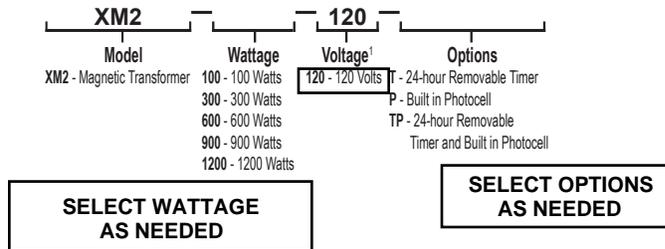

Notes:

1. Some direct burial and 277V options are available. Contact your Vision3 Lighting sales representative for more information.
2. Specifications, certifications, and ordering information are subject to change. Please check website for latest specification sheets.

Example: **XM2 - 600 - 120**

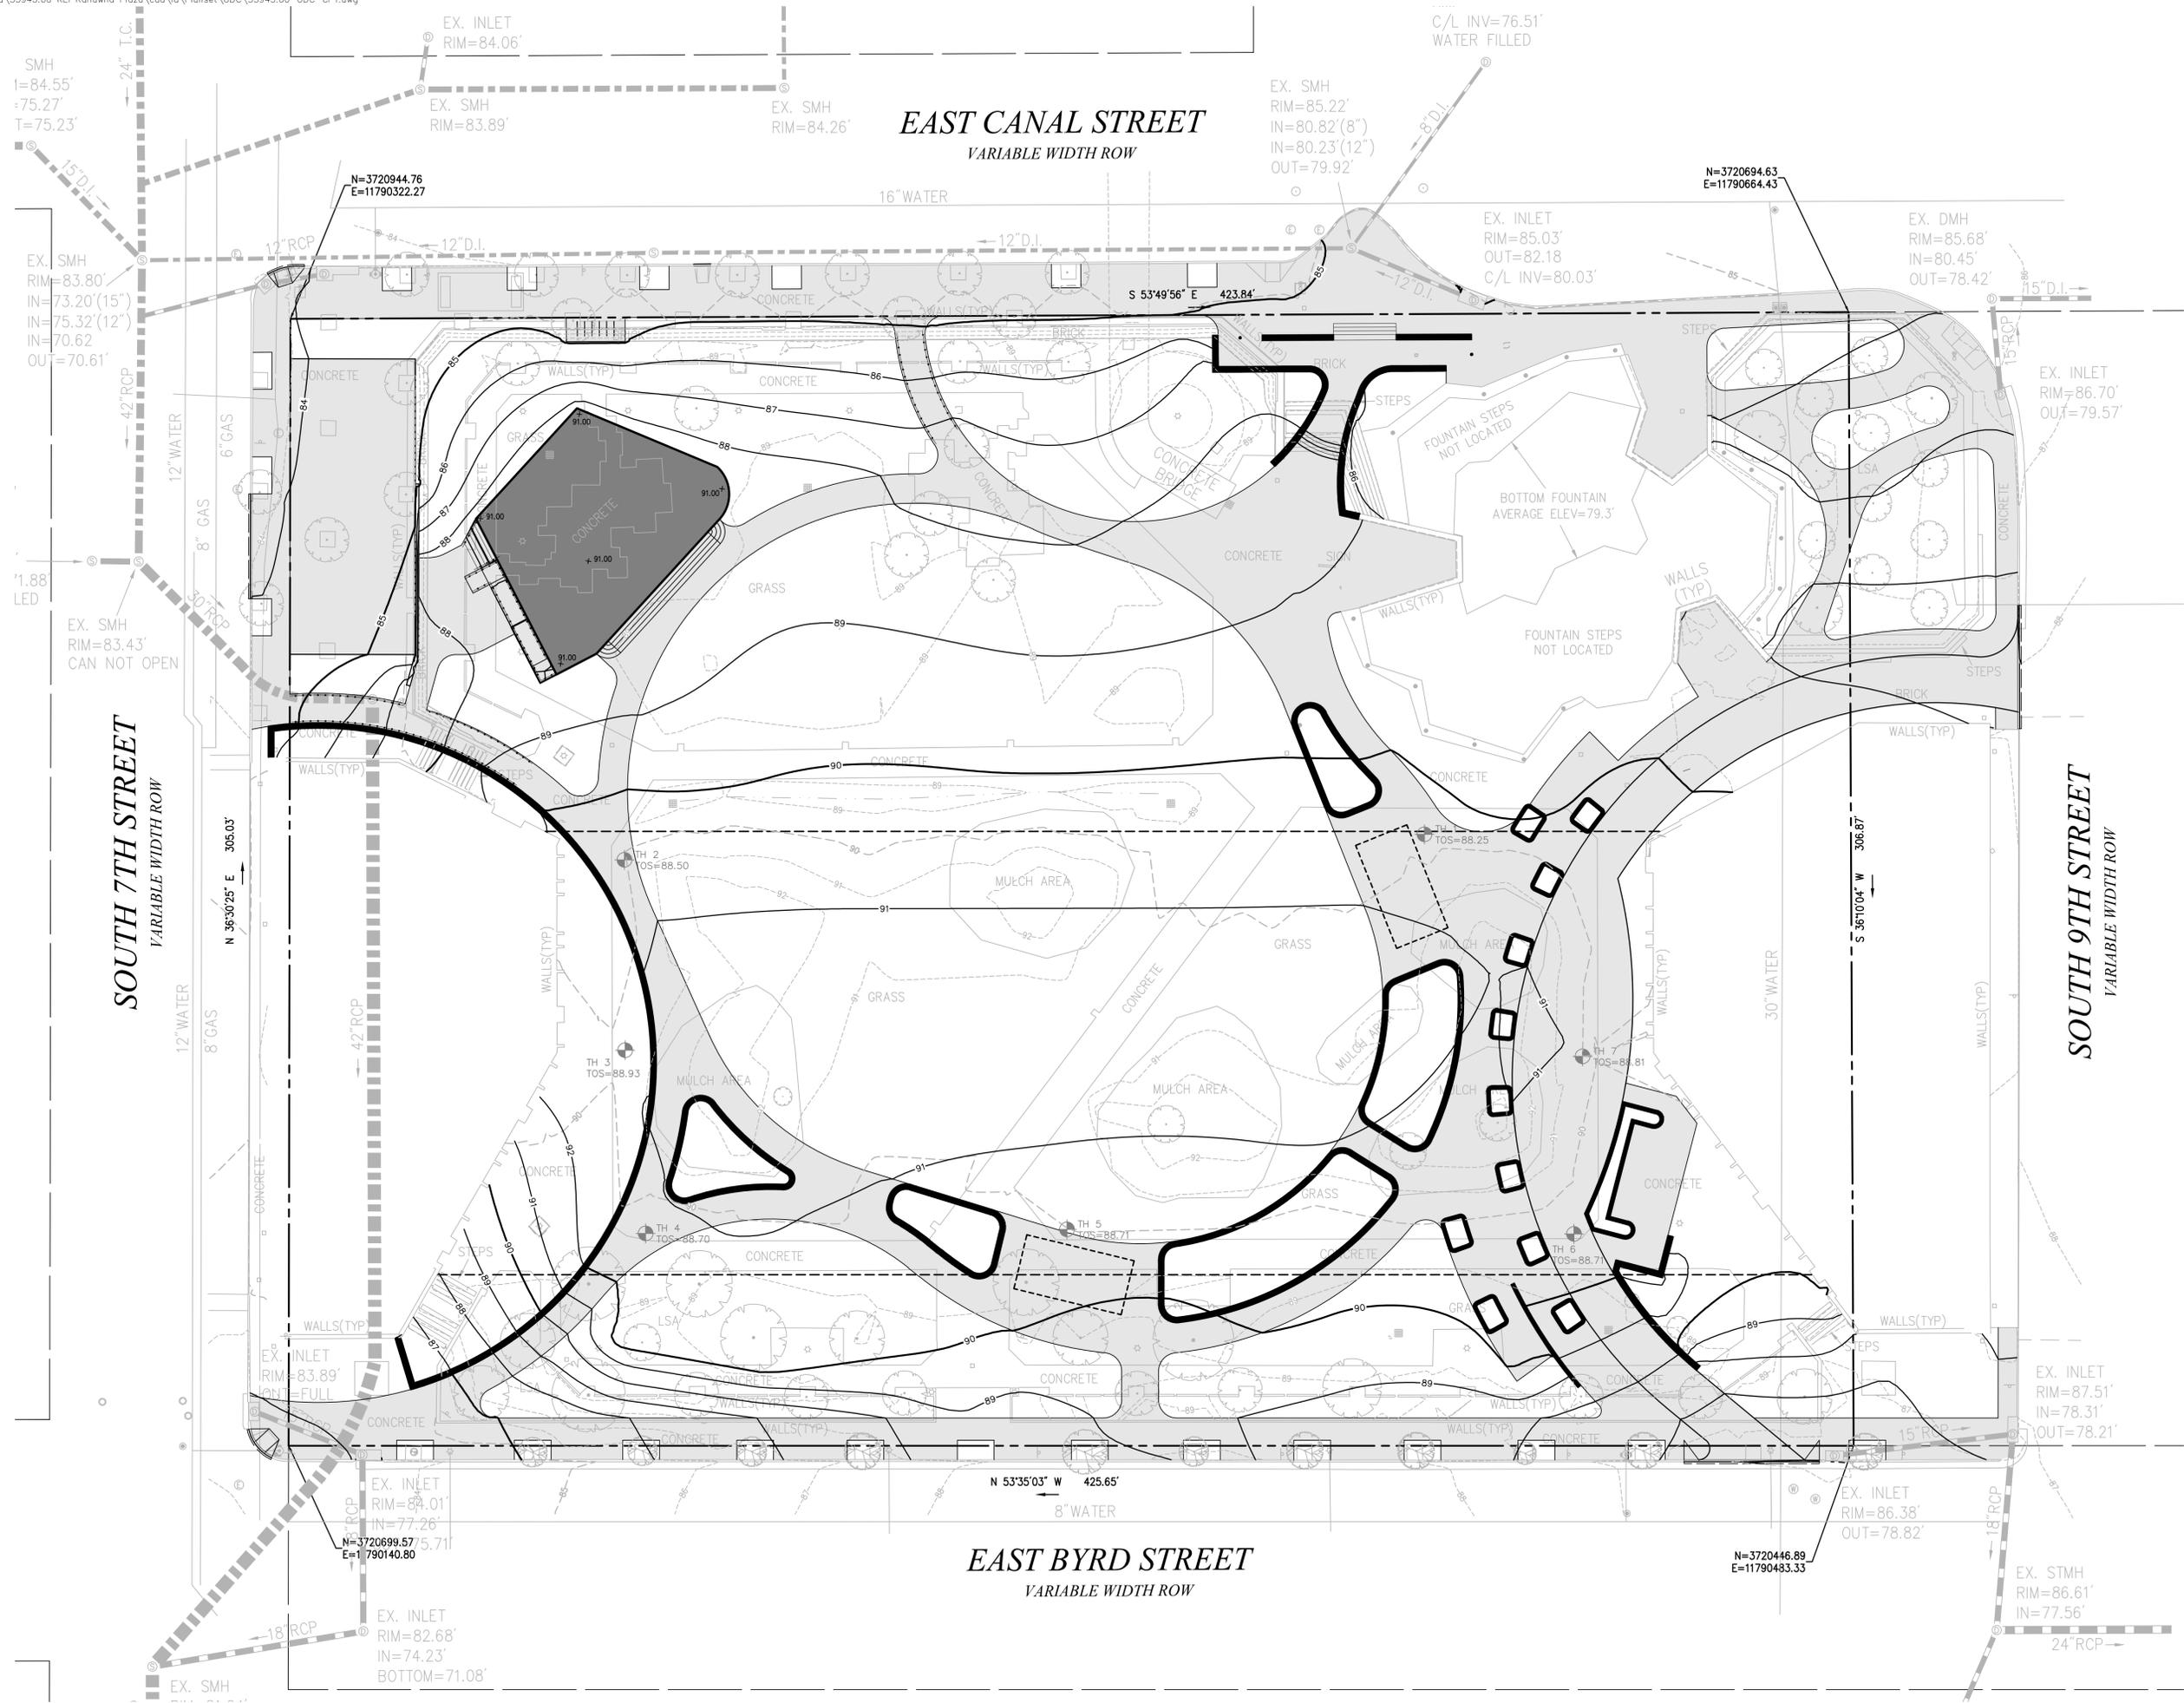

ARCHITECTURE
INTERIORS
URBAN DESIGN


101 west Broad Street
Suite 101B
Richmond, VA 23220
804.788.0880



115 South 15th Street
Suite 200
Richmond, VA 23219
804.343.7100



DANIELS & ASSOCIATES, P.C.
Consulting Engineers
2112 W. Laburnum Avenue
Suite 202
Richmond, VA 23227
804.553.1283

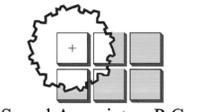

Snead Associates, P.C.
Landscape Architecture
8005 Creighton
Parkway #703
Mechanicsville, VA 23111
804.649.8500



HS ENGINEERING, INC.
CONSULTING ENGINEERS
479 Southlake Boulevard
Richmond, VA 23236
804.594.7210

Kanawha Plaza
East Canal Street
Richmond, Virginia

No.	Revision	Date	Aspd.

Designed by _____ Checked by _____

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Planning Commission Review April 16, 2015

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Site Plan Grading

Drawing Number _____


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Sheet _____ of _____

2

Project Number
33945.00

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ARCHITECTURE
INTERIORS
URBAN DESIGN


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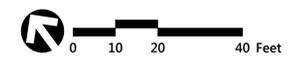
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8005 Creighton
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Issued for _____ Date _____

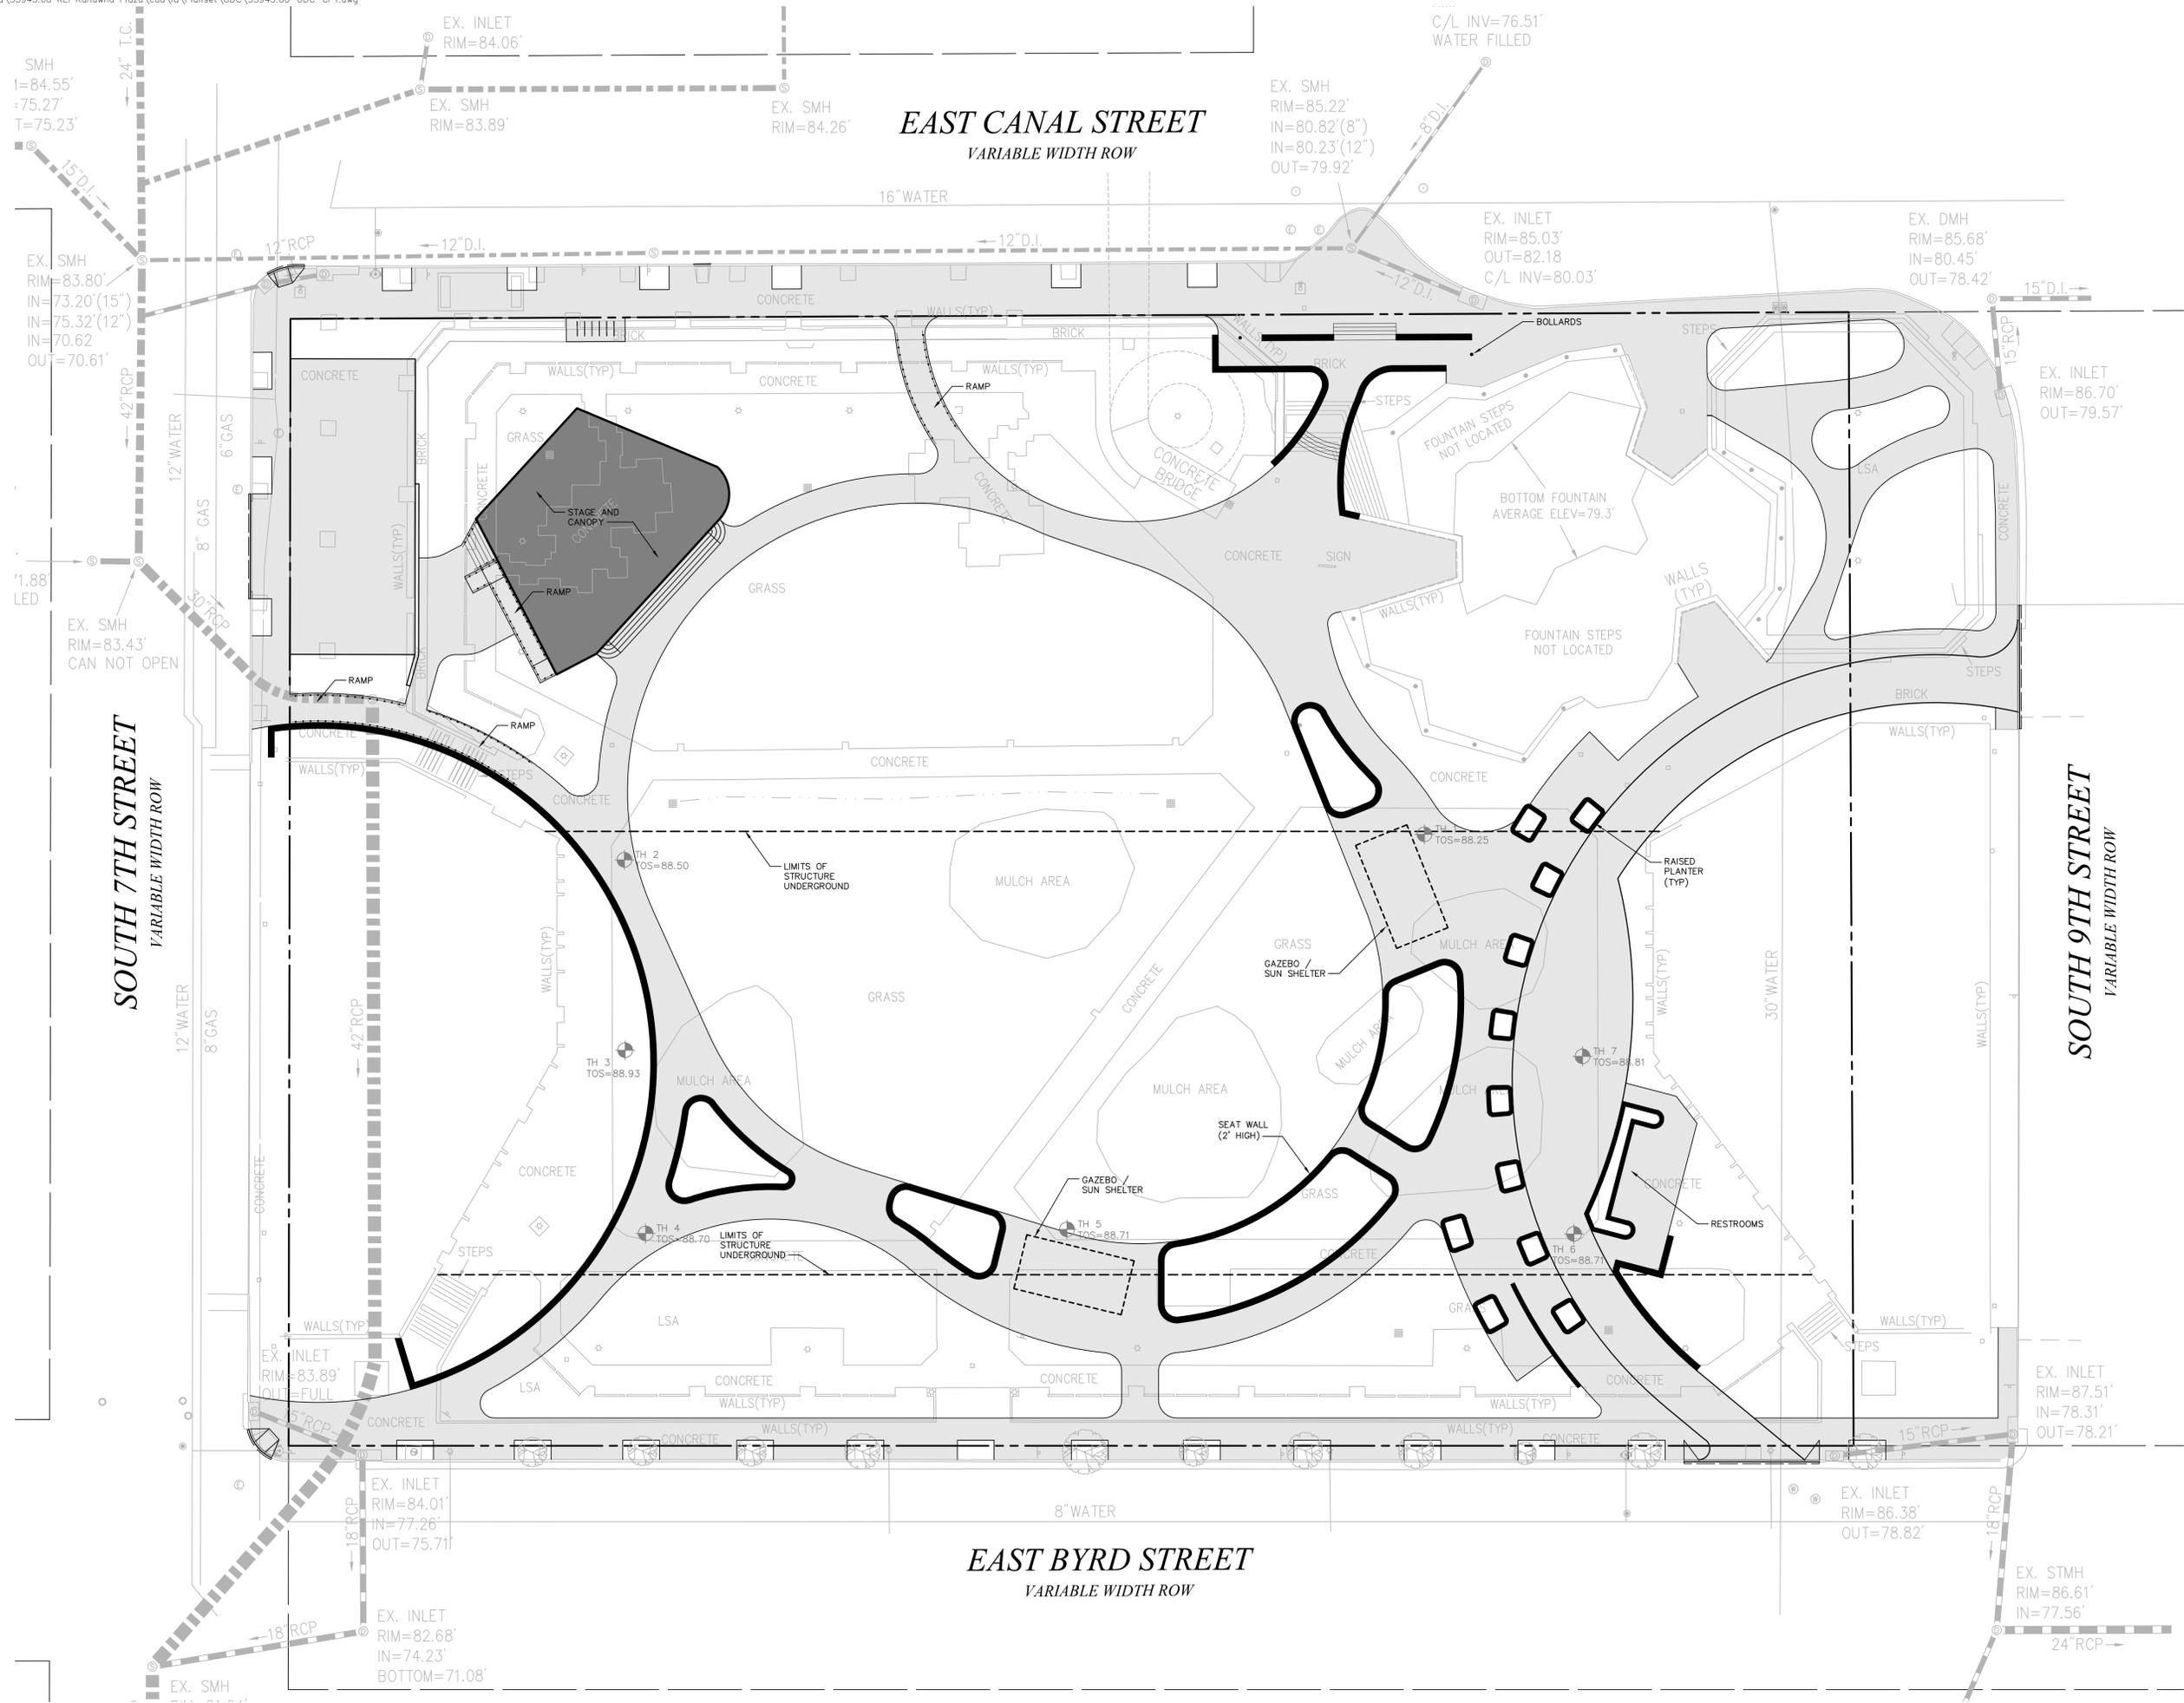Planning Commission Review April 16, 2015

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Site Plan Layout

Drawing Number _____


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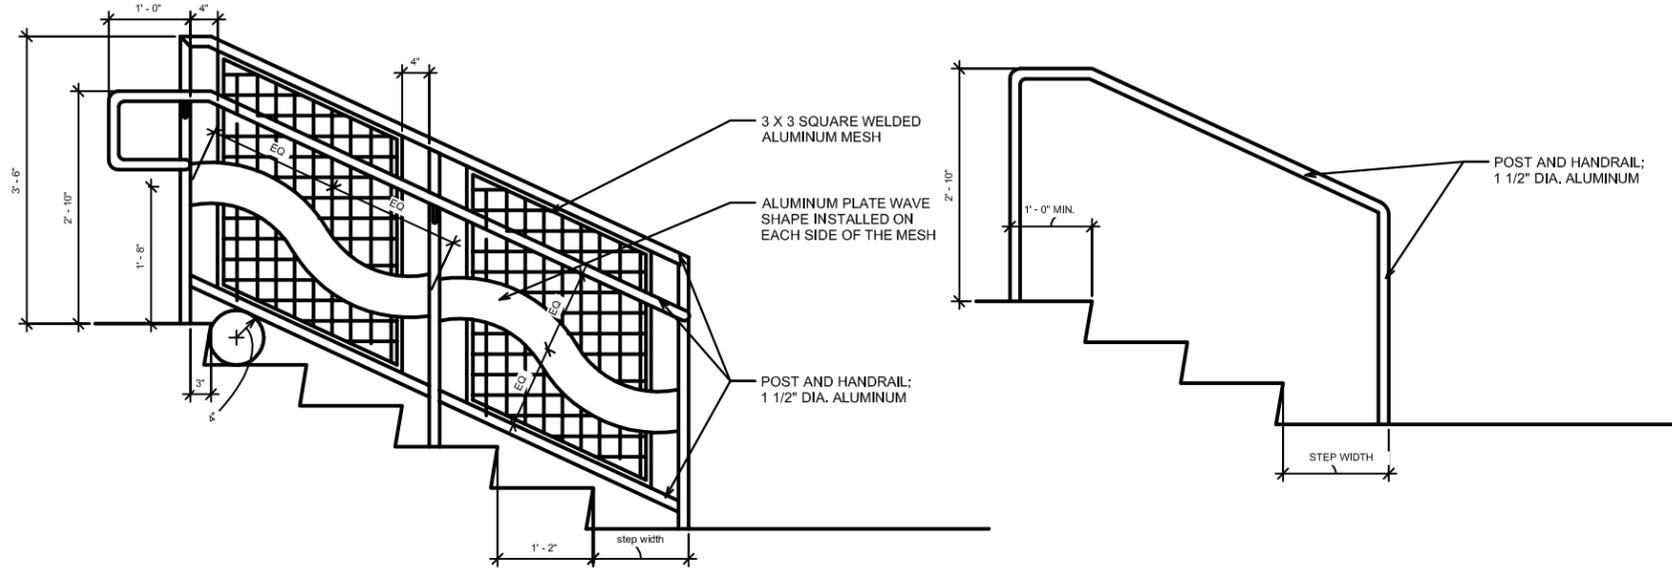
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Project Number
33945.00

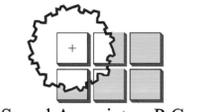
GUARDRAIL AT ALL LOCATIONS WITH DIFFERENCE IN LEVEL HIGHER THAN 30" WITH ADJACENT GROUND. STAGE SIDE AND FOUNTAIN OVERVIEW



HANDRAIL WITH GUARDRAIL AT ALL LOCATIONS WITH DIFFERENCE IN LEVEL HIGHER THAN 30" WITH ADJACENT GROUND

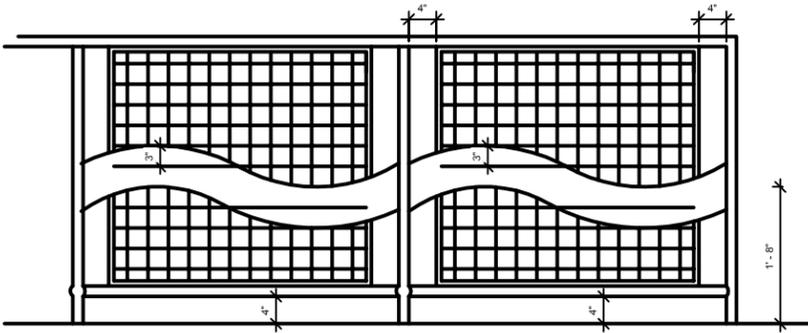

HANDRAIL FOR STAIR THAT HAS ADJACENT LEVEL LESS THAN 30" DIFFERENCE.

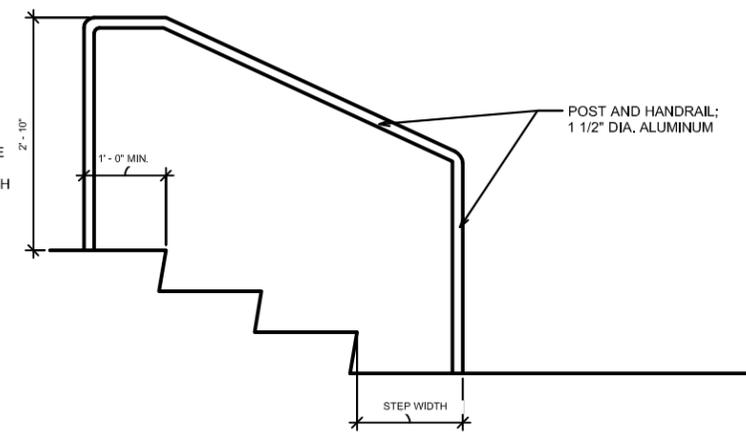

1 STAIR HANDRAIL AND GUARDRAIL
1/8" = 1'-0"




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Suite 200
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804.343.7100



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Consulting Engineers
2112 W. Laburnum Avenue
Suite 202
Richmond, VA 23227
804.553.1283



Snead Associates, P.C.
Landscape Architecture
8005 Creighton
Parkway #703
Mechanicsville, VA 23111
804.649.8500

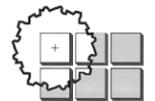

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Drawing Number

Sheet **1** of

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33945.00

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2 RAMP HANDRAIL
1/8" = 1'-0"

